# 5.6. MATERIAL CHANGE OF USE - MULTIPLE DWELLINGS & SHORT-TERM **ACCOMMODATION - 69 - 73 MURPHY STREET PORT DOUGLAS**

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**DEPARTMENT Environment and Planning** 

MCUC 2021\_4490/1 **APPLICATION NO** 

**PROPOSAL** Material Change of Use (Multiple Dwellings & Short-term

Accommodation)

Gurner TM Nominee Pty Ltd **APPLICANT** 

> C/- Planning Plus PO Box 399

REDLYNCH QLD 4870

LOCATION 69 - 73 Murphy Street PORT DOUGLAS

**PROPERTY** LOT: 516 TYP: PTD PLN: PARCEL 2344

2 September 2022

2094, LOT: 2 RP: 724386

**PLANNING SCHEME** 2018 Douglas Shire Council Planning Scheme Version 1.0

ZONING **Tourist Accommodation Zone** 

LEVEL OF ASSESSMENT Code

PROPERLY MADE DATE 25 November 2021

**STATUTORY ASSESSMENT DEADLINE** 

**REFERRAL AGENCIES** N/A

**LOCALITY** 



Figure 1 - Locality Plan

#### RECOMMENDATION

That Council approves the development application for a Material Change of Use for Short-Term Accommodation & Multiple Dwellings over land described as Lot 2 on RP724386 & Lot 516 on PTD2094, subject to the following:

# APPROVED DRAWING(S) AND / OR DOCUMENT(S)

The term 'approved drawing(s) and / or document(s)' or other similar expressions means:

Drawing or Document	Reference	Date
Site Context	Gurner TM Drawing No. DA01.001 Job No. 9663 Rev. E	13/07/2022
Site Survey	Gurner TM Drawing No. DA01.005 Job No. 9663 Rev. E	13/07/2022
Site Survey	Gurner TM Drawing No. DA01.006 Job No. 9663 Rev. E	13/07/2022
Interpolated Survey	Gurner TM Drawing No. DA01.007 Job No. 9663 Rev. F	13/07/2022
Proposed Site Plan	Gurner TM Drawing No. DA03.001 Job No. 9663 Rev. G	13/07/2022
Site Access Plan	Gurner TM Drawing No. DA03.002 Job No. 9663 Rev. C	13/07/2022
Ground Floor Plan	Gurner TM Drawing No. DA010.001 Job No. 9663 Rev. K	13/07/2022
LO1 Floor Plan	Gurner TM Drawing No. DA010.002 Job No. 9663 Rev. K	13/07/2022
LO2 Floor Plan	Gurner TM Drawing No. DA010.003 Job No. 9663 Rev. K	13/07/2022
LO3 Floor Plan	Gurner TM Drawing No. DA010.004 Job No. 9663 Rev. K	13/07/2022
Roof Plan	Gurner TM Drawing No. DA010.005 Job No. 9663 Rev. J	13/07/2022
North Elevation	Gurner TM Drawing No. DA20.001 Job No. 9663 Rev. H	13/07/2022

Drawing or Document	Reference	Date
East Elevation	Gurner TM Drawing No. DA20.002 Job No. 9663 Rev. H	13/07/2022
South Elevation	Gurner TM Drawing No. DA20.003 Job No. 9663 Rev. H	13/07/2022
West Elevation	Gurner TM Drawing No. DA20.004 Job No. 9663 Rev. G	13/07/2022
Murphy St Elevation	Gurner TM Drawing No. DA20.100 Job No. 9663 Rev. A	13/07/2022
Typical Sections	Gurner TM Drawing No. DA30.001 Job No. 9663 Rev. K	13/07/2022
Typical Sections	Gurner TM Drawing No. DA20.102 Job No. 9663 Rev. G	13/07/2022
Pool Sections	Gurner TM Drawing No. DA30.003 Job No. 9663 Rev. B	13/07/2022
Development Summary - GFA	Gurner TM Drawing No. DA50.001 Job No. 9663 Rev. F	13/07/2022
Development Summary - Site Cover	Gurner TM Drawing No. DA50.002 Job No. 9663 Rev. F	13/07/2022
Development Summary- Landscape	Gurner TM Drawing No. DA50.003 Job No. 9663 Rev. F	13/07/2022
Materials	Gurner TM Drawing No. DA90.001 Job No. 9663 Rev. D	13/07/2022
Landscape Plans		
Cover Page	511 DA 01	12/07/2022
Planting Schedule	511 DA 02	12/07/2022
Planting Schedule	511 DA 03	12/07/2022
Tree Retention & Removal Plan	511 DA 04	12/07/2022
Landscape Plan – Entry Road & Western Boundary	511 DA 10	12/07/2022

Drawing or Document	Reference	Date
Landscape Plan – Ground Level & Green Roof	511 DA 11	12/07/2022
Landscape Plan – Level 1	511 DA 12	12/07/2022
Landscape Plan – Level 2	511 DA 13	12/07/2022
Landscape Plan – Level 3	511 DA 14	12/07/2022
Typical Details	511 DA 35	12/07/2022
General Specification	511 DA 50	12/07/2022
Stormwater Catchment & Upgrade		
DSC Drainage Catchments  - North Catchment 2	Sketch DSC-001	18/08/2022

#### ASSESSMENT MANAGER CONDITIONS

- 1. Carry out the approved development generally in accordance with the approved drawing(s) and/or document(s), and in accordance with:
  - a. The specifications, facts and circumstances as set out in the application submitted to Council; and
  - b. The following conditions of approval and the requirements of Council's Planning Scheme and the FNQROC Development Manual.

Except where modified by these conditions of approval

## **Timing of Effect**

2. The conditions of the Development Permit must be effected prior to Commencement of Use, except where specified otherwise in these conditions of approval.

#### **Amended Plan**

- 3. The access driveway design is to be revised to comply with the Australian Standard AS2890.1 Parking Facilities Off-Street Parking and good engineering design. The following design parameters must be addressed:
  - a. The horizontal geometry must be amended to comply with Table 2.2 of AS2890.1;
  - b. The width of the driveway must be sufficient for one-way traffic movement, provided a Traffic Management Plan for managing right of way for the driveway is prepared and approved by Council;
  - c. The driveway width must be supported by turn templates for the appropriate service vehicle. At a minimum the driveway must be demonstrated to cater for both the B99 vehicle and an SRV vehicle as independent ingress and egress movements;

- d. The inside gradient of any bends must not exceed 20%;
- e. The roadside safety barriers identified on the Inertia Engineering drawings are to be detailed and approved by Council with consideration to be given to visual impact. Council's approval may require additional visual amelioration treatments to address visual impact;
- f. The southern most projection of the driveway must not extend further than the limit shown on the revised Inertia engineering Sketch SK007-Rev D dated 07/07/2022.

The revised plans must be certified by an RPEQ as part of Operational Works application for the driveway, earthworks and retaining walls in the road reserve.

The amended plans must be endorsed by the Chief Executive Officer prior to the issue of a Development Permit for Building Work.

The section of private access driveway and landscaping treatments within the unconstructed road reserve will not become a Council asset and will never be maintained by Council. The ongoing maintenance obligation of the driveway in the road reserve remains with the property owner/s (or future body corporate) at all times. This requirement must be reflected in any future Community Management Statement for the development.

#### **Operational Works**

- 4. An Operational Works Approval is required for the water, sewer, stormwater, earthworks and driveway associated with the development. The application for Operational Works must include, but not be limited to, the following:
  - a. Decommissioning of the existing services within the site including demolition and removal of redundant services;
  - b. Drainage works nominated as detailed in conditions of approval and any additional works confirmed by the local drainage study;
  - c. Earthworks internal and external to the site;
  - d. Required external works within the road reserve for the driveway and retaining walls and Murphy Street;
  - e. Water and sewerage works required to provide additional capacity (where required) to enable connectivity of the site to Council's system without impacted existing levels of service.

Such works must be completed to the satisfaction of the Chief Executive Officer prior to Commencement of Use.

# Road condition survey

5. Prior to any works occurring on the site, the applicant is to prepare a road condition report of the proposed road haulage route(s) from the site to the approved disposal site(s). The report is to identify relevant existing defects or problems with the roadway along the identified route. On completion of the works, the haul route(s) shall be subject to a joint inspection by the applicant and Council Officers to identify any further damage that has occurred. Where additional damage has occurred, all rectification works shall be at the applicant's expense, to the satisfaction of the Chief Executive Officer.

# **Building Colours & Finishes**

6. A submission detailing the colours of all of the external walls and structures is to be re-submitted for endorsement by the Chief Executive Officer prior to the issue of a Development Permit for Building Work. The use of lighter colours and material finishes such as the nominated REN-1, REN-2 & RET-1 are to be avoided for upper storeys of the development.

# Water Supply and Sewerage Works External

- 7. Undertake the following water supply and sewerage works external to the site to connect the site to existing water supply and sewerage infrastructure:
  - Augment existing water supply infrastructure to the extent necessary such that the development does not adversely affect the water supply to adjacent properties and such that a water service connection can be provided at the lot frontage;
  - b. Augment existing sewers or construct new sewer to accommodate the development. If connection is proposed to the existing sewer on the north western boundary, detailed plans are to be provided showing levels, capacity and existing sewerage demands through to the pump station downstream of the site. Alternatively, a new sewer connection will need to be designed through to the pump station. The connection point is to be into the existing incoming sewer and not into the pump station. The design is to be in accordance with the FNQROC Development Manual and submitted for Operational Works approval;
  - c. Extend the water main shown on Inertia Engineering Sketch SK004 Rev E dated 7/07/2022 north to Murphy Street terminating in the middle of the existing formation to enable future connection by Council;

The external works outlined above require Operational Works approval from Council.

All works must be carried out in accordance with the approved plans, to the requirements and satisfaction of the Chief Executive Officer prior to Commencement of Use.

#### Water Supply and Sewerage Works Internal

- 8. Undertake the following water supply and sewerage works internal to the subject land:
  - a. Provide a single internal sewer connection which must be clear of any buildings or structures;
  - b Provide a single internal water connection with appropriate metering and capacity for firefighting bypass arrangements as required.
    - Note: Council does not guarantee the pressure in its external water network beyond the minimum pressures nominated under FNQROC Development Manual. Where the building classification or use require greater pressures, these must be addressed by on-site measures as required to suit the building approval requirements;
  - c. Where required, water supply sub-metering must be designed and installed in accordance with *The Plumbing and Drainage Act 2002 and the Water Act 2000*

All the above works must be designed and constructed in accordance with the FNQROC Development Manual.

All works must be carried out in accordance with the approved plans, to the requirements and satisfaction of the Chief Executive Officer prior to Commencement of Use.

## **Inspection of Sewers**

9. Where altering existing sewer mains or construction of new sewer main, provide CCTV inspections of sewers both prior to commencement of works on site and at works completion where works have been undertaken over or to sewers. Defects must be rectified to the satisfaction of the Chief Executive Officer at no cost to Council prior to Commencement of Use.

# **Damage to Council Infrastructure**

10. In the event that any part of Council's existing sewer, water or road infrastructure is damaged as a result of construction activities occurring on the site including but not limited to; mobilisation of heavy construction equipment; stripping; and grubbing, the applicant/owner must notify Council immediately of the affected infrastructure and have it repaired or replaced at the developer's/owners/builders cost, prior to the Commencement of Use.

# **General External Works**

- 11. Undertake the following external works:
  - a. Provide a full detail design for the driveway and reprofiling works in the verge including landscaping treatments and pedestrian access;

 The detail design in a above must include sufficient details on the local drainage, verge grading, concrete pathway grades and crossfall. The applicant is to ensure that the development complies with the requirements of AS2890.6, and other all-abilities access provisions applicable for this development classification;

The plan of the works must be endorsed by the Chief Executive Officer prior to the issue of a Development Permit for Operational Works. All works must be carried out in accordance with the approved plan prior to the issue of a Commencement of the Use.

# **Drainage Study of Site**

12. Undertake a local drainage study of the site to determine the catchment contributing to the existing pipe system that the development proposes to connect into.

The study must also address the following concerns with the current design concepts:

- a. The existing pipes are part way through their design life and the new development places permanent filling within the zone of influence of the pipe(s) applying additional loads to the pipe(s) that were not considered in their original design. Additionally, significant construction traffic will impact the existing pipes;
- b. The contributing catchment does not match Council's catchment (and resulting predicted peak flows);
- c. There are conflicts within the applicant's drawings with the southern open stormwater swale drain nominated on the Inertia Engineering Sketches competing with dense screening planning nominated by the landscape designer to ameliorate the visual impacts; and
- d. There are known capacity issues within the existing stormwater system.

Noting the above impacts and current deficiencies and the conflicts with internal stormwater swales and landscaping, Council proposes to collaborate with the developer to achieve a mutually beneficial solution. This includes:

- a. Permitting site stormwater to be collected in surface swales within Council's lot to the south west of the subject site, (Lot 1 on RP 724386), (to preserve the landscaping corridor for screening);
- b. The developer is to construct a new stormwater pipeline along the north western side of the development site, (size and invert levels to be confirmed with this study). Note: drainage required upslope of retaining solutions is permitted to utilise this pipe line;
- c. The developer is to upgrade the existing stormwater along the south western boundaries of the site and through to the esplanade discharge point including provision of appropriate pipe class to address the pipe loads from the development and access driveway;

d. The above concept is shown on Council Sketch DSC-001 attached;

The updated study (including the proposed system changes) is to be undertaken in conjunction with Council's drainage team to verify:

- The contributing catchment boundaries for the existing stormwater pipe system. Council's internal catchment plans do not match the calculations provided by Inertia Engineering;
- b. The conveyance path and flow characteristics for the 100 year ARI flood event in relation to the site both pre- and post-development;
- c. Primary and secondary peak flow volumes for the 5, 10 and 100 year ARI rainfall events;
- d. Proposed pipe infrastructure sizes and capacity compared with the peak flows.
- e. Identify any requirement for amendments to the drainage easements;
- f. Information on the proposed works and any impacts proposed at the drainage outlet from the proposed development.
- g. Lawful point of discharge.

The study must be endorsed by the Chief Executive Officer prior to the issue of a Development Permit for Operational Works.

# **Drainage Easements (General Drains)**

13. A Drainage Easement having a minimum width of 3 metres along the entire length of north western boundary must be granted in favour of Council. A copy of the easement documents must be submitted to Council for the approval of Council's solicitors at no cost to Council. The approved easement documents must be lodged and registered with the Department Resources prior to the Commencement of Use.

## **Plan of Drainage Works**

- 14. The subject land must be drained to the satisfaction of the Chief Executive Officer. In particular,
  - a. Drainage infrastructure as identified in the drainage study condition including but not limited to:
    - A new underground stormwater pipe within the development site adjacent the north western boundary on the site;
    - Upgraded underground pipes to 1 in 100 year ARI capacity and suitable pipe class along the south western boundary of the site and within Lot 1 on RP724386; and

- Overland swale drain along the south western boundary parallel to the swale nominated in Inertia Engineers drawing (and replacing that swale).
- b. The drainage system from the development must incorporate a stormwater quality improvement devices (SQID) internal to the site. The design of the SQID shall not compromise the hydraulic performance of the overall drainage system and be positioned to provide appropriate access for maintenance equipment.
- c. The drain age concept shown on Inertia Engineering Sketch SK02 is to be redesigned to eliminate the conflicts with the architectural and landscape plans in relation to the significant screening planting of the buffer area. The following drainage design is to be provided.

# **Geotechnical Investigation / Design**

- 15. An updated geotechnical assessment by a qualified and experienced geotechnical consultant must be submitted with the application for Operational Works, with a final geotechnical report to be endorsed by the Chief Executive Officer prior to the Commencement of Use.
  - a. The updated geotechnical assessment must address the recommendations In the Geo Design letter dated 5 October 2021 and the Geo Design Report dated 29 October 2020 including but not limited to:
    - A revised and updated geotechnical report should be prepared based on the final architectural designs and consider footings, stability and construction recommendations:
    - The updated geotechnical report may require the completion of additional fieldwork;
    - A detailed slope stabilisation design should be adopted for the Murphy Street batter that decreases the risk to the proposed development and Murphy Street;
    - Retaining works or slope retention systems may be required on other batters or natural slopes subject to a review of the final design;
    - Drainage works are considered essential to the successful completion of the works to minimise potential sediment and erosion issues together with decreasing the risks of instability.
  - b. The updated geotechnical assessment must address the cut batter along the northern boundary, and provide specific details on the staging of work and control measures required on this batter to maintain the safety of the site to enable work activities to be undertaken within the site;
  - c. Geotechnical details to be submitted include, but are not limited to, the following:

- Details of the specific means of supporting or retaining to be used. This
  must include geotechnical specifications identifying the required
  treatments at specific times, heights on the batter and the location within
  the site;
- Drawings (plans, longitudinal and cross sections) clearly showing the extent of the proposed treatments at each location;
- Methods to be used to minimise the visual impact (where not included within the building); and
- Elevations showing the visual impact when viewed from vantage points and duration that the treatment is expected to be exposed to public view.

All works identified must be supervised by the geotechnical consultant to ensure that the siteworks are undertaken in a manner that maintains a low to very low risk rating in accordance with AGS Guidelines. The supervising geotechnical assessment must provide a final geotechnical report confirming that the constructed works comply with the approved designs. The final report must be endorsed by the Chief Executive Officer prior to the issue of a Development Permit for Operational Works.

16. The geotechnical report must include designs and treatments for the site for temporary works and for the staging of construction. The temporary works are to be certified by a suitably qualified RPEQ and must be supervised by the geotechnical consultant to ensure that the siteworks are undertaken in a manner that maintains a low to very low risk rating in accordance with AGS Guidelines.

Where the proposed temporary or permanent geotechnical design solution requires soil nails, the extent of the nails must not extend beyond the property boundary without written consent from the adjacent landowner. The design must fully disclose the extent, depth and potential impact on future development of adjoining land so that the owner provides informed consent to any encroachment. As-constructed details of the geotechnical solution are to be provided to Council and records must be kept by the applicant/land owner and provided to future owners/body corporate. Certification from the RPEQ that the works have been undertaken in accordance with the approved plans and recommendations of the geotechnical investigation and compliance with the conditions is required prior to the Commencement of Use.

#### **Construction Management Plan for Earthworks**

17. The site development requires excavation and earthworks and will require material to be imported and exported from the site with access through the Esplanade road and car park area.

The applicant is to prepare a traffic management plan and detail the controls necessary to manage the impacts for movement of materials to and from the site. The plan must nominate the type and number of truck movements required including total truck movements, daily truck movements and management of movements throughout the day.

The final earthworks design is to be lodged with the application for a Development Permit for Operational Works. Such earthworks must be completed in accordance with the approved plans prior to the Commencement of Use.

# Stockpiling and Transportation of Fill Material

18. Soil used for filling or spoil from the excavation is not to be stockpiled in locations that can be viewed from adjoining premises or a road frontage for any longer than one (1) month from the commencement of works.

Transportation of fill or spoil to and from the site must not occur within:

- a. peak traffic times; or
- b. before 7:00 am or after 6:00 pm Monday to Friday; or
- c. before 7:00 am or after 1:00 pm Saturdays; or
- d. on Sundays or Public Holidays.
- 19. Dust emissions or other air pollutants must not extend beyond the boundary of the site and cause a nuisance to surrounding properties.

# **Storage of Machinery and Plant**

20. The storage of any machinery, material and vehicles must not cause a nuisance to surrounding properties, to the satisfaction of the Chief Executive Officer.

# Landscape Plan

- 21. The site and external areas must be landscaped generally in accordance with the Landscape Plans prepared by Myles Baldwin Design dated 12 July 2022 subject to the following requirements. An amended landscape plan/s must be provided which shows:
  - a. The retention of the Calophyllum tree located in the unconstructed road reserve which is earmarked for removal unless otherwise approved at the time of assessing the Landscape Plans;
  - The Landscape Plan is to detail protection measures to be installed for vegetation to be retained. Protection measures are to be in accordance with AS 4970-2009;
  - c. Further detail on the proposed refuse facility located in the unconstructed road reserve in terms of building material, finishes and screening. The refuse facility is to be of a high quality and be appropriately screened;
  - d. Landscaping and deep planting of cut and fill areas and other disturbed areas as a consequence of installing services;
  - e. Undertaking deep planting of building setback areas;
  - f. Deep landscaping of the setback area adjacent Dwelling 3 & Dwelling 4 to screen the building piers overtime. Landscaping is also permitted within Lot 1 on RP724386 following the installation of the new stormwater pipe to create an effective buffer between the development and the existing buildings.

- g. Detail ground preparation and removal of any unsuitable material. The soil must be well prepared (not compacted) and fertilized with organic fertilizers to encourage strong growth;
- h. Species to have regard to Council's Planning Scheme Policy SC6.7 Landscaping;
- i. Inclusion of any other relevant conditions included in this Development Permit. A copy of this Development Approval must be given to the applicant's Landscape Architect/Designer.

The Landscape Plan must be endorsed by the Chief Executive Officer at the time of seeking a Development Permit for Operational Works. All landscaping works must be undertaken in accordance with the endorsed plan prior to the Commencement of Use and maintained at all times to the satisfaction of the Chief Executive Officer.

#### **Sediment and Erosion Control**

22. All earthworks must be carried out in accordance with section CP1.13 and D5 of the FNQROC Development Manual. A copy of the contractors Erosion and Sediment Control Plan (ESCP) is to be submitted to Council prior to the issue of a Development Permit for Operational Work. Measures nominated in the ESCP must be implemented prior to commencement of any earthworks. The ESC Plan must address the Institution of Engineers' Australia Guidelines for Soil Erosion and Sediment Control and the Environment Protection (Water) Policy and Clauses CP1.06, CP1.13 and D5.10 of Council's FNQROC Development Manual.

# **Existing Services**

- 23. Written confirmation of the location of existing services for the land must be provided. In any instance where existing services are contained within another lot, the following applies, either:
  - a. Relocate the services to comply with this requirement; or
  - b. Arrange registration of necessary easements over services located within another lot prior to Commencement of Use.

# **Electricity Supply**

24. Written evidence from Ergon Energy advising if distribution substation/s are required within the development must be provided and accompanied by written confirmation from Ergon Energy. Details regarding electricity supply must be provided prior to the issue of a Development Permit for Operational Works.

#### Above Ground Transformer Cubicles / Electrical Sub-Stations

25. Any required above ground transformer cubicles and/or electrical sub-stations are to be positioned so that they do not detract from the appearance of the streetscape and must be clear of the road frontage and footpath areas. This will require cubicles / sub-stations to be setback from the street alignment behind suitable screening, or incorporated within the built form of the proposed building. Details of the electrical sub-station positioning must be endorsed by the Chief Executive Officer prior to the issue of Development Permit for Building Work.

# **Electricity and Telecommunications**

26. Written evidence of negotiations with the telecommunication authority must be submitted to Council stating that a telecommunications service will be provided to the development prior to the issue of a Development Permit for Building Work.

# **Street Lighting**

- 27. The following arrangements for the installation of upgraded street lighting within the Esplanade Road Reserve must be provided prior to Commencement of the Use:
  - a. Prior to the issue of a development permit for Operational Works a Rate 2 lighting scheme is to be prepared by an Ergon Energy approved consultant and submitted to the Chief Executive Officer for approval. The Rate 2 lighting scheme is to be designed in accordance with the relevant Road Lighting Standard AS/NZS 1158 and the FNQROC Development Manual. The applicable lighting category is to be determined for an Access Street per the Road Hierarchy Table D1.1 and the corresponding applicable Lighting Categories Table D8.1 as identified in the FNQROC Development Manual.

The lighting scheme must show a <u>new</u> light pole supplied by underground power and located to identify the driveway entry point onto the Esplanade roadway and parking areas. The new "flag light" is to be located to avoid conflicts with the existing stormwater pipes and inlet pits and other services and the proposed refuse facility.

The existing light pole north east from the driveway connection point and the overhead power supply are to be decommissioned and removed.

The design must provide the applicable illumination level specified in the Road Lighting Standard AS/NZS 1158 at the driveway entry/exit point assessed as an "intersection".

b. Prior to the Commencement of the Use provide evidence that the relevant capital contribution required by Ergon Energy has been paid must be submitted, to ensure that the street lighting will be constructed.

## **Vehicle Parking**

28. The amount of vehicle parking to be provided onsite is a minimum of eleven (11) spaces. The car parking layout must comply with the Australian Standard AS2890.1 2004 Parking Facilities – off-street car parking and be constructed in accordance with Austroads and good engineering design. In addition, all parking, driveway and vehicular manoeuvring areas must be imperviously sealed, drained and line marked and these attributes must be maintained for the life of the development.

# **Amalgamation of Lots Required**

29. The applicant/owner is to ensure that the subject lots are held together as one site for the duration of the approved land use. This is to be achieved by the amalgamation of Lot 1 on RP718896 and Part of Lot 1 on SP267838 into one lot. The Plan of Survey must be registered with the Department of Natural Resources and Mines and Energy and a new certificate of title issued at the applicant's/owner's cost prior to Commencement of Use.

# **Construction Signage**

- 30. Prior to the commencement of any construction works associated with the development, a sign detailing the project team must be placed on the road frontage of the site and must be located in a prominent position. The sign must detail the relevant project coordinator for the works being undertaken on the site, and must list the following parties (where relevant) including telephone contacts:
  - a. Developer;
  - b Project Coordinator;
  - c. Architect / Building Designer;
  - d. Builder;
  - e. Civil Engineer;
  - f. Civil Contractor;
  - g. Landscape Architect

#### Advices

- 1. This approval, granted under the provisions of the Planning Act 2016, shall lapse six (6) years from the day the approval takes effect in accordance with sections 85(1)(b) and 71 of the Planning Act 2016.
- 2. The Douglas Shire Council area is subject to water restrictions during dry season months that may limit and/or restrict the use of Council water for landscaped areas. Council recommends water harvesting and water saving devices to be included to cater for the dry season periods.
- 3. All building site managers must take all action necessary to ensure building materials and / or machinery on construction sites are secured immediately following the first cyclone watch and that relevant emergency telephone contacts are provided to Council officers, prior to commencement of works.
- 4. This approval does not negate the requirement for compliance with all other relevant Local Laws and other statutory requirements. In particular, the use of the adjacent sidewalk area is subject to a Local Law approval for outdoor dining. The use of the sidewalk area for outdoor dining is subject to a Local Laws approval.
- 5. A charge levied for the supply of trunk infrastructure is payable to Council towards the provision of trunk infrastructure in accordance with the Infrastructure Charges Notice, a copy of which is attached for reference purposes only. The original Infrastructure Charges Notice will be provided under cover of a separate letter.

The amount in the Infrastructure Charges Notice has been calculated according to Council's Adopted Infrastructure Charges Resolution.

Please note that this Decision Notice and the Infrastructure Charges Notice are stand-alone documents. The Planning Act 2016 confers rights to make representations and appeal in relation to a Decision Notice and an Infrastructure Charges Notice separately.

The amount in the Infrastructure Charges Notice is subject to index adjustments and may be different at the time of payment. Please contact the Planning Team at Council for review of the charge amount prior to payment.

The time when payment is due is contained in the Infrastructure Charges Notice.

6. For information relating to the *Planning Act 2016* log on to <a href="www.dsdip.qld.gov.au">www.dsdip.qld.gov.au</a>. To access the *FNQROC Development Manual*, Local Laws and other applicable Policies, log on to <a href="www.douglas.qld.gov.au">www.douglas.qld.gov.au</a>.

#### **REASONS FOR DECISION**

The reasons for this decision are:

- 1. Sections 60, 62 and 63 of the Planning Act 2016:
  - a. to ensure the development satisfies the benchmarks of the 2018 Douglas Shire Planning Scheme Version 1.0; and
  - b. to ensure compliance with the *Planning Act 2016*.
- 2. Findings on material questions of fact:
  - a. the development application was properly lodged to the Douglas Shire Council on 25 November 2021 2022 under s51 of the *Planning Act 2016* and Part 1 of the *Development Assessment Rules*;
  - b. the development application contained information from the applicant which Council reviewed together with Council's own assessment against the 2017 State Planning Policy and the 2018 Douglas Shire Planning Scheme Version 1.0 in making its assessment manager decision.
- 3. Evidence or other material on which findings were based:
  - a. the development triggered assessable development under the Assessment Table associated with the Tourist Accommodation Zone Code;
  - b. Council undertook an assessment in accordance with the provisions of s60, s62 and s63 of the *Planning Act 2016*; and
  - c. the applicant's reasons have been considered and the following findings are made:
    - i. The proposed use and built form is an acceptable outcome for the site which in in keeping with similar building heights and building setbacks of adjoining development. Plans of development have been modified during the assessment process to adequately address concerns raised over building height and vehicle access to the site; and
    - ii. Subject to conditions, the development satisfactorily meets the Planning Scheme benchmarks.

# **Non Compliance with Assessment Benchmarks**

Benchmark Reference	Alternative Measure/Comment
Tourist Accommodation Zone	The development does not meet the assessment benchmarks of AO1 and AO2 of the code as it relates to building height, setbacks and site cover. However, the development is considered to meet the corresponding Performance Outcomes, as the development:  (a) is of a similar height to the adjoining development to west being 67 Murphy Street; (b) is located on an existing benched site established as a result of previous quarry activities; (c) Flag staff hill forms the back drop of the development with building heights and building setbacks remaining consistent with existing building heights and established building setbacks along Murphy Street;
	<ul> <li>(d) provides acceptable building setbacks from the unconstructed road reserve. The presence of the driveway and landscaping treatments will achieve visual relief of the building when viewed from areas external to the site.</li> <li>The development does not meet the assessment benchmarks of AO3.1 which limits the length of building to 30m. The development meets the corresponding Performance Outcome as the site is at the end of Murphy Street with the building façade of Dwelling 1 facing the vegetated bank of Flagstaff Hill.</li> </ul>
Access, Parking and Servicing Code	Despite the non achievement of the Acceptable Outcome AO2 the development achieves the respective Performance Outcome, namely:  a) Sufficient on-site car parking is provided to cater for the amount and type of vehicle traffic expected to be generated by the use.  b) Any inconvenience with the car parking layout is internalised and does not involve high turnover vehicle parking;

# **EXECUTIVE SUMMARY**

Development application has been received over land at 69-73 Murphy Street Port Douglas which seeks to develop the land for Multiple Dwellings which also have the ability to be used for Short-term Accommodation.

The development comprises 4 separate buildings which are accessed via a common driveway extending from the unconstructed road reserve adjacent Jalun Park. The development involves constructing an access driveway within the unconstructed road reserve which connects the site to Macrossan Street.

The two buildings adjacent the southern boundary are best described as split level and single storey with the two buildings located towards the rear of the site being 4 storeys in height.

While the proposal includes a four storey element, the proposed buildings at the rear of the site are similar in elevation to the existing buildings along Murphy Street. It is important to note that the development has been reduced in elevation throughout the assessment process in order to address concerns raised over building height and visual amenity in addition to achieving better outcomes with respect to vehicle access.

The development has the ability to meet the objectives of the Planning Scheme for development within the Tourist Accommodation zone subject to reasonable and relevant conditions and therefore, approval of the application is recommended.

#### TOWN PLANNING CONSIDERATIONS

# **Background**

The site is currently vacant and has been subject to past quarry operations that has resulted in existing ground levels being significantly modified. The site is currently characterised by a prominent benched area located central on the site and a significant cut adjacent to the Murphy Street frontage. The cut is unstable with evidence of slumping that has taken place over time.

In 2013, the Planning & Environment Court issued a Court Order approving the development of 4 Multiple Dwellings on the site. The Court Order was a consequence of a submitter's appeal against the approval of the development issued by Cairns Regional Council. The approval was not acted upon and has since lapsed.

In December 2020, the Applicant lodged a development application for Multiple Dwellings, Short-term Accommodation and Food & Drink Outlet. The layout of the proposed development required the acquisition of part of the adjoining road reserve. Council had raised a number of concerns regarding building height, bulk and mass in addition to overall site cover extent of earthworks and building setbacks. It is understood the Applicant has chosen not to pursue this proposal any further.

In light of previous concerns raised, the Applicant has submitted a new development application for a significantly different development. The current development proposal in its current form largely responds to the previous issues raised.

# **Proposal**

The development seeks approval for the construction of 4 Multiple Dwellings / Short-term Accommodation on the site with each unit being contained in a separate building. While only 4 dwelling units, the units are quite significant in terms of gross floor area and building height and are of a 'high end' product.

The development comprises:-

- 2 Multiple dwellings (2 x 3 bedroom units in a single storey split level building);
- 1 x 3 bedroom unit in a 4 storey building adjacent the western boundary;
- 1 x 6 bedroom unit in a 4 storey building adjacent the eastern boundary;
- 11 onsite car parking spaces;
- Internal access within the common property to provide pedestrian access to Murphy Street.
- Landscaped areas both within and external to the site.

The internal dwelling layouts include generous outdoor deck and recreational areas.

The proposal plans have been modified in response to additional information being requested and concerns raised with the proposed access, overall building height and infrastructure servicing. These items are further discussed in the body of the report when responding to various planning and infrastructure considerations.

A copy of the proposal plans including site plans, sections and elevations forms Attachment 1.

#### DOUGLAS SHIRE PLANNING SCHEME ASSESSMENT

The following benchmarks are applicable to the proposed development:

Table 1.

Douglas Shire Planning Scheme	Comment
Planning Zone	
Tourist Accommodation	The proposal does not comply with a number of assessment benchmarks of the code being building height, site cover and building setback. Refer to discussion below.
	The establishment of Multiple dwellings and Short-term accommodation is anticipated to take place in the Tourist Accommodation zone. No issues are raised with the proposed land uses.
Local Plan	
Port Douglas / Craiglie Precinct	The site is subject to the Port Douglas / Craiglie Local Plan. The provisions of the Local Plan to the extent relevant to the proposed development seeks to maintain key landscape features that contribute to the local character of the town. See further discussions on the Tourist Accommodation zone cone regarding these elements.

Douglas Shire Planning Scheme	Comment
Land Use Codes	
Multiple Dwelling & Short Term Accommodation	The development generally satisfies the land use code. The land use code does have provisions relating to building setbacks and site cover requirements. However in this instance the Tourist Accommodation zone code prevails. Refer to the discussion below regarding these aspects.
	The design and internal layout of the development more than satisfies requirements with regard to ensuring suitable amenity and recreational spaces are provided for each unit.
	The land use code seeks to avoid against expansive eave lines and promotes building articulation. The eave line of Dwelling 1 fronting Murphy Street has a straight eave line of approximately 66m compared with the code requirement of 30m. However given the location of the building at the end of Murphy Street and this face of the building will not be seen, no major concerns are held. It is noted that the design does include horizontal treatments of this façade to break up this wall plane.
Overlay Codes	
Acid sulphate soils overlay	While the site is affected by the overlay, no excavations are taking place below an RL that will involve the consideration of acid sulphate soils.
Flood and storm tide hazard overlay	Similar to the comment on the acid sulphate soils, while the land is affected by the flood and storm tide hazard mapping under the current mapping, more recent investigations has determined the site is not impacted by storm tide. No further considerations are required.
Bushfire hazard overlay	Proposal is located on the edge of the potential impact buffer area, at the base of a slope and within an urban area. The risk of bushfire to the site is considered minimal and the proposal includes appropriate emergency access and water supply to mitigate any risk that does exist.
Hillslopes overlay	The area of the site adjacent Murphy Street is identified as being affected by the Hillslopes overlay. This is likely as a result of the existing cut adjacent Murphy Street and change of elevation from Murphy Street to the existing bench area within the site. The design of the development works in with the existing topography and while some of the retaining structures are greater than what the code nominates, those retaining structures which are over in height will not be visible externally. Refer to approved plans at Attachment 1.  A condition of the approval requires a further submission regarding proposed colours and treatments of the building particularly as it relates to the piers and the rear buildings.

Douglas Shire Planning Scheme	Comment
Landscape values overlay	The site is located within the view corridor of Flagstaff Hill and within the coastal scenery area within the Landscape values mapping.
	Despite being over in height, the building will not be visible from the identified view corridor. The proposed development also does not offend the outcomes identified associated with the coastal scenic corridor. The site maintains a substantial buffer from the foreshore area with building setbacks that are not inconsistent with the existing unit development adjacent the southern boundary.
	The Landscape plans do nominate vegetation removal within the road reserve. The proposed removal of a significant tree is being questioned as it is not located within the driveway corridor.
	Conditions of the approval require this to be further explored and reasons for the proposed removal is to be justified.
Potential landslip hazard	The site is identified within the potential landslip hazard overlay. The proposed development includes a geotechnical report. The report acknowledges that the majority of cuts will be retained as detailed on the proposal plans. The report also contains recommendations with regard to the existing cut along Murphy Street and proposed that the existing cut batter needs to have all vegetation removed, trimmed, soil nailed and place reinforced shotcrete over the surface. While concerns are raised with this treatment, a similar treatment has been applied to the large landslip further to the west of the site.
	The report recommends a detailed slope stabilisation design be adopted for Murphy Street that decreases the risk of landslip to Murphy Street and the development.
	Unfortunately, the implementation of geotechnical solutions to make the site low risk can conflict with other outcomes of the Planning Scheme in relation to landscaping treatments and the desire to maintain the lush tropical appearance and character of the area.
	Conditions have been included in the recommendation to seek to achieve the best balance possible in terms of the conflicting outcomes being sort.

Douglas Shire Planning Scheme	Comment
Transport network overlay	The proposal involves the construction of a private driveway in the unconstructed road reserve adjacent the eastern boundary of the site. The driveway traverses upslope at a grade of approximately 20% to deliver vehicles to the entry of the site at an RL of 9m AHD. Existing ground levels are 10.5m
	The driveway access has been redesigned to address concerns regarding the extent of filling and retaining works proposed on the road reserve and the resultant impacts on the amenity of the existing building on the corner of Macrossan Street and unconstructed road reserve.
	Further comment is provided on this below.
Other Development Codes	
Access, parking and servicing code	The development provides for 11 onsite spaces which is more than required for the proposed uses under the Planning Scheme.
	Further discussion is provided below with respect to parking and vehicle access.
Advertising devices code	Not Applicable.
Infrastructure works code	Considerable investigations have been undertaken to ensure the development can connect to existing urban services, being stormwater and reticulated water and sewer without having an impact on adjoining or downstream properties.
	Conditions of approval added to adequately address these matters.
	Further commentary is provided below with respect to stormwater and water supply.
Landscaping code	Detailed landscape plans have been provided as part of the supporting material. The landscape design and intent is generally acceptable. Conditions of approval requires amendments to the landscape plans to provide further detail regarding the refuse area and the retention of a significant tree within the road reserve area. The landscape plan condition also allows plantings to take place in the adjoining allotment (to contain the upgraded stormwater pipe) to achieve improved screening of piers and screening between buildings.

## **Tourist Accommodation zone**

The development does not comply with several development requirements of the Tourist Accommodation zone, being building height, building setbacks and site cover. While the development does not comply with the prescriptive requirement nominated in the zone code, the development does satisfy the corresponding performance outcome as it relates to each non-compliance.

# **Building Height**

The Tourist Accommodation zone provides for building heights up to 13.5 metres and 3 storeys in height. The prosed development is for 4 storeys with a maximum building height of 16.7m. Despite being over the nominated height limits, the building at its highest point will be at approximately the same height at the neighbouring building.

The building height has also been reduced by several metres as concerns were raised during the assessment process questioning the height of the building which resulted in undesirable outcomes external to the site with regard to the driveway design and associated works. In response to those items raised, the building has been lowered which also provides for less ramping and earthworks in the road reserve.

The alignment of the driveway was also amended to provide greater separation from the existing units on the corner of Macrossan Street and unconstructed road reserve.

The south elevation (image below) is also "broken up" which provides building articulation and reduces the building bulk and massing when viewed from Macrossan Street, Jalun Park and foreshore areas.

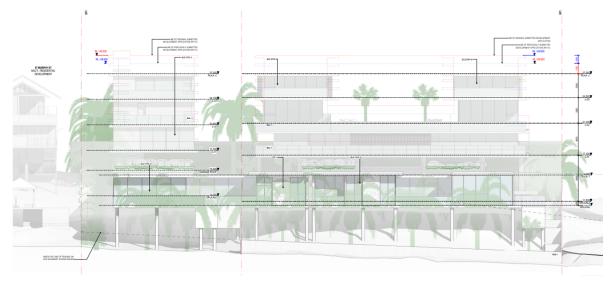


Figure 1. South Elevation

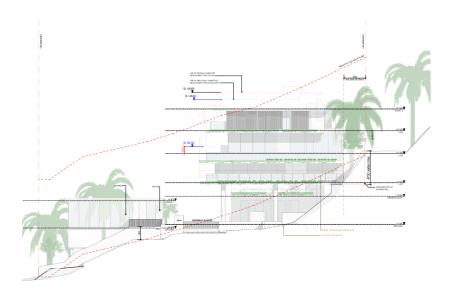


Figure 2. Revised design – reduction in building height & vehicle entry arriving at below existing ground levels.

# Site Cover & Building Setbacks

The site cover for the development in the Tourist Accommodation zone is nominated at 50% with building setbacks of 6 metres from main street frontages, 4 metres from secondary street frontages and 2 metres from side boundary or half the average height of the building.

When considering the built form, the proposed building setbacks are generally compliant with the setback requirements. However, there are elements such as retaining structures and pool areas located within the building setback. For example, the plans nominate a setback of 5.5m & 6m to the unconstructed road reserve however pool and deck areas are located within the setback. The setbacks range from 0m (retaining structures on the boundary) to 2 metres (to the pool – Dwelling 4) and 4.5m to the retaining wall of Dwelling 1.

The pool area for Dwelling 4 can be seen in the above image of the south elevation (bottom right) relative to the front boundary. The top of the pool has a height difference of 6m from the driveway and setback 2 metres from the boundary. There is an opportunity to implement landscaping in the 2m terraced setback area which will also include a retaining structure built on the boundary.

Proposed setbacks from Murphy Street are consistent with the adjoining property and other building setbacks observed along Murphy Street. Buildings along Murphy Street generally have reduced setbacks due to the sloping nature of the land and to provide vehicle access.

While the building setback is nominated at 3m from the Murphy Street frontage, retaining walls and pools are proposed to be sited within this area as shown on the plans. The proposed setbacks are consistent with other buildings in the street and the pool and retaining works will be screened from view by the fencing treatment. The proposed setback of 4m from the side boundary is acceptable.

# **External Driveway**

As previously mentioned, the proposal was amended to address concerns raised over the design of the external driveway.

The revised driveway design has largely addressed the concerns with the significant embankment at the lower section that was commencing in front of the existing units fronting Macrossan Street adjacent to Jalun Park.

The new design commences further north and does not rise as sharply as the previous design had proposed.

This has addressed some of the concerns with impacts on the existing units and the esplanade area.

The images below show that the changes in the current revisions result in the driveway being moved approximately 7m northeast to reduce the encroachment across the frontage of the existing units.

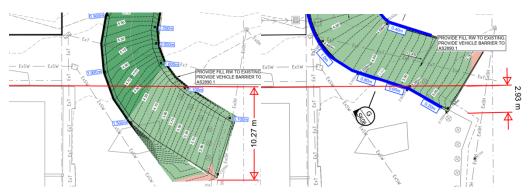


Figure 3. Driveway Design

The images also show that the significant filling and embankment impacts in front of the existing units are largely addressed. The red line in the images shows a projection from the outer wall of the existing units extending across the road frontage.

The previous design (image on the left), proposed a height above ground level of between 1.7m to 1.9m (plus safety barrier) and intruded across the frontage of the units.

The new design proposes a much reduced encroachment, and the height is reduced to 0.6m in line with the building.

The driveway changes have resulted in much tighter turns on the driveway, (see images below).



Figure 4. Driveway Design

The previous design also had a driveway width of 4m with the revised design being 6m in width however no discussion has been provided regarding he change or whether two-way traffic flow is proposed. Having regard to the turn templates provided, these confirm that the driveway can only accommodate one vehicle and one way operation of the driveway. The templates show that within the curved section, two vehicles cannot pass.

The finished surface contours provided on Inertia Engineer's drawing SK007 indicate that the longitudinal grade on the inside of the sharp curves is 25%. This is not consistent with the labelling on the architects plans that claim a maximum grade of "1 in 5.6 internal curve", (17.9%). This may be reflective of the travelled path, which raises questions on why the driveway design uses 6m width that cannot be driven on. AS2890.1 – Off Street Parking Code advises that the minimum inside radius for curved roadways and ramps is 4m. The current driveway does not appear to achieve the minimum set out in the Australian Standard. Vehicle barriers will also need to be provided in certain locations.

A condition of the approval requires further detail to be provided regarding operating procedures regarding the control of a one-way entry and exit. Further design modifications maybe necessary.

## **Internal Driveway**

Proposal plans illustrate 4 columns in the driveway area, appearing to potentially constrain entry and exit from garages for Dwelling 2 and Dwelling 3. Turn templates have been provided but only for the B85 vehicle and show some garages require multiple movements to access. It is noted that any inconvenience is internal to the development and will not impact external stakeholders. The frequency of vehicle movements is also expected to be low given the location of the site and the number of units proposed.

Driveway grade internal from the gate (DA 30.002 Rev G), requires retaining walls either side of driveway to interface within building. Section 2 on DA.001 Rev K confirms retaining walls either side of the driveway.

Ramp and gate width of DA010.01 scales at approximately 4.9m. Scaling on various plans indicates driveway width on ramp is limited to approx. 4.9m. The Applicant will need to confirm if the driveway is intended to allow for 2-way vehicle traffic. This element will need to be further explored as part of the vehicle entry and exit considerations for the external driveway.

#### Stormwater

The elevations shown on drawing DA 20.004 and DA 20.002 (and sections 1 and 2 on DA30.001) do not reflect the representations on the Inertia Stormwater Plans as they do not show how stormwater run-off will be controlled within the lower portion of the site.



Figure 5. Inertia Engineering Stormwater swale Drain - blue arrows

The Architect's sections do not show the stormwater drain along the southern boundary (as proposed by the Engineer) and therefore do not appear to make provision for the runoff to be contained within the site and conveyed to a lawful point of discharge.

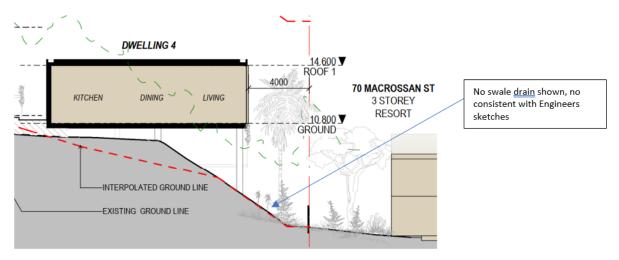


Figure 6. Section 2 from Architects Drawings

The screening density proposed appears to only be achievable with unrestricted use of the lower offset corridor, whereas stormwater conveyance requires the certainty of a defined (clear) flow path.

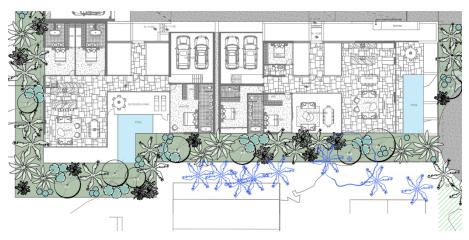


Figure 7. Landscape Plan

The two proposals of stormwater conveyance and dense screening plantings are mutually exclusive of each other.

The preferred approach to achieve both a superior stormwater outcome and the desired planting/screening outcome for the development is to upgrade the stormwater along the northwestern and south-western boundaries and through to the esplanade outlet.

The development has impacts on the stormwater that are not fully acknowledged in the information presented to Council. The development proposes to connect to the stormwater pit near the south-eastern corner of the site. The use of an internal pit and pipe system, roofs, guttering etc will result in a more efficient and effective rainfall capture than the current site. This results in increased capture and direct flows to the stormwater pit and downstream pipeline which is known to have capacity limitations.

The Applicant's response to this issue is that the changed conditions as a consequence of the development will not impact existing operations. This is not supported by the assessment of the proposal. Council's assessment has identified a significantly larger catchment area to that nominated and assessed by the Applicant. The Applicant has identified and external stormwater catchment of 1.2Ha to the downstream inlet pit just outside the site, whereas Council's plans indicate a catchment of up to 3.55Ha. Part of the difference may be in the operation (and effectiveness) of cut off drains installed above Murphy Street. The larger area assumes that in the 100-year event the upslope cut-off drains do little to divert flows.

Conditions contained within the recommendation address the issue of stormwater and require upgrades to adequate service the proposed development and provide the opportunity to implement landscaping as intended. At the same time, the stormwater network will provide additional capacity as a consequence of the upgrades.

A Sketch Plan has been prepared to illustrate the drainage solution and is reference in conditions of the approval and forms part of the suite of approved plans. Refer to Attachment 1.

## **Water Supply**

The extent of water main shown on the supporting engineering plans is not supported.

The water main is to be extended further north to the Murphy Street road formation to enable a ring main to be established.

The proposed works to take place in the road reserve and the existing steep bank adjacent Murphy Street will significantly limit future construction options and access to the upper section of the Esplanade.

A condition of approval requires this section of the watermain be completed prior to the construction of the driveway with its retaining walls and cuttings.

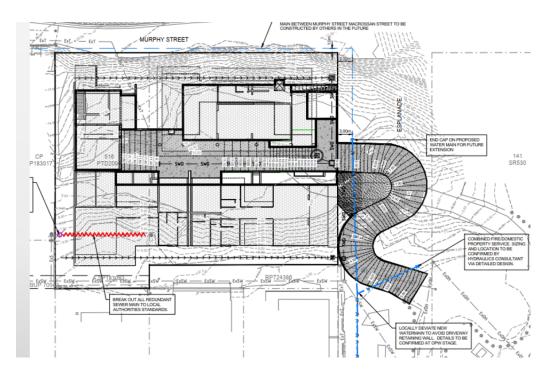


Figure 8. Water main proposed to terminate on other side of the driveway

# **Sewer Reticulation**

While there is an ability to connect to sewer, the information submitted with the application is not definitive as to the preferred approach.

Unless consent can be obtained from the adjoining owner to make connection at a point that can control the site, the Applicant will be required to construct new sewer which will connect into the existing gravity main in Macrossan Street which then connects to the pump station.

Conditions of approval have been included to address connection to Council's sewer network.

# **Public Notification / Submissions**

Not required for code assessable development.

# **Referral Agency Requirements**

None Applicable.

#### **Internal Referrals**

Advice was received from the following internal departments:

Table 2.

Department	Comments
Water Reticulation	Made comments regarding the desire to extend water main to Murphy Street to enable a ring main to be established. Conditions included in the recommendation to achieve this.
Waste Water	Further detail required as to how the connection to the sewer will be achieved. The preference is to undertake works external to the site and make connection to the existing pump station. Conditions included in the recommendation to reflect the preferred approach.
Infrastructure	Raised concerns with the service corridor through to Murphy Street and the issues surrounding stormwater and limitations of the existing system. Conditions have been included in the recommendation to service the development and increase capacity in the existing system.
Environmental Health	None Applicable

#### Consultation

The proposed development was workshopped with Council on Tuesday 16 August 2022.

#### ADOPTED INFRASTRUCTURE CHARGES

The development does trigger Infrastructure Charges.

Refer to Attachment 3 to review the calculated Infrastructure Charge.

## **COUNCIL'S ROLE**

Council can play a number of different roles in certain circumstances and it is important to be clear about which role is appropriate for a specific purpose or circumstance. implementation of actions will be a collective effort and Council's involvement will vary from information only through to full responsibility for delivery.


The following area outlines where Council has a clear responsibility to act:

Regulator: Council has a number of statutory obligations detailed in numerous regulations and legislative Acts. Council also makes local laws to ensure that the Shire is well governed. In fulfilling its role as regulator, Council will utilise an outcomes based approach that balances the needs of the community with social and natural justice.

Under the Planning Act 2016 and the Planning Regulation 2017, Council is the assessment manager for the application.

#### **ATTACHMENTS**

- 1. Attachment 1 - Proposal Plans [5.6.1 - 41 pages]
- 2. Attachment 2 - Infrastructure Charges [5.6.2 - 1 page]

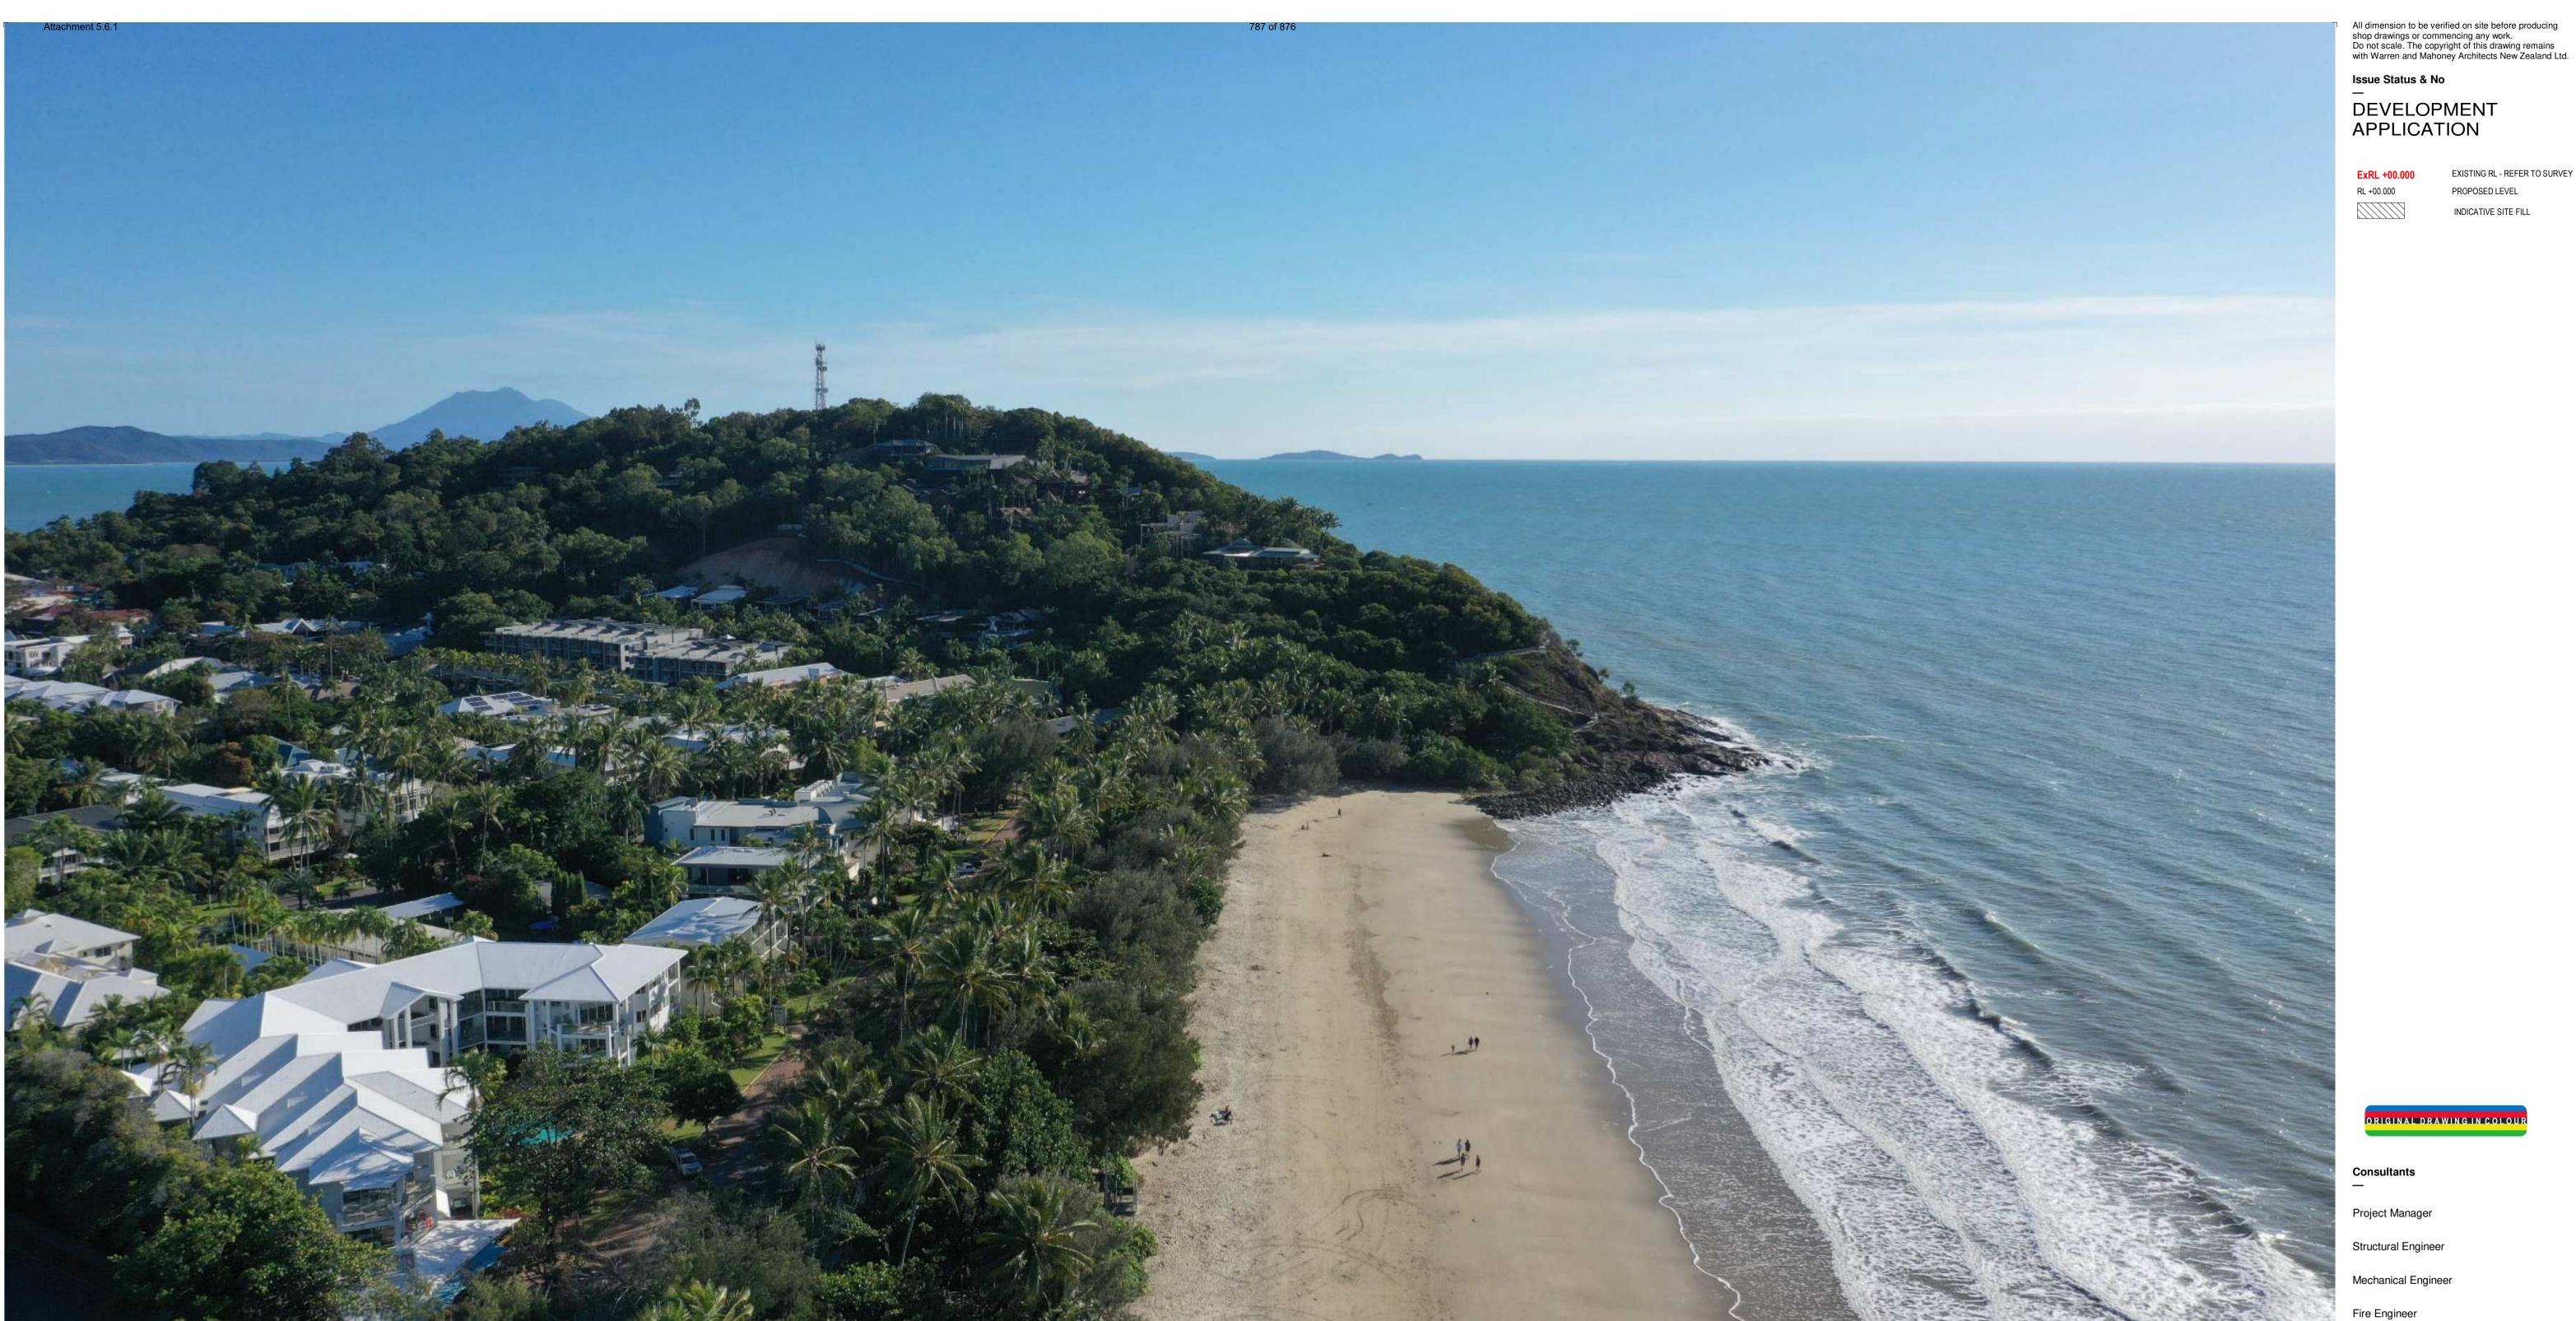

69 - 73 MURPHY STREET | PORT DOUGLAS

DEVELOPMENT APPLICATION

JULY 2022

# DA DRAWING LIST

27.12.10.11.11.11		
DA01.001	SITE CONTEXT	Ε
DA01.002	SITE IMAGERY	Ε
DA01.003	SITE IMAGERY	Ε
DA01.004	SITE ANALYSIS	Ε
DA01.005	SITE SURVEY	Ε
DA01.006	SITE SURVEY	Ε
DA01.007	INTERPOLATED SURVEY	F
DA03.001	PROPOSED SITE PLAN	G
DA03.001 DA03.002	SITE ACCESS PLAN	С
DA03.002	SITE ACCESS PLAN	C
DA010.01	GROUND FLOOR PLAN	K
DA010.02	L01 FLOOR PLAN	Κ
DA010.03	L02 FLOOR PLAN	Κ
DA010.04	L03 FLOOR PLAN	Κ
DA010.05	ROOF PLAN	J
DA20.001	NORTH FLEVATION	Н
DA20.001	EAST ELEVATION	Н
DA20.002	SOUTH ELEVATION	Н
DA20.003	WEST ELEVATION	G
DA20.100	MURPHY STREET ELEVATION	Α
D/ 120.100	MONTH OTHER ELEVATION	/1

DA30.001 DA30.002 DA30.003	TYPICAL SECTIONS TYPICAL SECTIONS POOL SECTIONS
DA50.001 DA50.002 DA50.003	DEVELOPMENT SUMMARY - GF DEVELOPMENT SUMMARY - SIT DEVELOPMENT SUMMARY - LAI
DA80.001 DA80.002	SOLAR ANALYSIS - JUNE 21 SOLAR ANALYSIS - DECEMBER
DA90.001 28	MATERIALS

ORIGINAL DRAWING IN COLOUR

EXISTING RL - REFER TO SURVEY

PROPOSED LEVEL

INDICATIVE SITE FILL

Project Manager

Structural Engineer

Mechanical Engineer

Electrical Engineer

**GURNER TM** GURNER™


Warren and Mahoney Architects Australia Pty Ltd


Level 4, 141 Flinders Lane Melbourne VIC 3000 Phone + 61 3 8547 6977

Registered Architects and Designers www.warrenandmahoney.com

69-73 MURPHY STREET PORT DOUGLAS

Ordinary Council Meeting - 30 August 2022

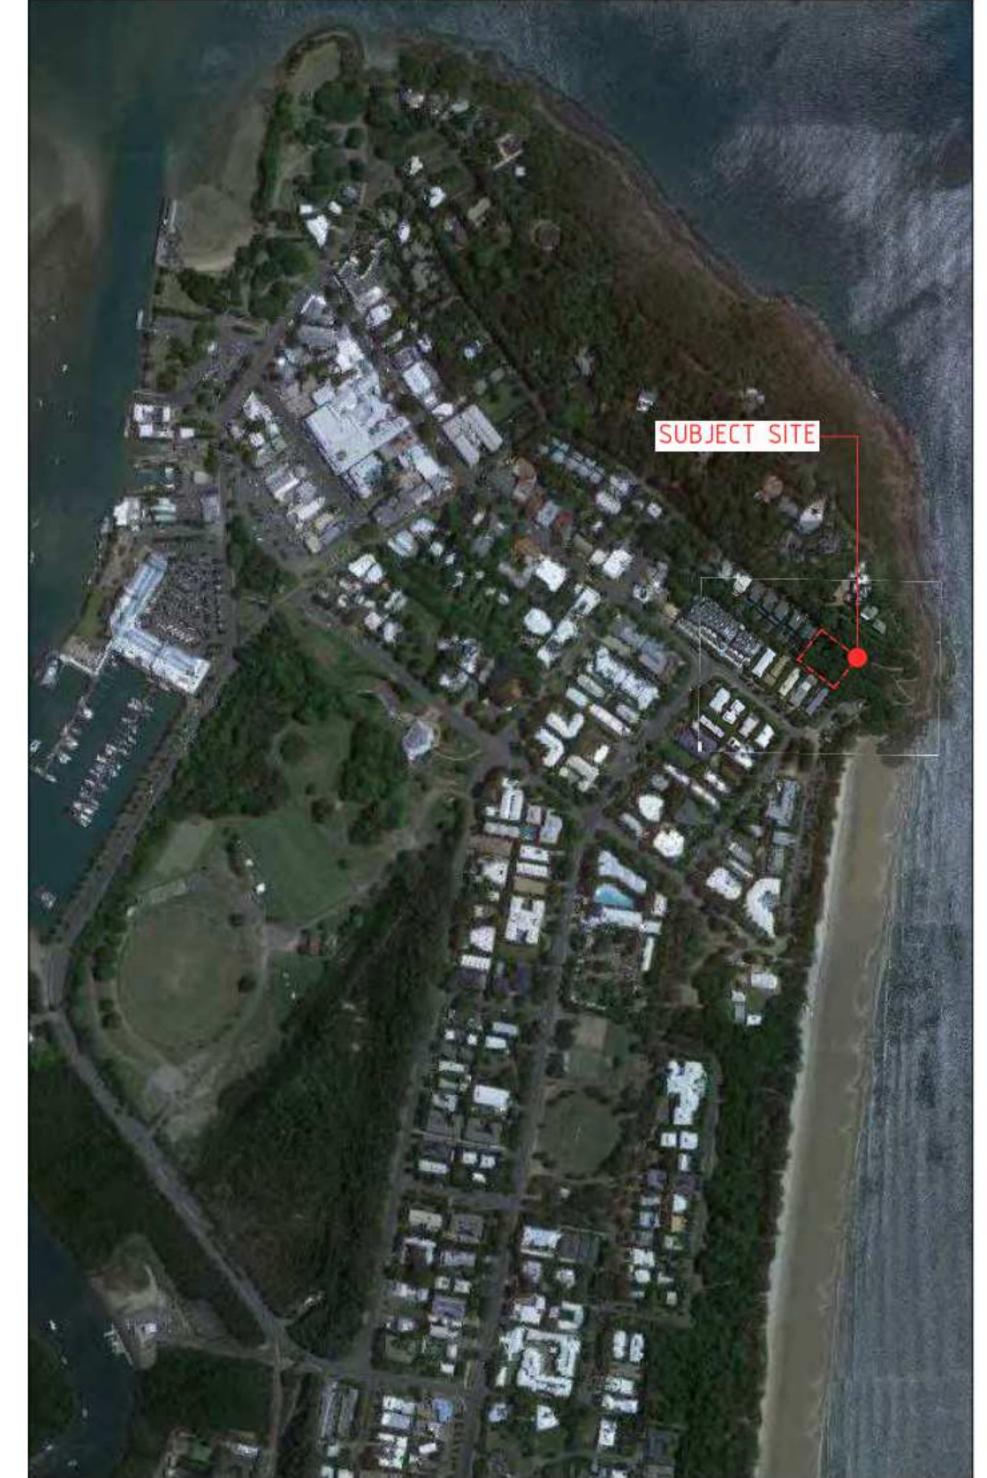

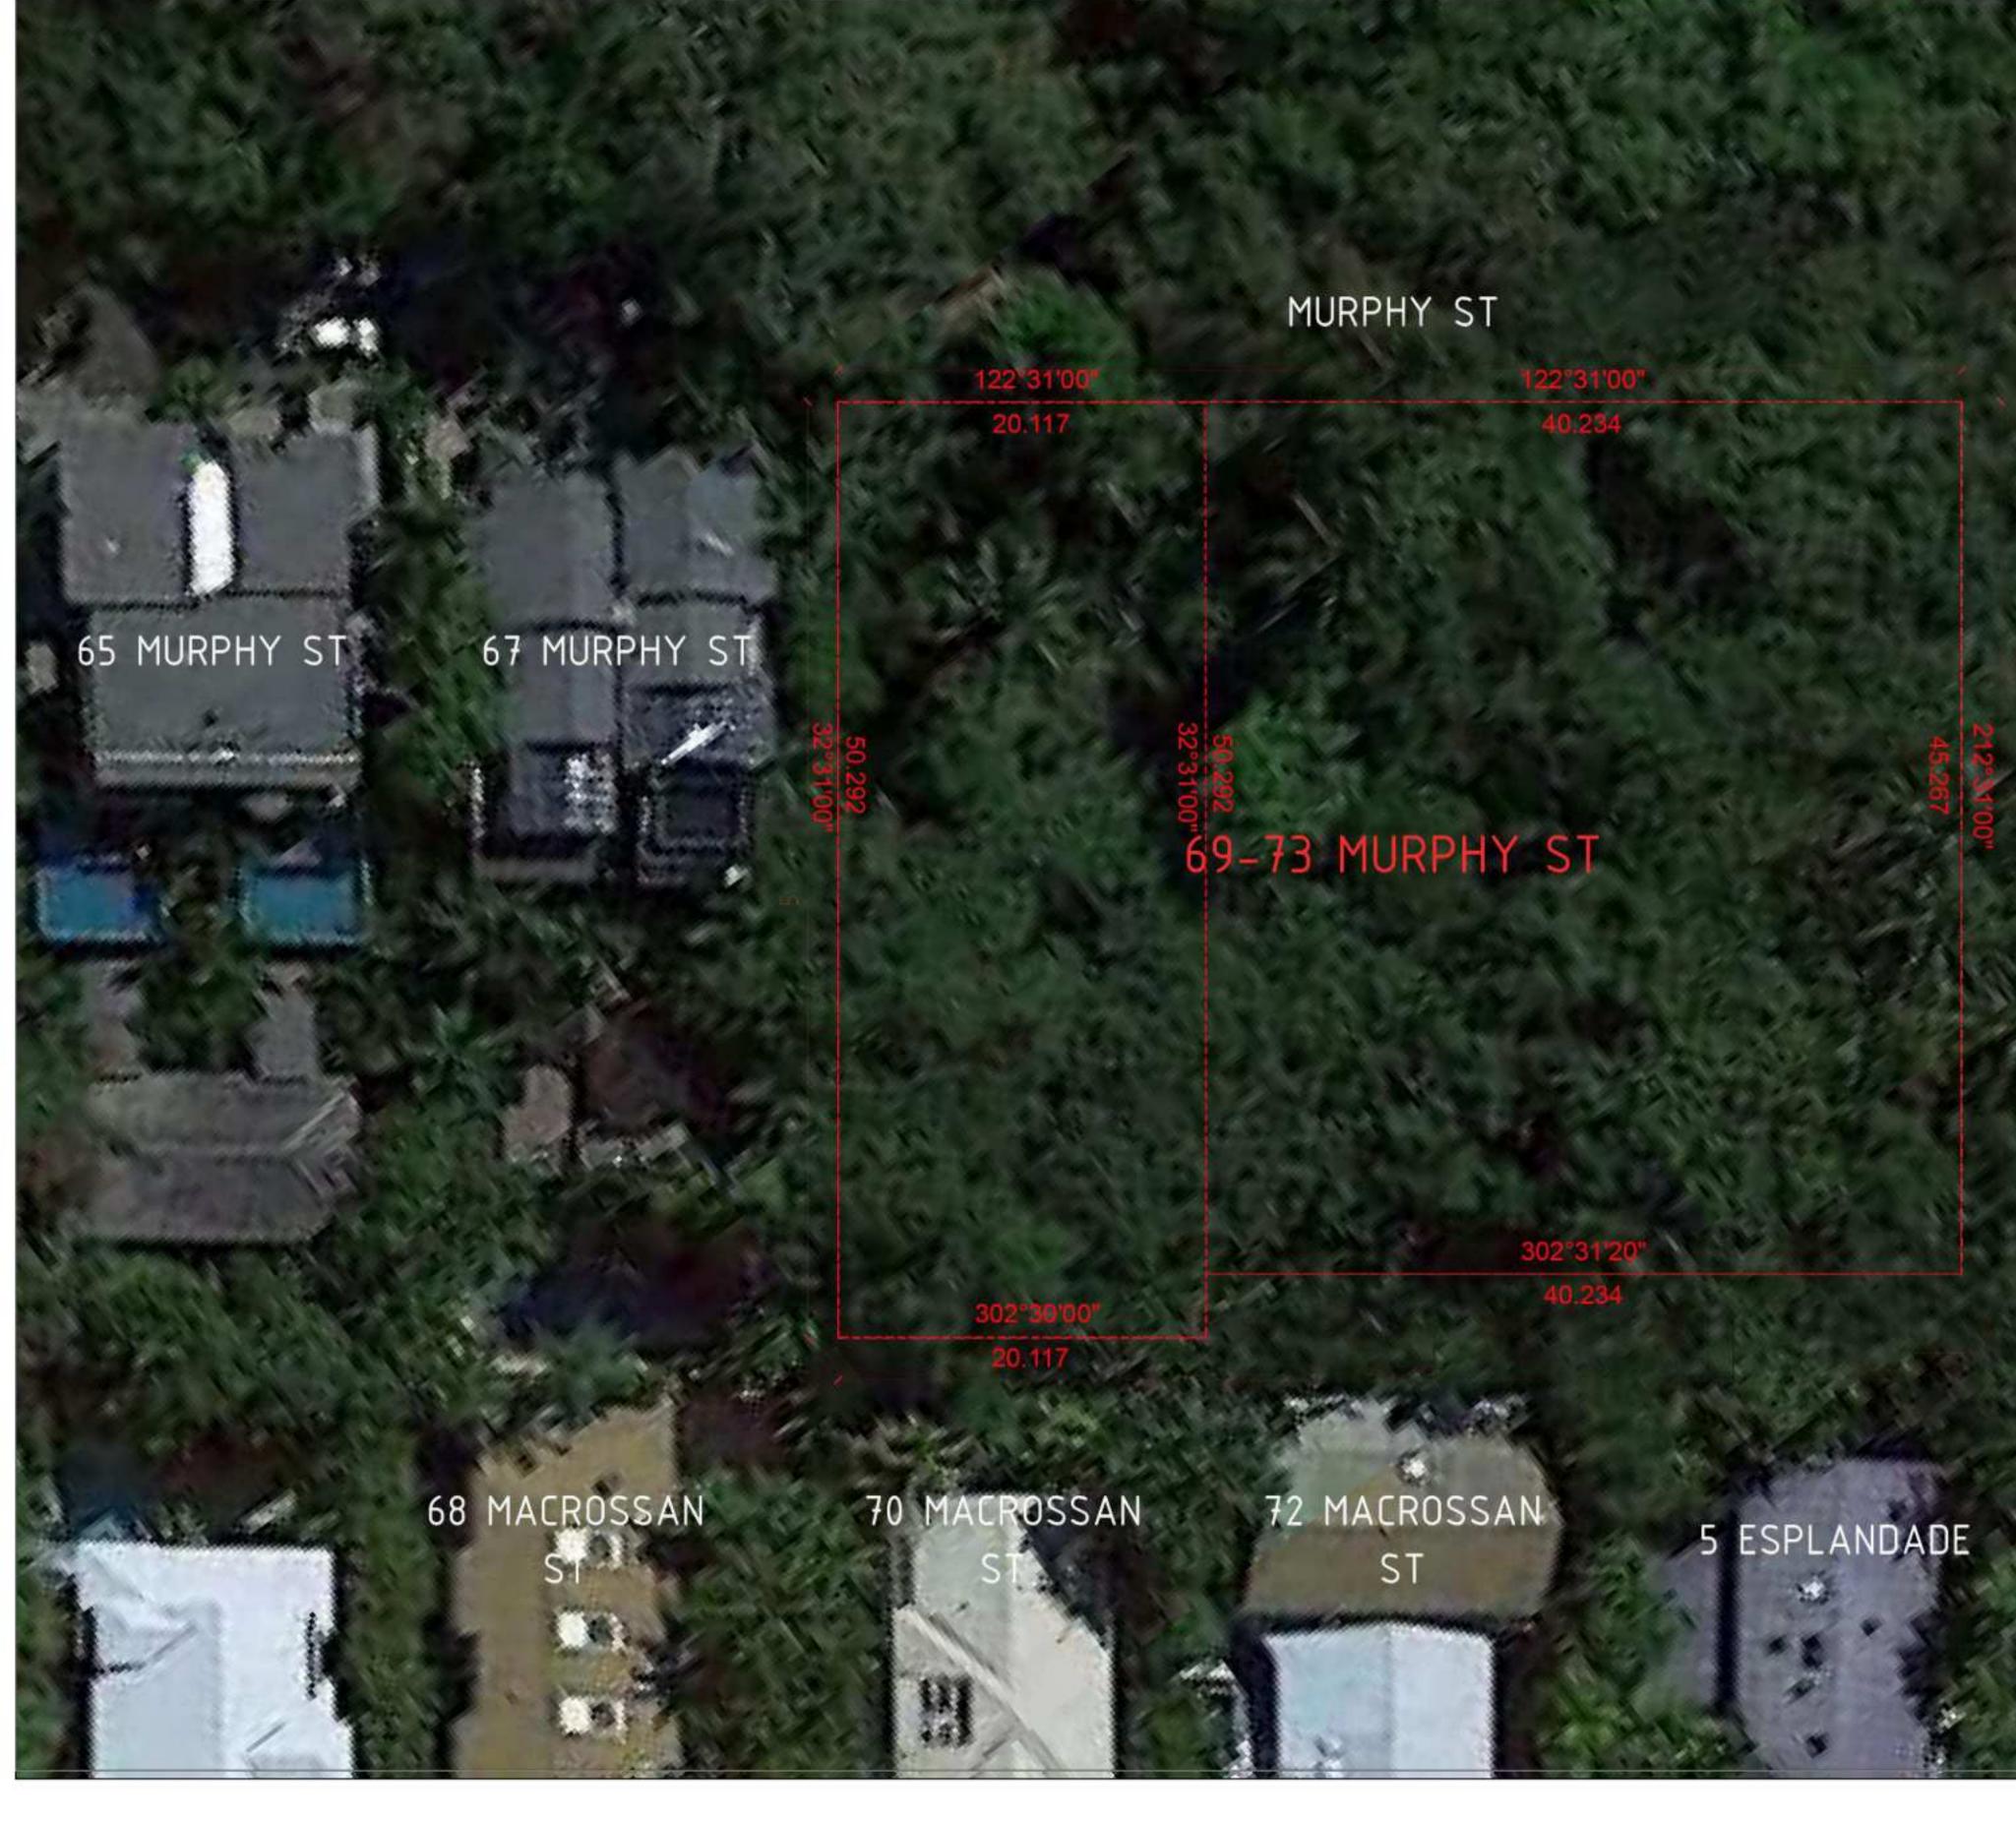

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Revisions
—

A 09/09/21 FOR CONSULTANT COORDINATION
B 15/09/21 FOR INFORMATION
C 22/09/21 DRAFT DA
D 04/10/21 ISSUE FOR DA

E 13/07/22 ISSUE RFI 02

Note

Consultants
—
Project Manager

Structural Engineer

Mechanical Engineer

Fire Engineer

Electrical Engineer
Ordinary Council Meeting - 30 August 2022

Client
—
GURNER TM

GURNER TM

Project Title

69-73 MURPHY

STREET PORT DOUGLAS

JRPHY SITE CONTEXT

All dimension to be verified on site before producing shop drawings or commencing any work.
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Drawing Status

DEVELOPMENT
APPLICATION

**Drawing Title** 

Drawing Details
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 Scale
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 Date
 13/07/22


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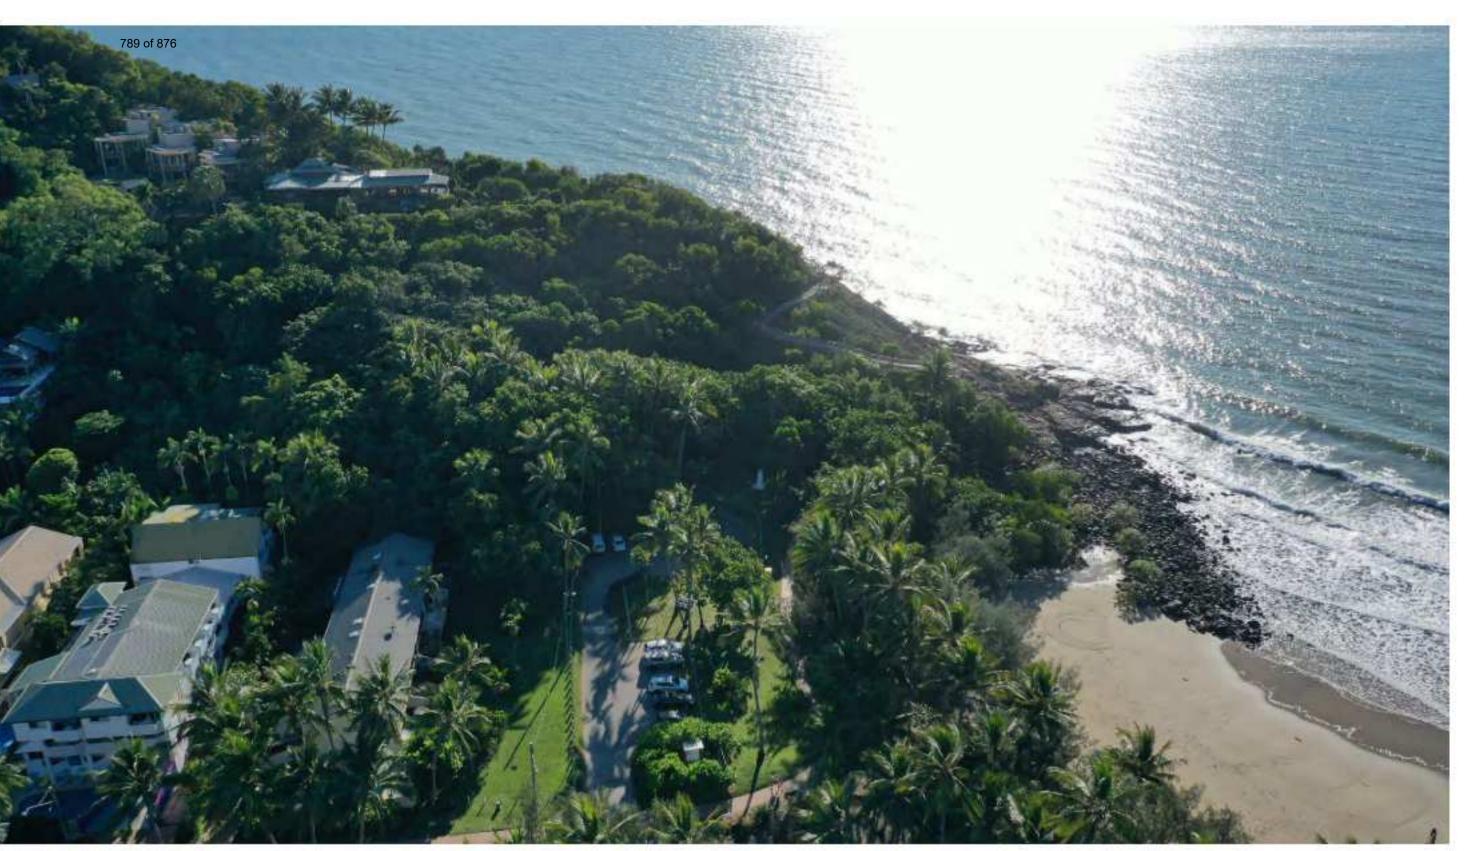
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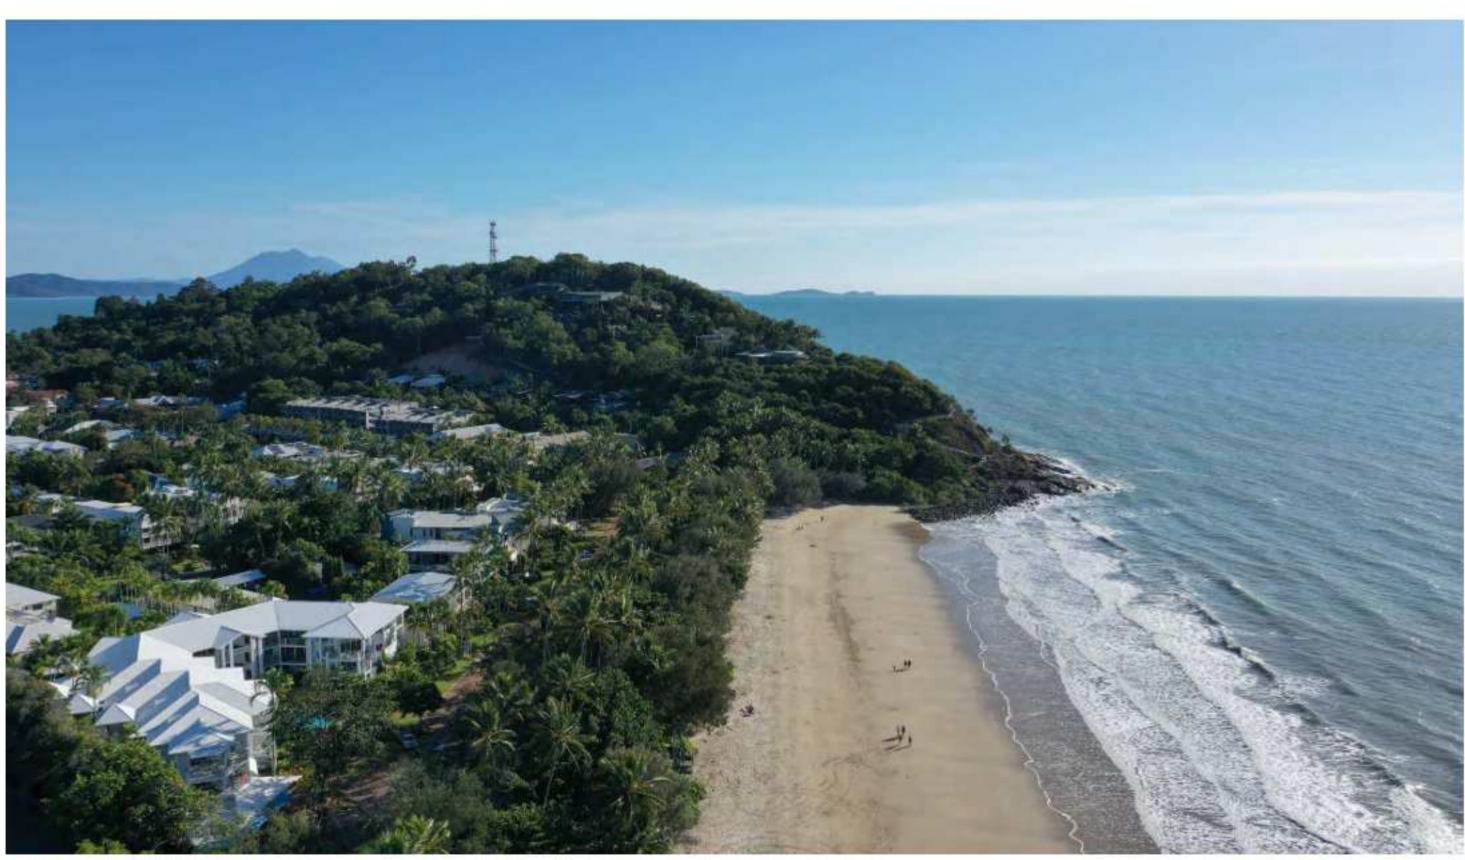
Revision E





UAV DRONE POSITION 2 Lat 16:29:0733 Long 145:27:5673



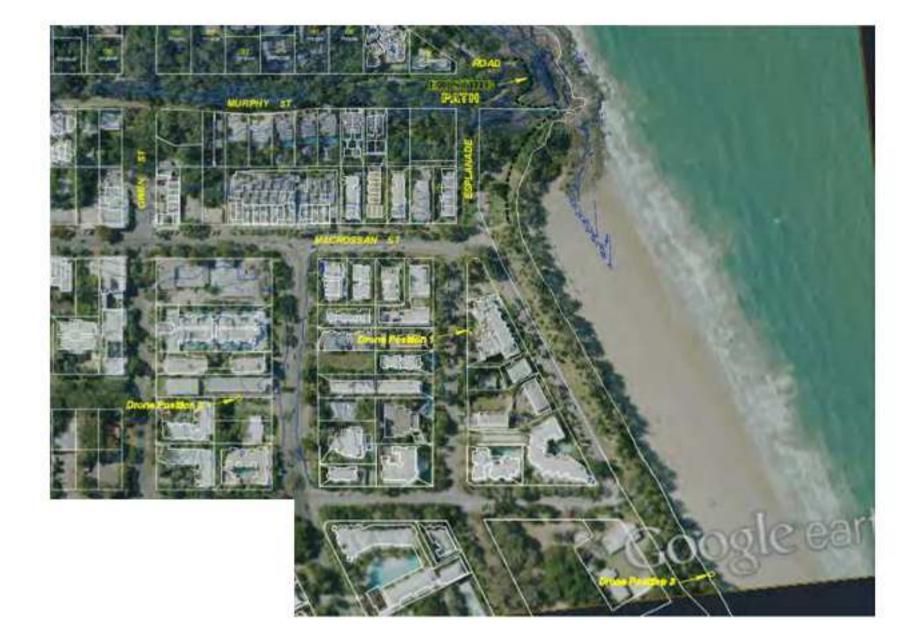

UAV DRONE POSITION 2 Lat 16:29:1991 Long 145:28:0479

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A 09/09/21 FOR CONSULTANT COORDINATION C22/09/21 DRAFT DA D04/10/21 ISSUE FOR DA

B 15/09/21 FOR INFORMATION E 13/07/22 ISSUE RFI 02

Consultants

Project Manager

Structural Engineer

Mechanical Engineer

Fire Engineer

Electrical Engineer Ordinary Council Meeting - 30 August 2022

**GURNER TM** GURNER™ Project Title

69-73 MURPHY STREET PORT DOUGLAS

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Drawing Title
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SITE IMAGERY

**Drawing Status** DEVELOPMENT APPLICATION

**Drawing Details** Scale

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DA01.002

Revision

☐ Attachment 5.6.1 790 of 876


















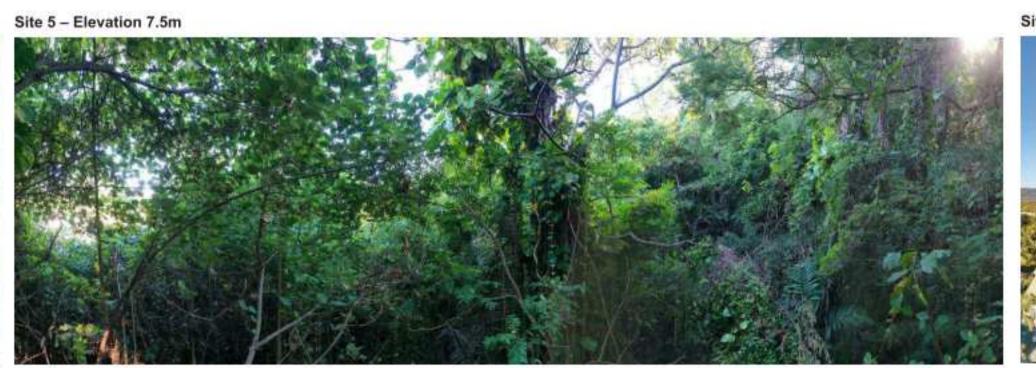



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A 09/09/21 FOR CONSULTANT COORDINATION B 15/09/21 FOR INFORMATION C22/09/21 DRAFT DA D04/10/21 ISSUE FOR DA E 13/07/22 ISSUE RFI 02

Consultants Project Manager Structural Engineer Mechanical Engineer

Fire Engineer

Electrical Engineer Ordinary Council Meeting - 30 August 2022

**GURNER™** 

Client —

**GURNER TM** 

Project Title 69-73 MURPHY STREET

PORT DOUGLAS

All dimension to be verified on site before producing shop drawings or commencing any work.


Do not scale. The copyright of this drawing remains with Warren and Mahoney Architects New Zealand Ltd.


Drawing Title
— SITE IMAGERY

**Drawing Status** DEVELOPMENT APPLICATION

**Drawing Details** Scale 1 : 1@ A1 13/07/22 Job No 9663 Drawn ND Checked **Drawing No** Revision DA01.003

Attachment 5.6.1

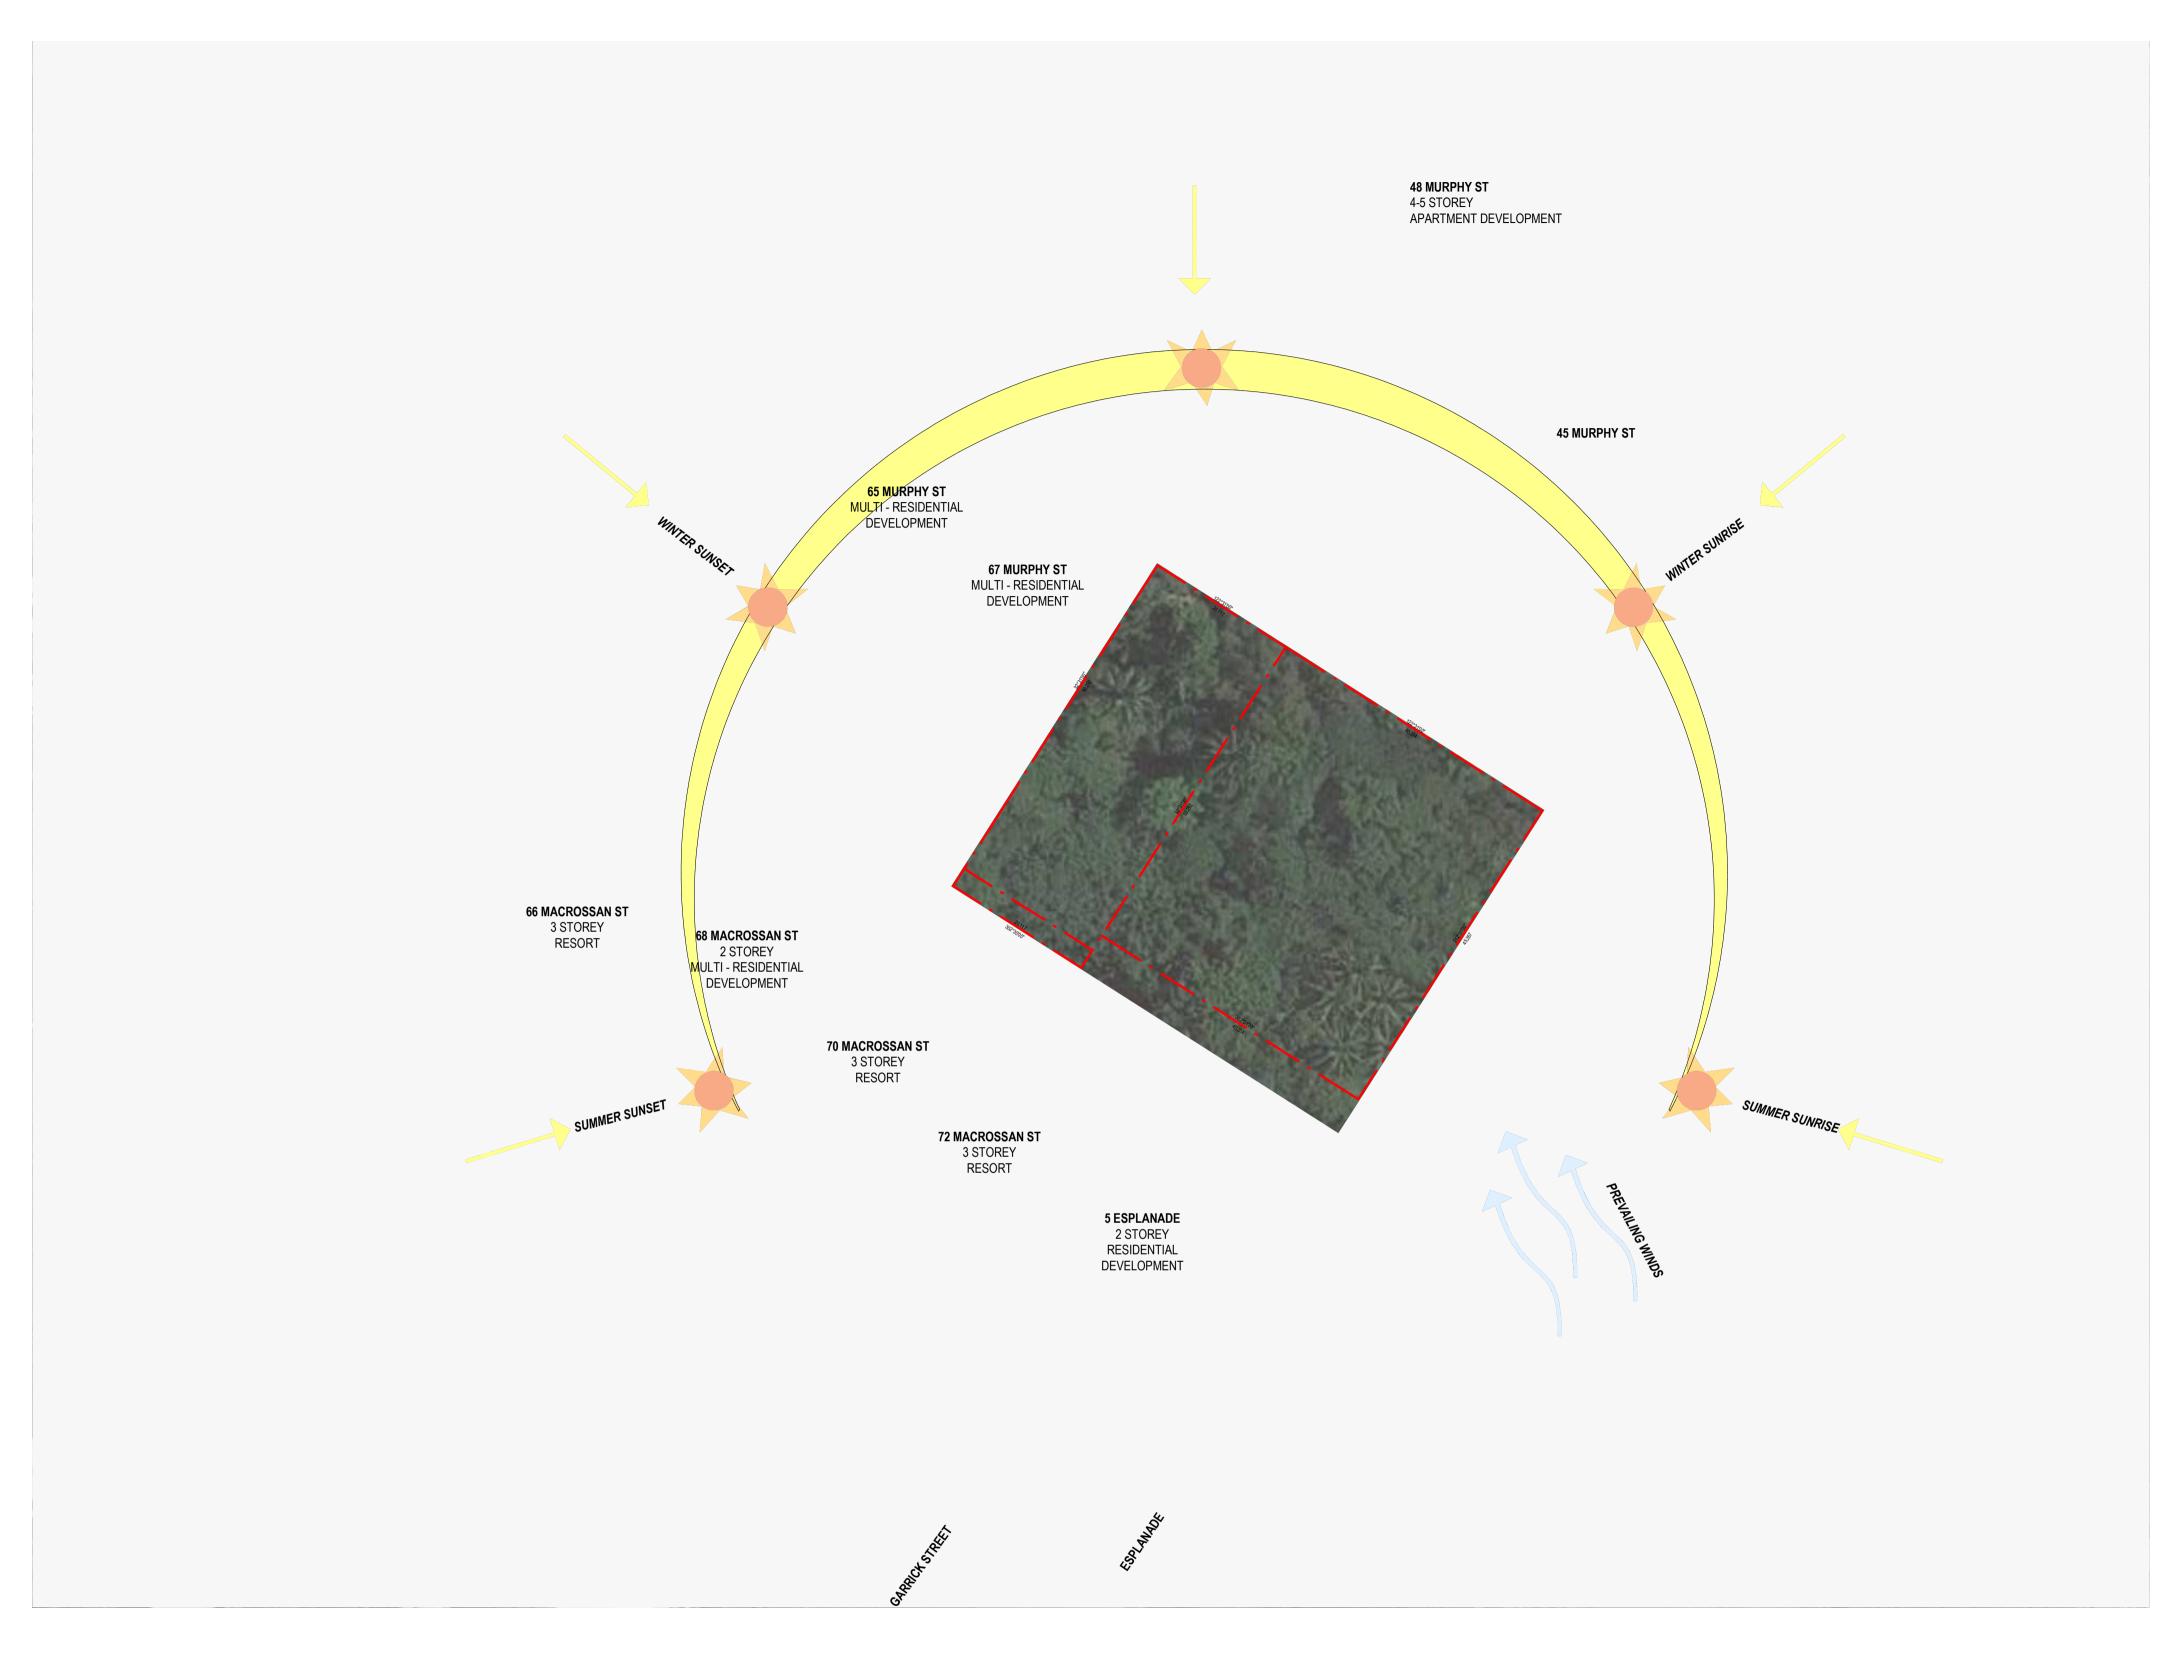

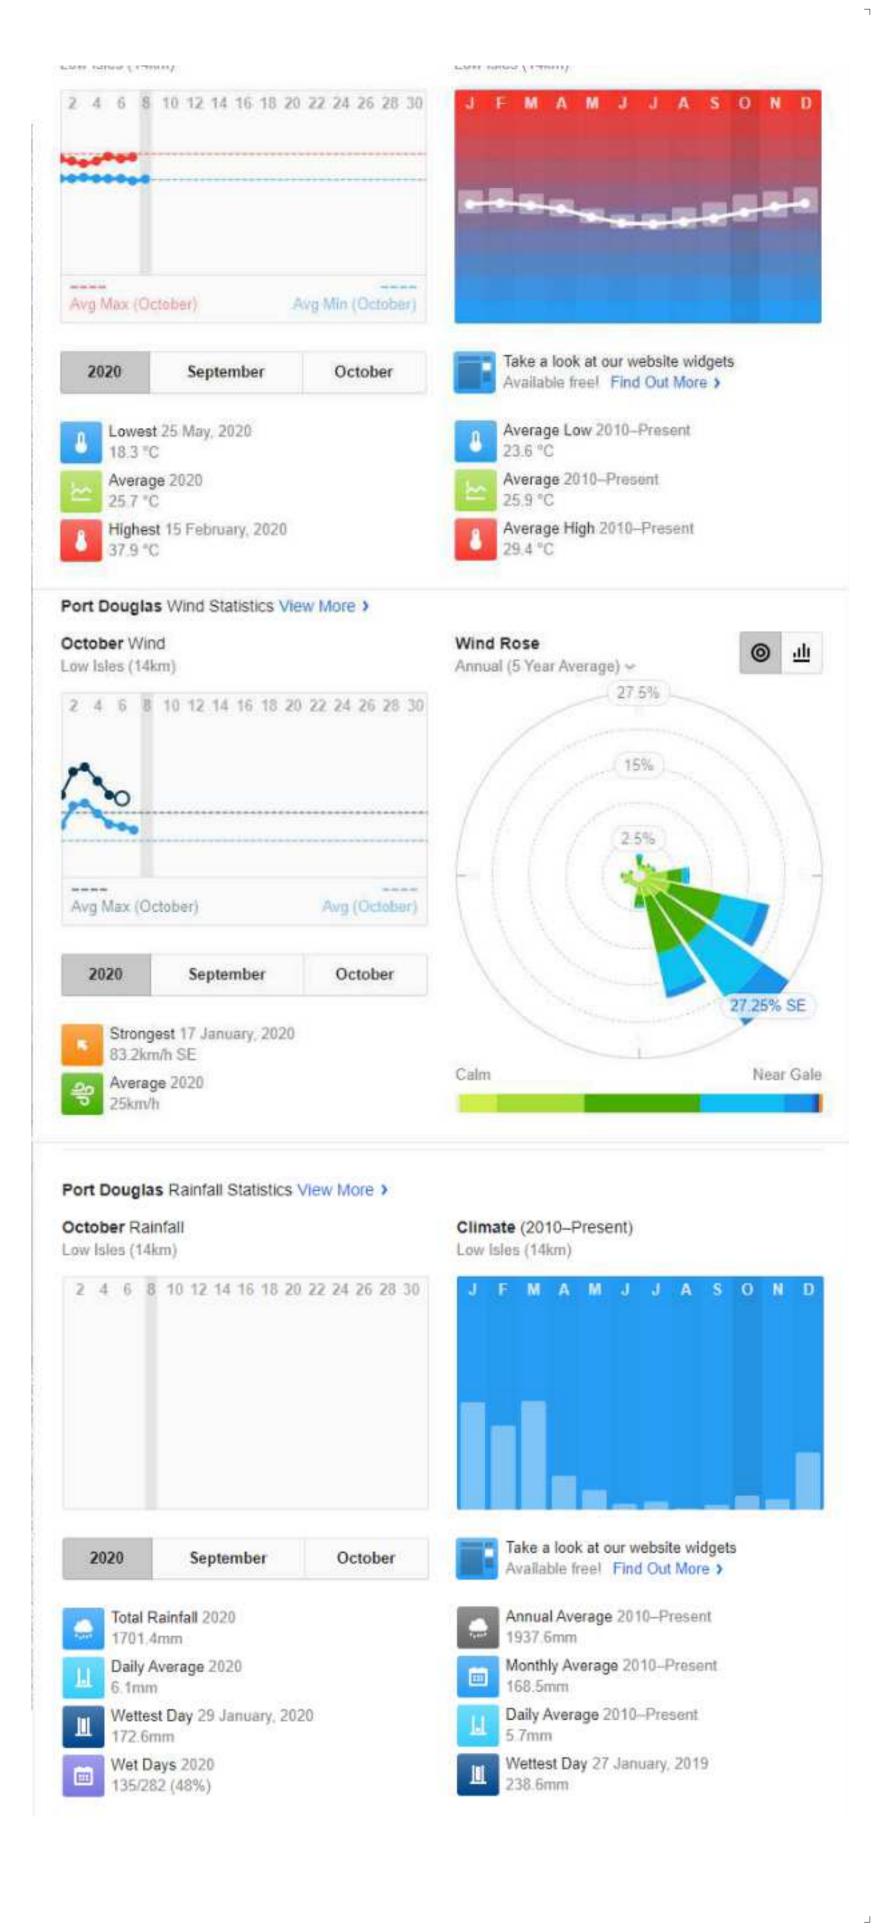

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Phone + 61 3 8547 6977


— Registered Architects and Designers www.warrenandmahoney.com

Revisions —

A 09/09/21 FOR CONSULTANT COORDINATION
B 15/09/21 FOR INFORMATION
C 22/09/21 DRAFT DA
D 04/10/21 ISSUE FOR DA
E 13/07/22 ISSUE RFI 02

OR CONSULTANT
DORDINATION
OR INFORMATION
RAFT DA
SUE FOR DA
SUE RFI 02

Notes

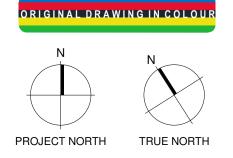

Consultants
—
Project Manager
Structural Engineer
Mechanical Engineer

Electrical Engineer Ordinary Council Meeting - 30 August 2022

Fire Engineer

791 of 876

Client
—
GURNER TM

GURNER TM

Project Title

69-73 MURPHY

STREET

PORT DOUGLAS

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Drawing Title
—
SITE ANALYSIS

Drawing Status
DEVELOPMENT
APPLICATION

Drawing Details

Scale As indicated@ A1
Date 13/07/22
Job No 9663
Drawn Checked ND

Drawing No Revision

DA01.004




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A 09/09/21 FOR CONSULTANT COORDINATION B 15/09/21 FOR INFORMATION C22/09/21 DRAFT DA D04/10/21 ISSUE FOR DA E 13/07/22 ISSUE RFI 02



Project Manager Structural Engineer Mechanical Engineer

Fire Engineer

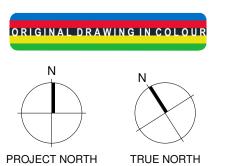Electrical Engineer
Ordinary Council Meeting - 30 August 2022

**GURNER TM** GURNER™

69-73 MURPHY STREET PORT DOUGLAS

All dimension to be verified on site before producing shop drawings or commencing any work.

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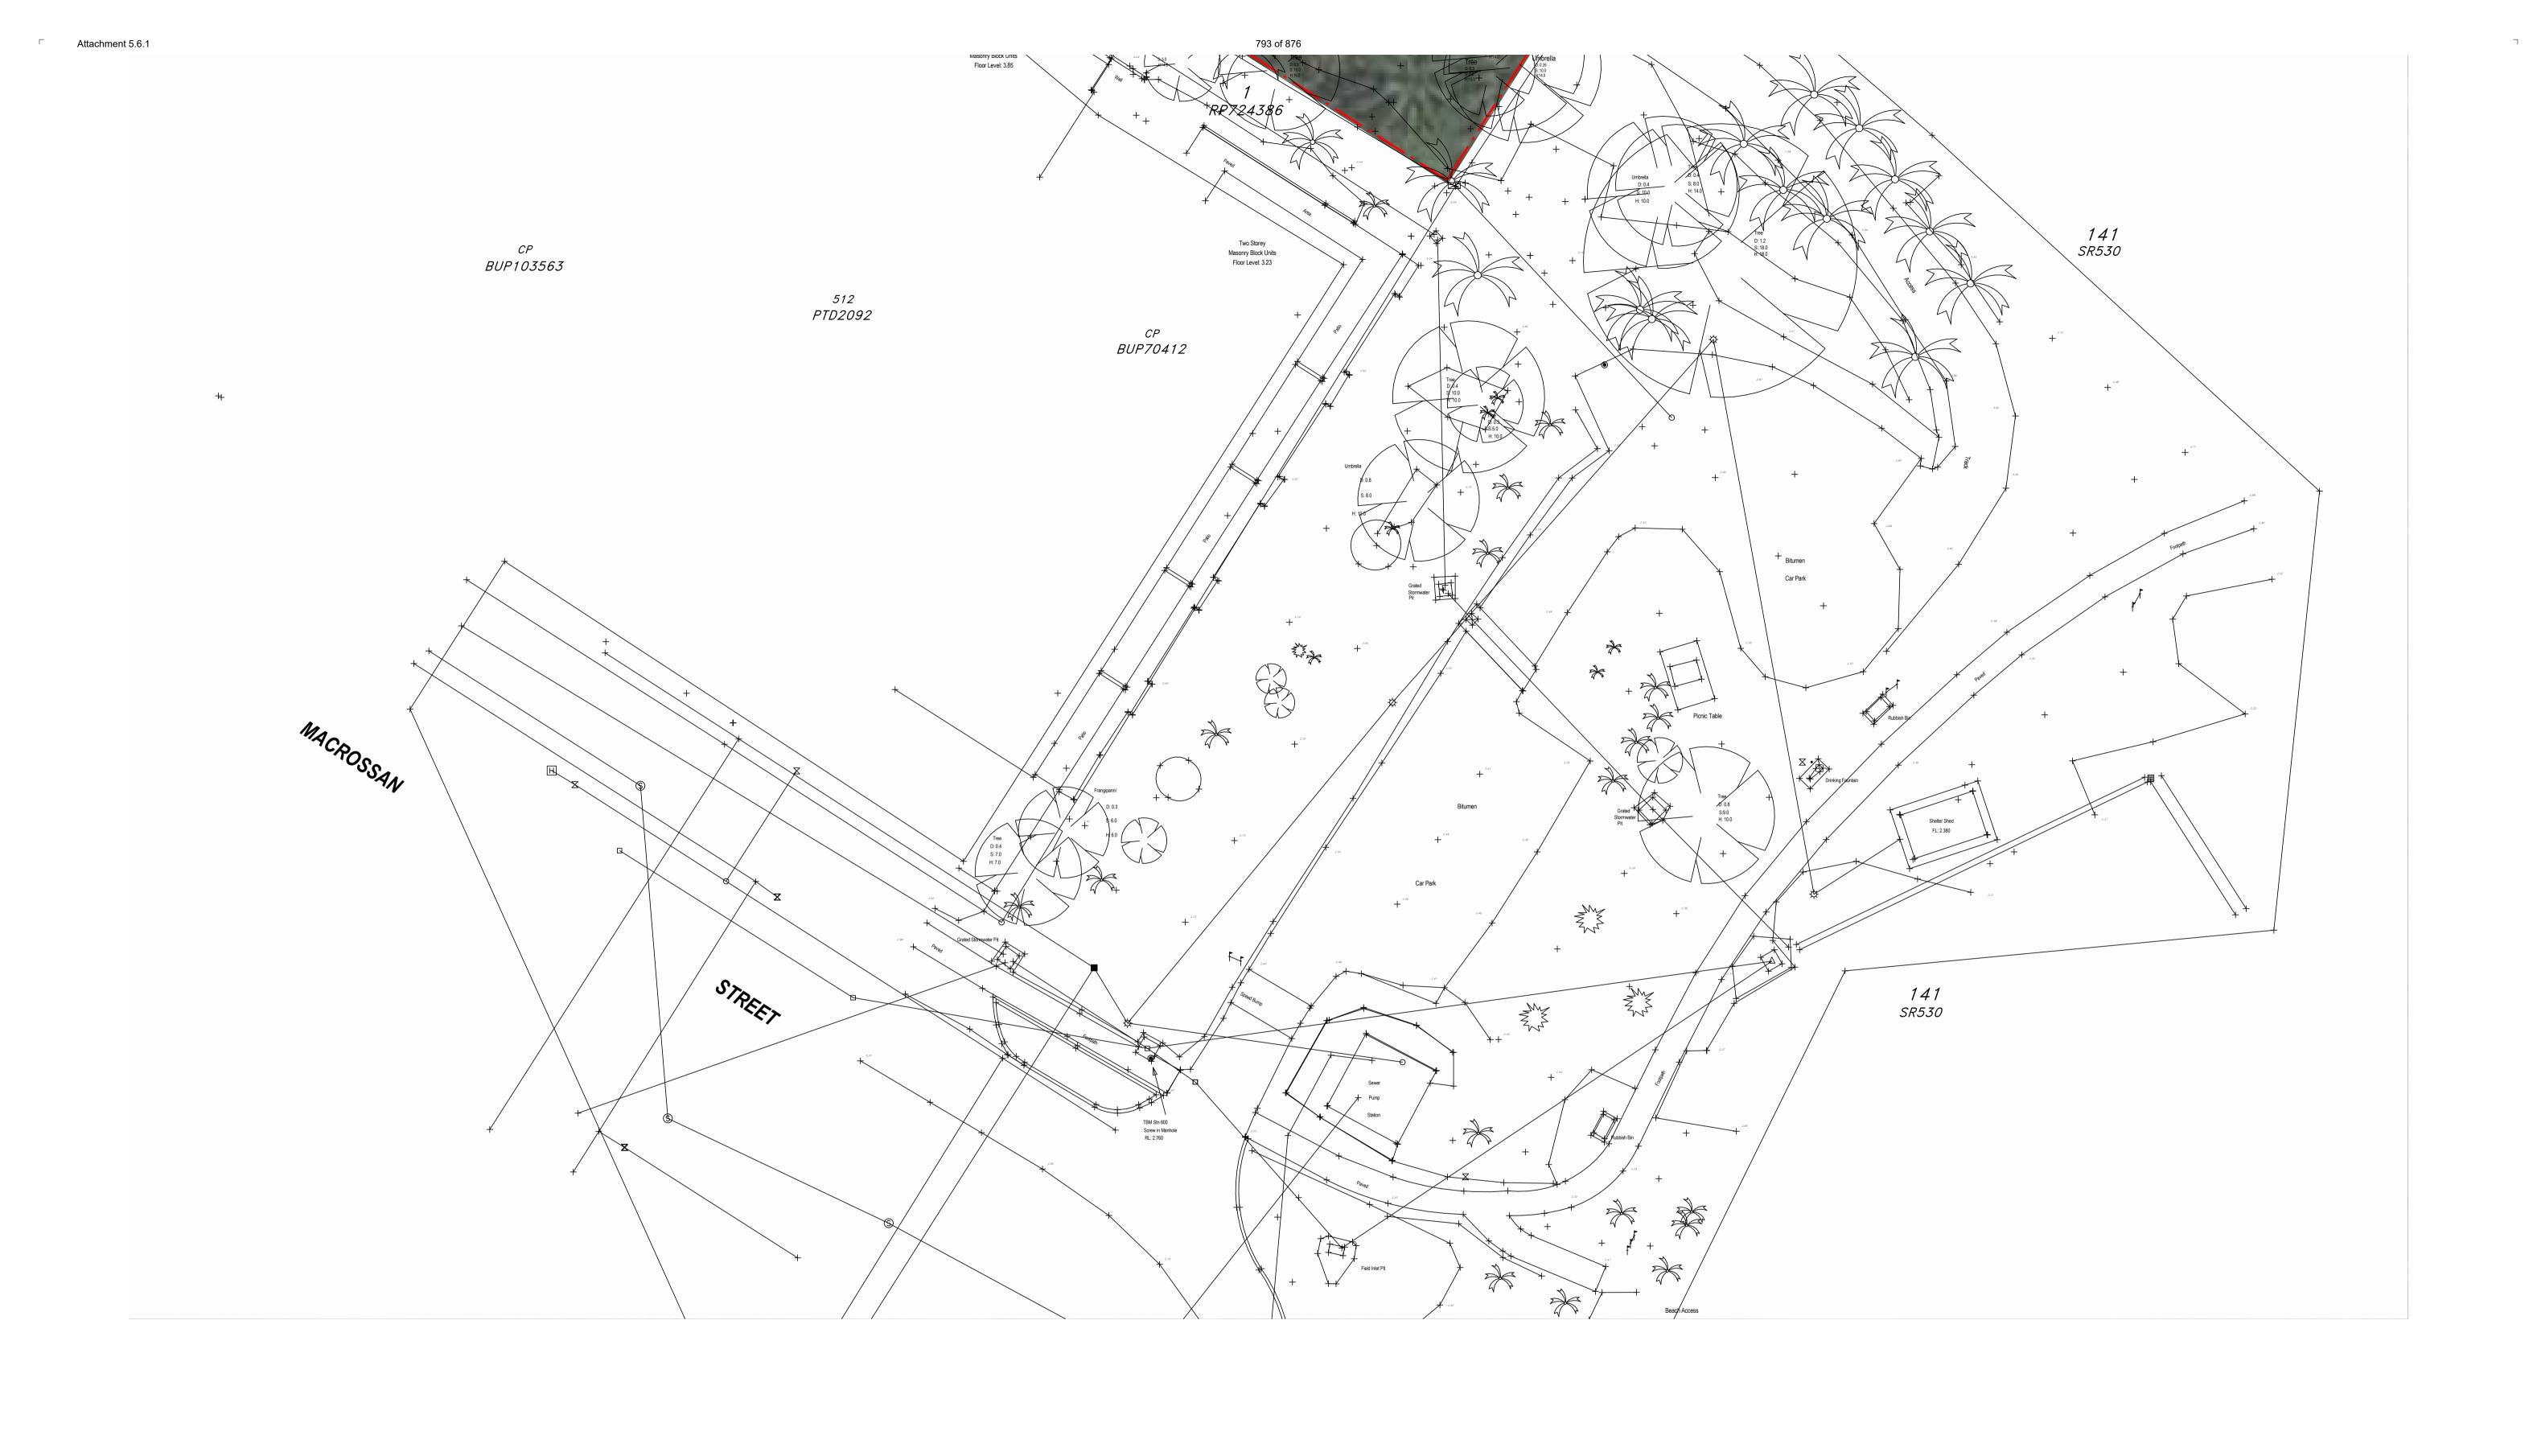
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Drawn Checked **Drawing No** 

**Drawing Status** DEVELOPMENT APPLICATION

13/07/22 9663 Job No ND Revision DA01.005

1 : 200@ A1



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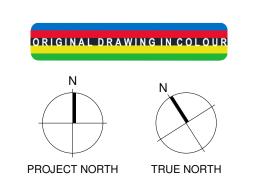
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B 15/09/21 FOR INFORMATION
C 22/09/21 DRAFT DA
D 04/10/21 ISSUE FOR DA
E 13/07/22 ISSUE RFI 02

LTANT ION MATION Notes



Consultants
—
Project Manager
Structural Enginee

Electrical Engineer
Ordinary Council Meeting - 30 August 2022

Structural Engineer

Mechanical Engineer

Fire Engineer

GURNER TM

GURNER TM

Client — Project Title

-69-73 MURPHY
STREET
PORT DOUGLAS

All dimension to be verified on site before producing shop drawings or commencing any work.

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Drawing Title

—
SITE SURVEY

DEVELOPMENT

APPLICATION

Drawing Status

Drawing Details

Scale 1:200@ A1

Date 13/07/22


Job No 9663

Drawn 
Checked ND

Drawing No Revision

DA01.006

Attachment 5.6.1

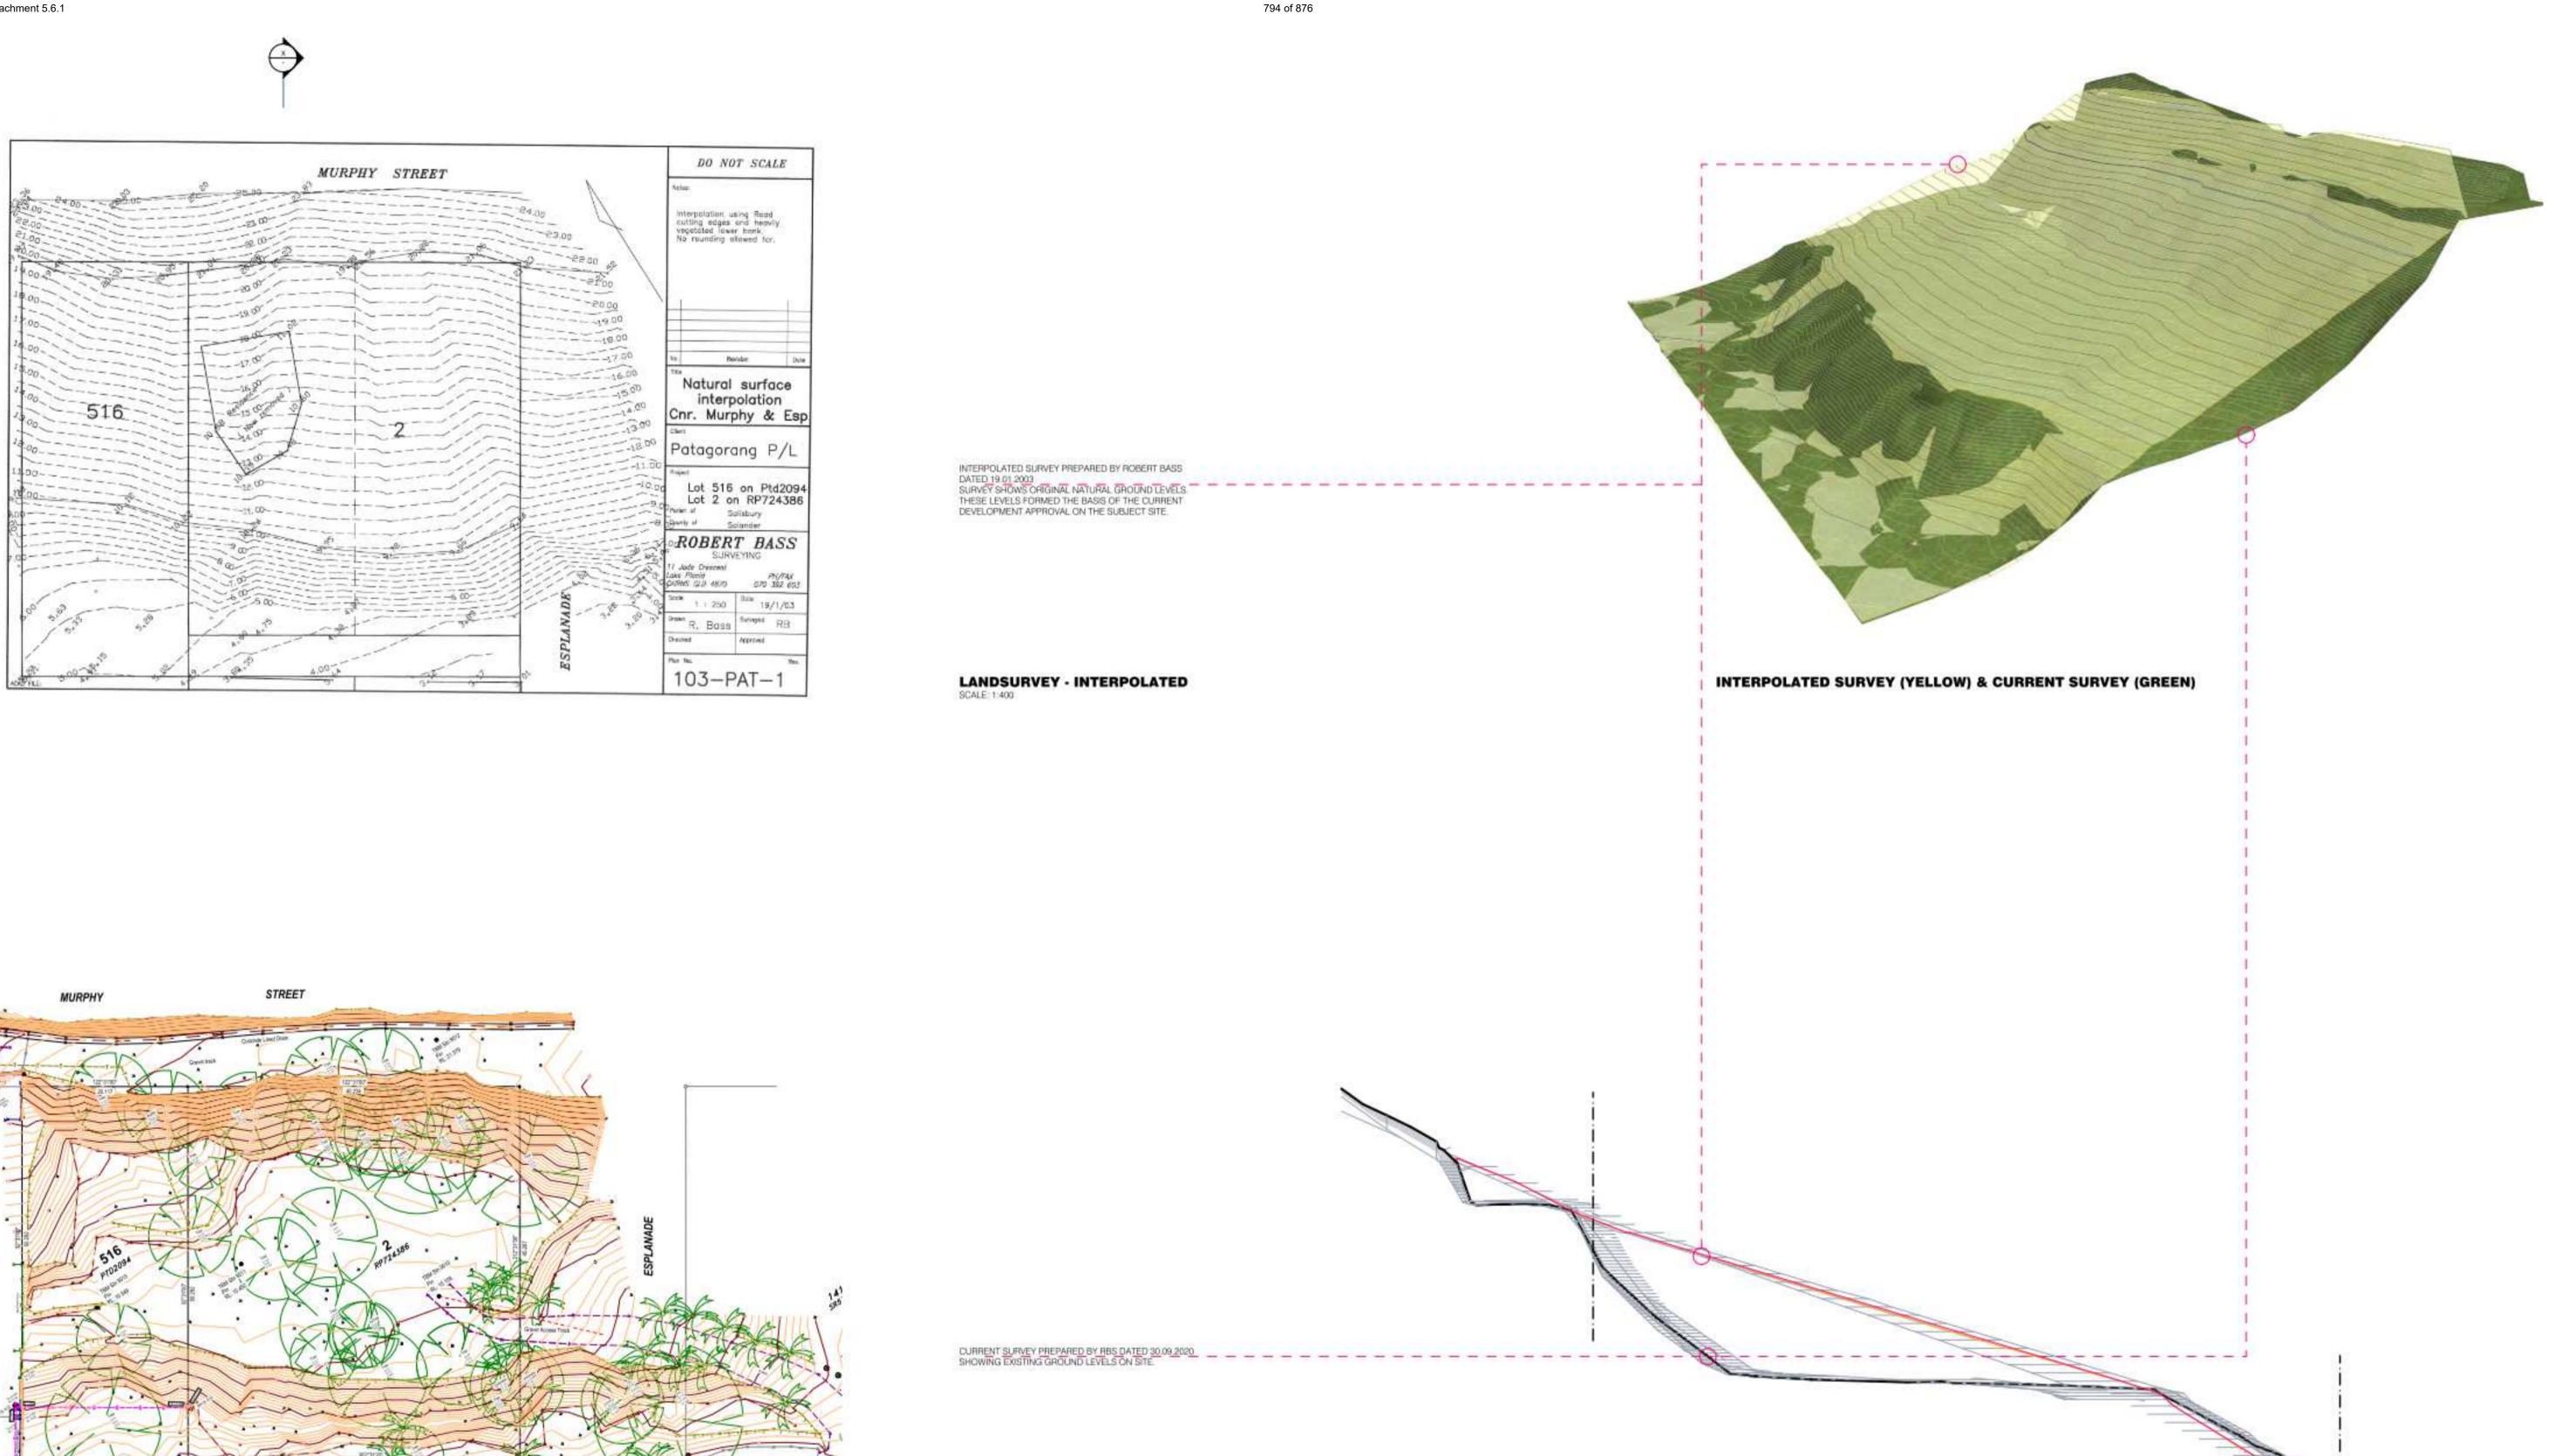

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Revisions

F 13/07/22 ISSUE RFI 02

LANDSURVEY - CURRENT SCALE: 1.400

Project Manager Structural Engineer Mechanical Engineer Fire Engineer

Electrical Engineer
Ordinary Council Meeting - 30 August 2022

Consultants

**GURNER TM** GURNER™ Project Title 69-73 MURPHY STREET PORT DOUGLAS

X SITE SECTION - SURVEY LEVELS

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**Drawing Title** INTERPOLATED SURVEY

> **Drawing Status** DEVELOPMENT APPLICATION

**Drawing Details** 1 : 1@ A1 13/07/22 9663 Job No Drawn ND Checked **Drawing No** DA01.007

795 of 876

All dimension to be verified on site before producing shop drawings or commencing any work.

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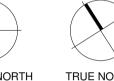
#### Revisions

A 03/09/21 FOR CLIENT COMMENT
B 09/09/21 FOR CONSULTANT COORDINATION
C 15/09/21 FOR INFORMATION
D 22/09/21 DRAFT DA
E 04/10/21 ISSUE FOR DA
F 10/03/22 ISSUE RFI 01
G 13/07/22 ISSUE RFI 02

#### Notes







Consultants

Project Manager

Mechanical Engineer

Structural Engineer

Fire Engineer

Electrical Engineer

Client

— GURNER TM

# **GURNER**<sup>TM</sup>

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Registered Architects and Designers www.warrenandmahoney.com
 Project Title

69-73 MURPHY STREET PORT DOUGLAS

Drawing Title
—

PROPOSED SITE PLAN


Drawing Status
DEVELOPMENT
APPLICATION
Drawing Details

13/07/ 96
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Drawing No

\_ DA03.001 Revision

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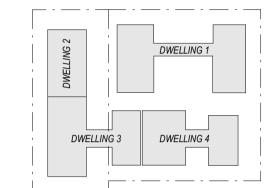
Revisions


A 18/02/22 FOR INFORMATION B 10/03/22 ISSUE RFI 01 C 13/07/22 ISSUE RFI 02
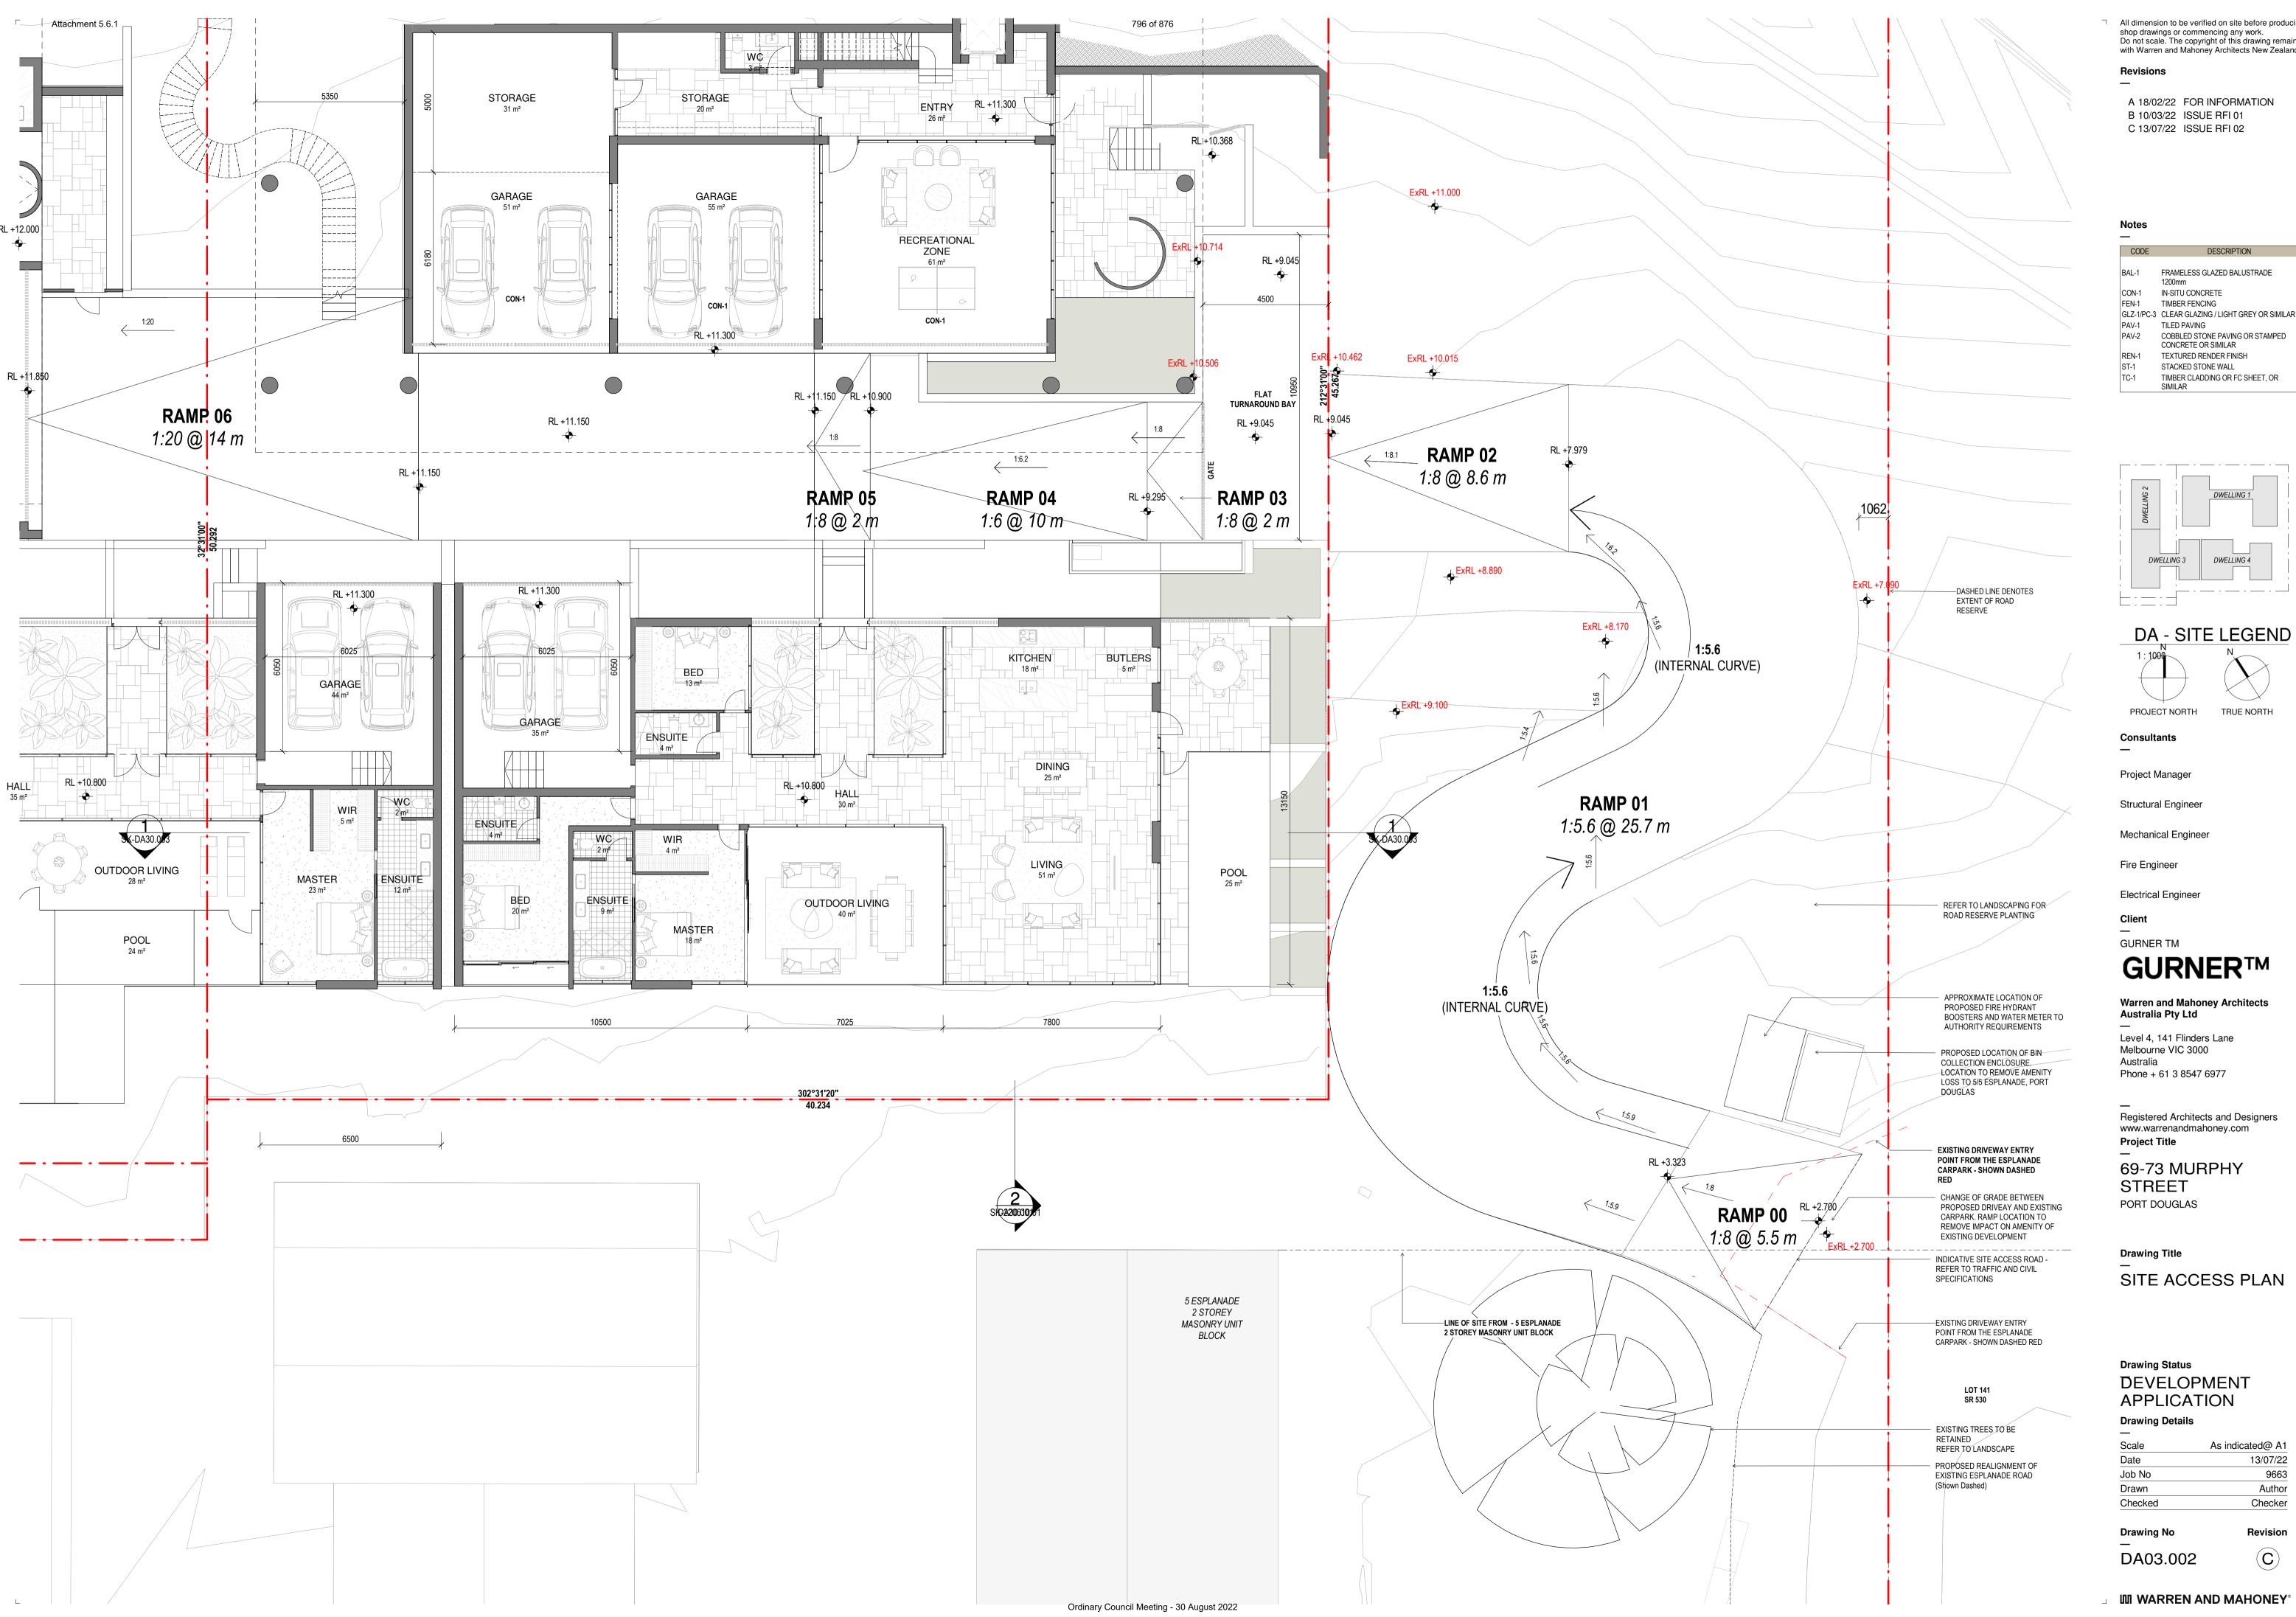
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CON-1	IN-SITU CONCRETE
FEN-1	TIMBER FENCING
GLZ-1/PC-3	CLEAR GLAZING / LIGHT GREY OR SIMILAR
PAV-1	TILED PAVING
PAV-2	COBBLED STONE PAVING OR STAMPED CONCRETE OR SIMILAR
REN-1	TEXTURED RENDER FINISH
ST-1	STACKED STONE WALL

TIMBER CLADDING OR FC SHEET, OR

SIMILAR



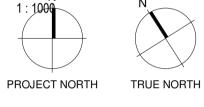

Consultants

Project Manager

Structural Engineer

Fire Engineer

Electrical Engineer

Client

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69-73 MURPHY STREET PORT DOUGLAS

Drawing Title

SITE ACCESS PLAN

#### **Drawing Status** DEVELOPMENT **APPLICATION Drawing Details**

Scale	As indicated@ A1
Date	13/07/22
Job No	9663
Drawn	Author
Checked	Checker

Drawing No

DA03.002


**III WARREN AND MAHONEY®** 



C 15/09/21 FOR INFORMATION D 17/09/21 FOR INFORMATION E 21/09/21 FOR COORDINATION F 22/09/21 DRAFT DA G 04/10/21 ISSUE FOR DA H 18/02/22 FOR INFORMATION J 10/03/22 ISSUE RFI 01 K 13/07/22 ISSUE RFI 02

CODE	DESCRIPTION
BAL-1	FRAMELESS GLAZED BALUSTRADE
	1200mm
CON-1	IN-SITU CONCRETE
FEN-1	TIMBER FENCING
GLZ-1/PC-3	CLEAR GLAZING / LIGHT GREY OR SIMILAR
PAV-1	TILED PAVING
PAV-2	COBBLED STONE PAVING OR STAMPED
	CONCRETE OR SIMILAR
REN-1	TEXTURED RENDER FINISH
ST-1	STACKED STONE WALL
TC-1	TIMBER CLADDING OR FC SHEET, OR
I	O I AU A D

SIMILAR

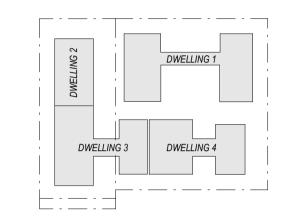



Consultants

Project Manager

Mechanical Engineer

Structural Engineer

Fire Engineer

Electrical Engineer

Client

**GURNER TM** 

# GURNER™

Warren and Mahoney Architects Australia Pty Ltd

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Registered Architects and Designers www.warrenandmahoney.com **Project Title** 

69-73 MURPHY STREET PORT DOUGLAS


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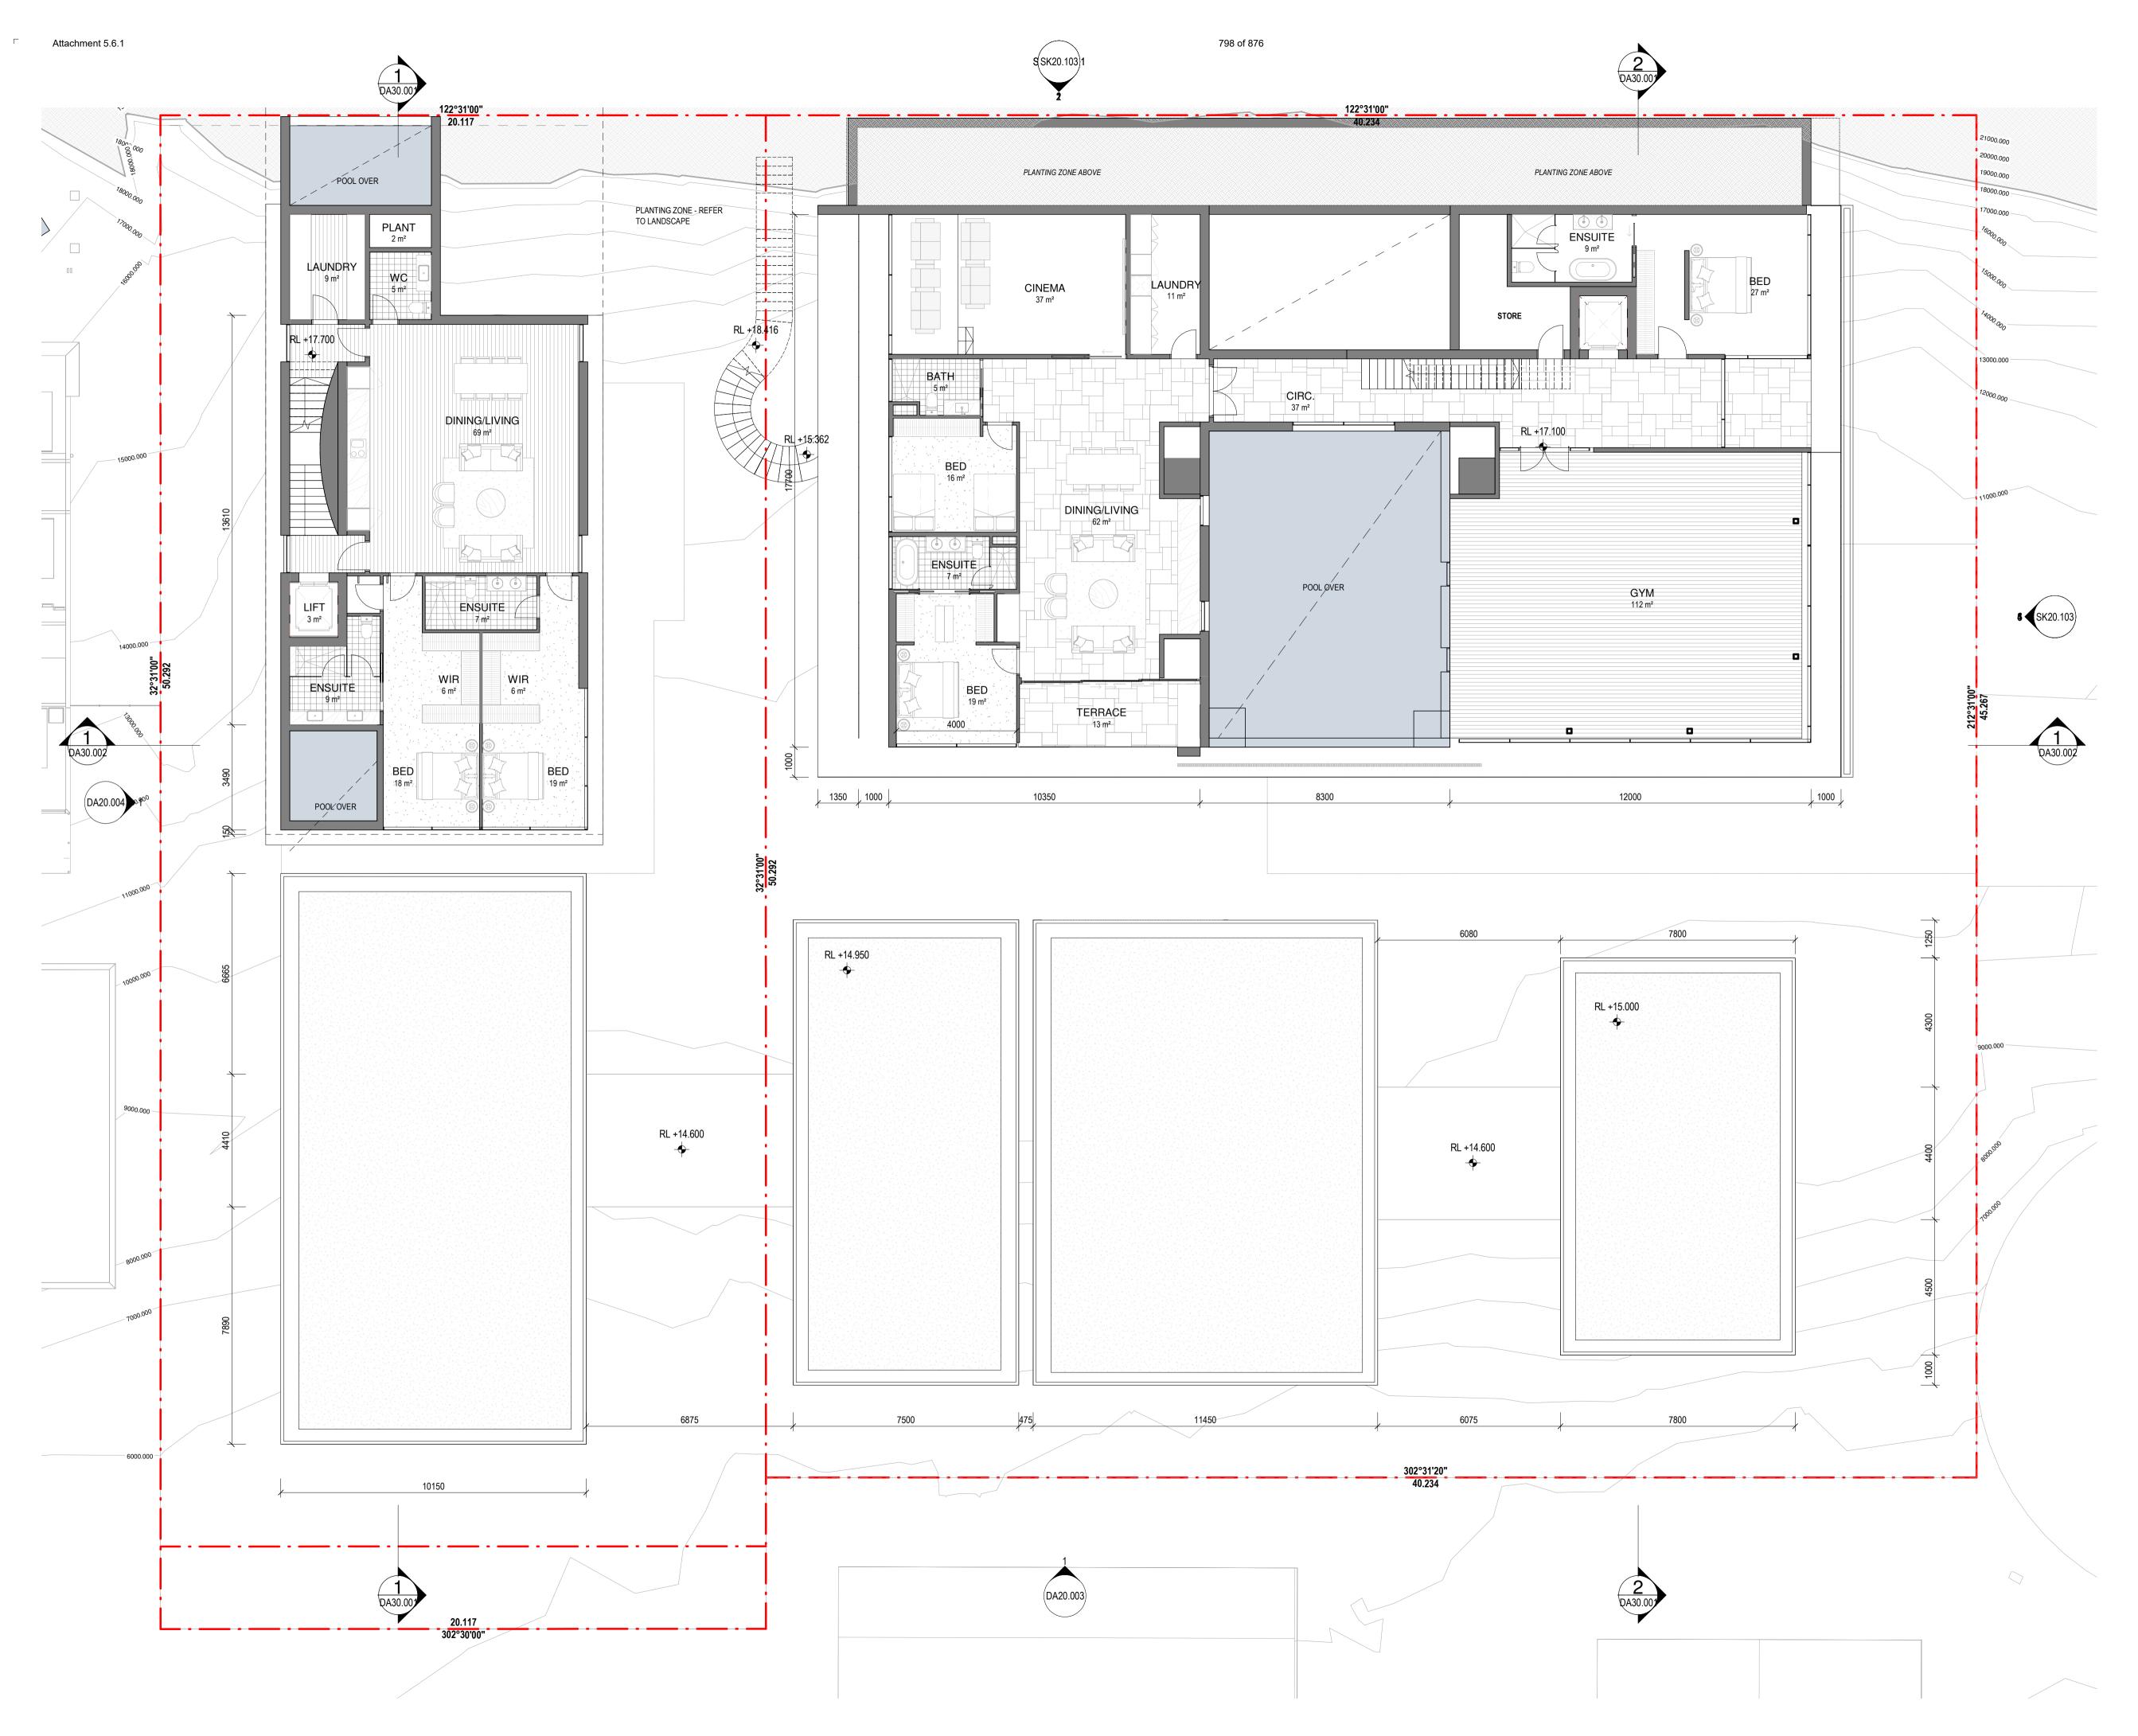
**GROUND FLOOR** PLAN

**Drawing Status** DEVELOPMENT **APPLICATION Drawing Details** 

Scale	As indicated@ A1
Date	13/07/22
Job No	9663
Drawn	SG
Checked	ND
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Drawing No



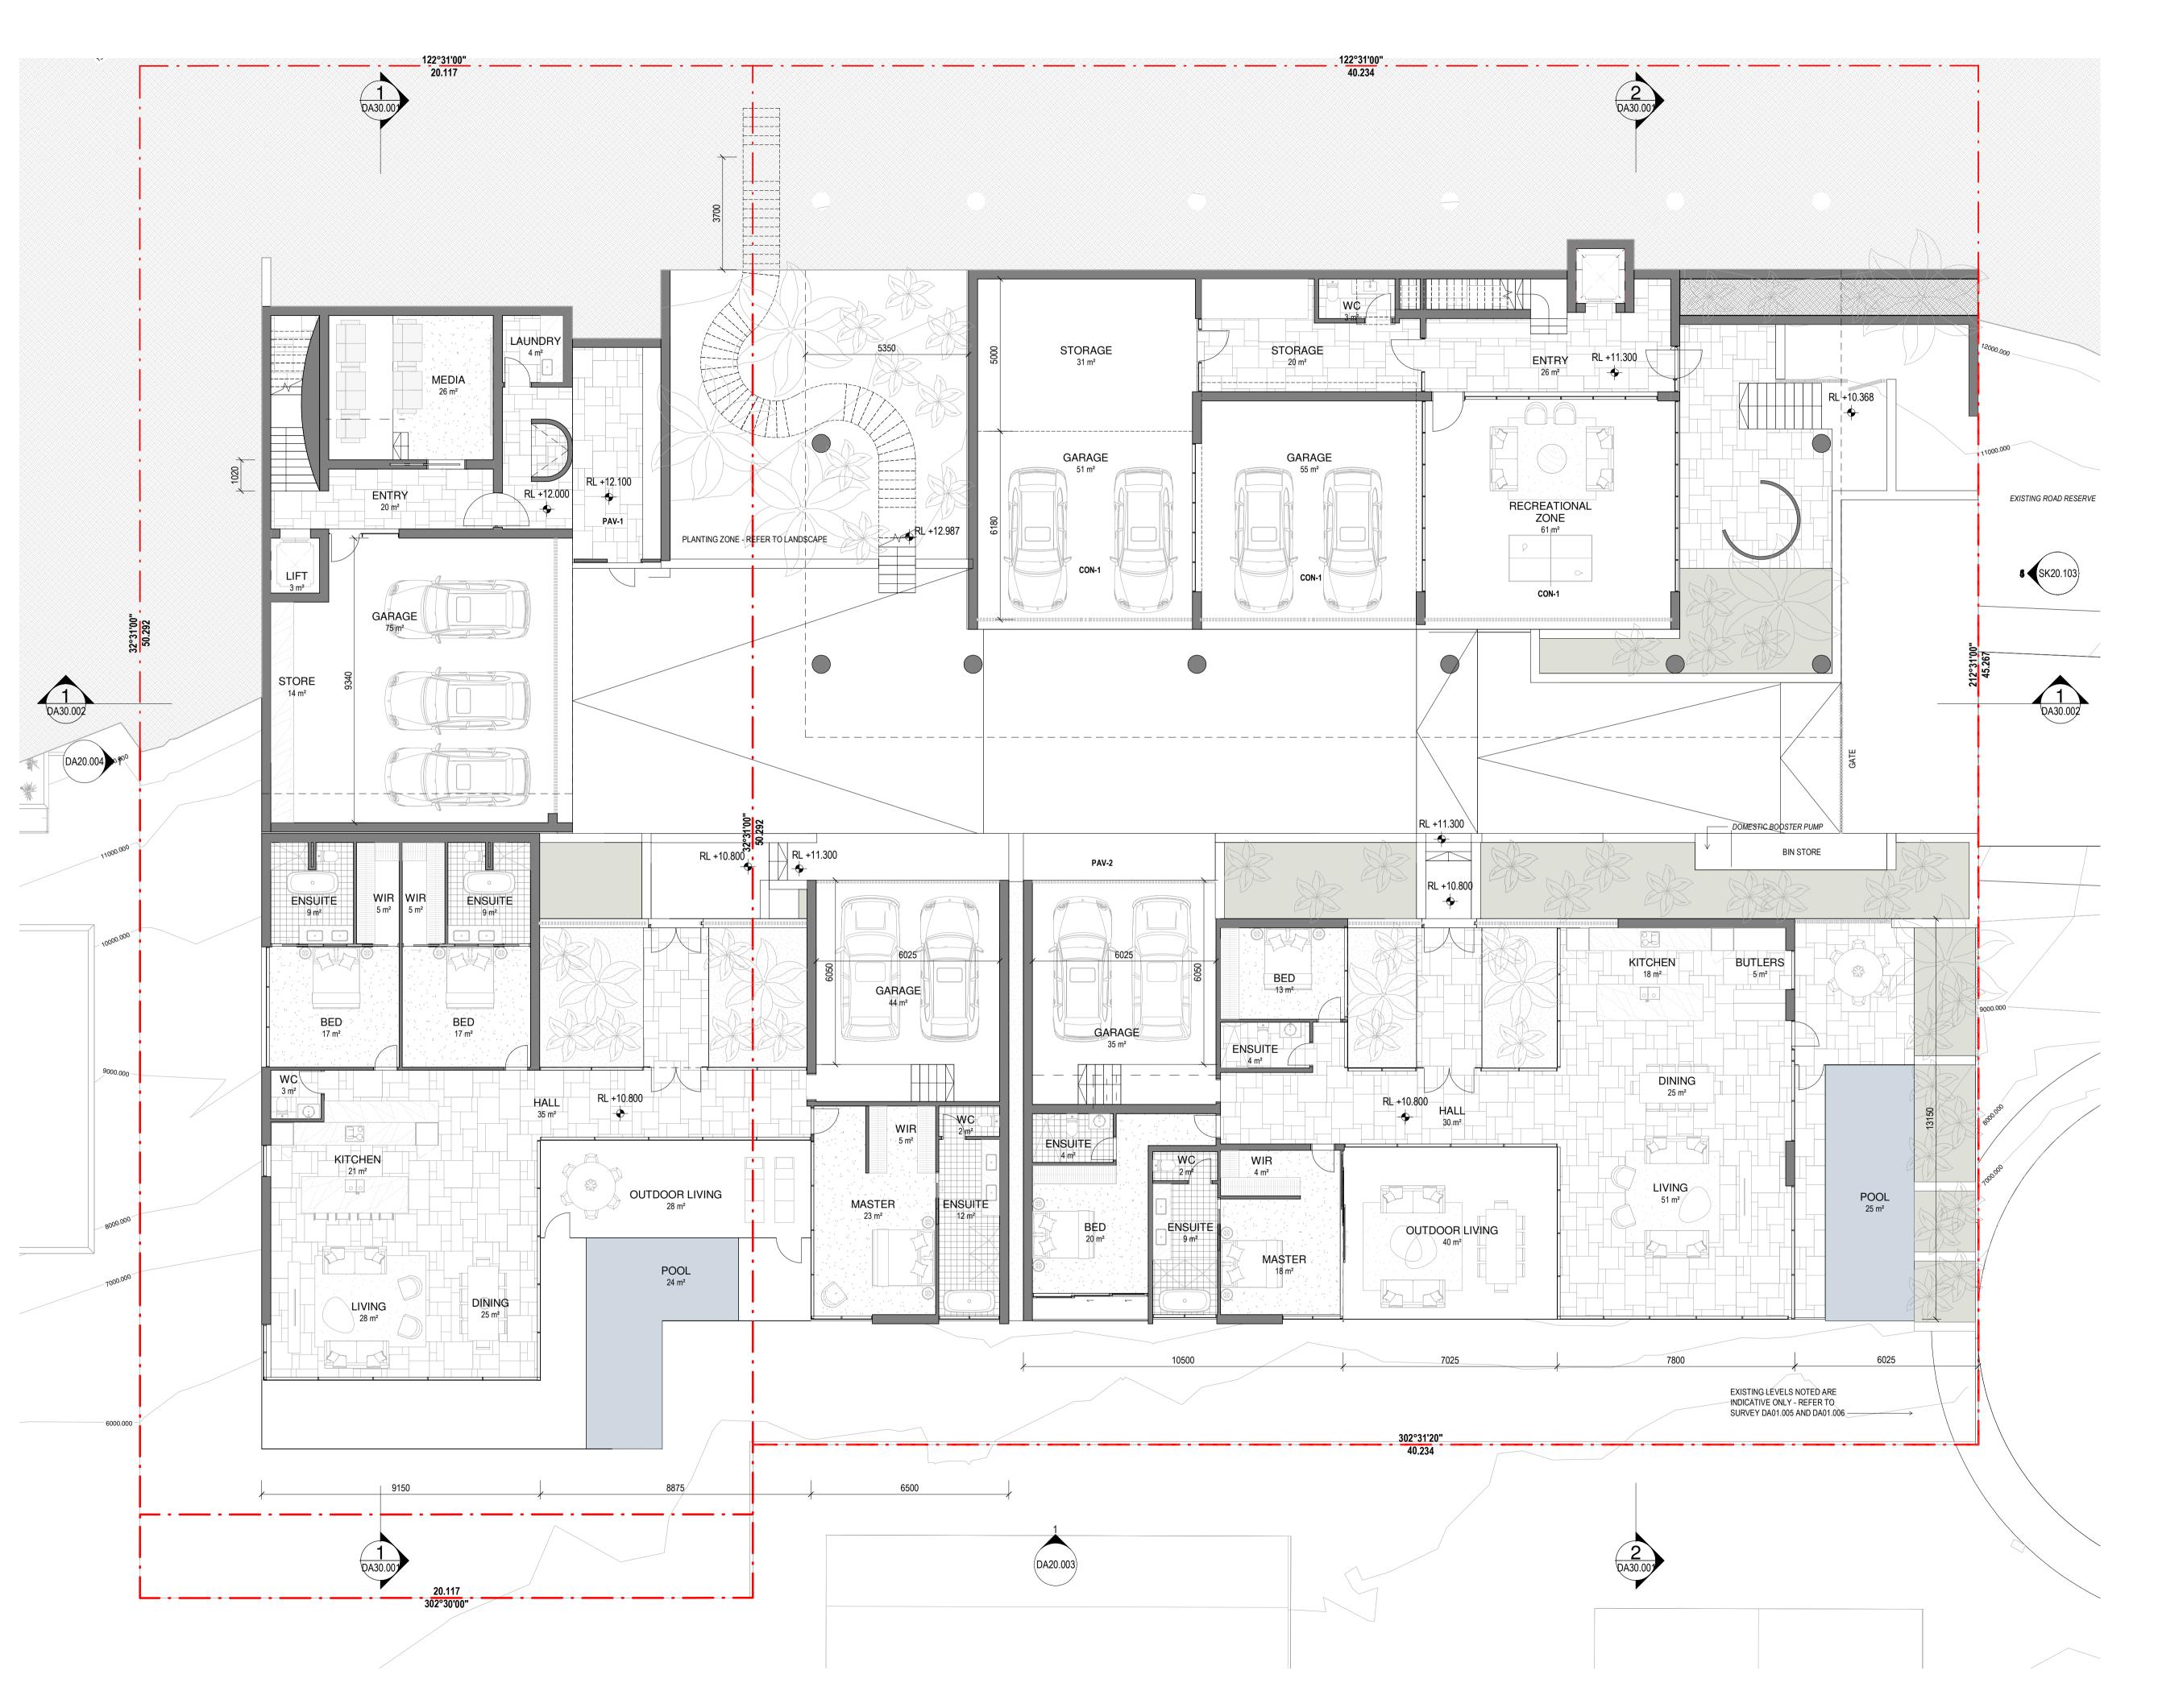


#### Revisions

C 15/09/21 FOR INFORMATION
D 17/09/21 FOR INFORMATION
E 21/09/21 FOR COORDINATION
F 22/09/21 DRAFT DA
G 04/10/21 ISSUE FOR DA
H 18/02/22 FOR INFORMATION
J 10/03/22 ISSUE RFI 01
K 13/07/22 ISSUE RFI 02

#### Notes

FRAMELESS GLAZED BALUSTRADE	
1200	
IN-SITU CONCRETE	
TIMBER FENCING	
CLEAR GLAZING / LIGHT GREY OR SIMILAR	
TILED PAVING	
COBBLED STONE PAVING OR STAMPED CONCRETE OR SIMILAR	
TEXTURED RENDER FINISH	
STACKED STONE WALL	
TIMBER CLADDING OR FC SHEET, OR SIMILAR	
	1200mm IN-SITU CONCRETE TIMBER FENCING CLEAR GLAZING / LIGHT GREY OR SIMILAR TILED PAVING COBBLED STONE PAVING OR STAMPED CONCRETE OR SIMILAR TEXTURED RENDER FINISH STACKED STONE WALL TIMBER CLADDING OR FC SHEET, OR

DESCRIPTION

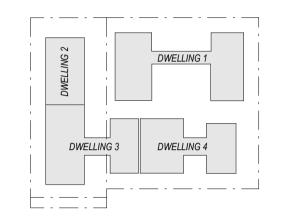





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Project Manager

Structural Engineer

Mechanical Engineer

Fire Engineer

Electrical Engineer

Oliona

Client —

GURNER TM

# GURNER™

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Registered Architects and Designers www.warrenandmahoney.com

Project Title

69-73 MURPHY STREET PORT DOUGLAS


Drawing Title
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L01 FLOOR PLAN

Drawing Status
DEVELOPMENT
APPLICATION
Drawing Details

Scale	As indicated@ A1
Date	13/07/22
Job No	9663
Drawn	SG
Checked	ND

Drawing No

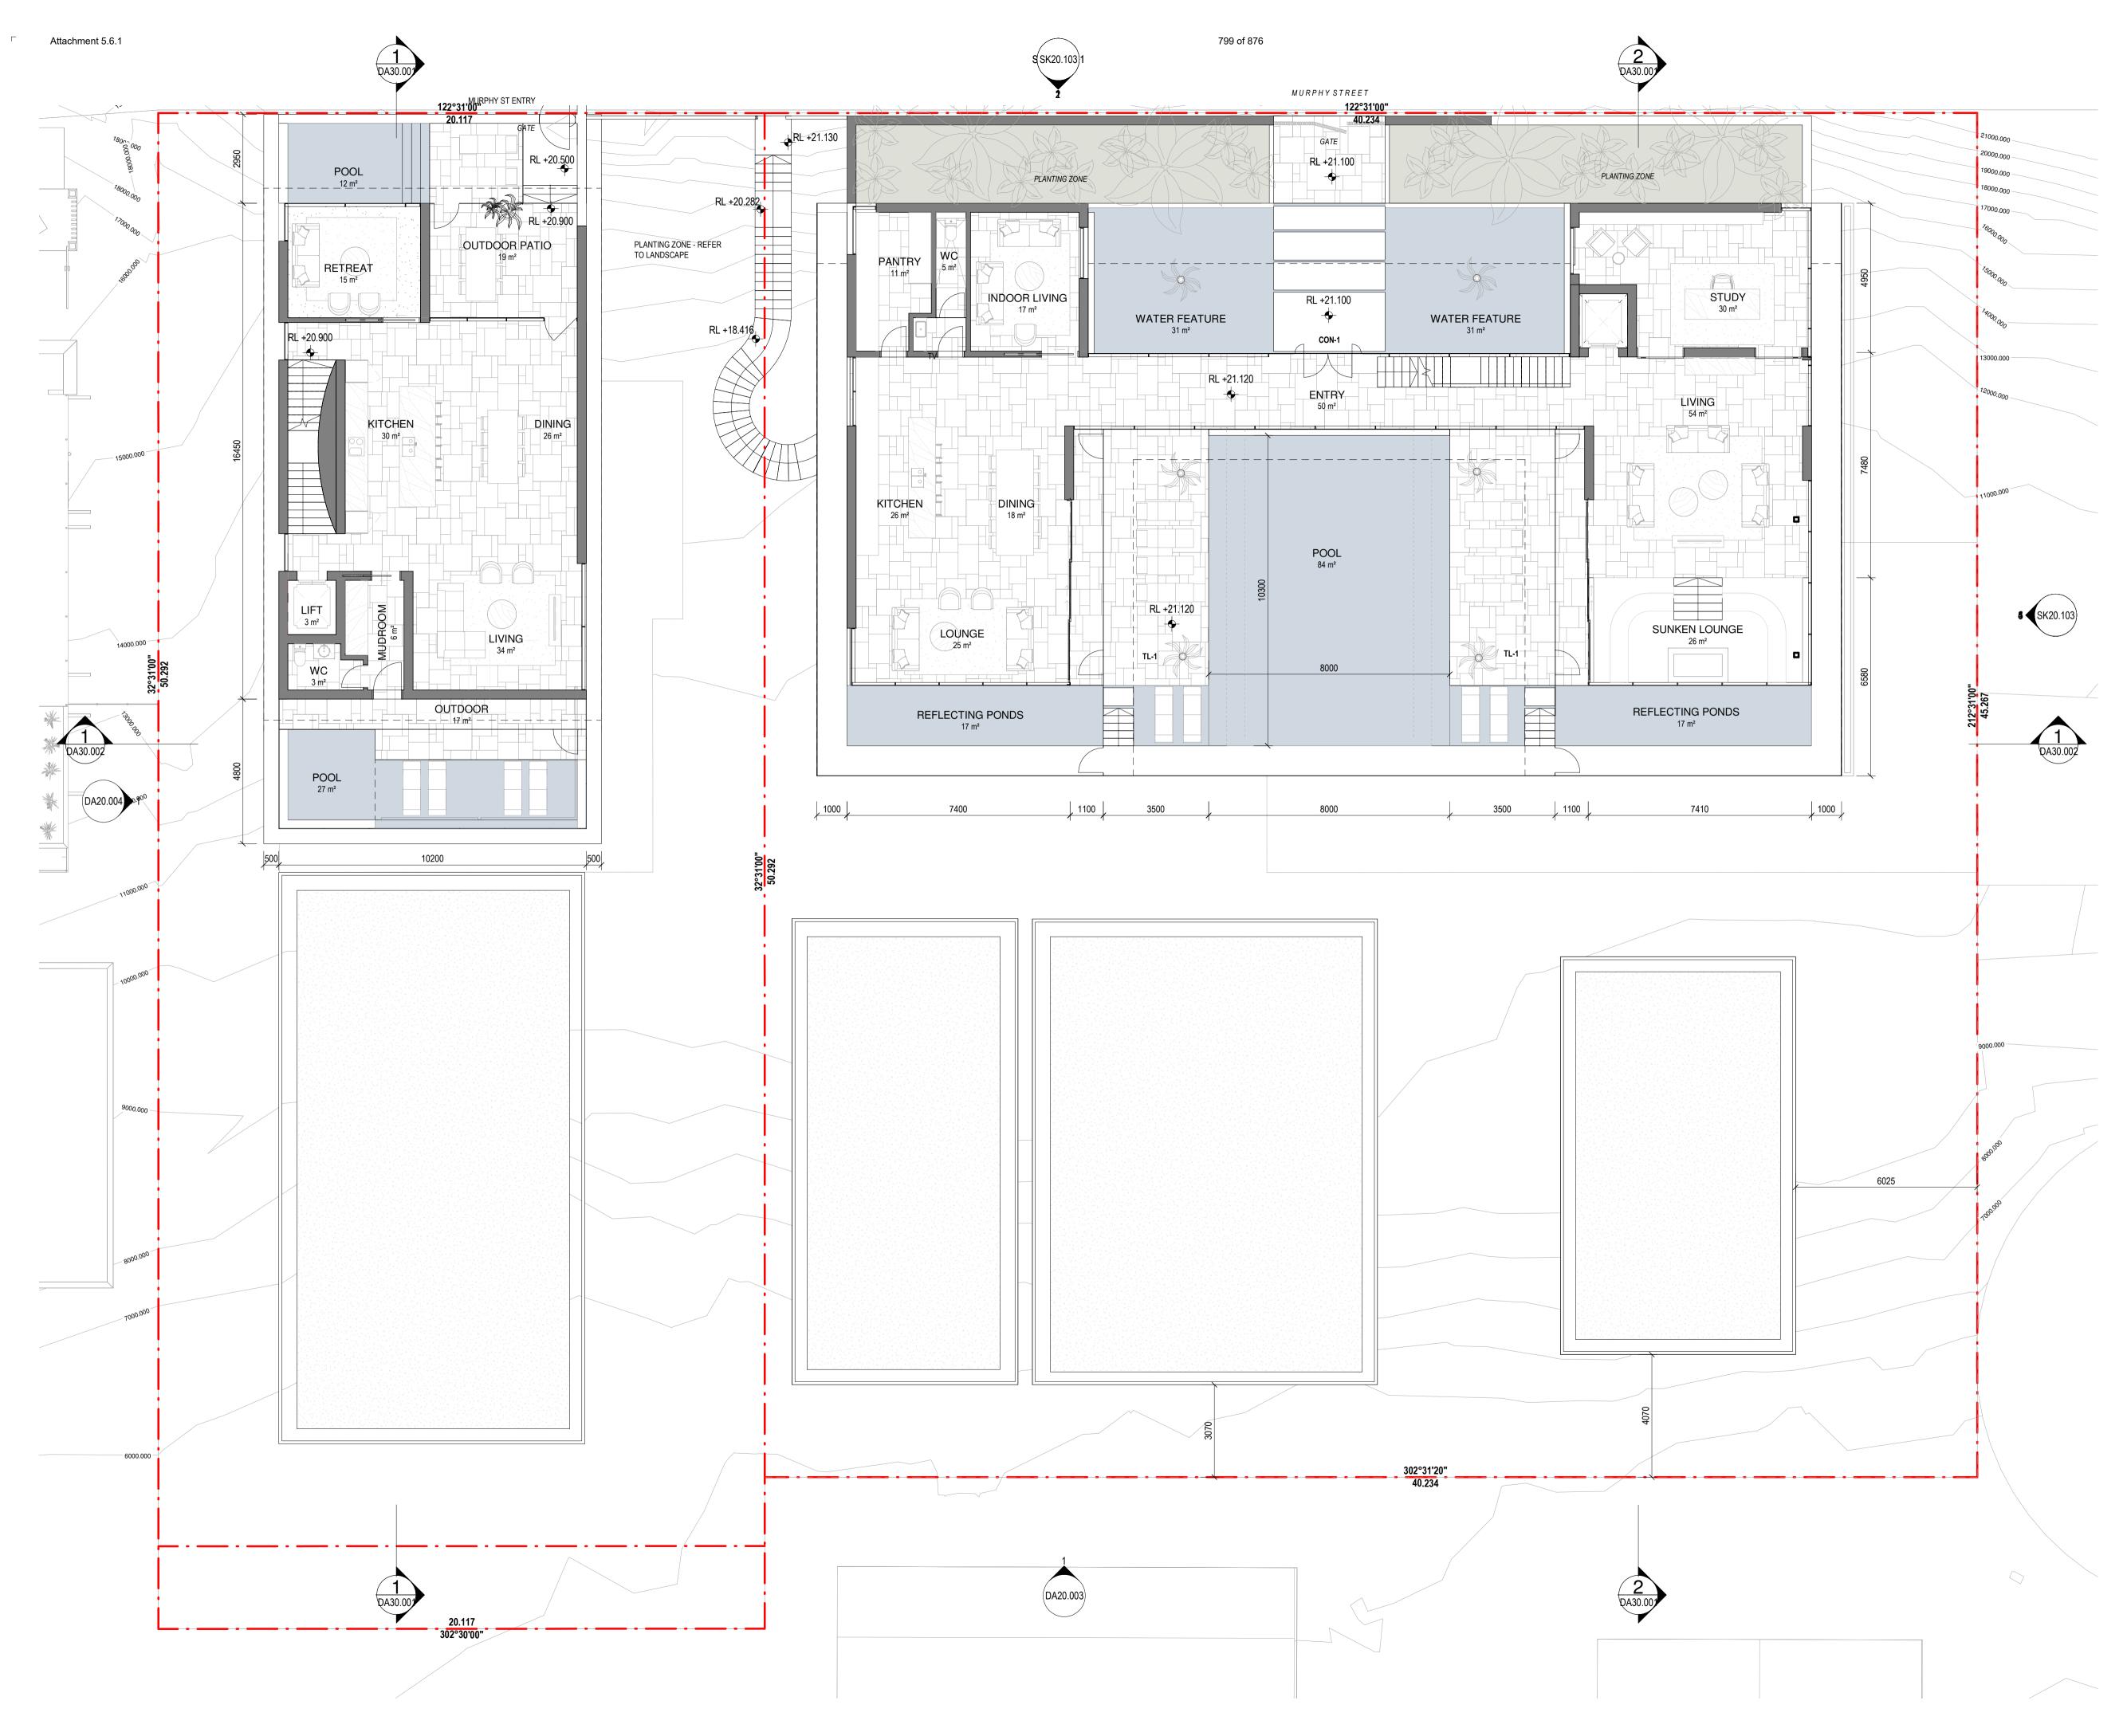


#### Revision

C 15/09/21 FOR INFORMATION
D 17/09/21 FOR INFORMATION
E 21/09/21 FOR COORDINATION
F 22/09/21 DRAFT DA
G 04/10/21 ISSUE FOR DA
H 18/02/22 FOR INFORMATION
J 10/03/22 ISSUE RFI 01
K 13/07/22 ISSUE RFI 02

#### Notes

BAL-1	FRAMELESS GLAZED BALUSTRADE 1200mm	
CON-1	IN-SITU CONCRETE	
FEN-1	TIMBER FENCING	
GLZ-1/PC-3	CLEAR GLAZING / LIGHT GREY OR SIMILAR	
PAV-1	TILED PAVING	
PAV-2	COBBLED STONE PAVING OR STAMPED CONCRETE OR SIMILAR	
REN-1	TEXTURED RENDER FINISH	
ST-1	STACKED STONE WALL	
TC-1	TIMBER CLADDING OR FC SHEET, OR SIMILAR	

DESCRIPTION

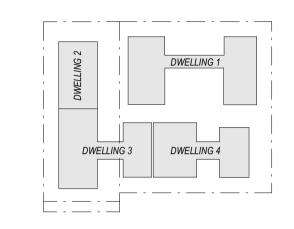



Consultants
—

Project Manager

Mechanical Engineer

Structural Engineer

Fire Engineer

Electrical Engineer

Client

— GURNER TM

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Project Title

69-73 MURPHY STREET PORT DOUGLAS


Drawing Title
—

L02 FLOOR PLAN

Drawing Status
DEVELOPMENT
APPLICATION
Drawing Details

Scale	As indicated@ A
Date	13/07/2
Job No	966
Drawn	SC
Checked	NI

Drawing No

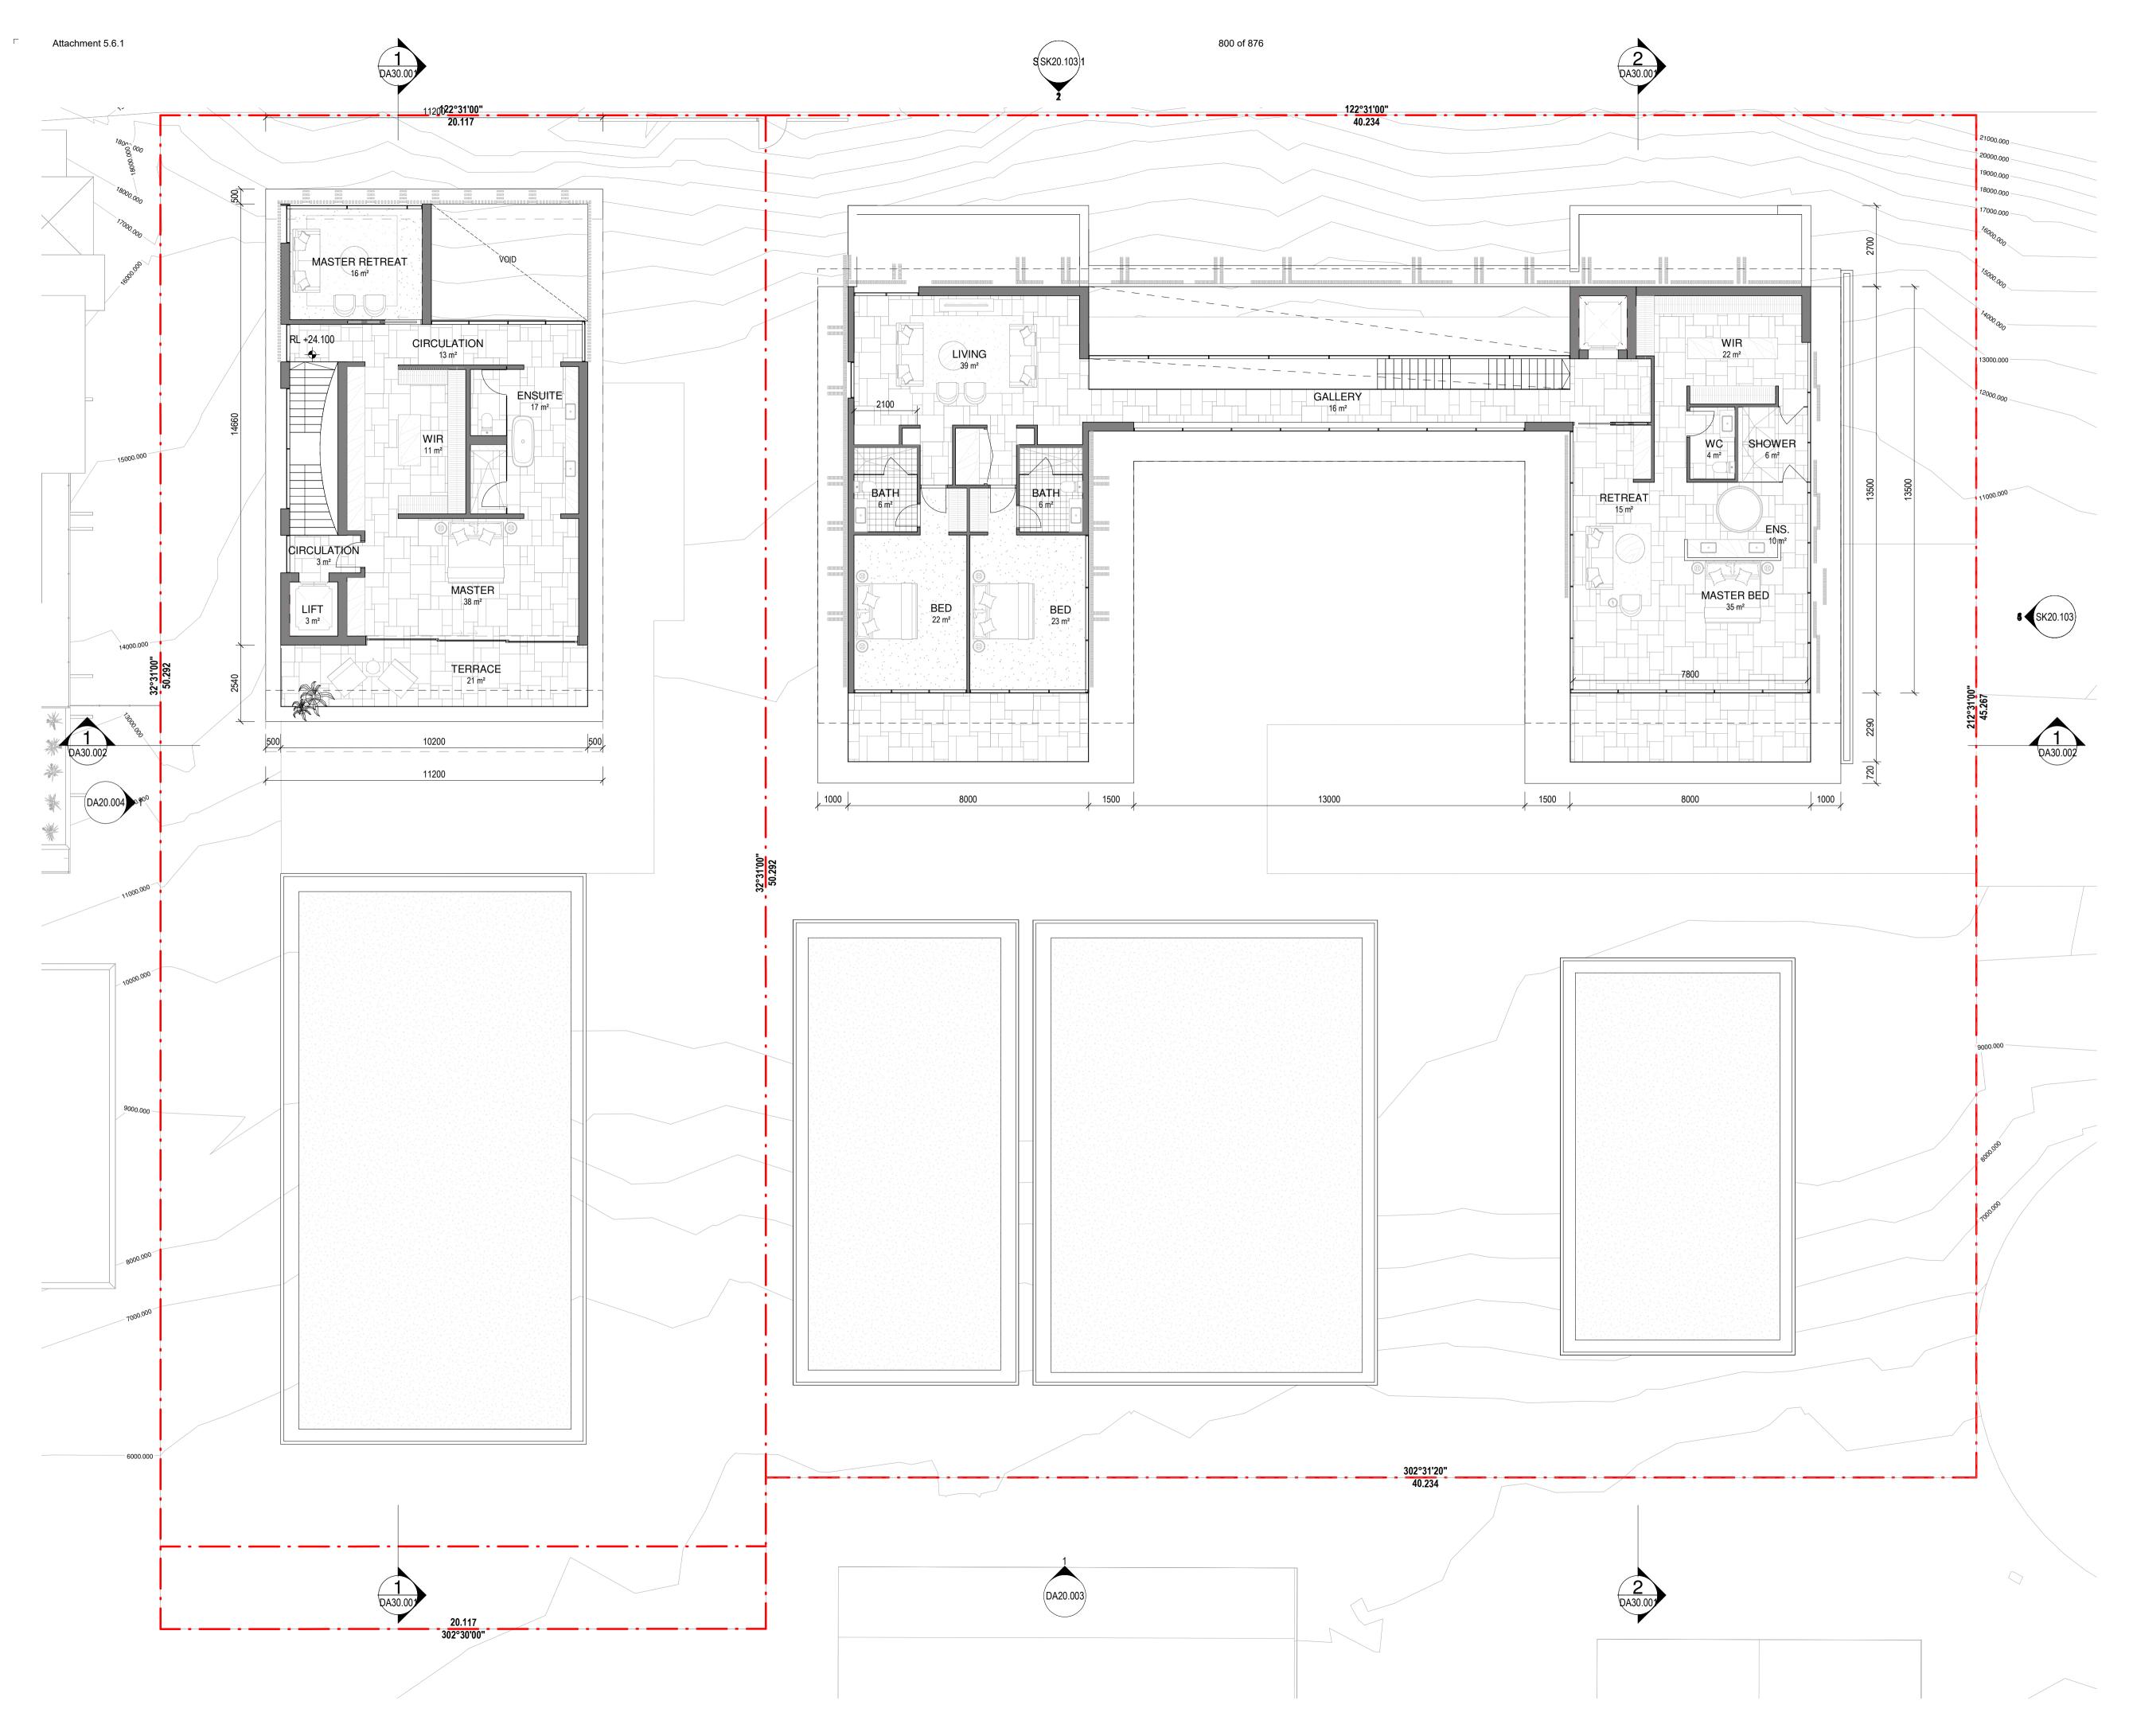


#### Revision

C 15/09/21 FOR INFORMATION
D 17/09/21 FOR INFORMATION
E 21/09/21 FOR COORDINATION
F 22/09/21 DRAFT DA
G 04/10/21 ISSUE FOR DA
H 18/02/22 FOR INFORMATION
J 10/03/22 ISSUE RFI 01
K 13/07/22 ISSUE RFI 02

#### Notes

BAL-1	FRAMELESS GLAZED BALUSTRADE	
	1200mm	
CON-1	IN-SITU CONCRETE	
FEN-1	TIMBER FENCING	
GLZ-1/PC-3	CLEAR GLAZING / LIGHT GREY OR SIMILAR	
PAV-1	TILED PAVING	
PAV-2	COBBLED STONE PAVING OR STAMPED CONCRETE OR SIMILAR	
REN-1	TEXTURED RENDER FINISH	
ST-1	STACKED STONE WALL	
TC-1	TIMBER CLADDING OR FC SHEET, OR SIMILAR	

DESCRIPTION

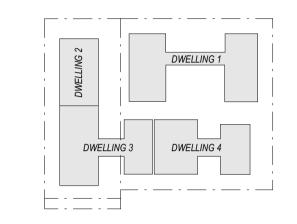



Consultants

Project Manager

Structural Engineer

Mechanical Engineer

Fire Engineer

Electrical Engineer

Client

— GURNER TM

# **GURNER**<sup>TM</sup>

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Project Title

69-73 MURPHY STREET PORT DOUGLAS


Drawing Title
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L03 FLOOR PLAN

Drawing Status
DEVELOPMENT
APPLICATION
Drawing Details
—

As indicated@ A1
13/07/22
9663
SG
ND

Drawing No

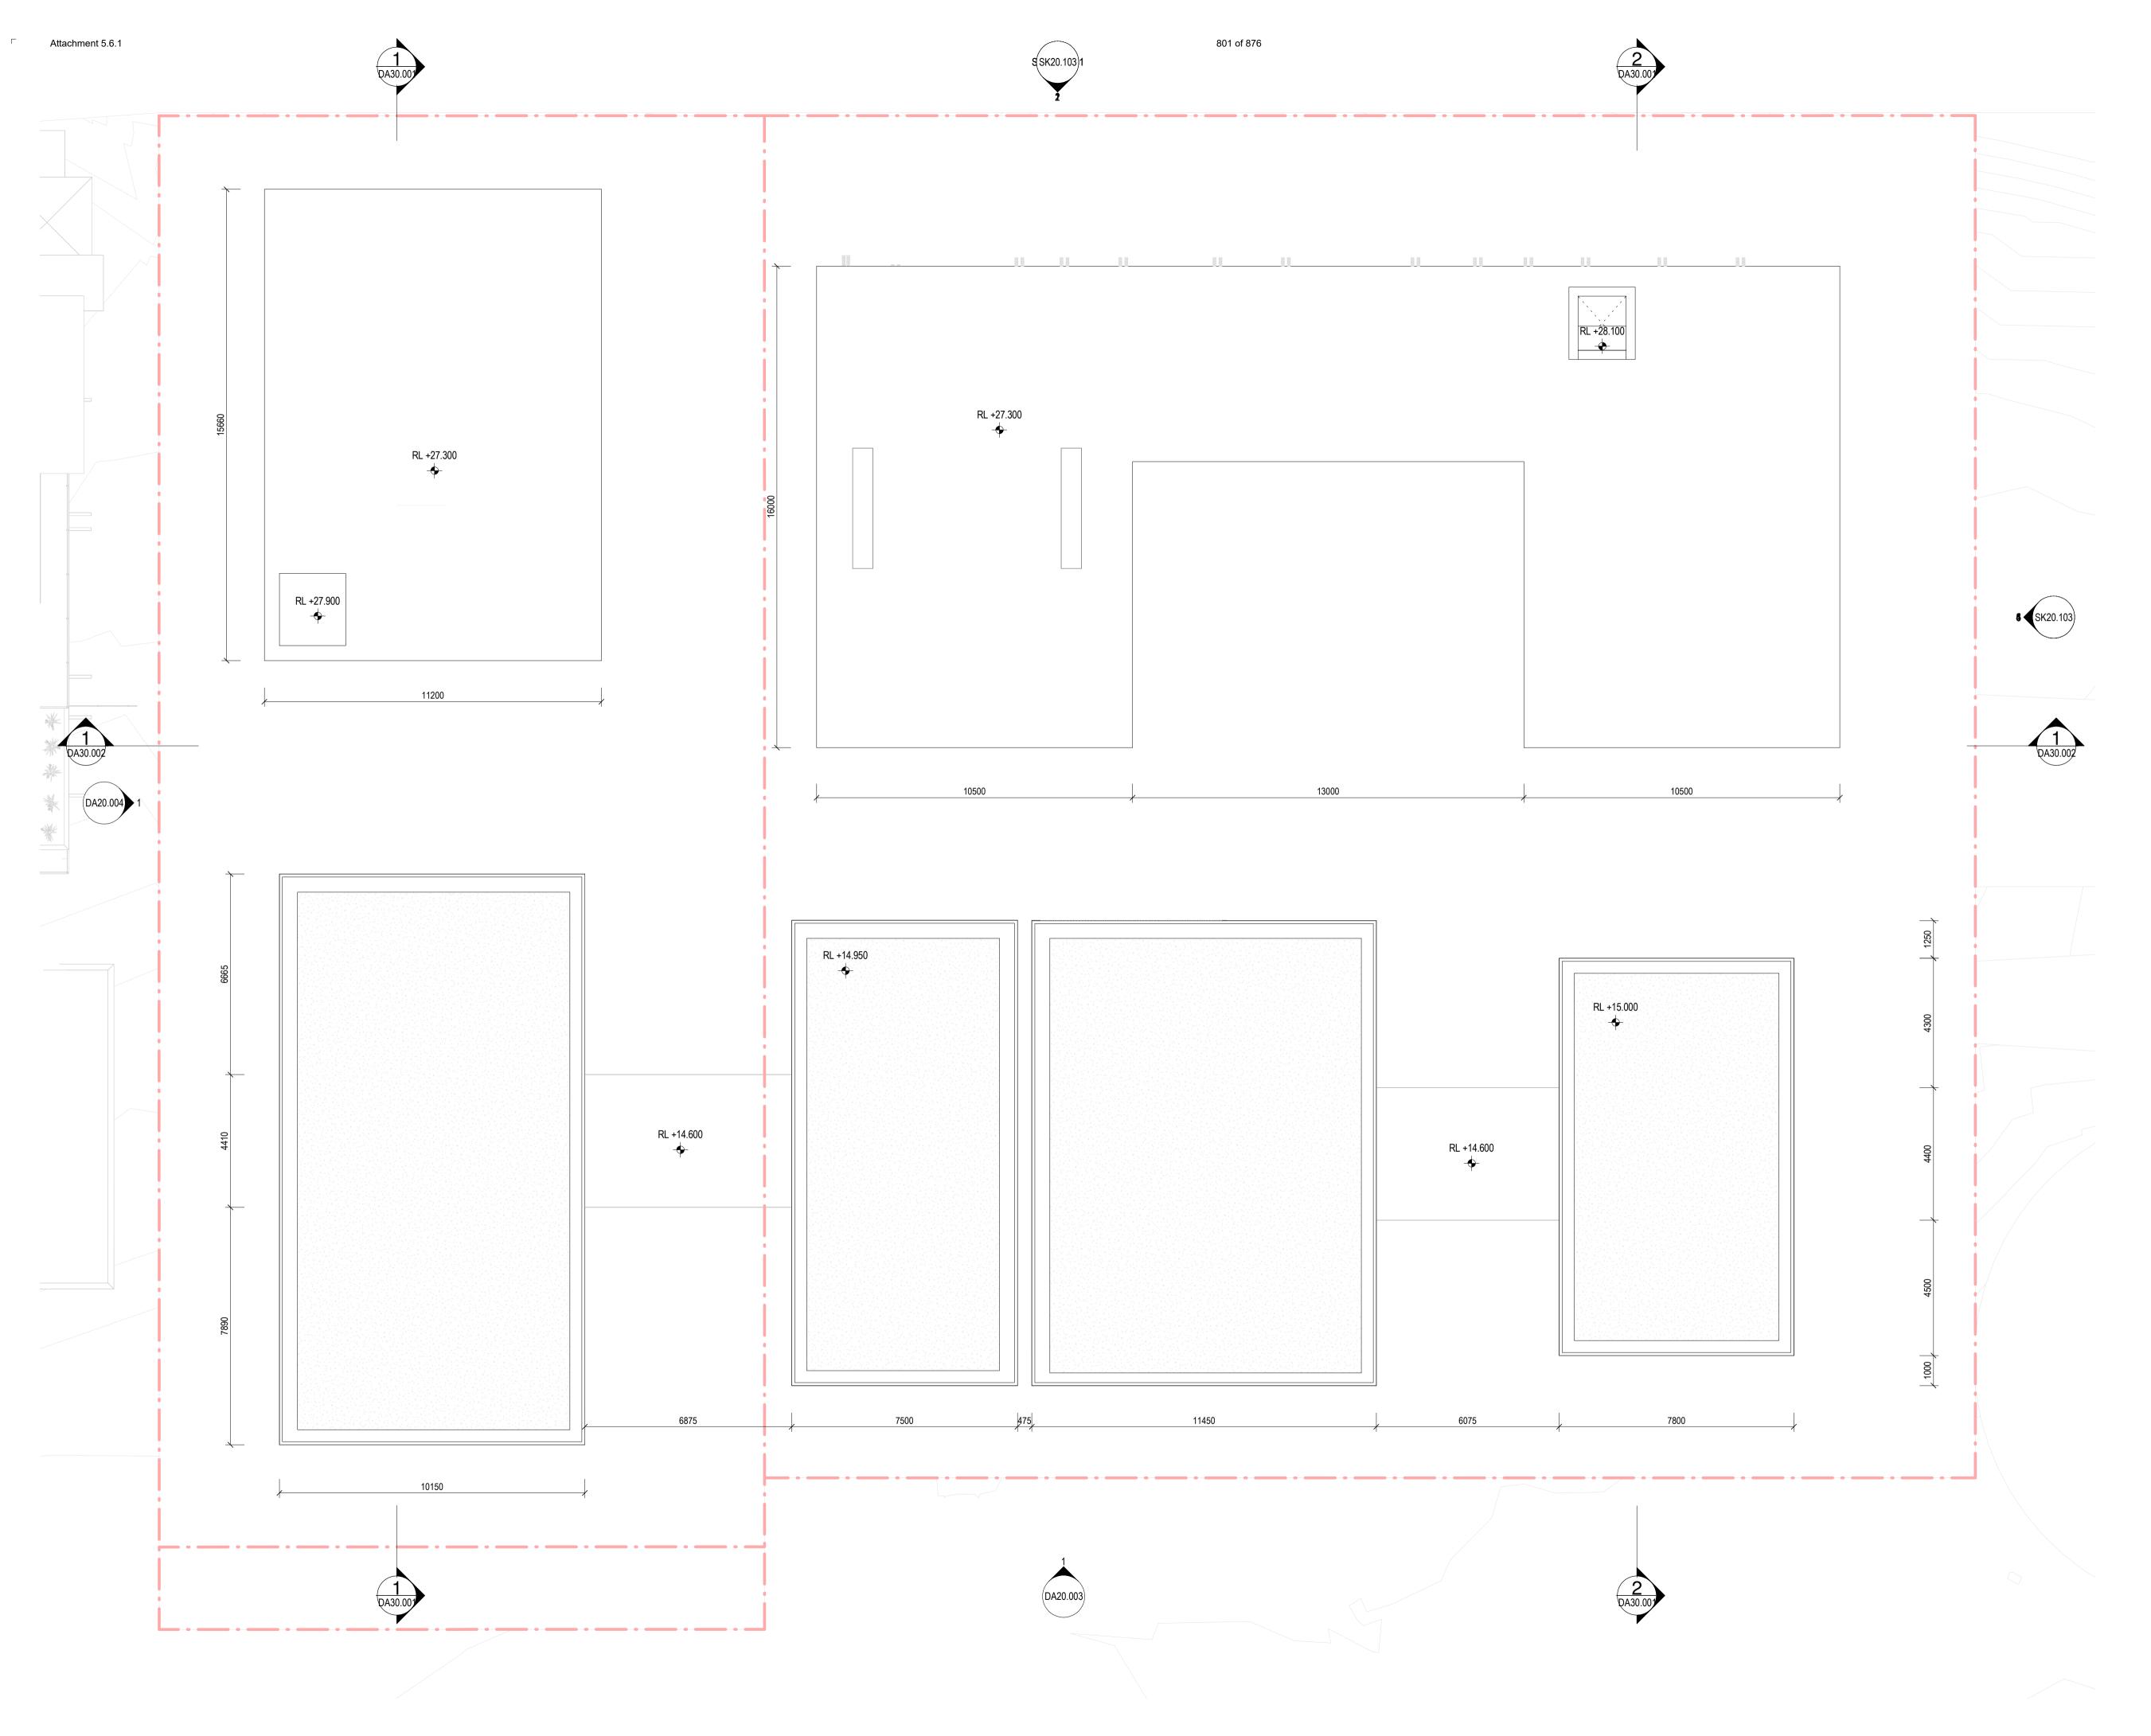


#### Revision

B 15/09/21 FOR INFORMATION
C 17/09/21 FOR INFORMATION
D 21/09/21 FOR COORDINATION
E 22/09/21 DRAFT DA
F 04/10/21 ISSUE FOR DA
G 18/02/22 FOR INFORMATION
H 10/03/22 ISSUE RFI 01
J 13/07/22 ISSUE RFI 02

#### notes

CODE	DESCRIPTION
BAL-1	FRAMELESS GLAZED BALUSTRADE
	1200mm
CON-1	IN-SITU CONCRETE
FEN-1	TIMBER FENCING
GLZ-1/PC-3	CLEAR GLAZING / LIGHT GREY OR SIMILAR
PAV-1	TILED PAVING
PAV-2	COBBLED STONE PAVING OR STAMPED
	CONCRETE OR SIMILAR
REN-1	TEXTURED RENDER FINISH
ST-1	STACKED STONE WALL
TC-1	TIMBER CLADDING OR FC SHEET, OR
	SIMILAR

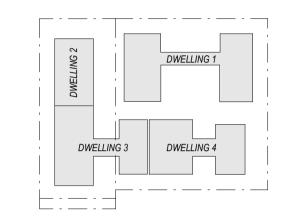





#### \_

Project Manager

## Structural Engineer

Mechanical Engineer

## Fire Engineer

Electrical Engineer

## Client

GURNER TM

## **GURNER**™

#### Warren and Mahoney Architects Australia Pty Ltd —

Level 4, 141 Flinders Lane Melbourne VIC 3000 Australia Phone + 61 3 8547 6977

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Project Title

69-73 MURPHY STREET PORT DOUGLAS

## Drawing Title —

ROOF PLAN


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Scale	As indicated@ A
Date	13/07/22
Job No	9660
Drawn	SC
Checked	NE


Drawing No.



T Attachment 5.6.1

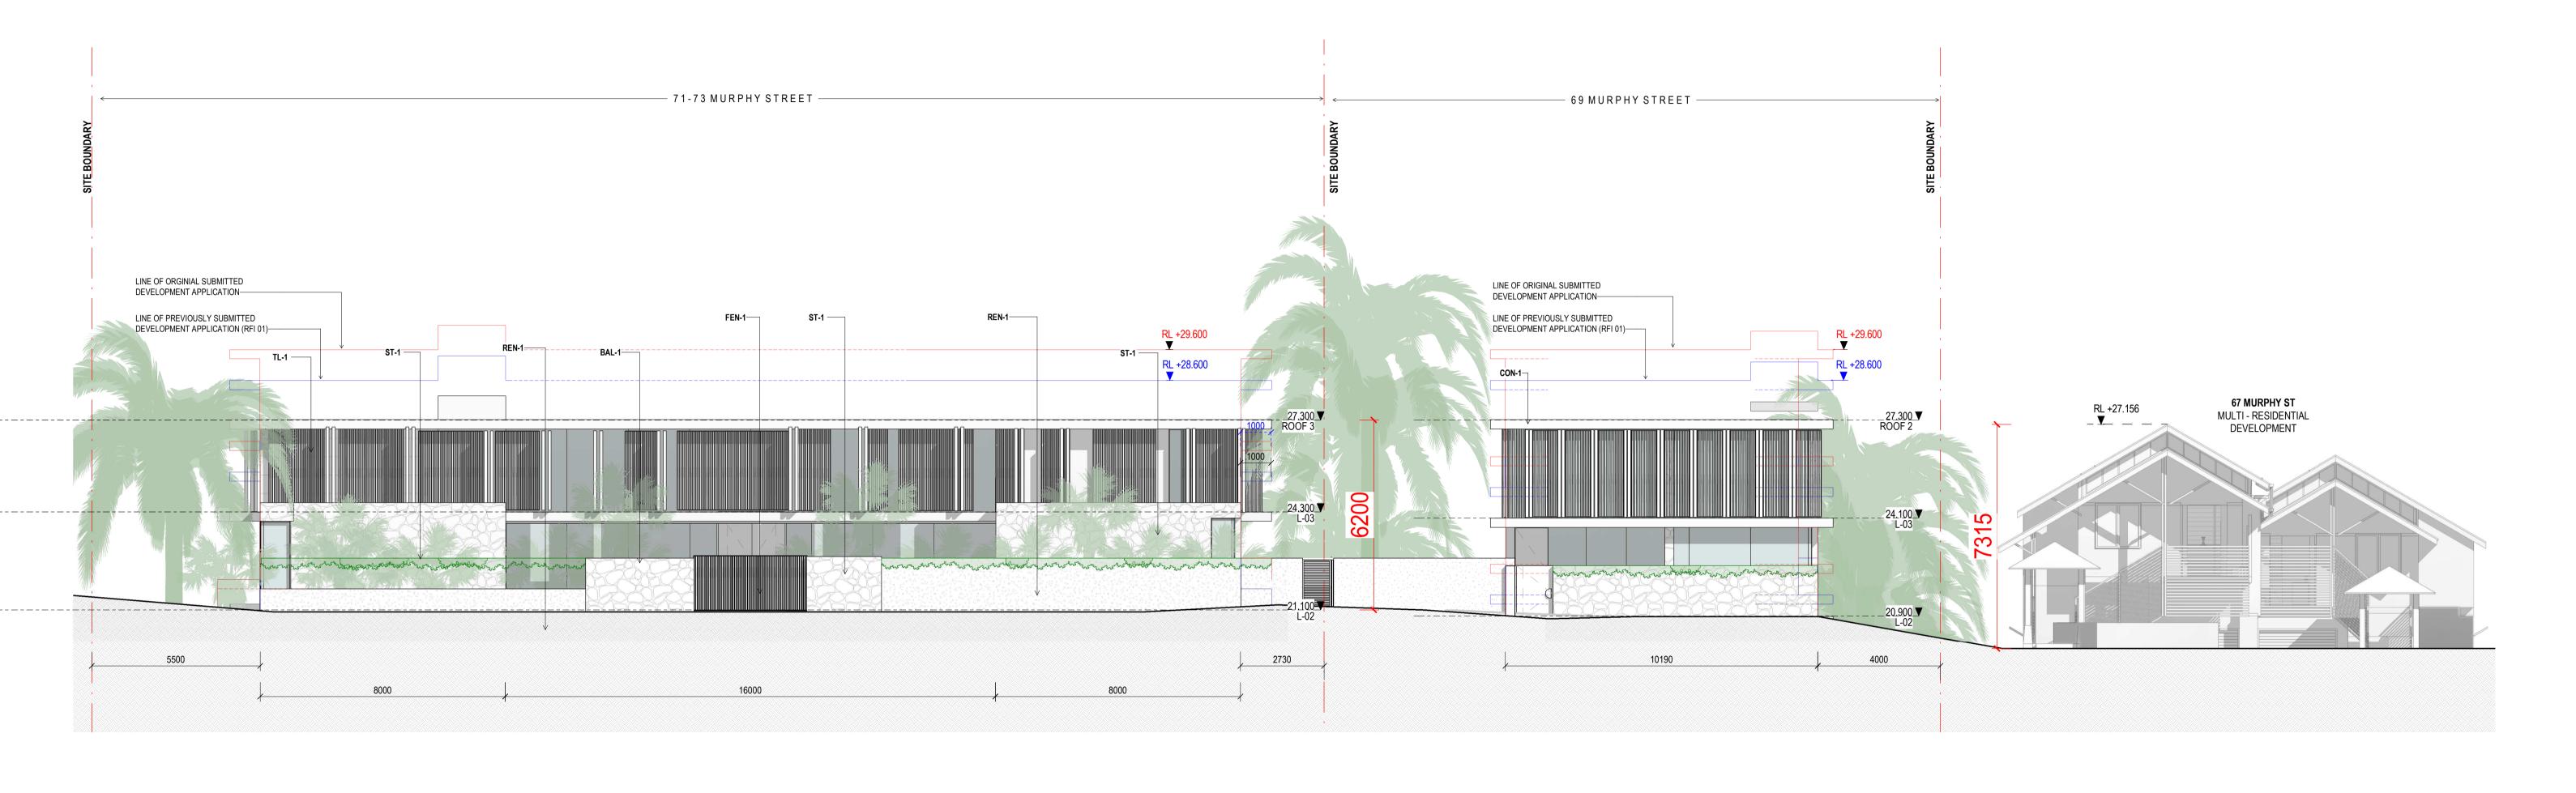


802 of 876

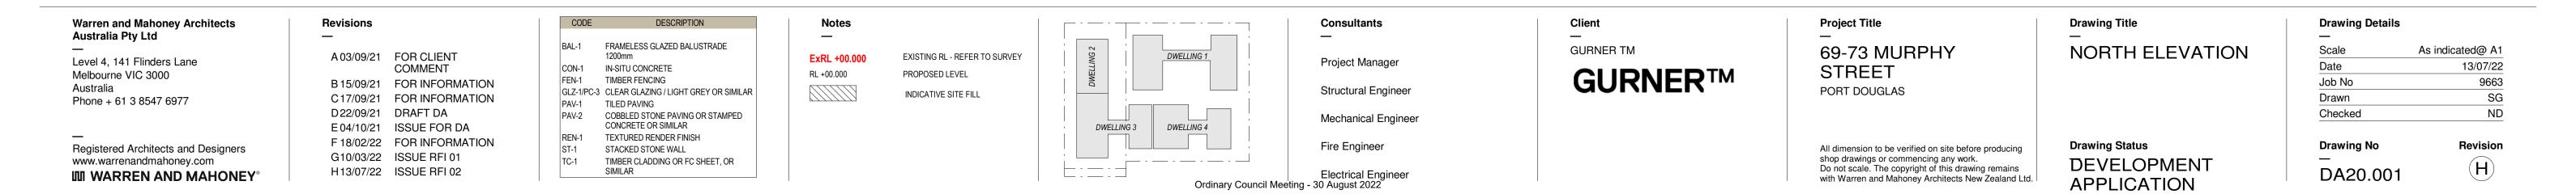

□ Attachment 5.6.1

H13/07/22 ISSUE RFI 02

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803 of 876

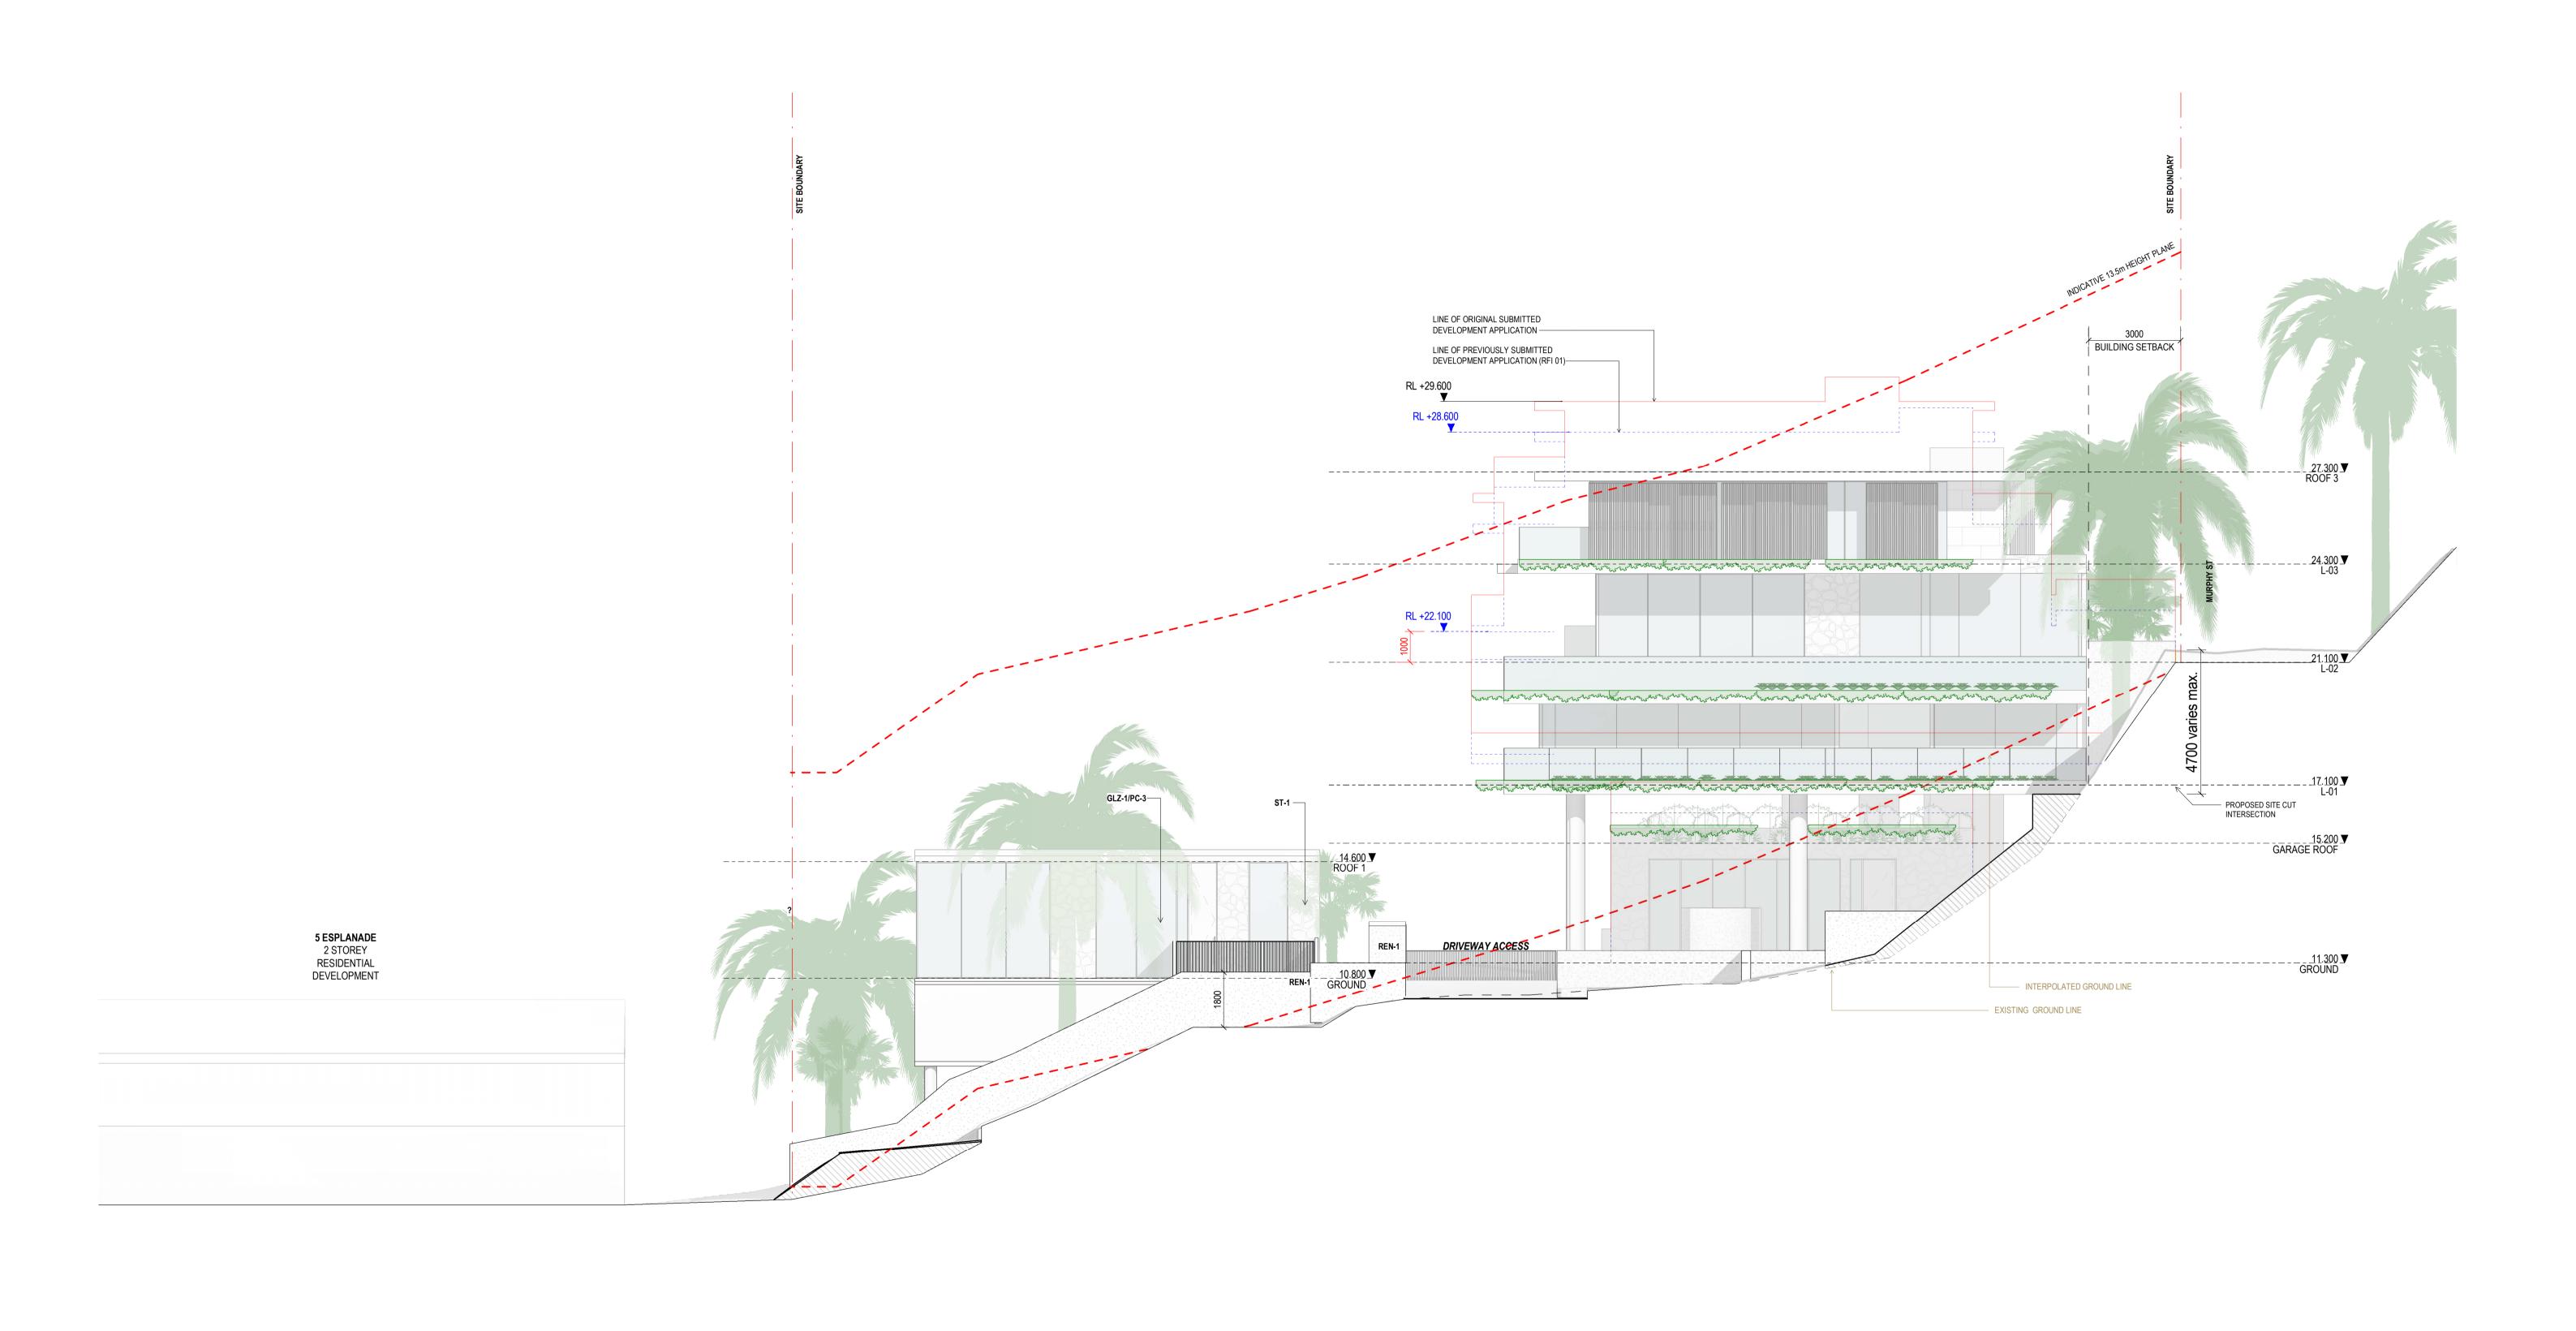
Notes — Client — Project Title Warren and Mahoney Architects Australia Pty Ltd **Drawing Title** Revisions Consultants **Drawing Details** FRAMELESS GLAZED BALUSTRADE 1200mm EAST ELEVATION 69-73 MURPHY **GURNER TM** As indicated@ A1 A 03/09/21 FOR CLIENT EXISTING RL - REFER TO SURVEY ExRL +00.000 Level 4, 141 Flinders Lane Project Manager 13/07/22 STREET COMMENT CON-1 IN-SITU CONCRETE **GURNER™** PROPOSED LEVEL Melbourne VIC 3000 RL +00.000 TIMBER FENCING Job No 9663 B 15/09/21 FOR INFORMATION Australia PORT DOUGLAS GLZ-1/PC-3 CLEAR GLAZING / LIGHT GREY OR SIMILAR Structural Engineer INDICATIVE SITE FILL C17/09/21 FOR INFORMATION SG Drawn Phone + 61 3 8547 6977 TILED PAVING D22/09/21 DRAFT DA ND Checked COBBLED STONE PAVING OR STAMPED Mechanical Engineer CONCRETE OR SIMILAR E 04/10/21 ISSUE FOR DA **DWELLING** 3 TEXTURED RENDER FINISH F 18/02/22 FOR INFORMATION **Drawing Status** Revision All dimension to be verified on site before producing shop drawings or commencing any work.
Do not scale. The copyright of this drawing remains with Warren and Mahoney Architects New Zealand Ltd. **Drawing No** Fire Engineer Registered Architects and Designers ST-1 STACKED STONE WALL G10/03/22 ISSUE RFI 01 TIMBER CLADDING OR FC SHEET, OR SIMILAR DEVELOPMENT www.warrenandmahoney.com TC-1

Electrical Engineer
Ordinary Council Meeting - 30 August 2022


DA20.002

APPLICATION


T Attachment 5.6.1

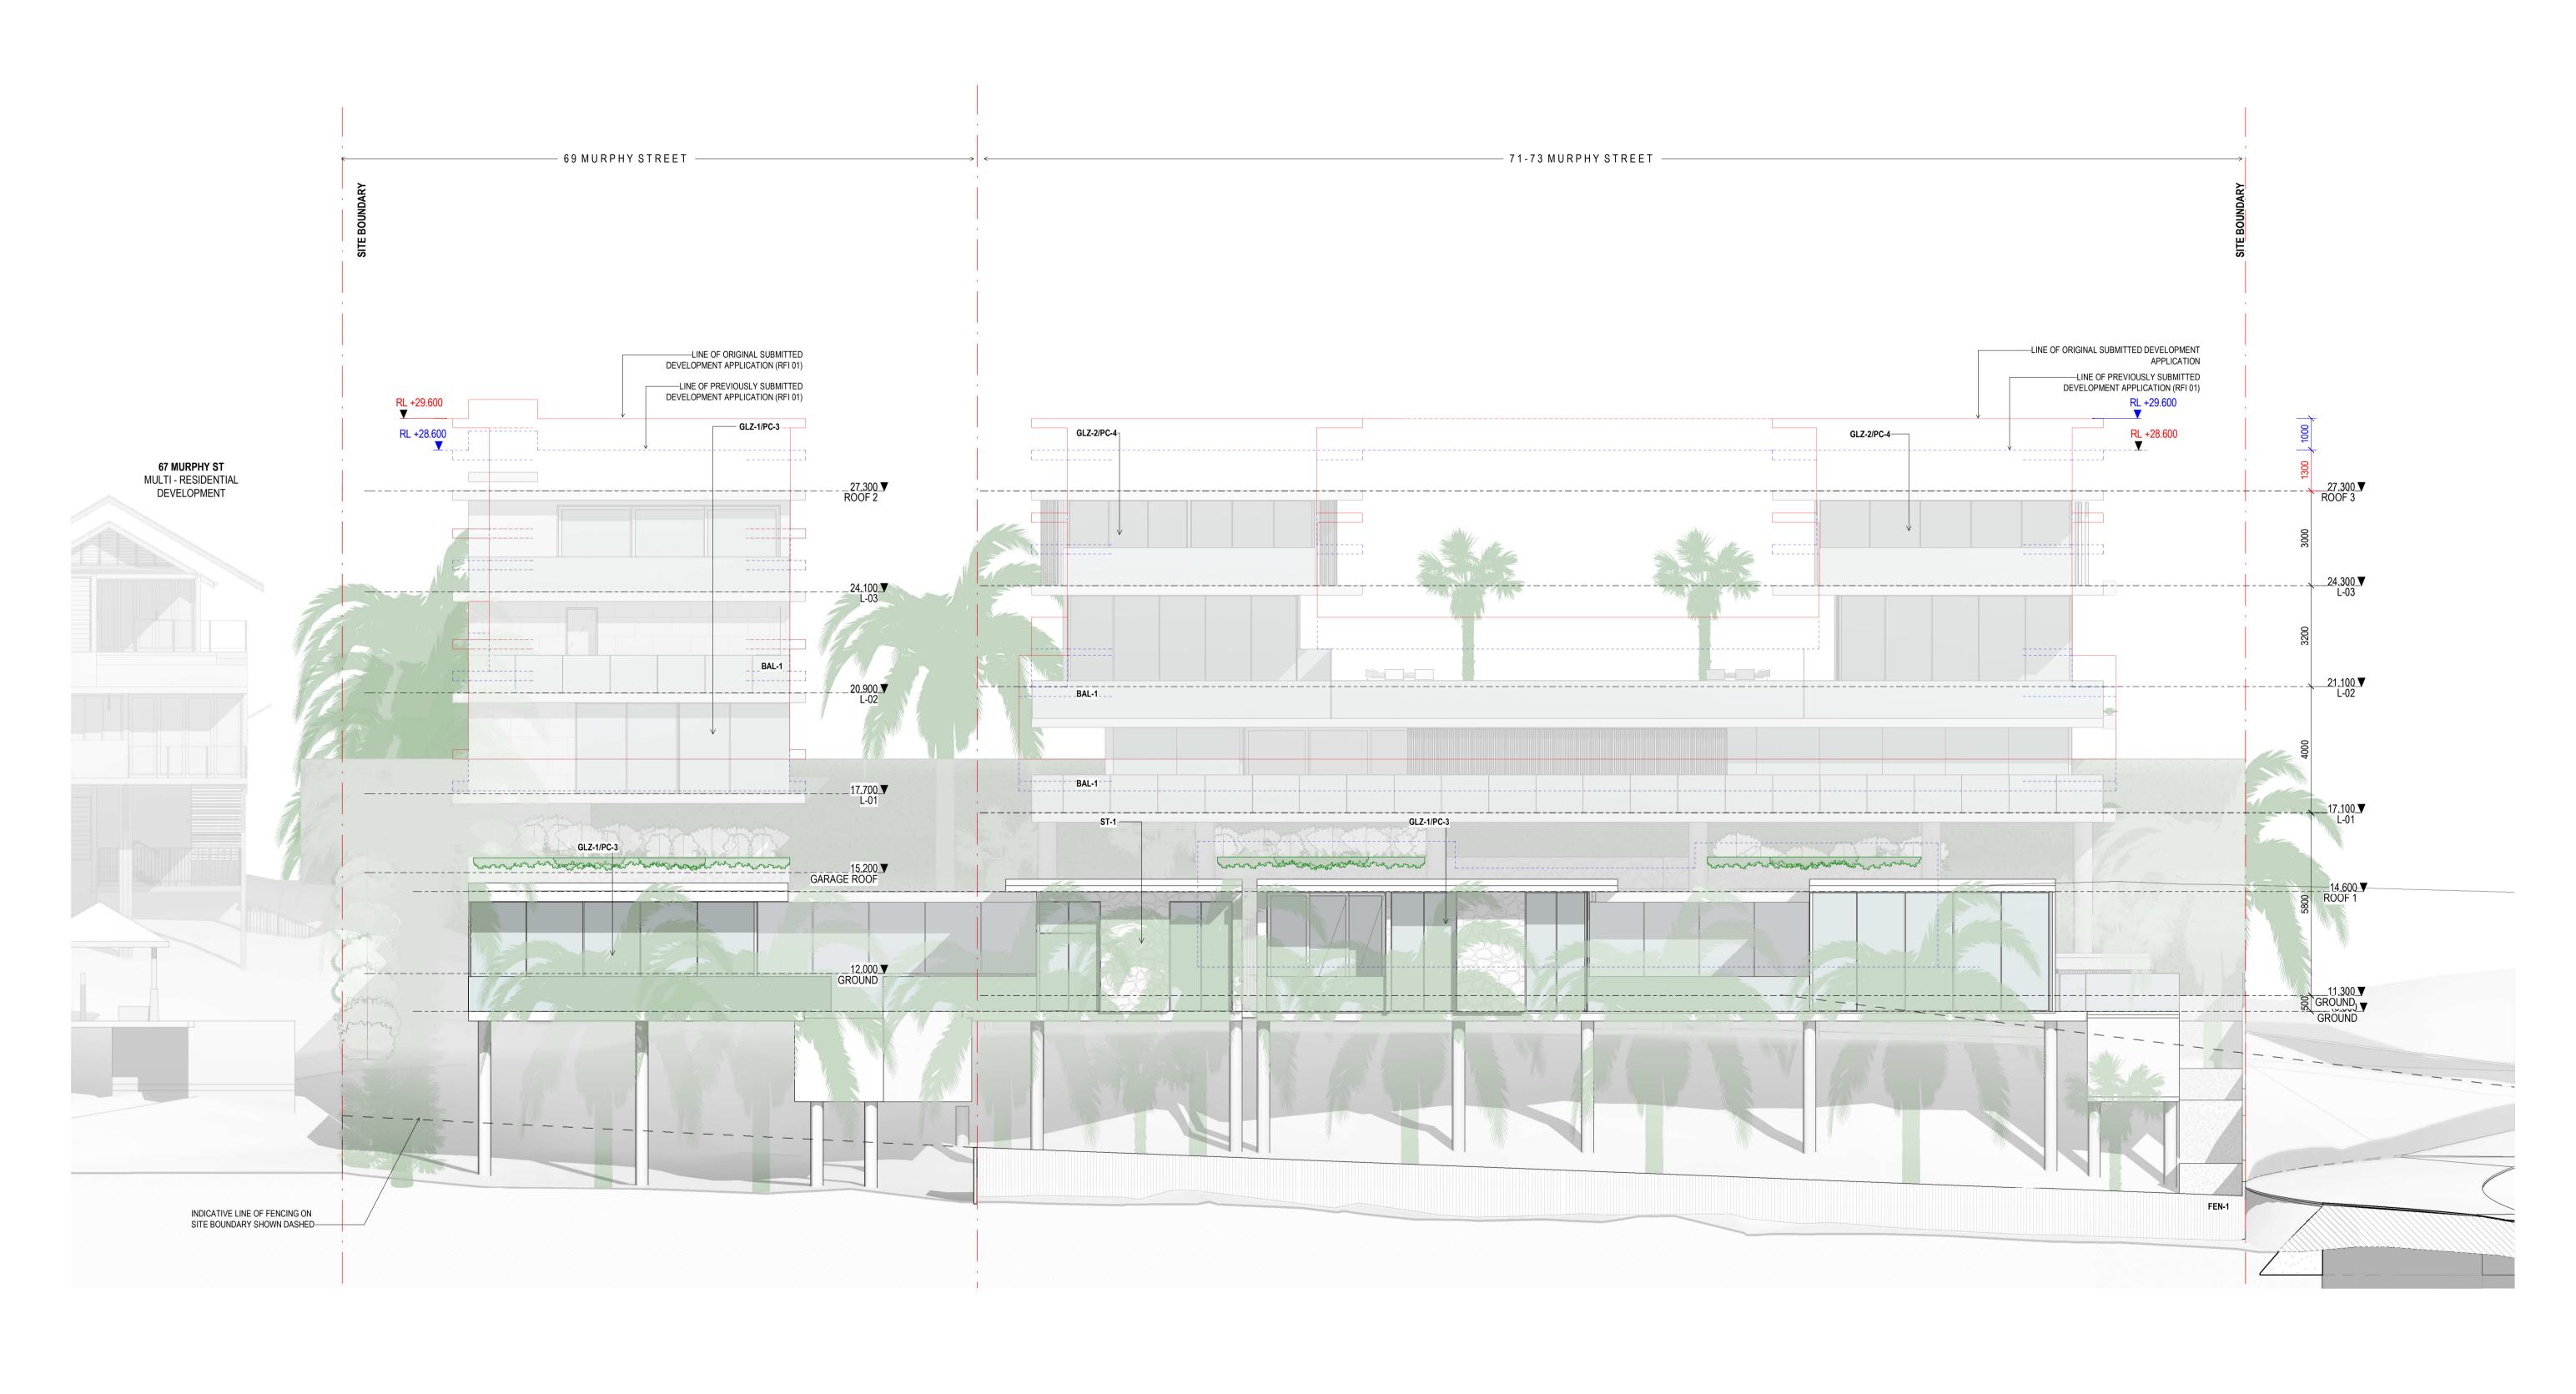

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Attachment 5.6.1

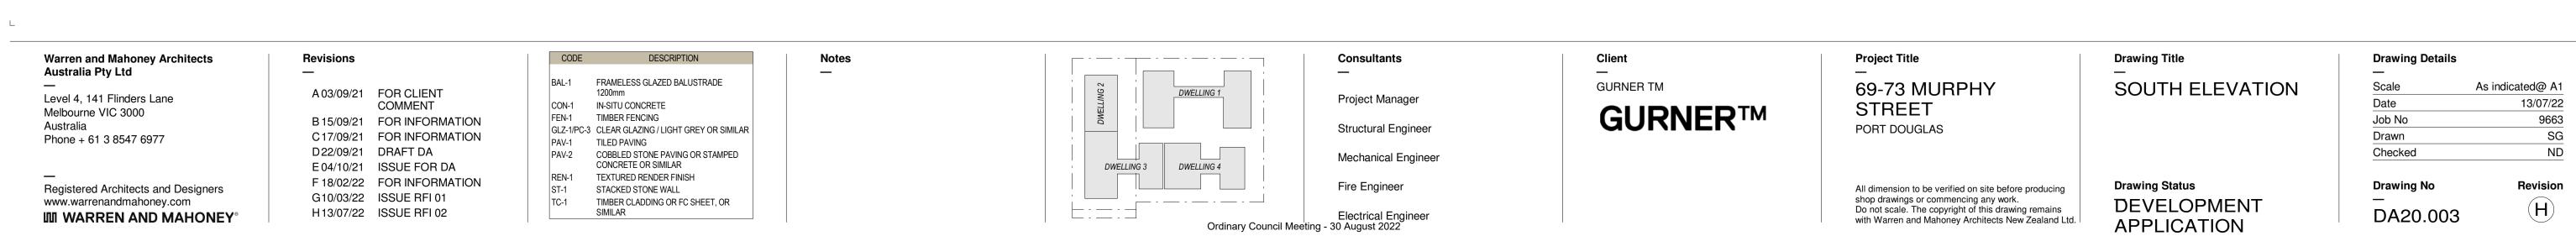

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A 03/09/21 FOR CLIENT COMMENT B 15/09/21 FOR INFORMATION C17/09/21 FOR INFORMATION D22/09/21 DRAFT DA

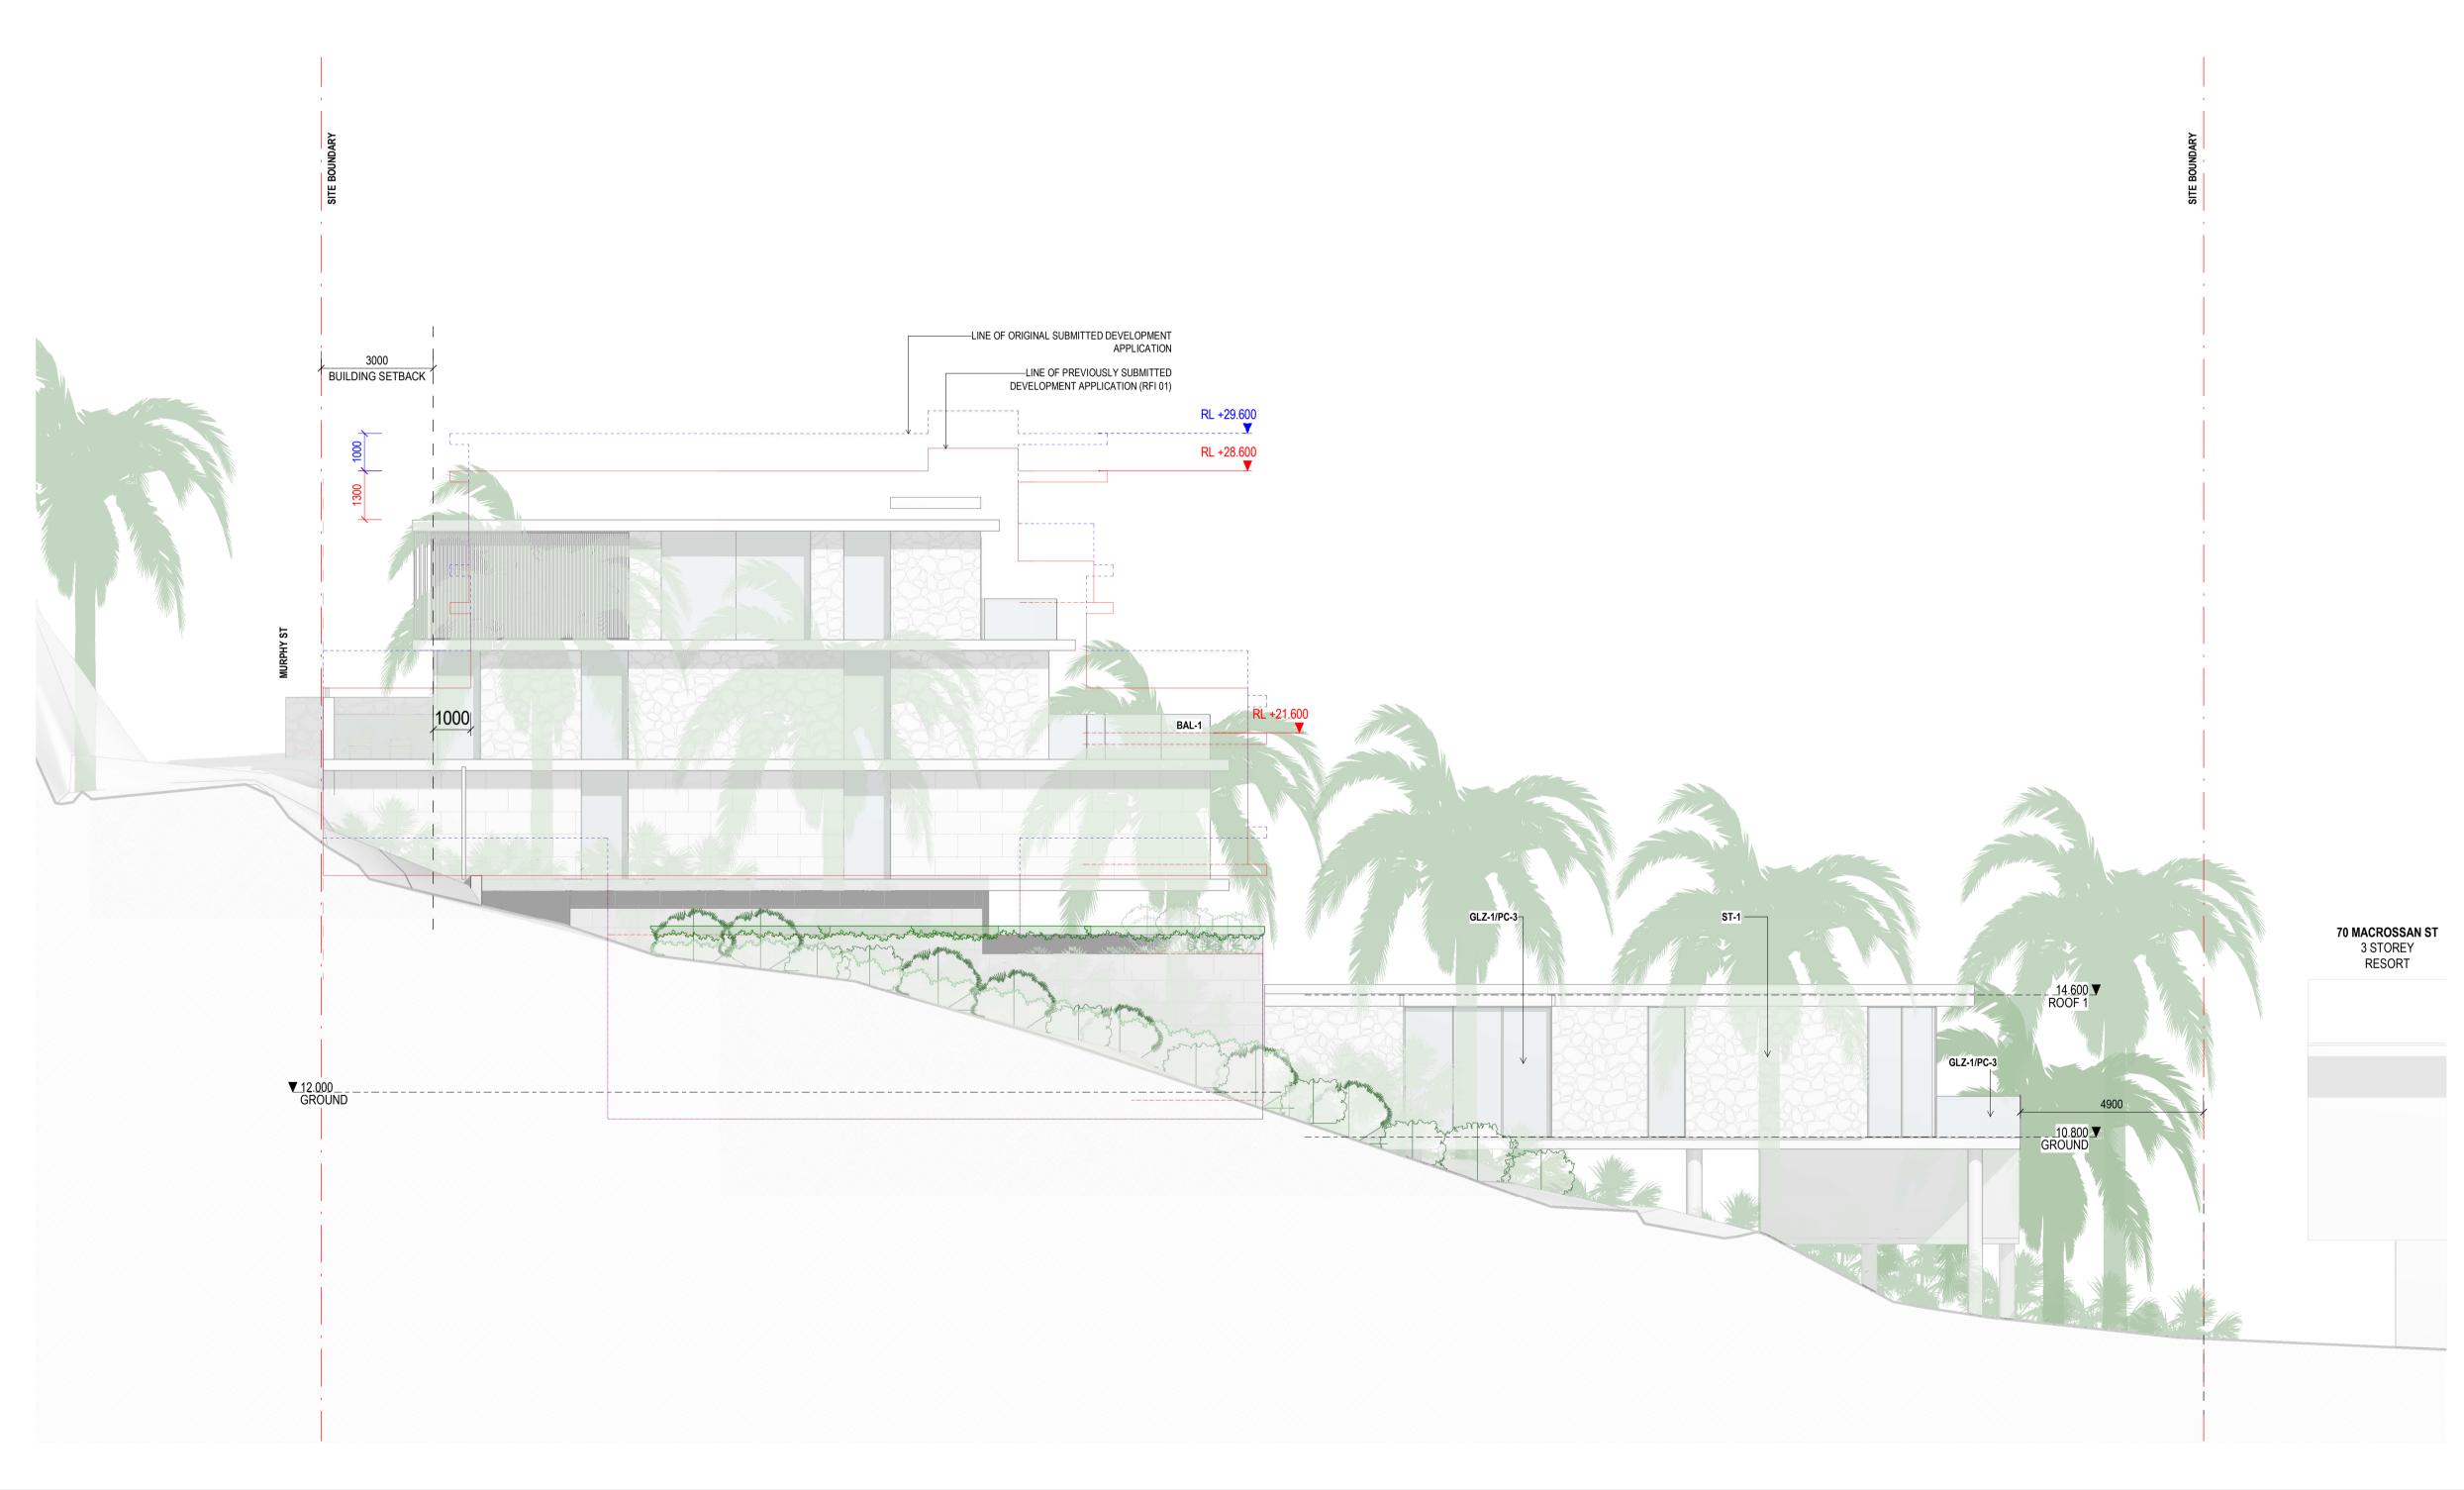E 04/10/21 ISSUE FOR DA F 10/03/22 ISSUE RFI 01 G13/07/22 ISSUE RFI 02


FRAMELESS GLAZED BALUSTRADE 1200mm CON-1 IN-SITU CONCRETE FEN-1 TIMBER FENCING GLZ-1/PC-3 CLEAR GLAZING / LIGHT GREY OR SIMILAR TILED PAVING COBBLED STONE PAVING OR STAMPED CONCRETE OR SIMILAR

TEXTURED RENDER FINISH

TIMBER CLADDING OR FC SHEET, OR SIMILAR

STACKED STONE WALL

REN-1 ST-1 TC-1

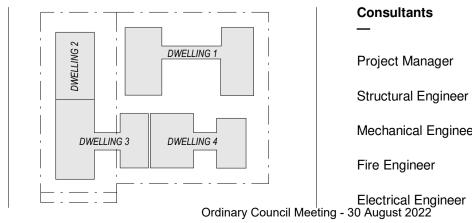

Consultants Project Manager Structural Engineer Mechanical Engineer Fire Engineer

Client — **GURNER TM GURNER™** 

Project Title 69-73 MURPHY STREET PORT DOUGLAS

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**Drawing Title** 

WEST ELEVATION


**Drawing Status** DEVELOPMENT APPLICATION

**Drawing Details** As indicated@ A1 13/07/22 Job No 9663 SG Drawn ND Checked


**Drawing No** DA20.004

Revision

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2 SITE CONTEXT - MURPHY ST PLAN
1: 250

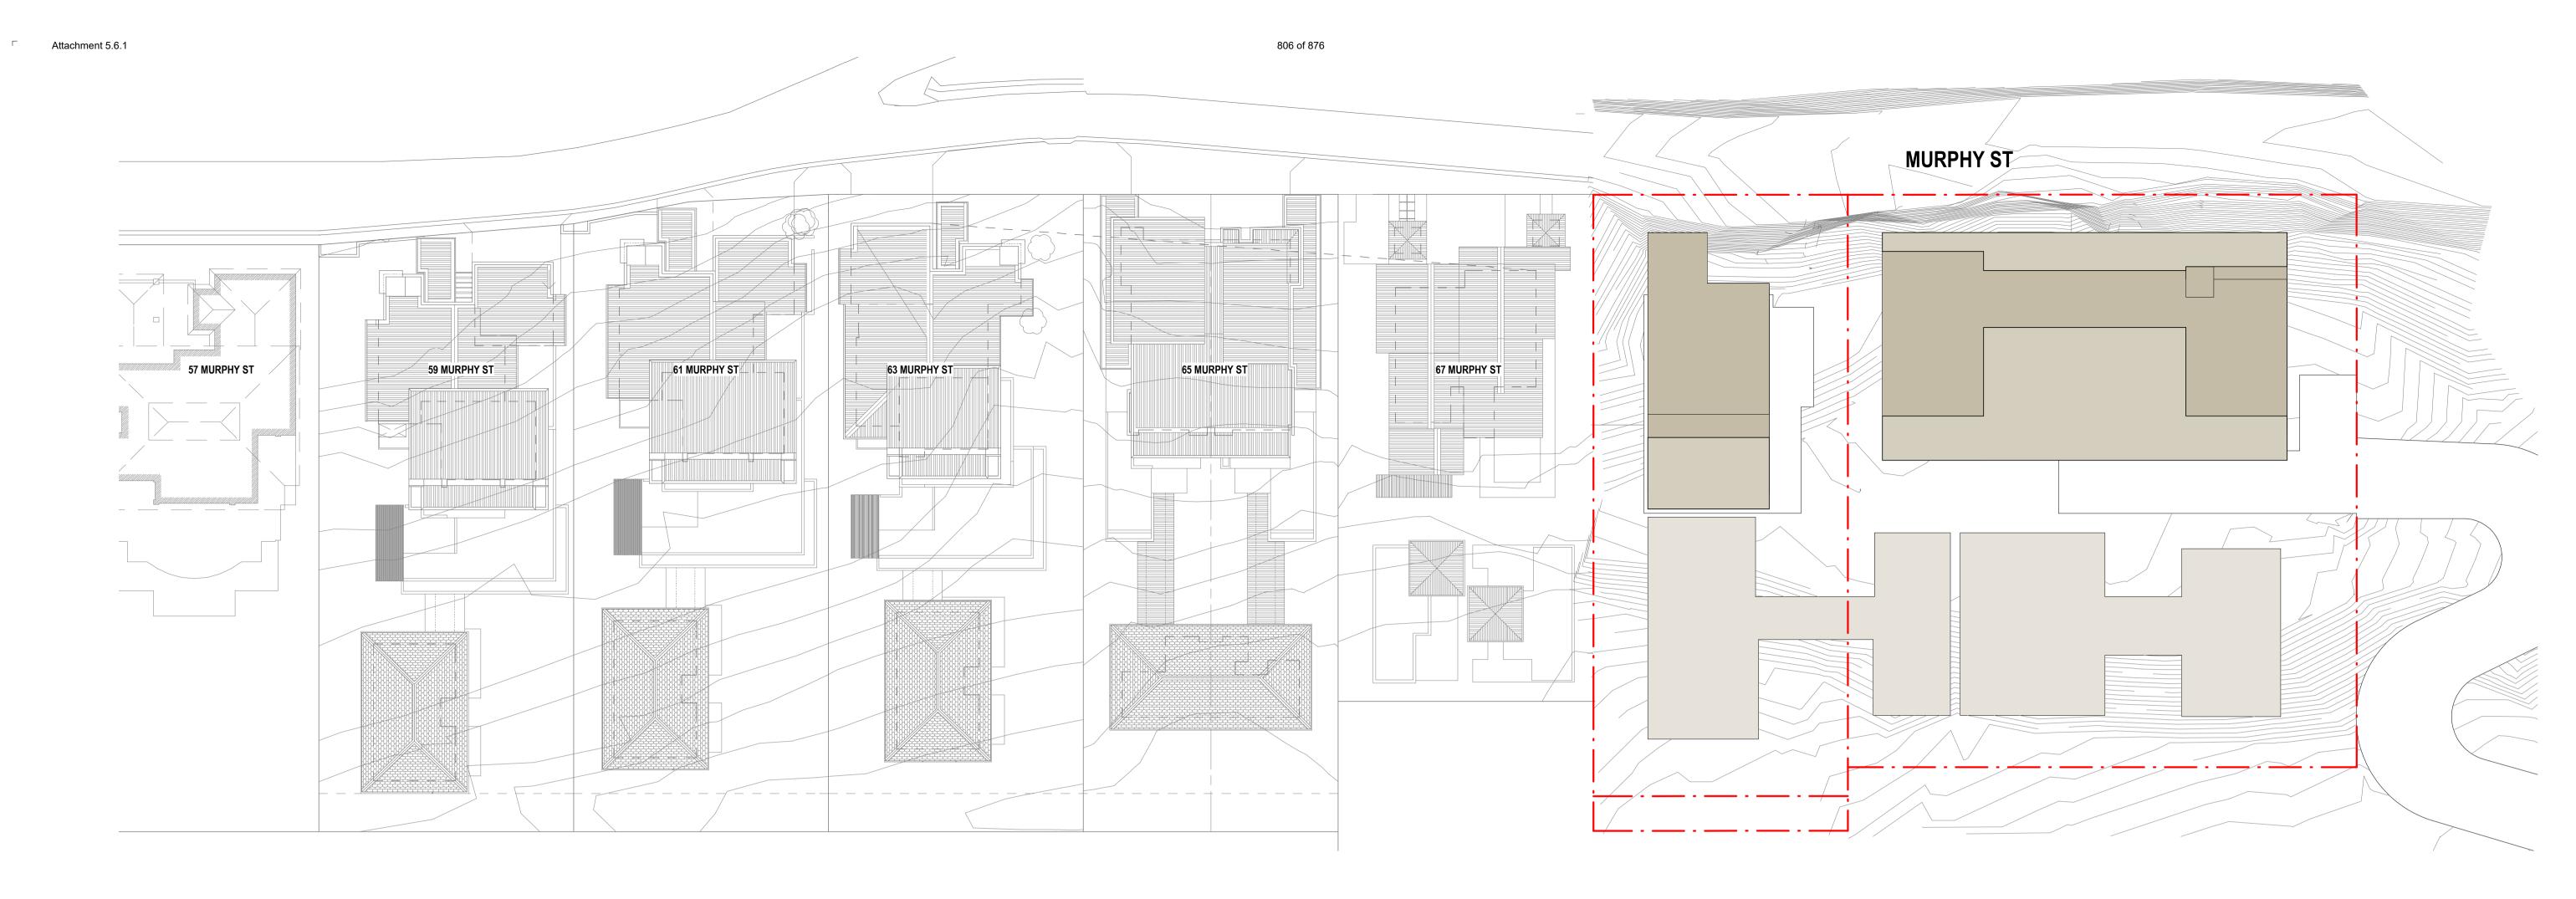


1 SITE CONTEXT - MURPHY STREET ELEVATION

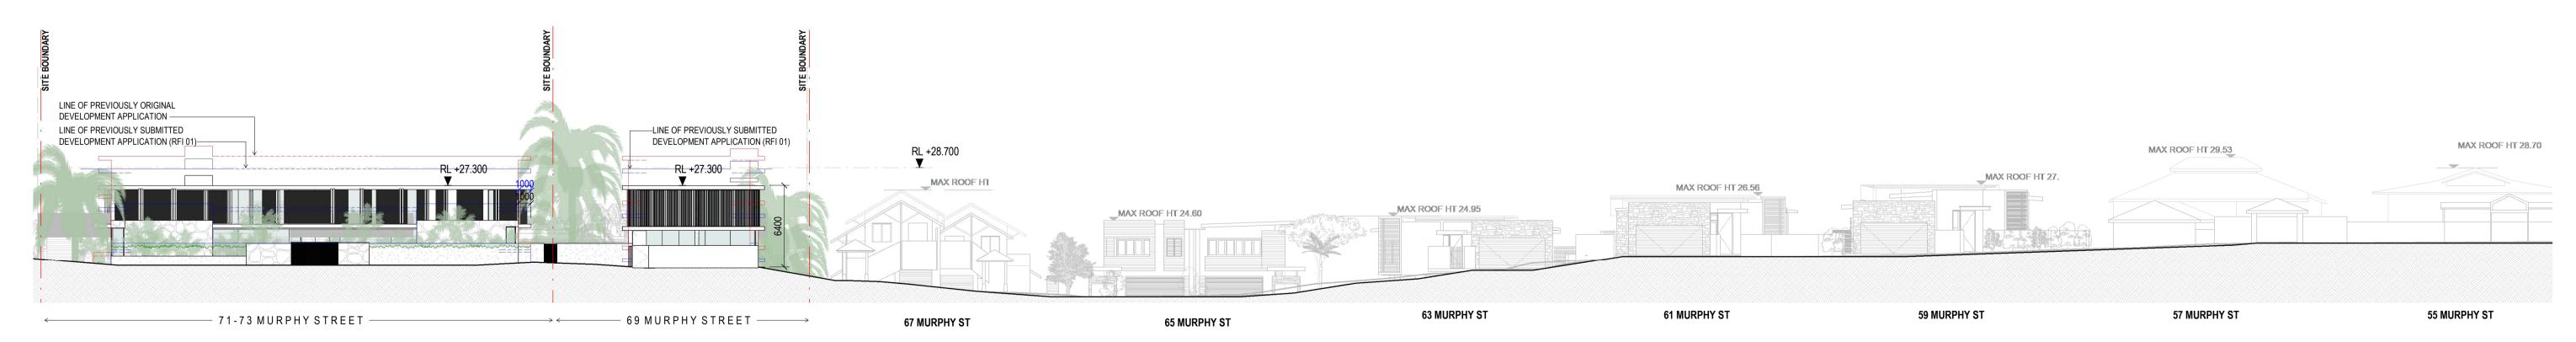
1: 250

Warren and Mahoney Architects Australia Pty Ltd **Drawing Title** Revisions Consultants Client **Project Title Drawing Details MURPHY STREET** 69-73 MURPHY **GURNER TM** 1 : 250@ A1 Scale A 13/07/22 ISSUE RFI 02 Project Manager Level 4, 141 Flinders Lane Date 13/07/22 STREET **ELEVATION** GURNER™ Melbourne VIC 3000 Job No 9663 Australia PORT DOUGLAS Structural Engineer Drawn Author Phone + 61 3 8547 6977 Checked Checker Mechanical Engineer Fire Engineer **Drawing Status** All dimension to be verified on site before producing shop drawings or commencing any work.

Do not scale. The copyright of this drawing remains with Warren and Mahoney Architects New Zealand Ltd. **Drawing No** Revision Registered Architects and Designers www.warrenandmahoney.com DEVELOPMENT DA20.100 Electrical Engineer
Ordinary Council Meeting - 30 August 2022 **III WARREN AND MAHONEY® APPLICATION** 

Attachment 5.6.1

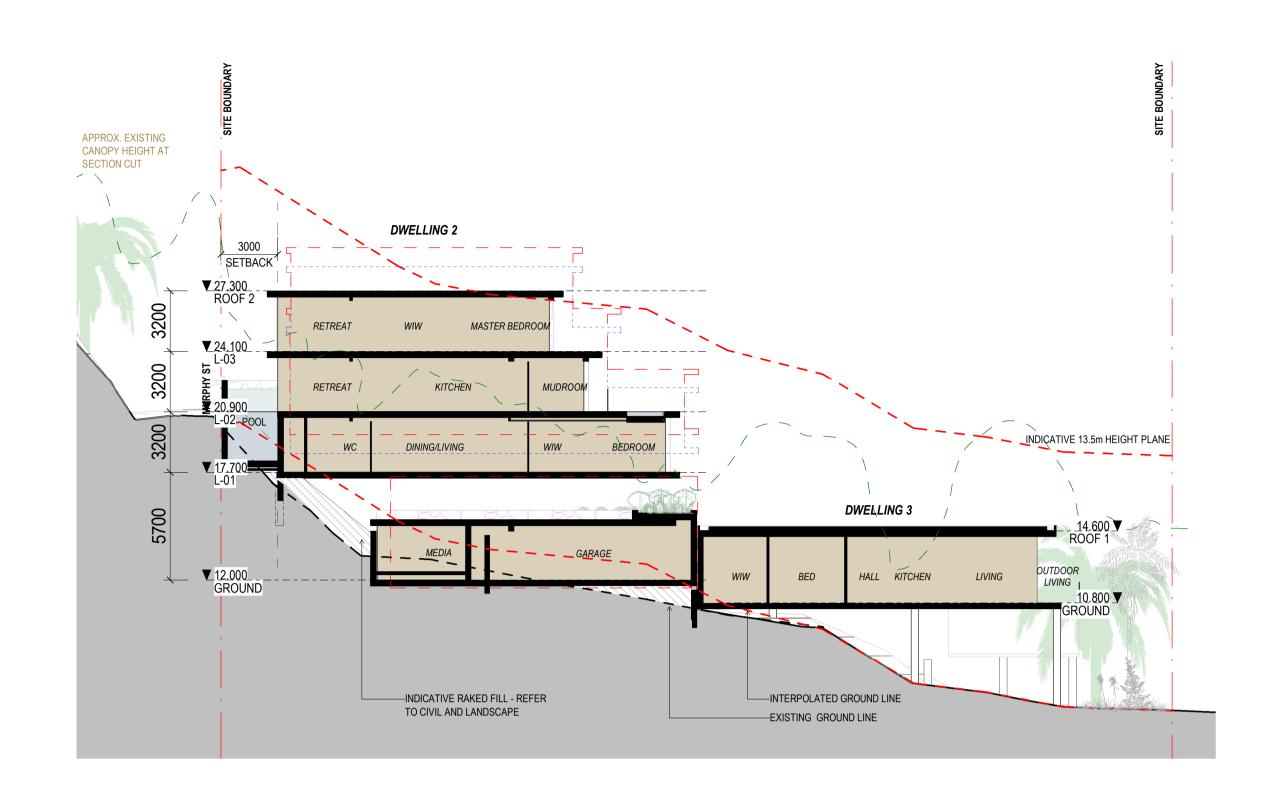

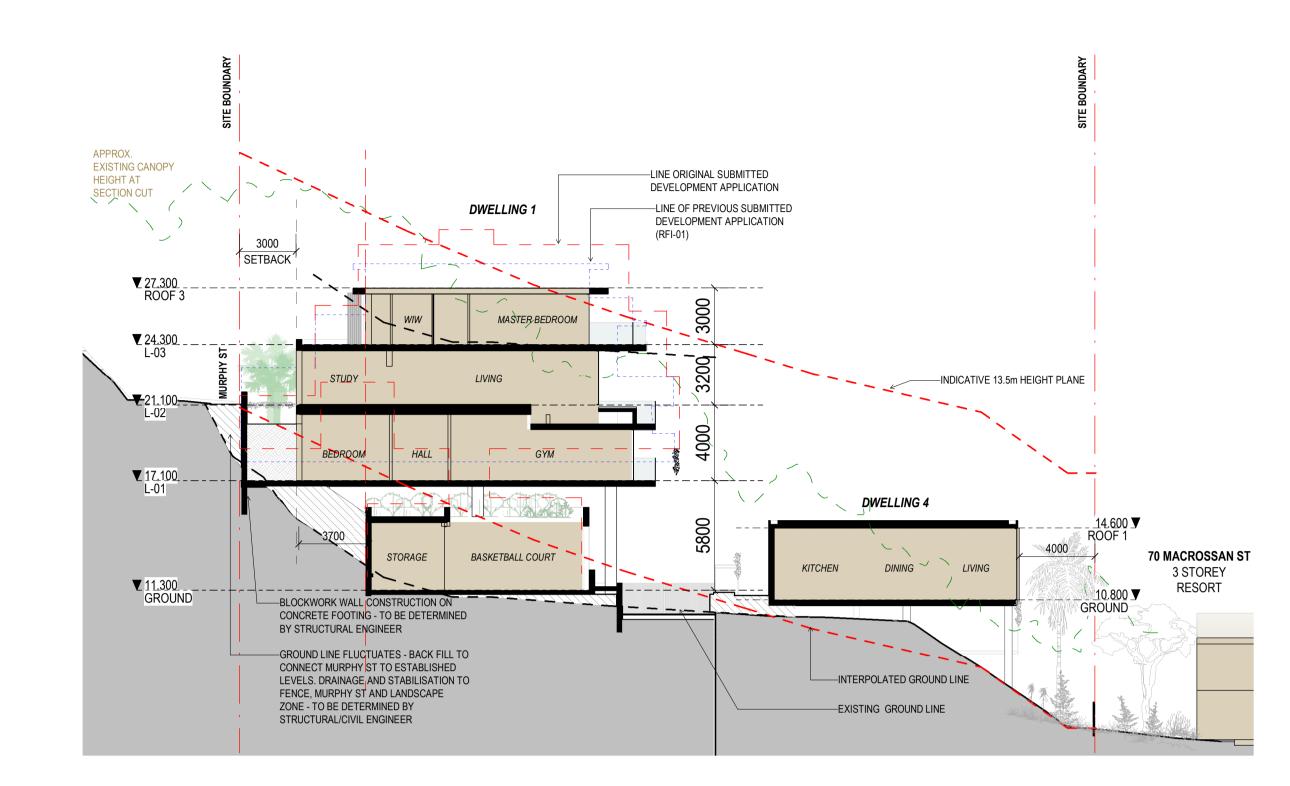

APPLICATION

SECTION 1

1:200

SECTION 2


1:200

807 of 876


Client — Project Title Warren and Mahoney Architects Australia Pty Ltd Revisions Consultants **Drawing Title Drawing Details** 69-73 MURPHY TYPICAL SECTIONS **GURNER TM** As indicated@ A1 C15/09/21 FOR INFORMATION EXISTING RL - REFER TO SURVEY ExRL +00.000 Project Manager Level 4, 141 Flinders Lane 13/07/22 STREET D17/09/21 FOR INFORMATION GURNER™ PROPOSED LEVEL Melbourne VIC 3000 RL +00.000 Job No 9663 E 21/09/21 FOR COORDINATION Australia PORT DOUGLAS Structural Engineer INDICATIVE SITE FILL Drawn SG Phone + 61 3 8547 6977 F 22/09/21 DRAFT DA ND Checked G04/10/21 ISSUE FOR DA Mechanical Engineer DWELLING 3 **DWELLING 4** H18/02/22 FOR INFORMATION J 10/03/22 ISSUE RFI 01 **Drawing Status** All dimension to be verified on site before producing shop drawings or commencing any work.


Do not scale. The copyright of this drawing remains with Warren and Mahoney Architects New Zealand Ltd. **Drawing No** Revision Fire Engineer Registered Architects and Designers K 13/07/22 ISSUE RFI 02 DEVELOPMENT  ${\color{red} (\mathbf{K})}$ www.warrenandmahoney.com DA30.001 Electrical Engineer
Ordinary Council Meeting - 30 August 2022 **III WARREN AND MAHONEY®** 

□ Attachment 5.6.1

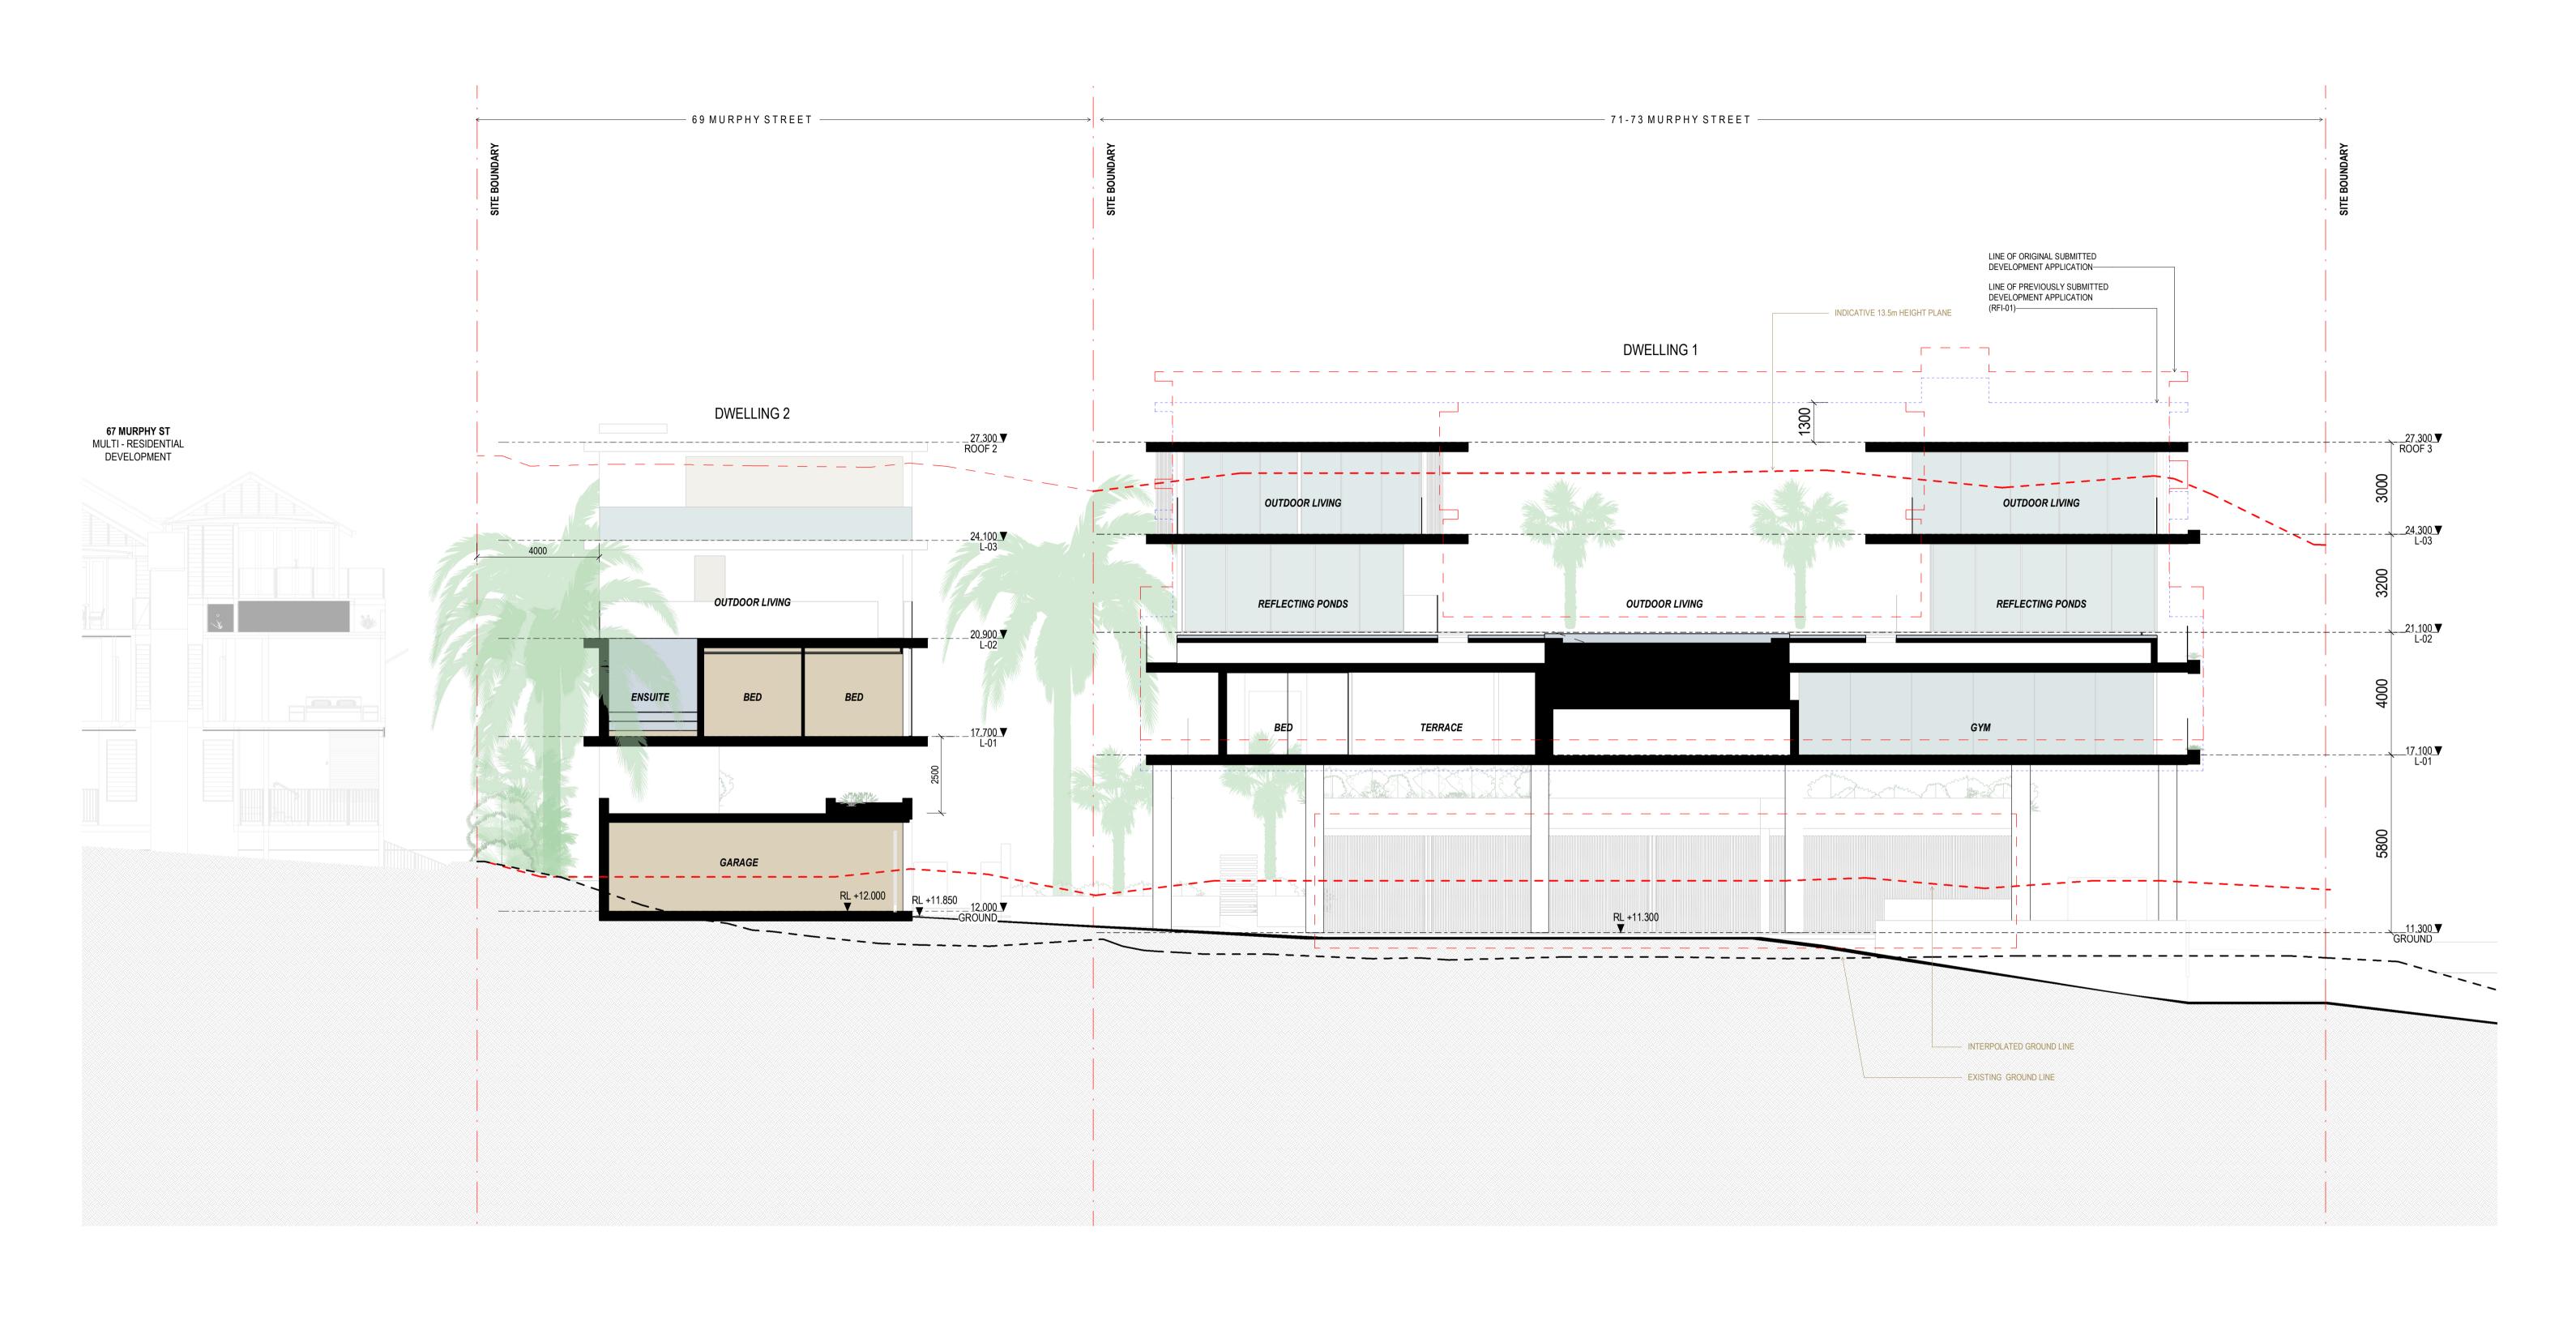


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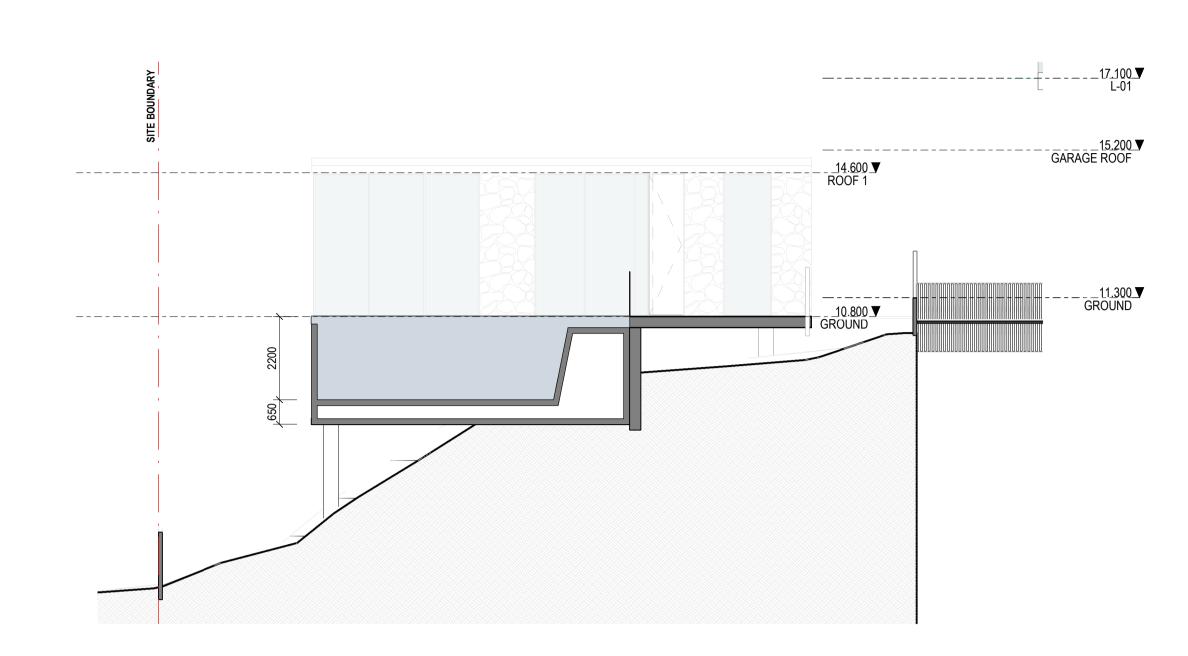


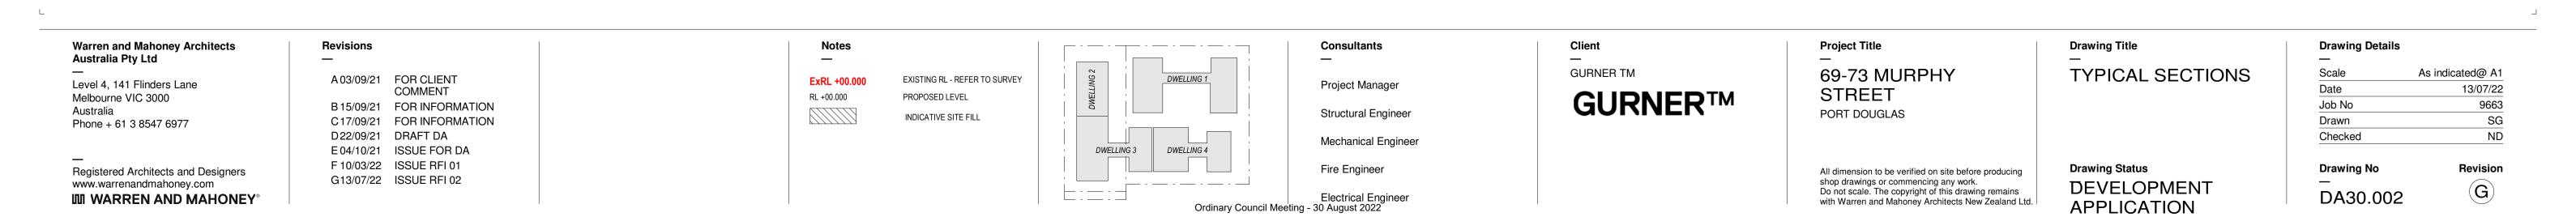

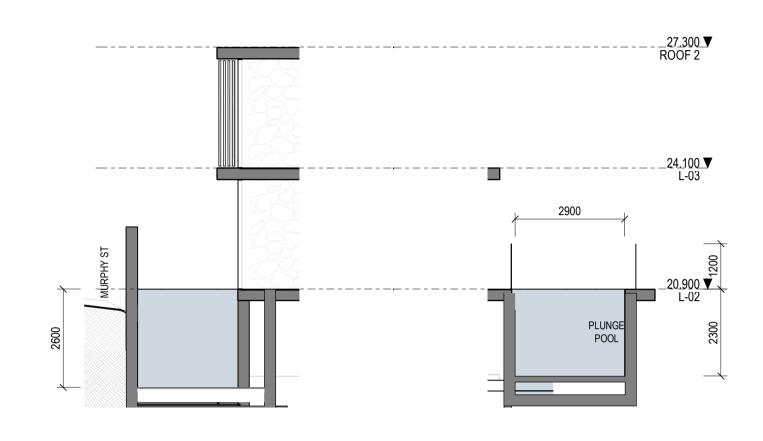
DWELLING 2 - POOL SECTION

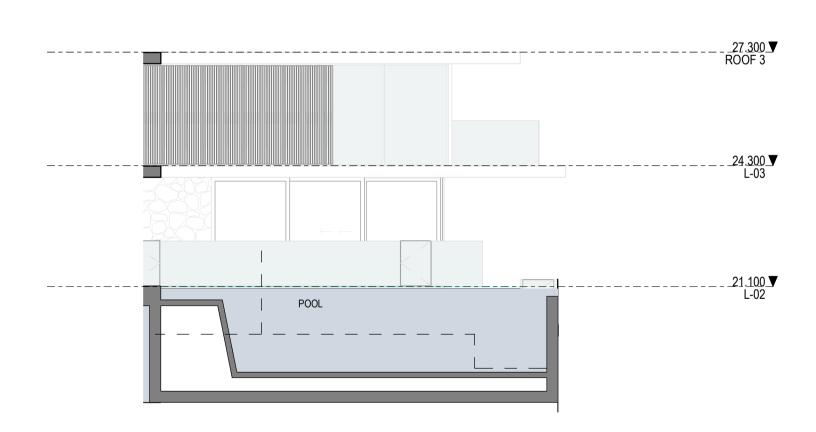

DWELLING 1 - POOL SECTION



DWELLING 4 - POOL SECTION

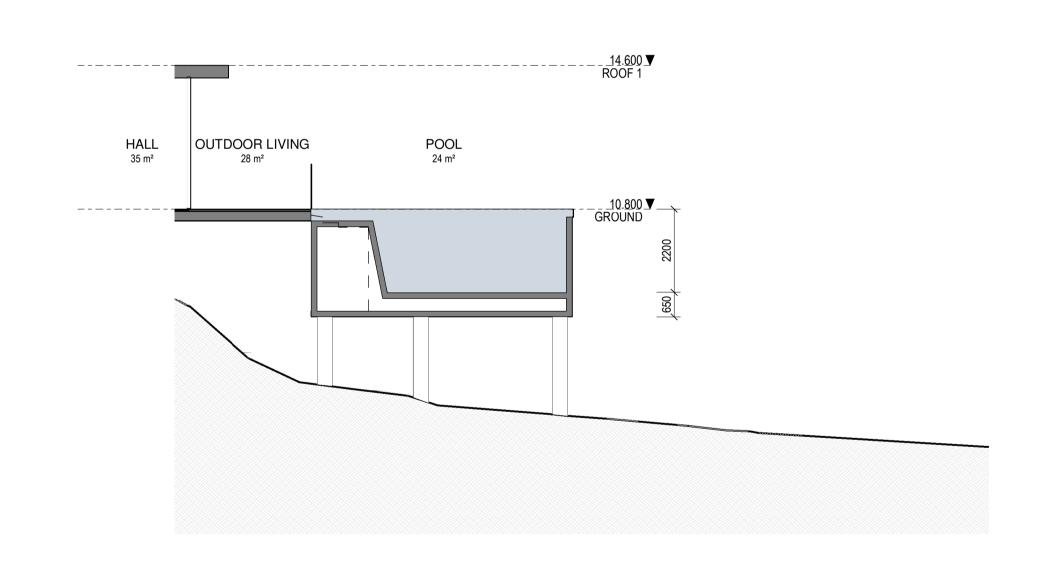

DWELLING 3 - POOL SECTION

Warren and Mahoney Architects Australia Pty Ltd

Level 4, 141 Flinders Lane Melbourne VIC 3000 Australia Phone + 61 3 8547 6977


Registered Architects and Designers www.warrenandmahoney.com **III WARREN AND MAHONEY®**  Revisions

A 10/03/22 ISSUE RFI 01 B 13/07/22 ISSUE RFI 02

Notes — ExRL +00.000 RL +00.000

EXISTING RL - REFER TO SURVEY PROPOSED LEVEL INDICATIVE SITE FILL

**DWELLING** 3

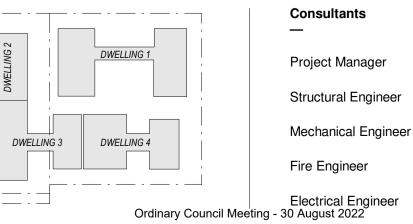

Client **GURNER TM GURNER™** 

Project Title 69-73 MURPHY STREET PORT DOUGLAS

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**Drawing Title POOL SECTIONS** 

**Drawing Status** DEVELOPMENT **APPLICATION** 

**Drawing Details** Scale Date Job No

> Drawn Checked **Drawing No**

Revision DA30.003

As indicated@ A1

13/07/22


9663

SG


BG

Attachment 5.6.1



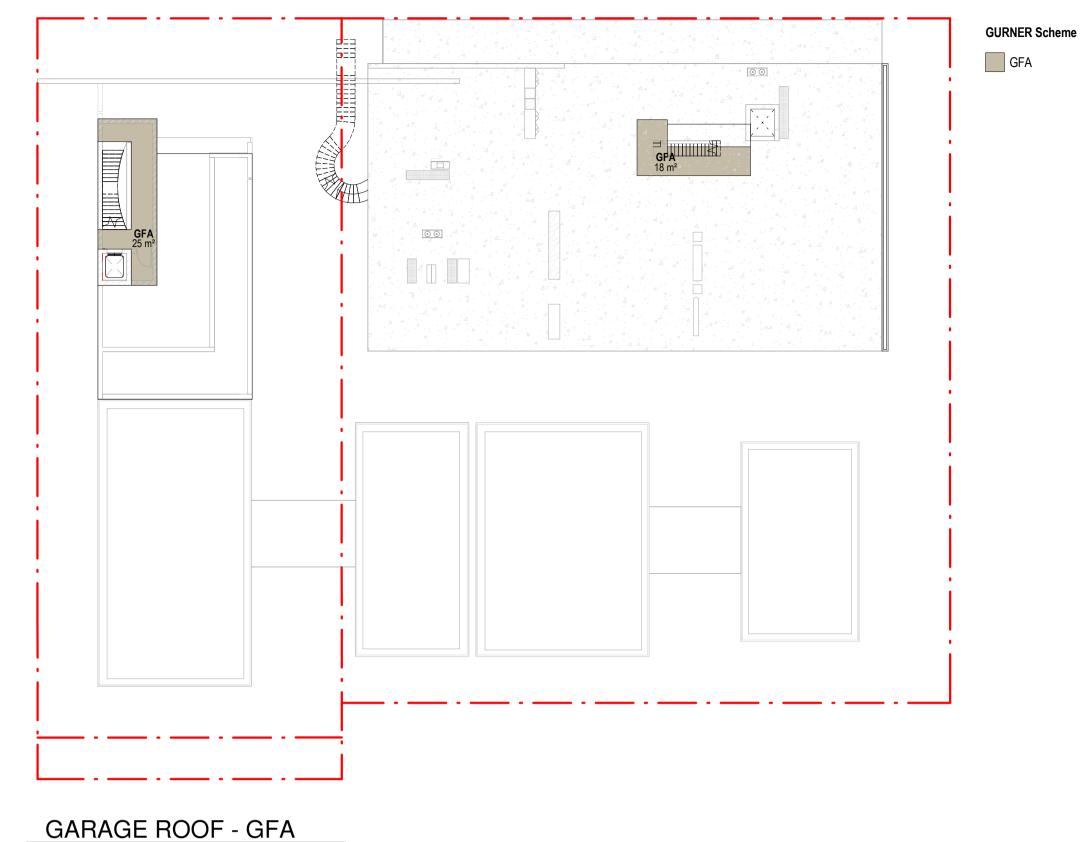

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#### GROSS FLOOR AREA (PLANNING):

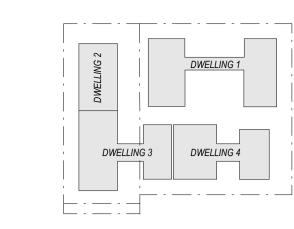The total floor area of all storeys of a building (measured from the outside of the external walls or the centre of a common wall), other than areas used for the following:

(a) building services, plant and equipment (b) access between levels

(c) ground floor public lobby

(d) a mall (e) the parking, loading and manoeuvring of motor vehicles

(f) unenclosed private balconies whether roofed or not.

**GFA (PLANNING)** 


## POS (PLANNING)


TYPE	AREA	TYPE	AREA
IG 1		DWELLING 1	
	1015 m <sup>2</sup>	POS	533 m <sup>2</sup>
IG 2		DWELLING 2	
	506 m²	POS	182 m²
IG 3		DWELLING 3	
	233 m²	POS	190 m²
IG 4		DWELLING 4	
	221 m²	POS	102 m²
	1976 m²		1007 m²


#### **CIRCULATION AND SERVICES ZONES**

TYPE	AREA
DWELLING 1	
CARPARK	147 m²
CIRCULATION	14 m²
SERVICES	98 m²
DWELLING 2	
CARPARK	80 m²
CIRCULATION	17 m <sup>2</sup>
SERVICES	31 m²
DWELLING 3	
CARPARK	49 m²
DWELLING 4	
CARPARK	48 m²
FSR (PLANNING)	484 m²

		F	SR
GFA	SITE AREA	FSR	:1

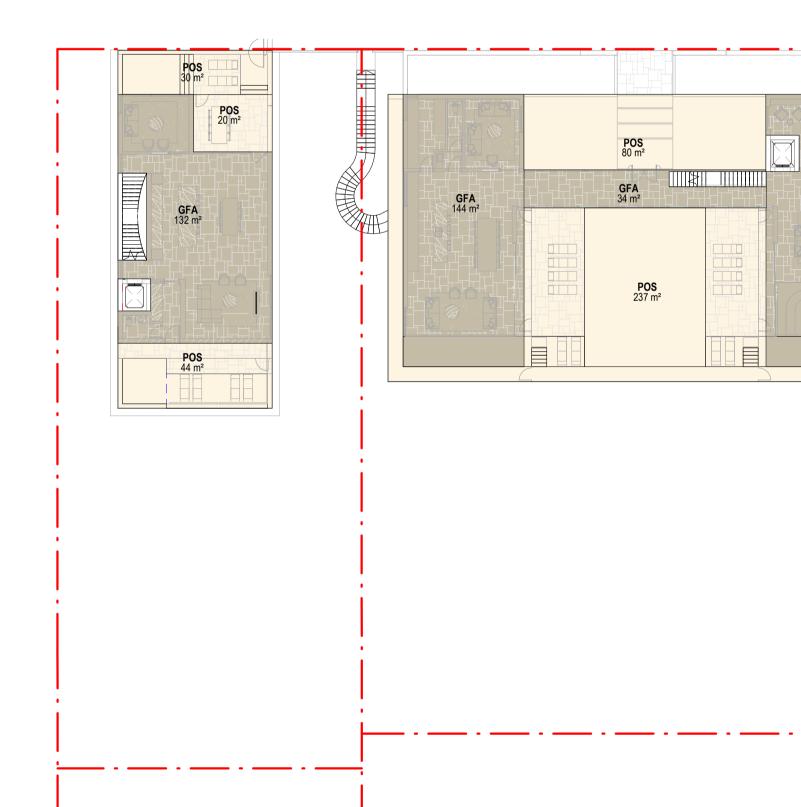

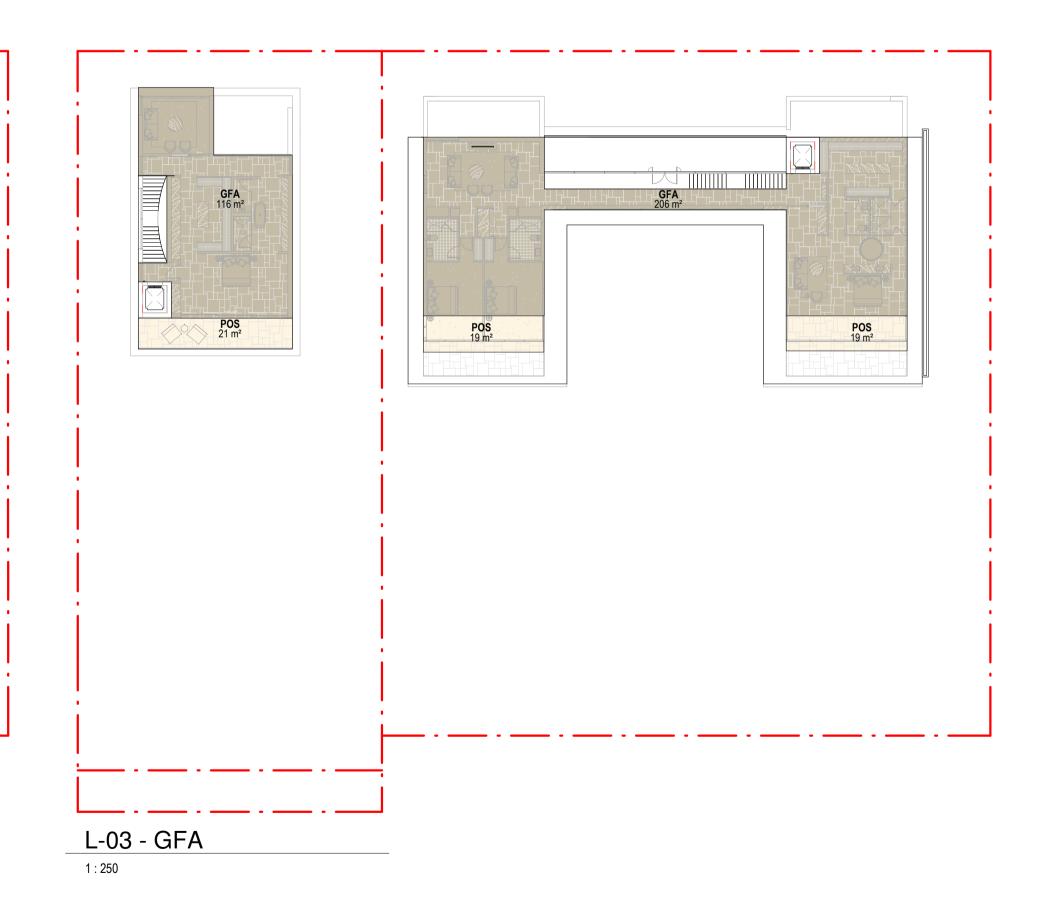

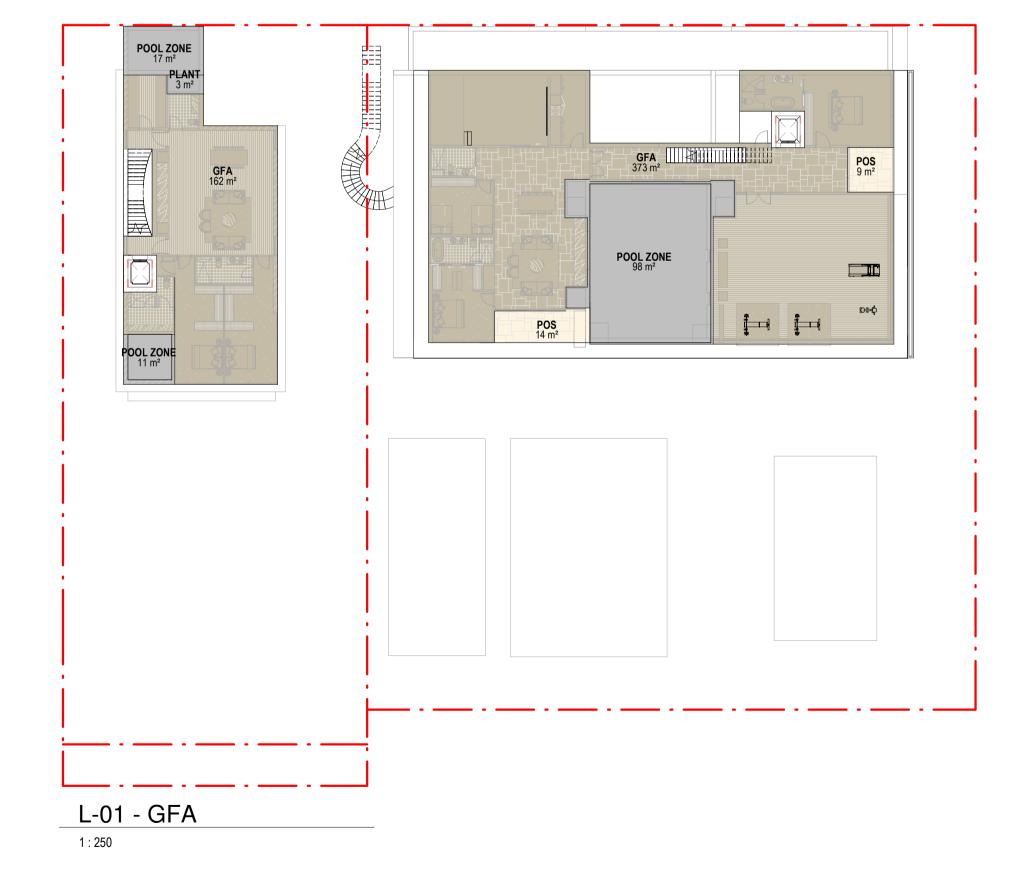



Melbourne VIC 3000

Australia

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Notes —

1:250

L-02 - GFA

1:250

Project Manager Structural Engineer Mechanical Engineer Fire Engineer Electrical Engineer
Ordinary Council Meeting - 30 August 2022

Consultants

Client **GURNER TM** 

**GFA** 139 m²

**GURNER™** 

**Project Title** 69-73 MURPHY STREET PORT DOUGLAS

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**Drawing Title** DEVELOPMENT

SUMMARY - GFA **Drawing Status** 

Scale As indicated@ A1 Date 13/07/22 Job No 9663 Drawn Checked


SG

ND

Revision


**Drawing Details** 

**Drawing No** DEVELOPMENT DA50.001 APPLICATION

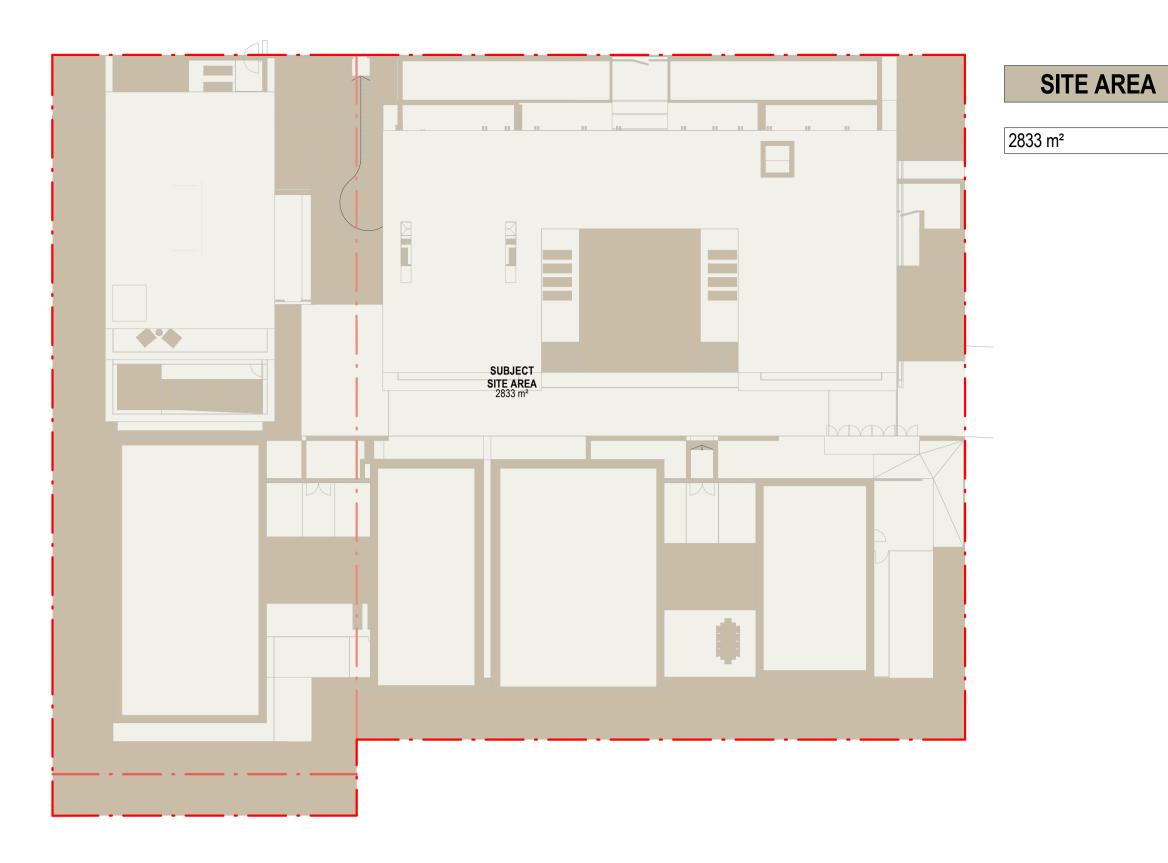

SITE AREA

1:250

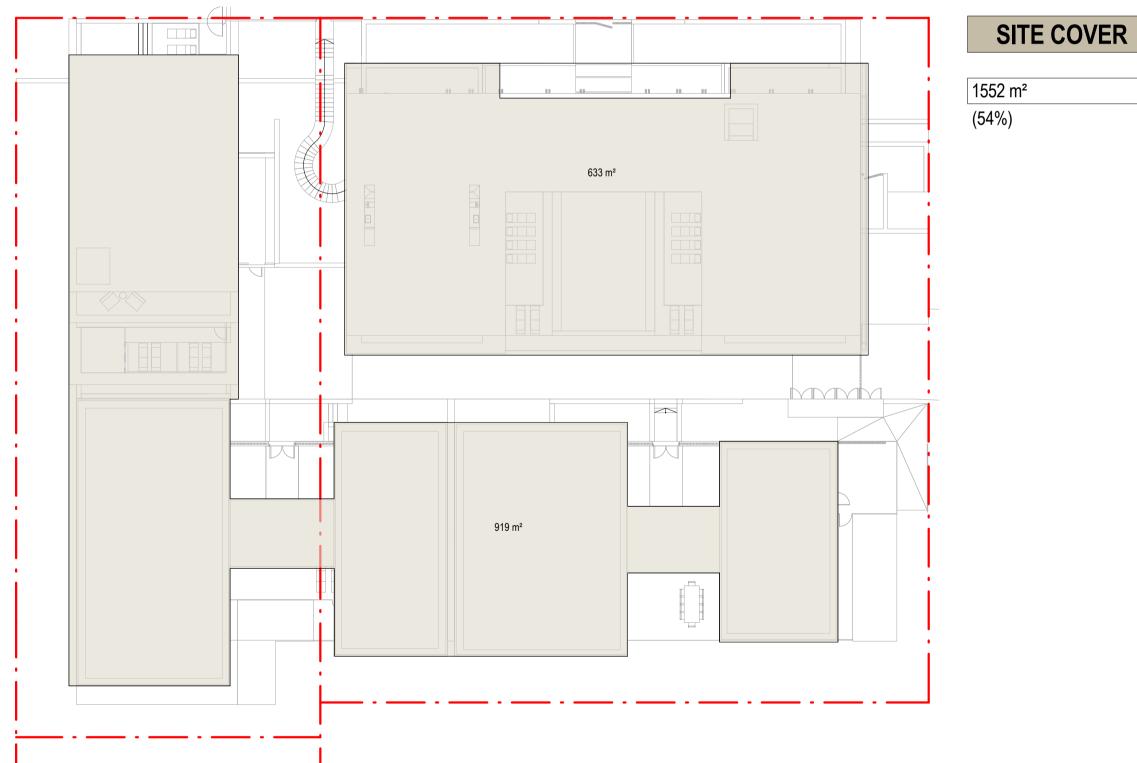

**L-01** 40m² AHD 19100 GROUND 135m<sup>2</sup> AHD 18100

SITE COVER (PLANNING):

THE PROPORTION OF THE SITE COVERED BY A BUILDING(S), STRUCTURE(S) ATTACHED TO THE BUILDING(S) AND CARPORT(S), CALCULATED TO THE OUTER MOST PROJECTIONS OF THE BUILDING(S) AND EXPRESSED AS A PERCENTAGE.

THE TERM DOES NOT INCLUDE:

(A) ANY STRUCTURE OR PART THEREOF INCLUDED IN A LANDSCAPED OPEN SPACE AREA SUCH AS A GAZEBO OR SHADE STRUCTURE;

(B) BASEMENT CAR PARKING AREAS LOCATED WHOLLY BELOW GROUND LEVEL.

GROUND LEVEL DEFINITION:
THE LEVEL OF THE NATURAL GROUND, OR, WHERE THE LEVEL OF THE NATURAL GROUND HAS BEEN CHANGED, THE LEVEL AS LAWFULLY CHANGED.

LOT 141 SR 530

Warren and Mahoney Architects Australia Pty Ltd

1:250

TOTAL SITE COVER

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C04/10/21 ISSUE FOR DA D18/02/22 FOR INFORMATION E 10/03/22 ISSUE RFI 01 F 13/07/22 ISSUE RFI 02

Project Manager Structural Engineer Mechanical Engineer Fire Engineer Electrical Engineer
Ordinary Council Meeting - 30 August 2022

Consultants

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PROPOSED EXCAVATED AREAS

1:250

Client — **GURNER TM** 

GURNER™

Project Title 69-73 MURPHY STREET PORT DOUGLAS

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**Drawing Title** 

DEVELOPMENT SUMMARY - SITE COVER

**Drawing Status** DEVELOPMENT **APPLICATION** 

**Drawing Details** Scale Date

Job No 9663 SG Drawn ND Checked **Drawing No** 


DA50.002



1 : 250@ A1

13/07/22

□ Attachment 5.6.1

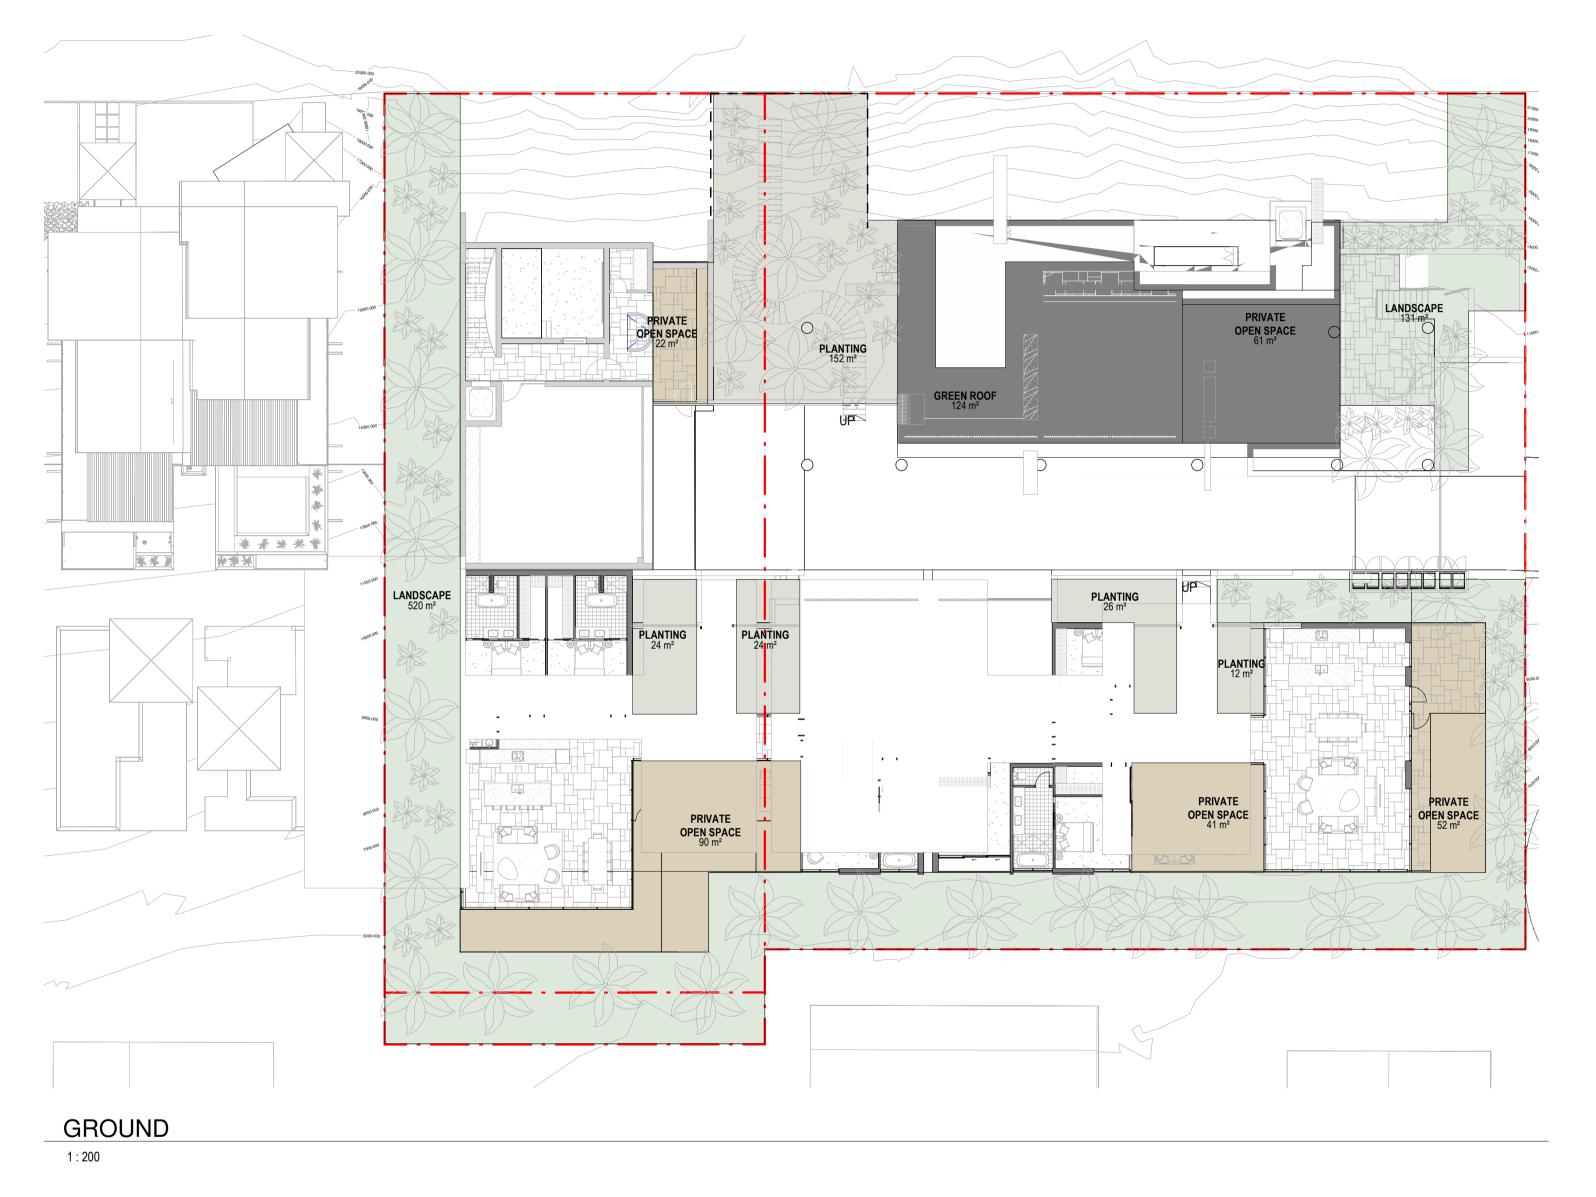



## LANDSCAPE/OPEN SPACE REQUIREMENTS:

A minimum of 35% of the site is allocated as landscaping and recreation area.

Development provides landscaping as follows: (a) A dense landscape planting strip of at least 2 metres width suitable for deep planting is provided and maintained along all street frontages; (b) A dense landscape planting strip of at least 1.5 metres width suitable for deep planting is provided along all side and rear boundaries.


\*not including green roof area

Development provides private open space which: (a) for ground storey dwellings, comprises of a minimum area of 35m2 with a


minimum dimension of 3 metres; (b) for dwellings above ground storey, comprises of a balcony with minimum area of 12m2 and a minimum dimension of 3 metres.

Development provides private open space areas that are: (a) directly accessible from internal primary living area of the dwelling (not

bedrooms); (b) provided with a screened area of 2m2 minimum dimension capable of screening air conditioning plant, private clothes drying etc... (c) provided with adjustable, moveable or operable privacy screening where appropriate.

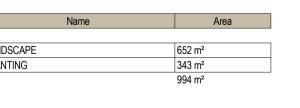

## 35% Landscape Coverage\*

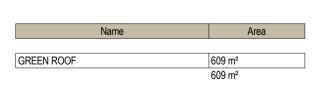

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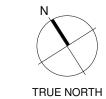
**Ⅲ WARREN AND MAHONEY®** 

Revisions

A 15/09/21 FOR INFORMATION B 22/09/21 DRAFT DA C04/10/21 ISSUE FOR DA D18/02/22 FOR INFORMATION E 10/03/22 ISSUE RFI 01

F 13/07/22 ISSUE RFI 02





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Project Manager Structural Engineer Mechanical Engineer

Consultants

Fire Engineer

Electrical Engineer
Ordinary Council Meeting - 30 August 2022

## Client

**GURNER TM** GURNER™ **Project Title** 69-73 MURPHY STREET

PORT DOUGLAS

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**Drawing Title** 

DEVELOPMENT SUMMARY -LANDSCAPE


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**Drawing Details** 


Scale 1 : 200@ A1 Date 13/07/22 Job No 9663 Drawn SG ND Checked

**Drawing No** DA50.003



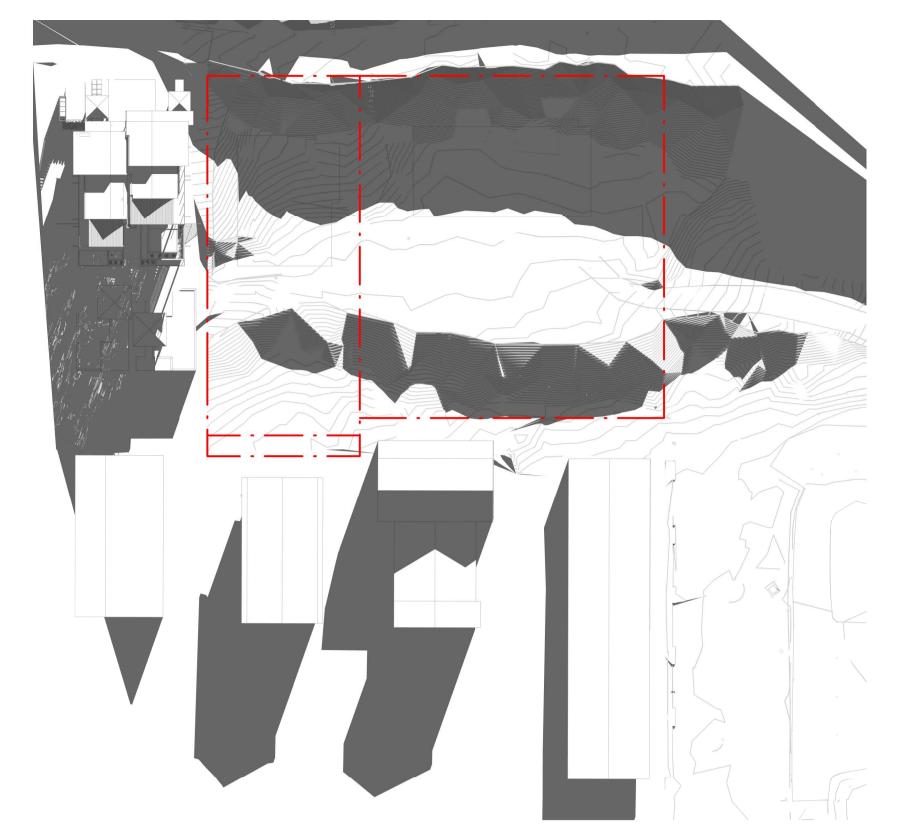


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21 JUNE - 4PM EXISTING

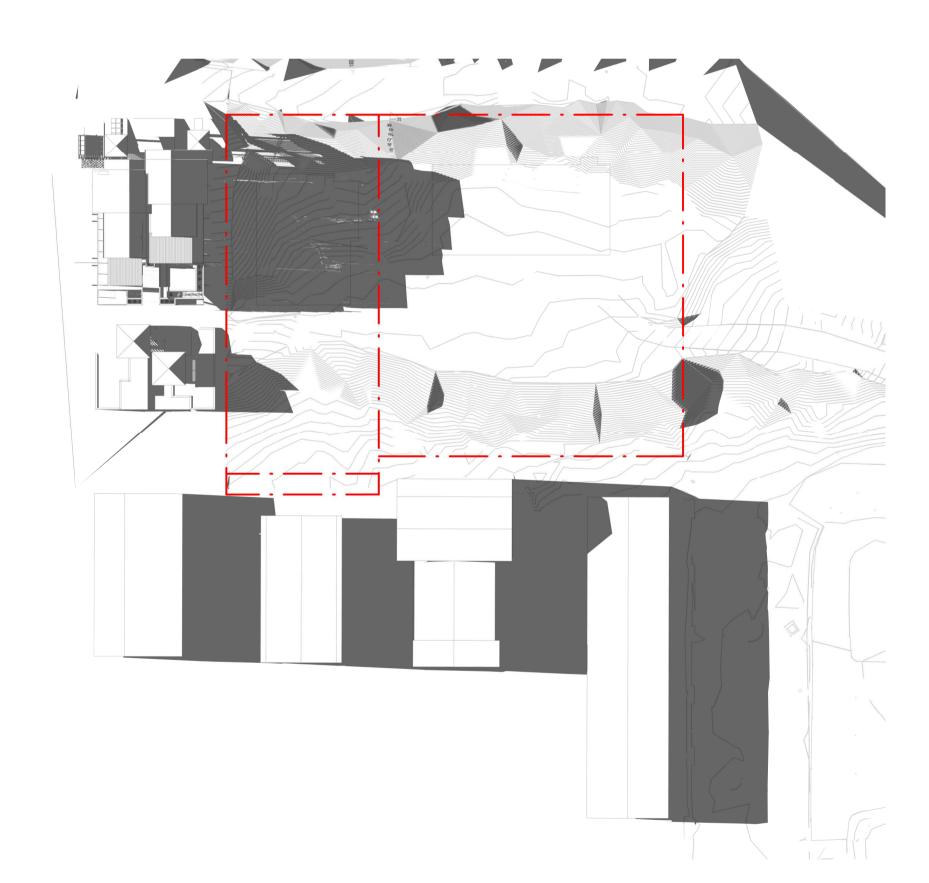

21 JUNE - 9AM PROPOSED 1:500



21 JUNE - 4PM PROPOSED

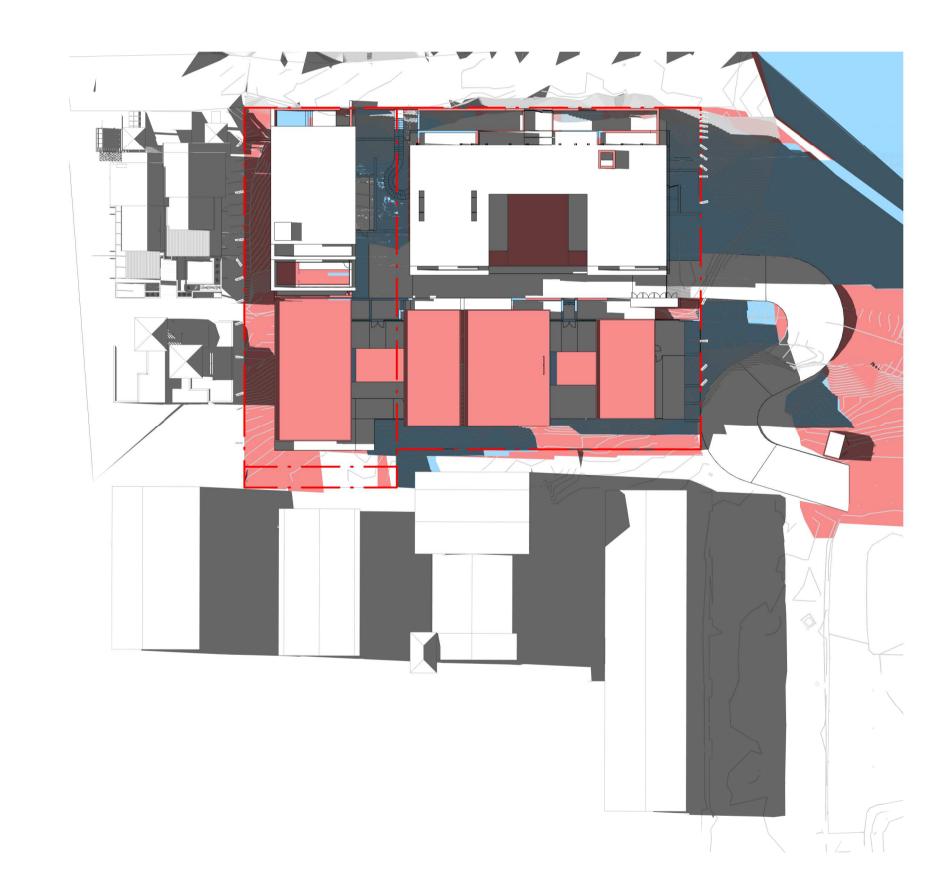1:500

Warren and Mahoney Architects Australia Pty Ltd


1:500

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A 15/09/21 FOR INFORMATION B 22/09/21 DRAFT DA C04/10/21 ISSUE FOR DA D18/02/22 FOR INFORMATION E 10/03/22 ISSUE RFI 01 F 13/07/22 ISSUE RFI 02

PROJECT NORTH



Project Manager Structural Engineer Mechanical Engineer

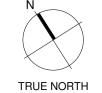Fire Engineer

Electrical Engineer
Ordinary Council Meeting - 30 August 2022

Consultants

**GURNER TM** GURNER™

Client

Project Title

69-73 MURPHY STREET PORT DOUGLAS

EXTENT OF PROPOSED SCHEME - SHADOW DENOTED IN BLUE

EXTENT OF HOTEL SCHEME - SHADOW DENOTED IN RED

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**Drawing Title** 

SOLAR ANALYSIS -JUNE 21

**Drawing Status** DEVELOPMENT APPLICATION

**Drawing Details** Scale Date

> Job No Drawn Checked **Drawing No** Revision

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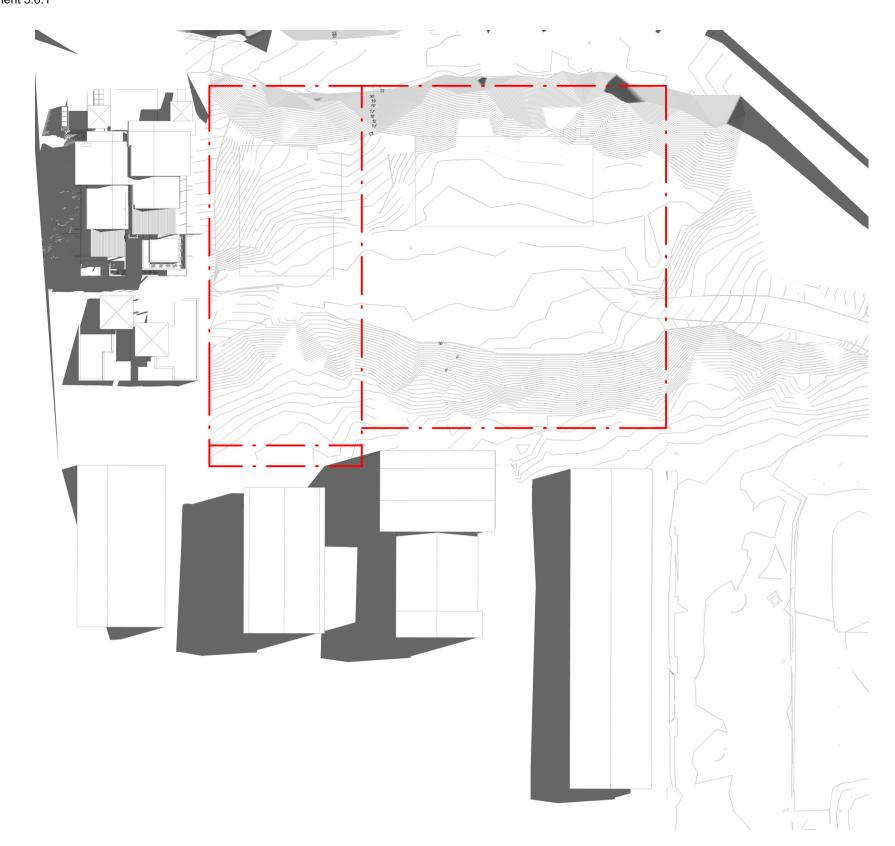
13/07/22

9663

SG


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DA80.001




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1 : 500



21 DEC - 4PM EXISTING

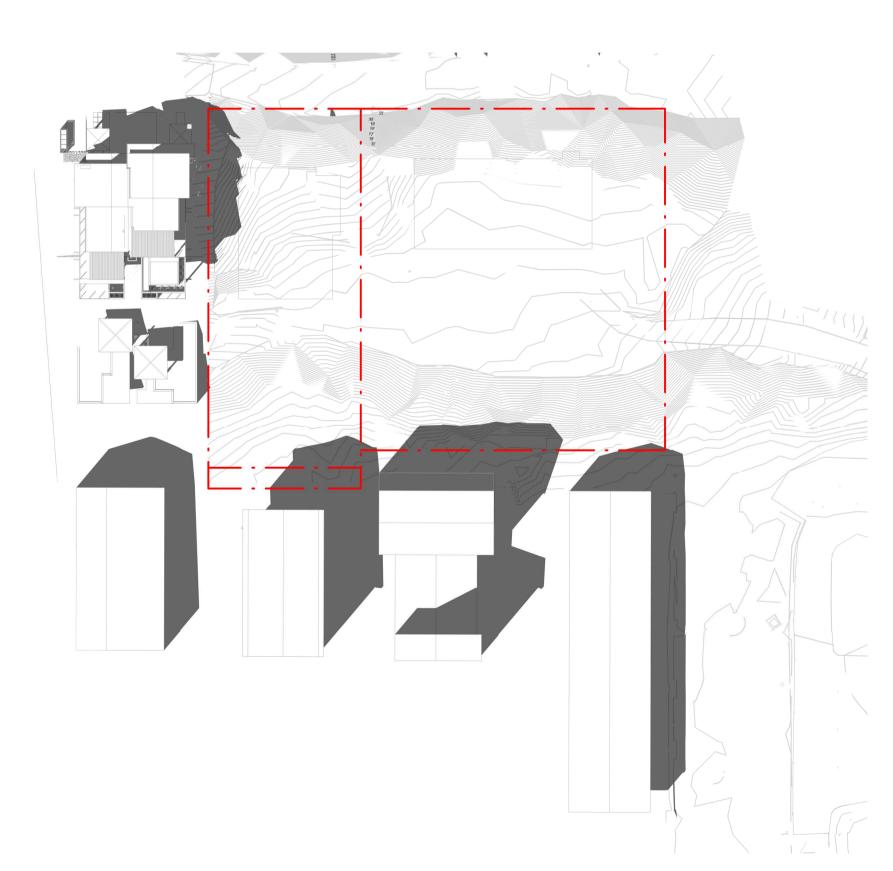1 : 500

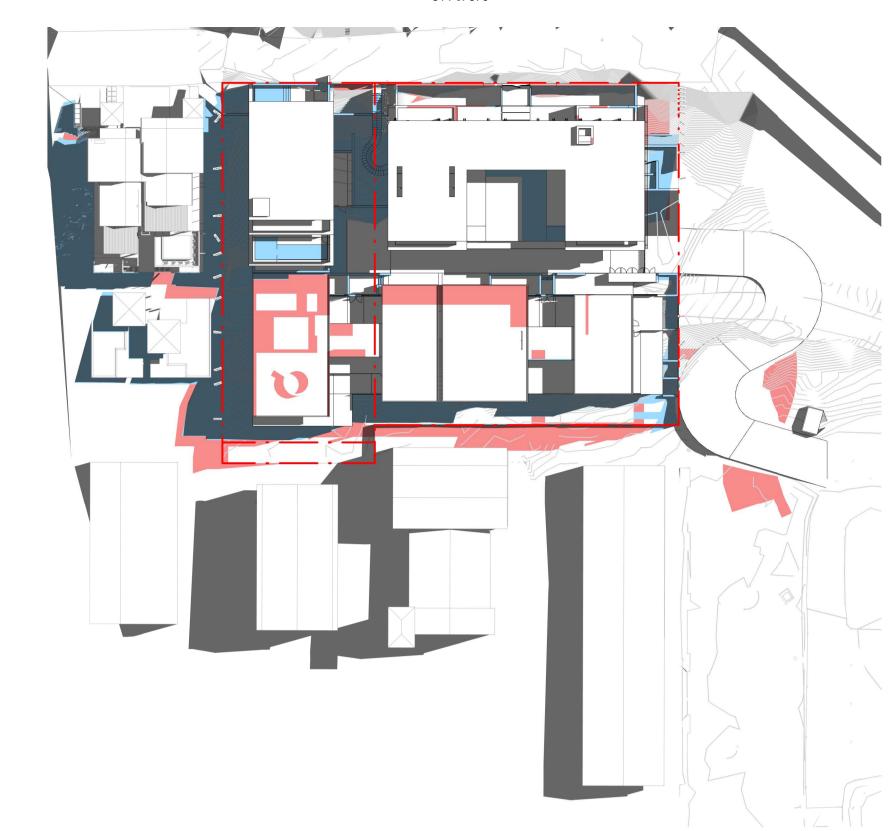

21 DEC - 9AM PROPOSED

1:500



21 DEC - 4PM PROPOSED

1 : 500

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Revisions
—

A 15/09/21 FOR INFORMATION
B 22/09/21 DRAFT DA
C 04/10/21 ISSUE FOR DA
D 18/02/22 FOR INFORMATION
E 10/03/22 ISSUE RFI 01
F 13/07/22 ISSUE RFI 02

Consultants
—
Project Manager
Structural Enginee

Structural Engineer

Mechanical Engineer

Fire Engineer

Electrical Engineer Ordinary Council Meeting - 30 August 2022 GURNER TM

**GURNER**<sup>TM</sup>

Project Title
69-73 MURPHY
STREET

PORT DOUGLAS

EXTENT OF PROPOSED SCHEME - SHADOW DENOTED IN BLUE

EXTENT OF HOTEL SCHEME - SHADOW DENOTED IN RED

All dimension to be verified on site before producing shop drawings or commencing any work.

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Drawing Title
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SOLAR ANALYSIS -DECEMBER 21

Drawing Status
DEVELOPMENT
APPLICATION

Drawing Details
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 Scale
 1:500@ A1

 Date
 13/07/22

 Job No
 9663

 Drawn
 SG


 Checked
 ND

Drawing No
—
DA80.002

Revision F

Attachment 5.6.1 815 of 876

## MATERIAL FINISHES PALETTE

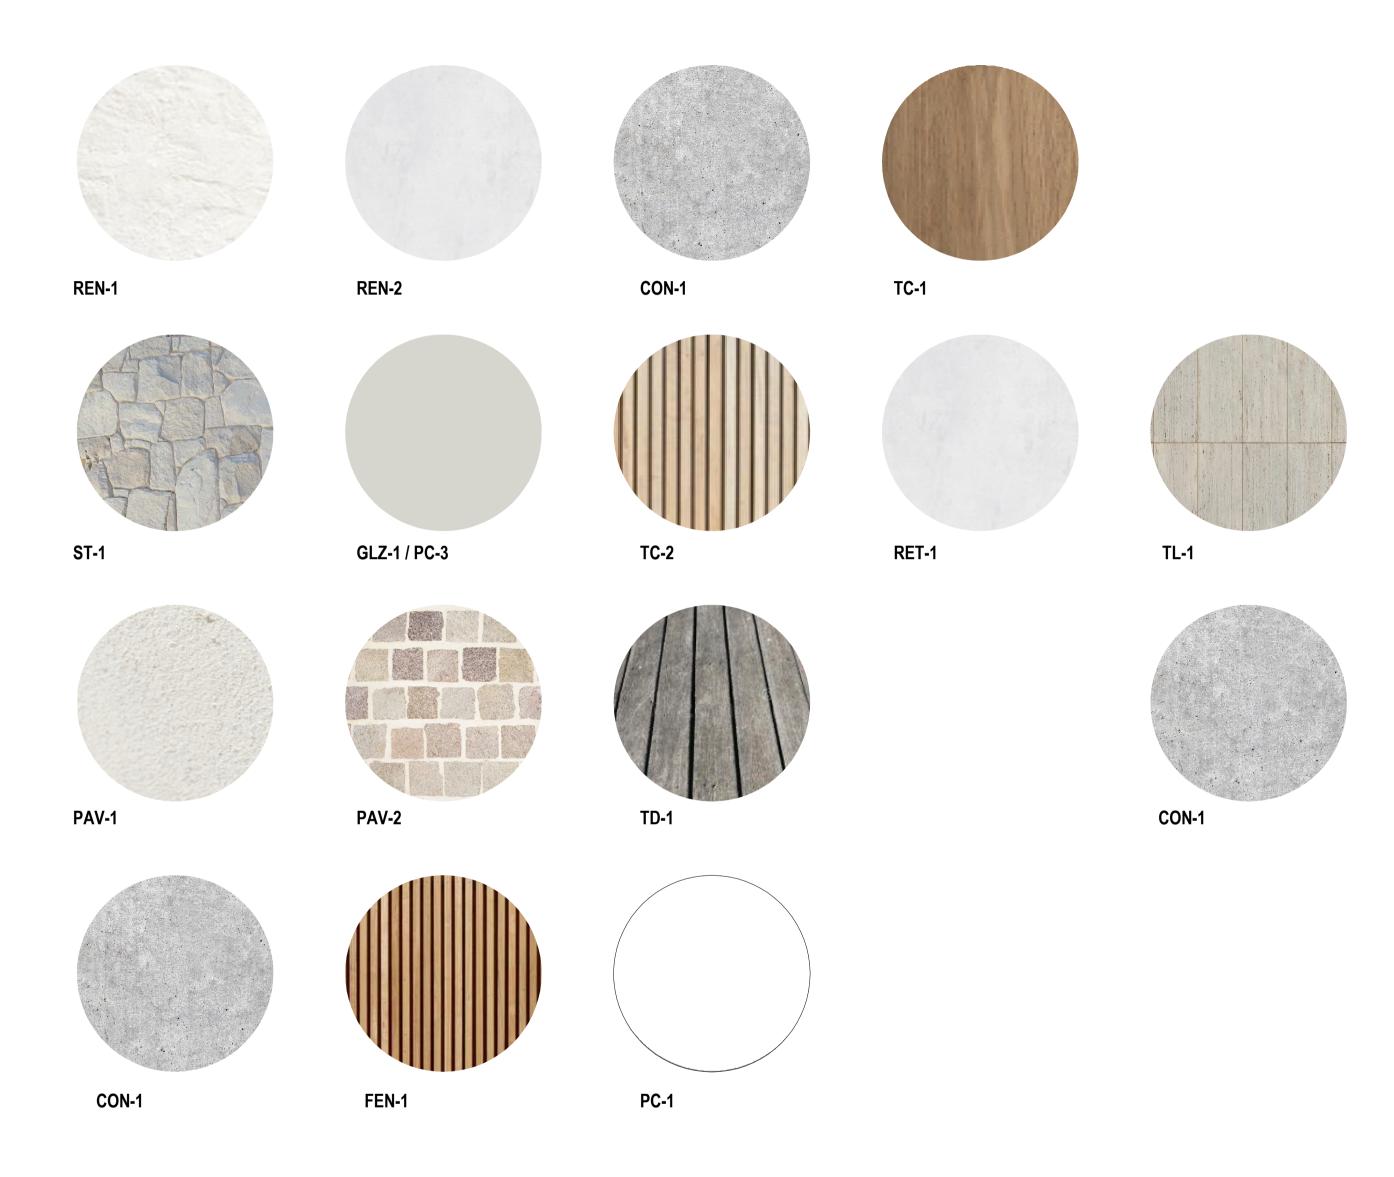

All dimension to be verified on site before producing shop drawings or commencing any work.

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#### Revisions

A 15/09/21 FOR INFORMATION B 22/09/21 DRAFT DA C 04/10/21 ISSUE FOR DA D 13/07/22 ISSUE RFI 02

CODE	DESCRIPTION
BAL-1	FRAMELESS GLAZED BALUSTRADE
	1200mm
CON-1	IN-SITU CONCRETE
FEN-1	TIMBER FENCING
GLZ-1/PC-3	CLEAR GLAZING / LIGHT GREY OR SIMILAR
PAV-1	TILED PAVING
PAV-2	COBBLED STONE PAVING OR STAMPED
	CONCRETE OR SIMILAR
REN-1	TEXTURED RENDER FINISH
ST-1	STACKED STONE WALL
TC-1	TIMBER CLADDING OR FC SHEET, OR
	SIMILAR

Consultants

Project Manager

Mechanical Engineer

Structural Engineer

Fire Engineer

Electrical Engineer

Client

**GURNER TM** 

GURNER™

Warren and Mahoney Architects Australia Pty Ltd

Level 4, 141 Flinders Lane Melbourne VIC 3000 Australia Phone + 61 3 8547 6977

Registered Architects and Designers www.warrenandmahoney.com Project Title
—

69-73 MURPHY STREET PORT DOUGLAS

Drawing Title
—

MATERIALS

**Drawing Status** DEVELOPMENT APPLICATION Drawing Details
—

Scale	1 : 1@ A1
Date	13/07/22
Job No	9663
Drawn	SG
Checked	ND

**Drawing No** 


DA90.001



Revision

 $\bigcirc$ 

816 of 876 Attachment 5.6.1

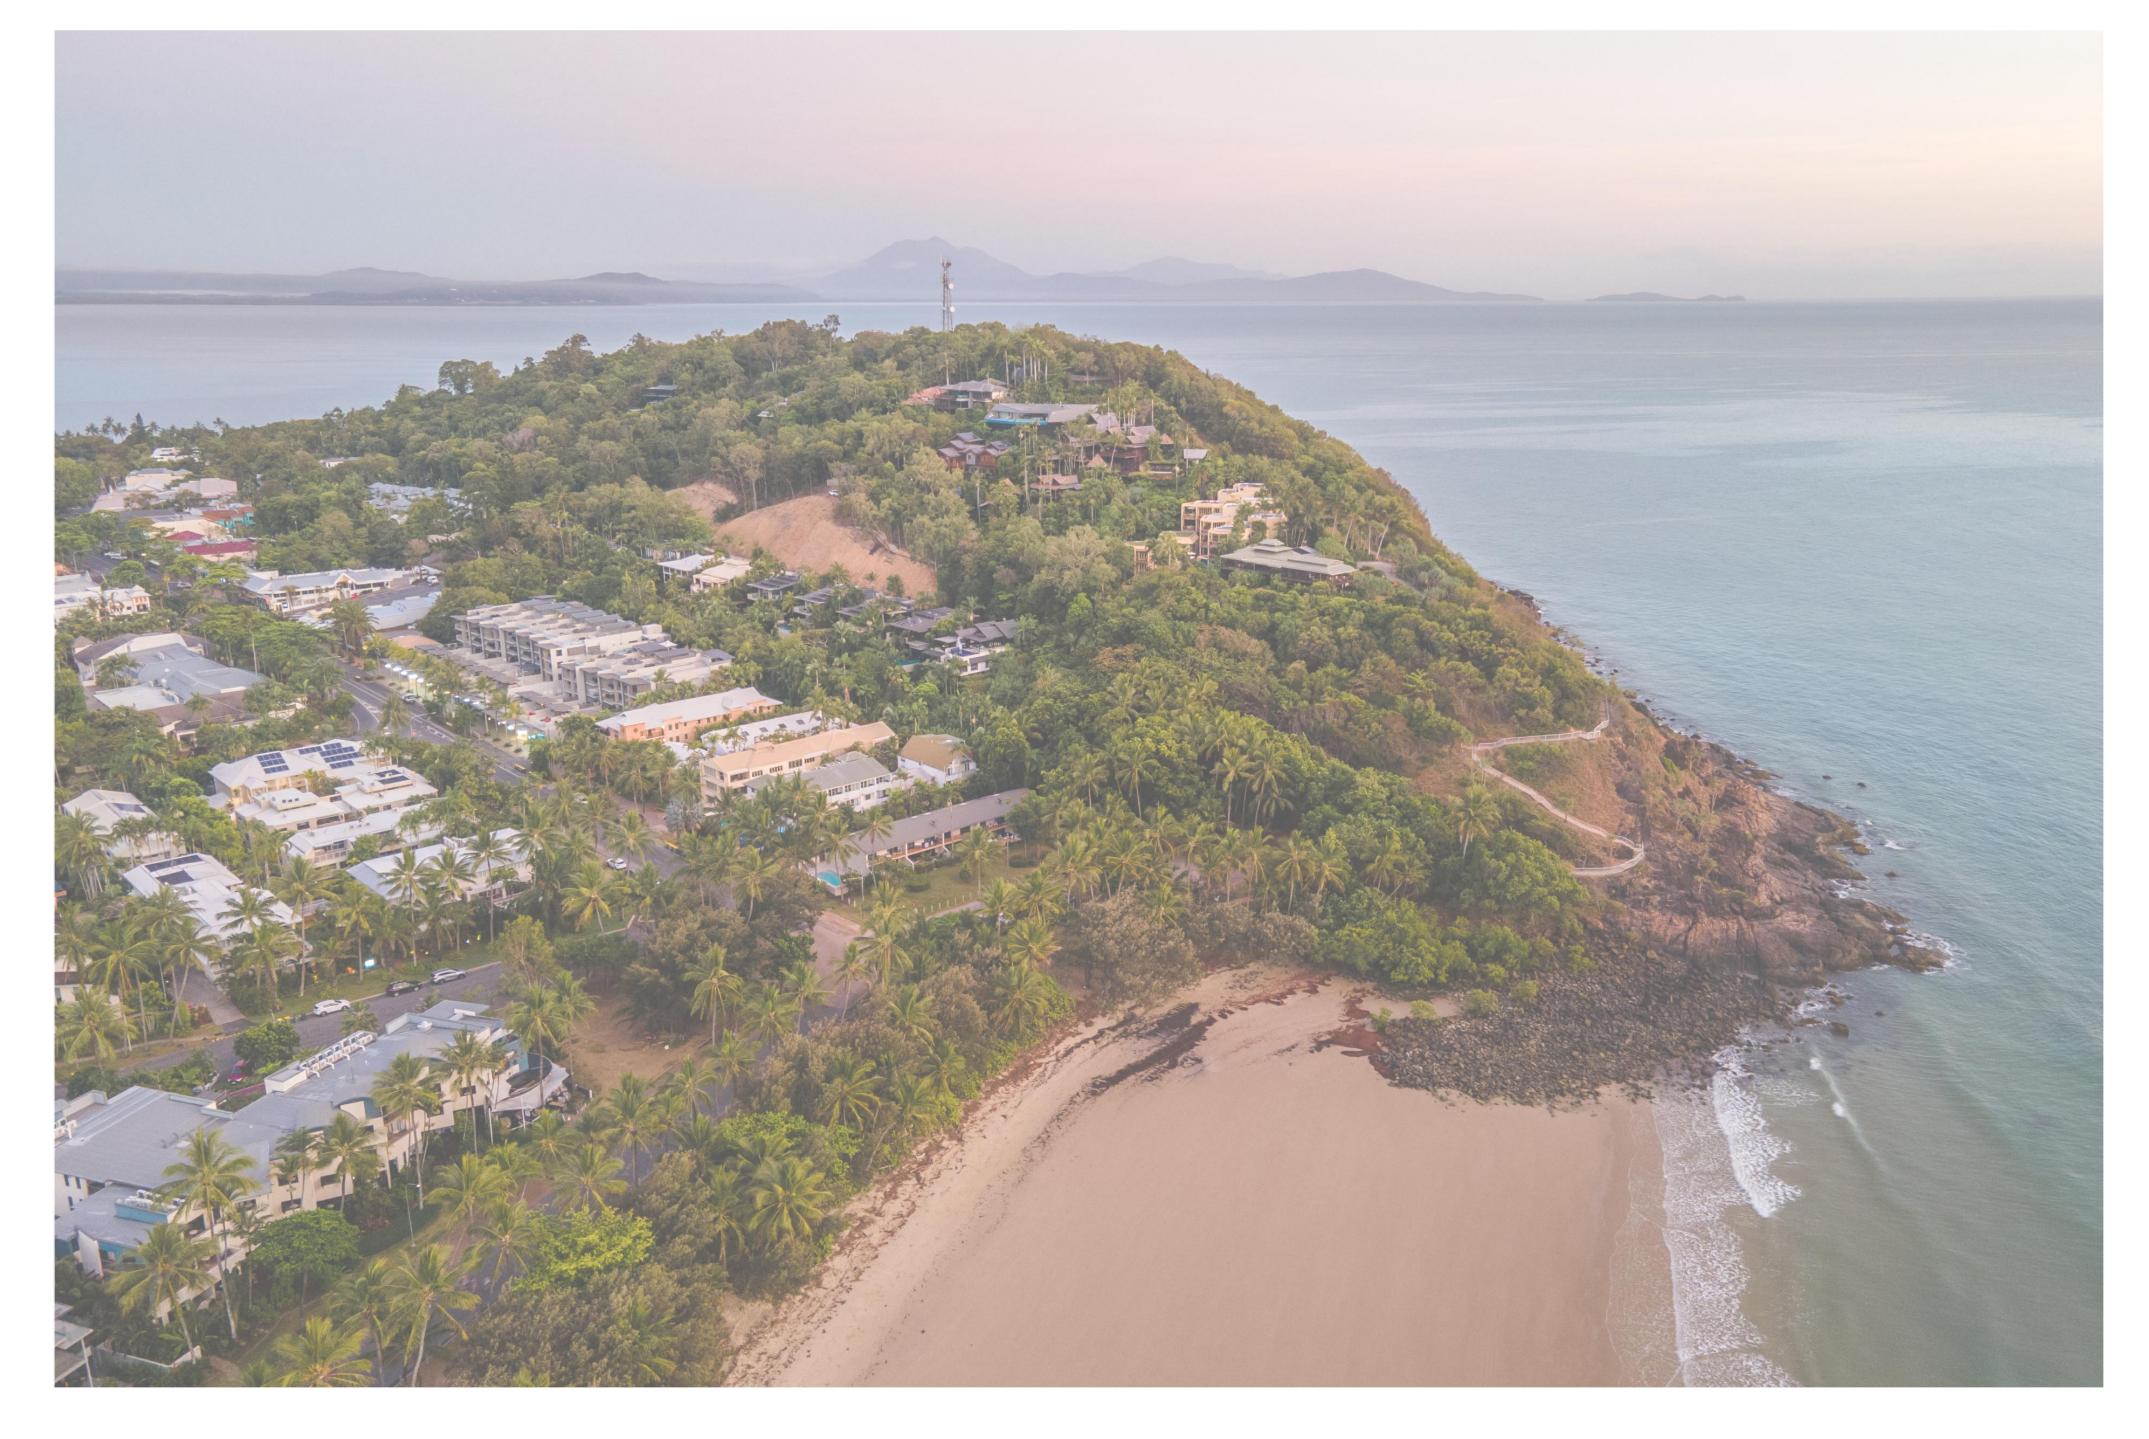

# 69 - 73 MURPHY STREET PORT DOUGLAS

## DRAWING SCHEDULE

511\_DA\_01 **COVER PAGE** PLANTING SCHEDULE 511\_DA\_02 PLANTING SCHEDULE 511\_DA\_03 TREE RETENTION & REMOVAL PLAN

511\_DA\_04

511\_DA\_11 LANDSCAPE PLAN - GROUND LEVEL & GREEN ROOF

LANDSCAPE PLAN - ENTRY ROAD & WESTERN BOUNDARY

511\_DA\_12 LANDSCAPE PLAN - LEVEL 1 511\_DA\_13 LANDSCAPE PLAN - LEVEL 2

511\_DA\_14 LANDSCAPE PLAN - LEVEL 3

511\_DA\_35 TYPICAL DETAILS

511\_DA\_10

511\_DA\_50 GENERAL SPECIFICATION

## GENERAL NOTES

- · ALL LANDSCAPE DRAWINGS ARE TO BE READ IN CONJUNCTION WITH THE ARCHITECT'S AND ADDITIONAL CONSULTANT'S DRAWINGS, SPECIFICATIONS AND REPORTS
- ALL PUBLIC UTILITY SERVICES ARE TO BE LOCATED ON SITE BY THE CONTRACTOR PRIOR TO THE COMMENCEMENT OF WORKS. THE LOCATION, PRESENCE AND EXTENT OF SERVICES SHOWN ARE NOT GUARANTEED COMPLETE OR CORRECT
- PERFORM EXCAVATION IN THE VICINITY OF UNDERGROUND UTILITIES WITH CARE AND IF NECESSARY, BY HAND. THE CONTRACTOR BEARS FULL RESPONSIBILITY FOR THIS WORK AND DISRUPTION OR DAMAGE TO UTILITIES SHALL BE REPAIRED IMMEDIATELY AT NO EXPENSE TO THE OWNER
- NO TREES PROTECTED UNDER THE LOCAL COUNCIL'S TREE PRESERVATION ORDER ARE TO BE REMOVED UNLESS APPROVED BY DEVELOPMENT CONSENT OR PERMIT OBTAINED FROM COUNCIL
- ALL PAVING IS INDICATIVE, TO BE TO FUTURE SPECIFICATION, AND SET OUT ON SITE
- ALL WORK TO BE CARRIED OUT IN ACCORDANCE WITH THE LOCAL COUNCIL'S APPROVAL, STANDARDS AND
- THE CONTRACTOR IS TO ENSURE THAT ALL THE WORKS ARE CARRIED OUT IN ACCORDANCE WITH THE WORK HEALTH AND SAFETY ACT
- MBD TO REVIEW PLANT MATERIALS AT SOURCE OR BY PHOTOGRAPHS PRIOR TO PURCHASE AND DELIVERY
- EXACT LOCATIONS OF NEW PLANT MATERIAL TO BE SETOUT AND APPROVED BY THE MBD ONSITE PRIOR TO INSTALLATION. MBD RESERVES THE RIGHT TO ADJUST PLANTS TO EXACT LOCATION ONSITE

## DRAINAGE AND IRRIGATION NOTES

- REFER TO CIVIL ENGINEER'S UTILITY AND DRAINAGE PLANS FOR UTILITY LOCATION AND DRAINAGE INFORMATION.
- REQUIREMENTS FOR LANDSCAPE DRAINAGE TO BE CONFIRMED ONSITE UNLESS OTHERWISE SHOWN ON THE LANDSCAPE PLANS
- TREE PITS THAT HAVE BEEN EXCAVATED INTO HEAVY EARTH OR STONE TO CONTAIN A RING OF AG PIPE LAID AT THE INVERT OF THE PIT WITHIN A MINIMUM 200mm LAYER OF FREE DRAINING MATERIAL. AG PIPE TO BE CONNECTED TO A DRAINAGE OUTLET (REFER TO TYPICAL TREE PIT DRAINAGE SECTION)
- · ALL POTS TO HAVE AN IRRIGATION ALLOWANCE (SHRUBBLERS OR DRIP)
- FOR POTS LOCATED ON PAVED SURFACES, TYPICAL PAVING IRRIGATION DETAIL TO BE USED AS SHOWN POTS ADJACENT TO GARDEN BEDS TO BE IRRIGATED VIA IN GARDEN IRRIGATION SYSTEM
- ALL LAWN AREAS TO HAVE POPUP ROTORS
- ALL GARDEN BEDS TO HAVE FIXED SOLID RISERS WITH SPRAYS

GURNER

DRAWING:


Attachment 5.6.1


## PLANT SCHEDULE

TDEEC												
CODE	BOTANIC NAME	COMMON NAME	ZONE 1	ZONE 2	ZONE 3	ZONE 4	ZONE 5	ZONE 6	ZONE 7	TOTAL	POT SIZE	MATURE HEIGHT
CA	Cupaniopsis anacardioides	Tuckeroo	4	8	ZONEO	ZOIL 4	ZOILE 3	ZONEO	ZONE /	12	Mature	12m
CI	Calophyllum inophyllum	Beach calophylum	3	4				2		9	Mature	12m
CN	Cocos nucifera	Coconut Palm	11	9	22			15		57	Mature	6-10m
FI	Ficus lyrata	Fiddle Leaf Fig				•	•	•	•		400mm	3m
GF	Glochidion ferdinandi	Cheese Tree	5	3						8	Mature	8m
LD	Livistona decipens	Ribbon Fan Palm	3	12						15	Mature	6-10m
Lg	Licuala grandis	Ruffled Fan Palm			•			•			400mm	2-3m
PS	Plumeria species	Frangipani	1					2		3	300L	6m
RF	Randia fitzalanii	Native Gardinia	3	8						11	300L	3m
SA	Schefflera arboricola	Umbrella Tree	4	3						7	Mature	9m
SP	Schizolobium parahyba	Brazilian Fire Tree			•			•			200L	6-8m
WF	Waterhousea floribunda	Weeping Lilly Pilly	•	•							200L	3-5m
SHRUBS	& PERENNIALS											
CODE	BOTANIC NAME	COMMON NAME	ZONE 1	ZONE 2	ZONE 3	ZONE 4	ZONE 5	ZONE 6	ZONE 7		POT SIZE	MATURE HEIGHT
Am	Alocasia macrorrhiza	Giant Taro	•		•			•			400mm	1.5-2.5m
Ach	Acmena hemilampra	Broad leaved lilly pilly	•	•							300mm	4m
Ac	Alpinia caerulea	Native Ginger	•	•							400mm	3m
Az	Alpinia zerumbet	Shell Ginger	•	•	•			•			200mm	2-3m
Cm	Carissa macrocarpa 'Emerald star'	Natal Plum			•	•	•	•			300mm	0.6m
Fm	Ficus microcarpa 'Green island'	Greenlisland Fig			•	•	•	•	•		300mm	0.6m
МС	Molineria capitulata	Palm Grass	•	•							140mm	0.8m
Md	Monstera deliciosa	Delicious Monster	•	•	•	•		•			400mm	3m
Мр	Murraya paniculata	Orange Jasmine	•	•							400mm	1-3m
	Philodendron 'Xanadu'	Philodendron			•	•		•			300mm	0.8m
Px		Broadlead lady palm	•	•	•			•				
Re	Rhapis excelsa	Broddiedd iddy pairti									300mm	4m
FERNS												
CODE	BOTANIC NAME	COMMON NAME	ZONE 1	ZONE 2	ZONE 3	ZONE 4	ZONE 5	ZONE 6	ZONE 7		POT SIZE	MATURE HEIGHT
Am	Asparagus densiflorus 'Myersii'	Foxtail Asparagus	•	•		•					200mm	0.7m
Aa	Asplenium antiquum	Birdsnest Fern	•	•		•					200mm	1m
Bg	Blechnum gibbum	Silver Lady Fern	•	•		•					200mm	1m
Md	Microsorum diversifolium	Kangaroo Fern	•	•		•					140mm	0.4m
7710	TVIICIOSOTOTTI GIVOISITOIIOTTI										1 10111111	0.1111
GPOUN	IDCOVERS & CLIMBERS											
CODE	BOTANIC NAME	COMMON NAME	ZONE 1	ZONE 2	ZONE 3	ZONE 4	ZONE 5	ZONE 6	ZONE 7		POT SIZE	MATURE HEIGHT
Cf	Chonemorpha fragrans	Frangipani Vine			•						140mm	Climber
Fp	Ficus pumila	Creeping fig	•	•	•			•				Climber
1 0											140mm	Cascading
Нс	Hedera canariensis	The Canarian Ivy		•	•		•	•	•		100mm	Groundcover
Hs	Hibbertia scandens	Guinea flower	•	•							140mm	Groundcover
Rc	Rhaphidophora cryptantha	Shingle Plant		•	•						140mm	Climber
Ve	Tarlmounia elliptica	Curtain creeper				•	•	•	•		140mm	Cascading
Vo	Viola odorata	Native violet	•	•	•	•		•			140mm	Groundcover

## NOTES

- · IF SPECIFIED POT SIZES ARE NOT READILY AVAILABLE, PLEASE CONTACT MBD TO CLARIFY SUBSTITUTE SIZES AND
- CHANGES TO QUANTITIES
- · ALL MATURE TREES TO BE SOURCED AND SUPPLIED BY MYLES BALDWIN DESIGN
- THE PLANT SCHEDULE IS CALCULATED BASED OFF THE LANDSCAPE PLANS PROVIDED BY MBD. ADDITIONAL PLANTS
- OUTSIDE OF THIS SCHEDULE MAY BE REQUIRED TO REACH THE DESIRED PLANT DENSITIES ONSITE
- · ALL PLANT MATERIAL TO BE SETOUT ONSITE BY MYLES BALDWIN DESIGN PRIOR TO INSTALLATION

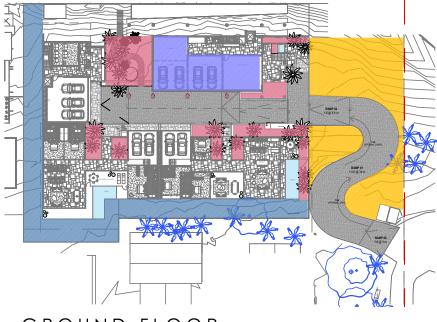

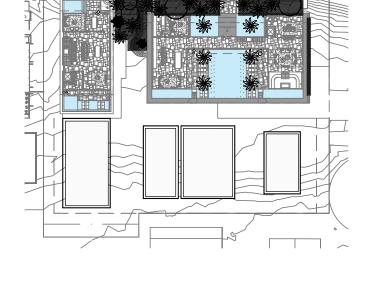




GROUND FLOOR PLANTING KEY PLAN

LVL 2 PLANTING KEY PLAN





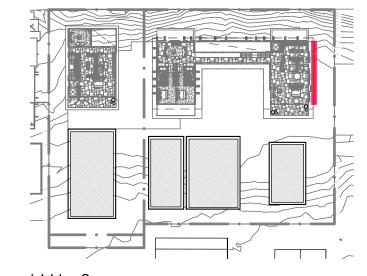


LVL 1 PLANTING KEY PLAN

LVL 3 PLANTING KEY PLAN

## TREES

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Ribbon Fan Palm Livistona decipens



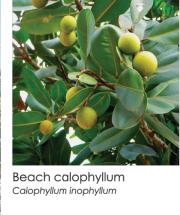



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## SHRUBS, PERENNIALS & FERNS














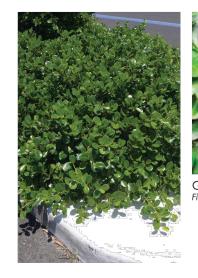









CLIMBERS, HANGING PLANTS






















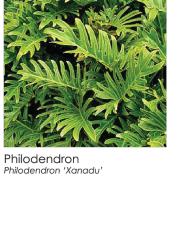
























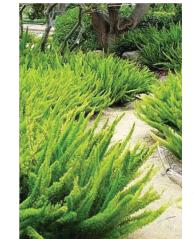

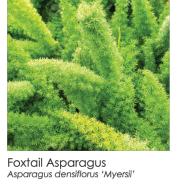

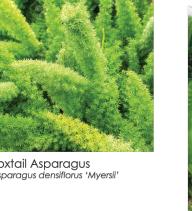































BUILDER TO CHECK AND VERIFY ALL DIMENSIONS ON SITE PRIOR TO CONSTRUCTION.

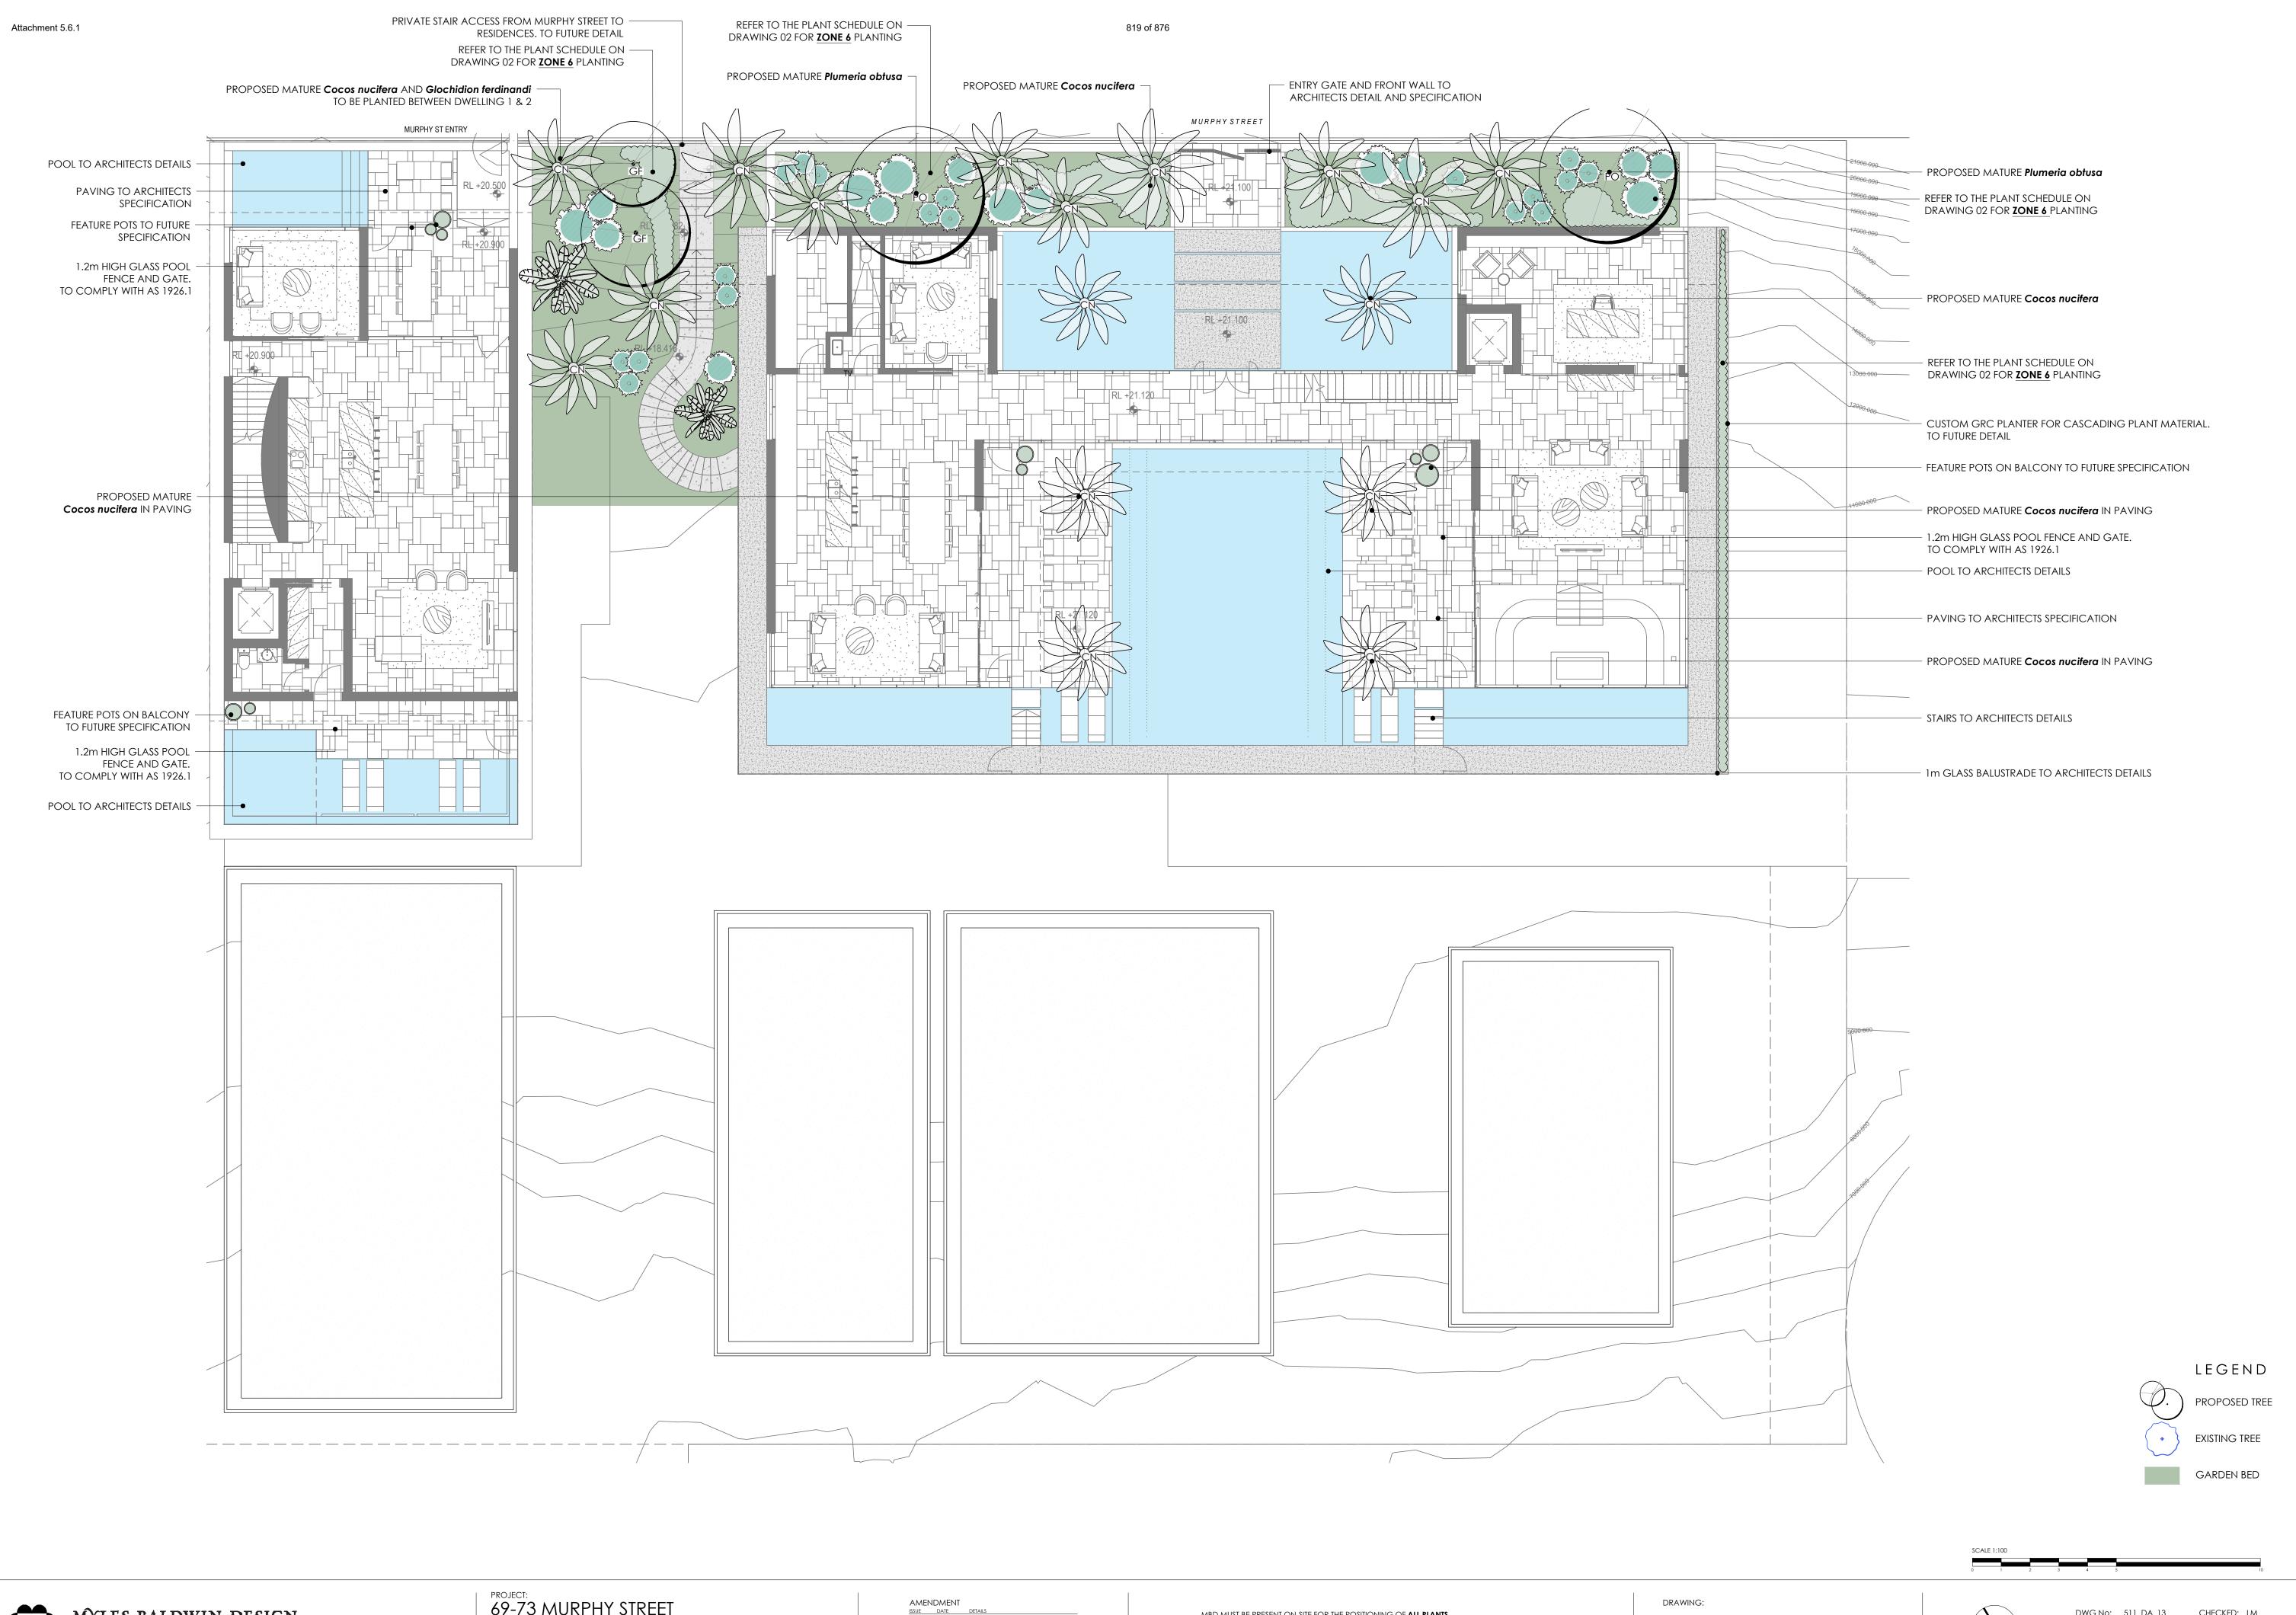




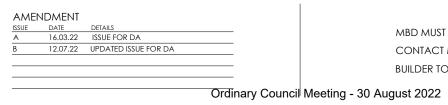






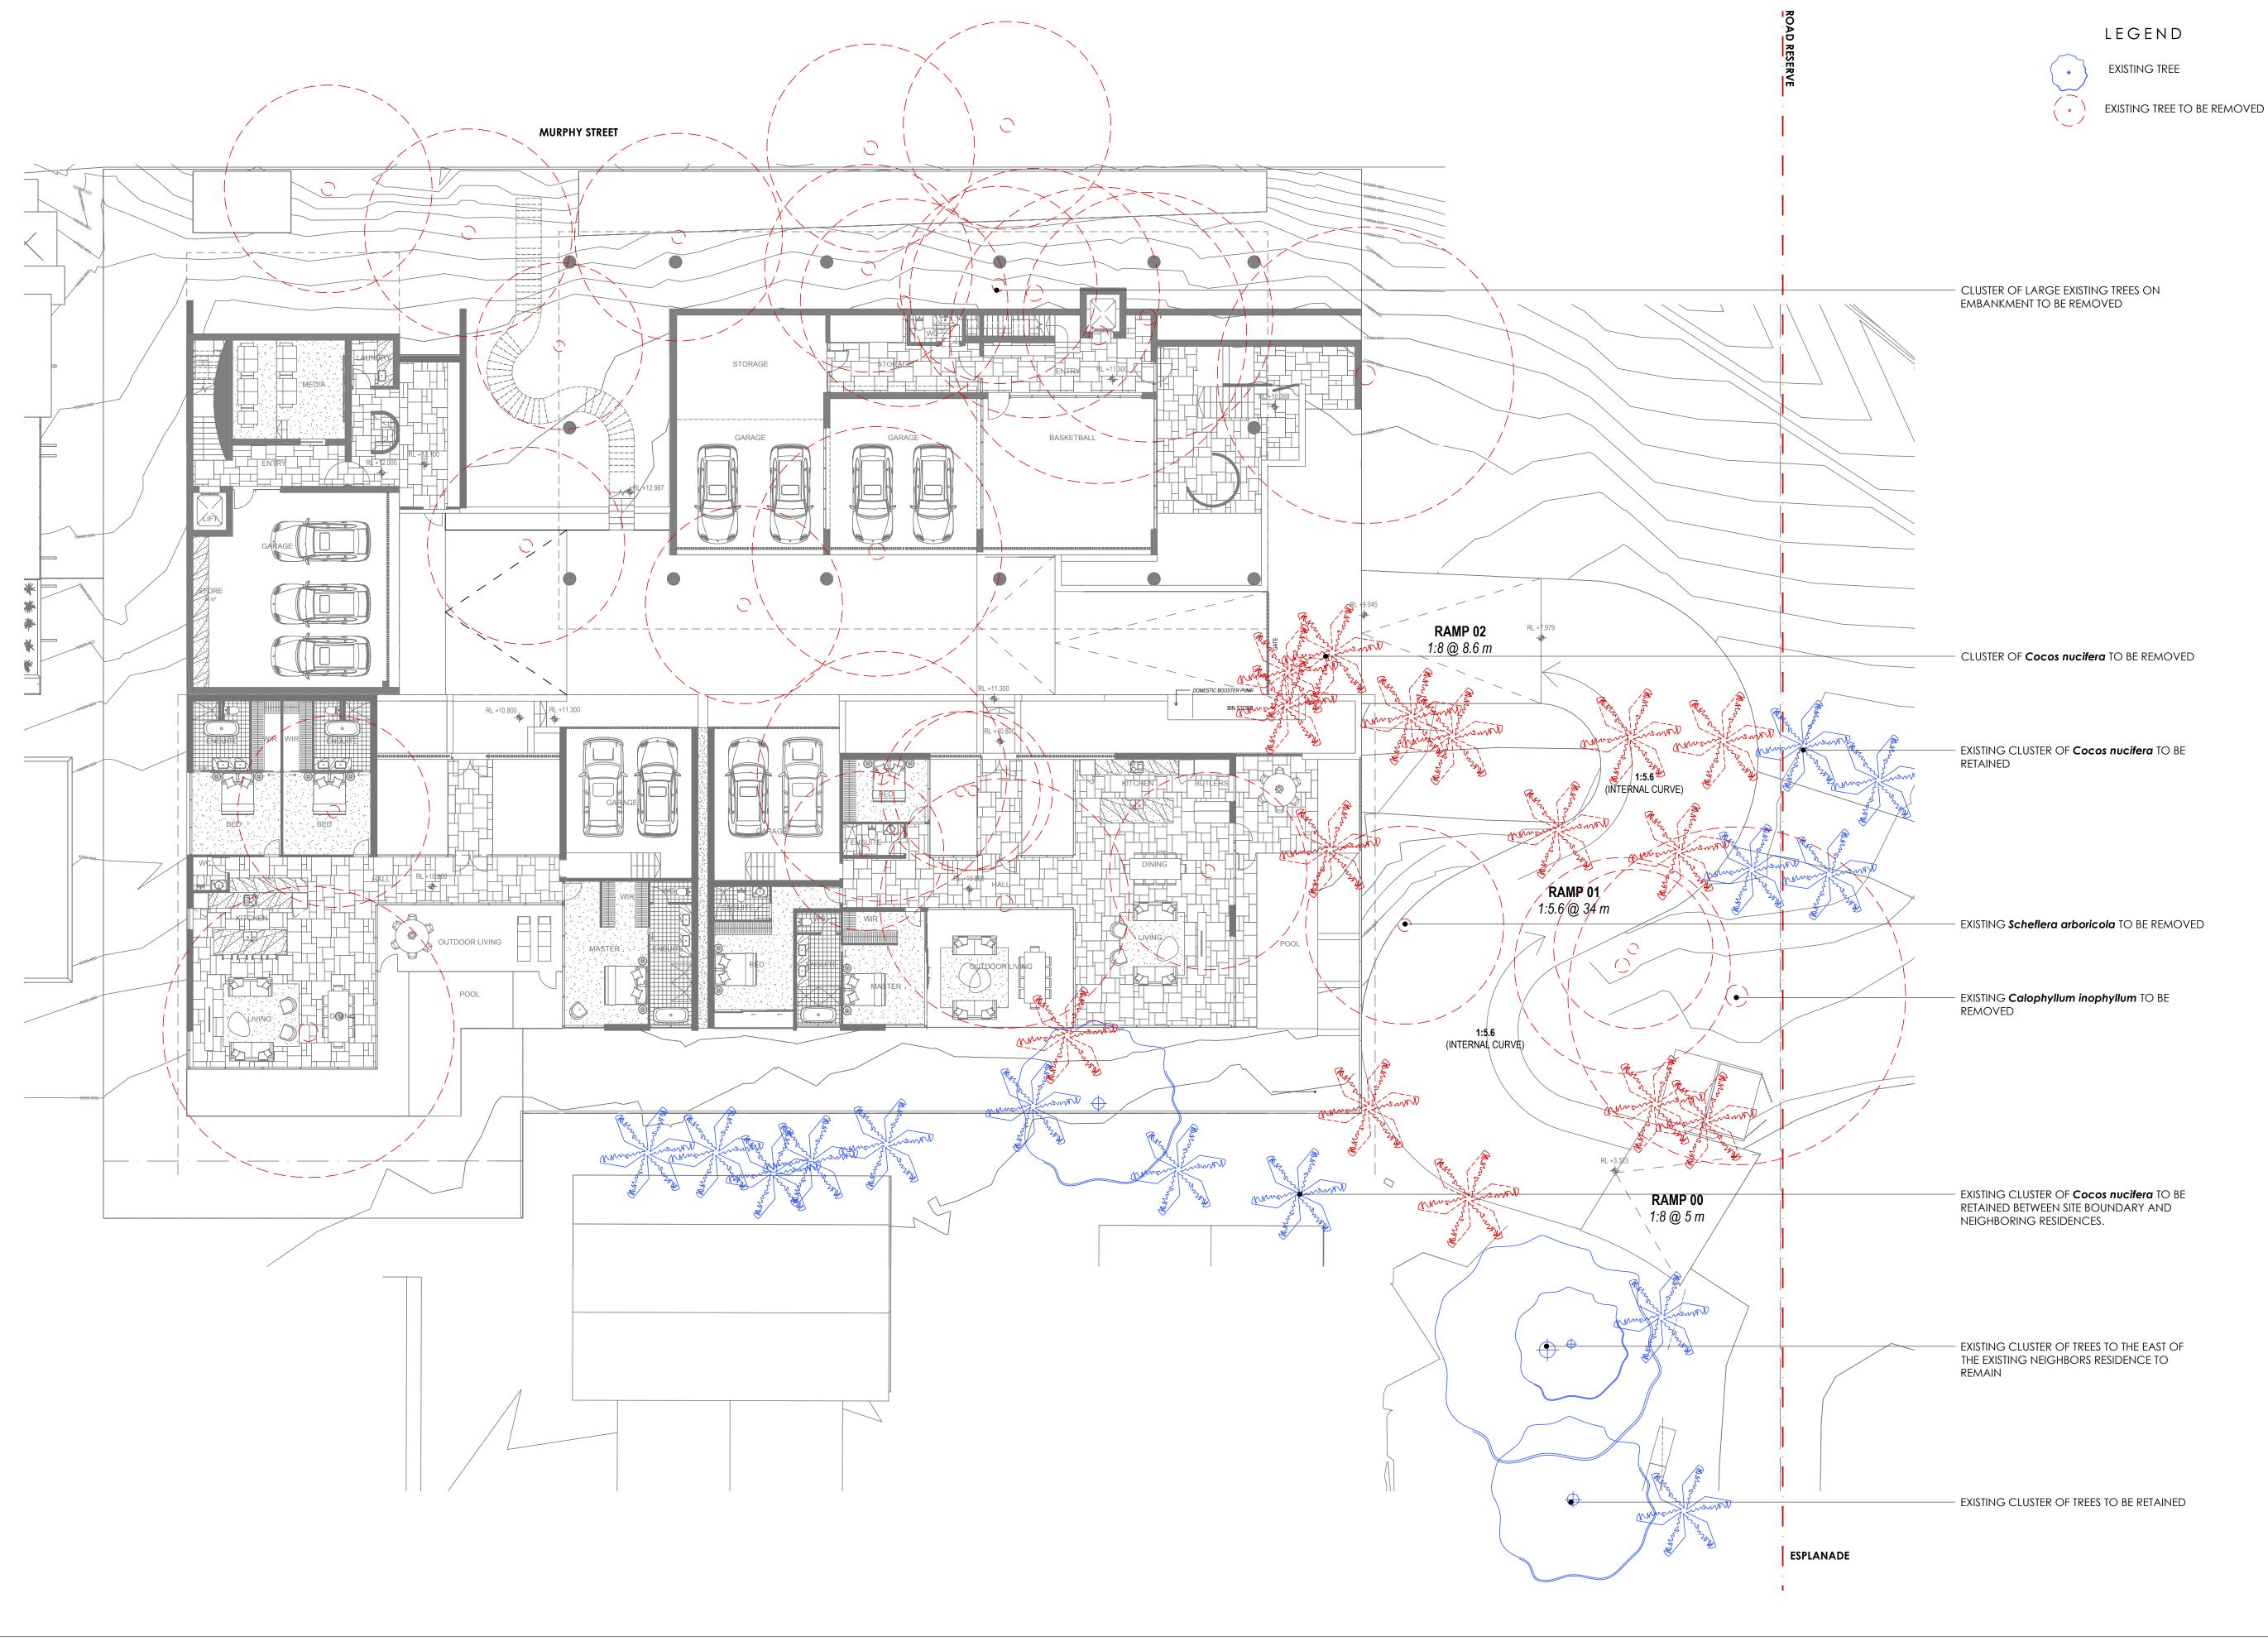



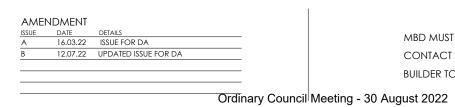

MBD MUST BE PRESENT ON-SITE FOR THE POSITIONING OF <u>ALL PLANTS</u>.

CONTACT MBD IF DISCREPANCIES OCCUR BETWEEN LANDSCAPE AND CONSULTANTS DOCUMENTS.

BUILDER TO CHECK AND VERIFY ALL DIMENSIONS ON SITE PRIOR TO CONSTRUCTION.

TREE RETENTION & REMOVAL



DWG No: 511\_DA\_04

SCALE: 1:150 @ A1

DRAWN: RM

CHECKED: LM


ISSUE: B

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Attachment 5.6.1 821 of 876








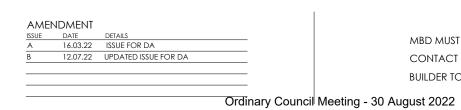

LANDSCAPE PLAN - LVL 1 & GARAGE MEZZANINE

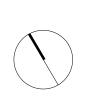

DWG No: 511\_DA\_12

SCALE: AS NOTED


DRAWN: RM

CHECKED: LM

ISSUE: B

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822 of 876 Attachment 5.6.1



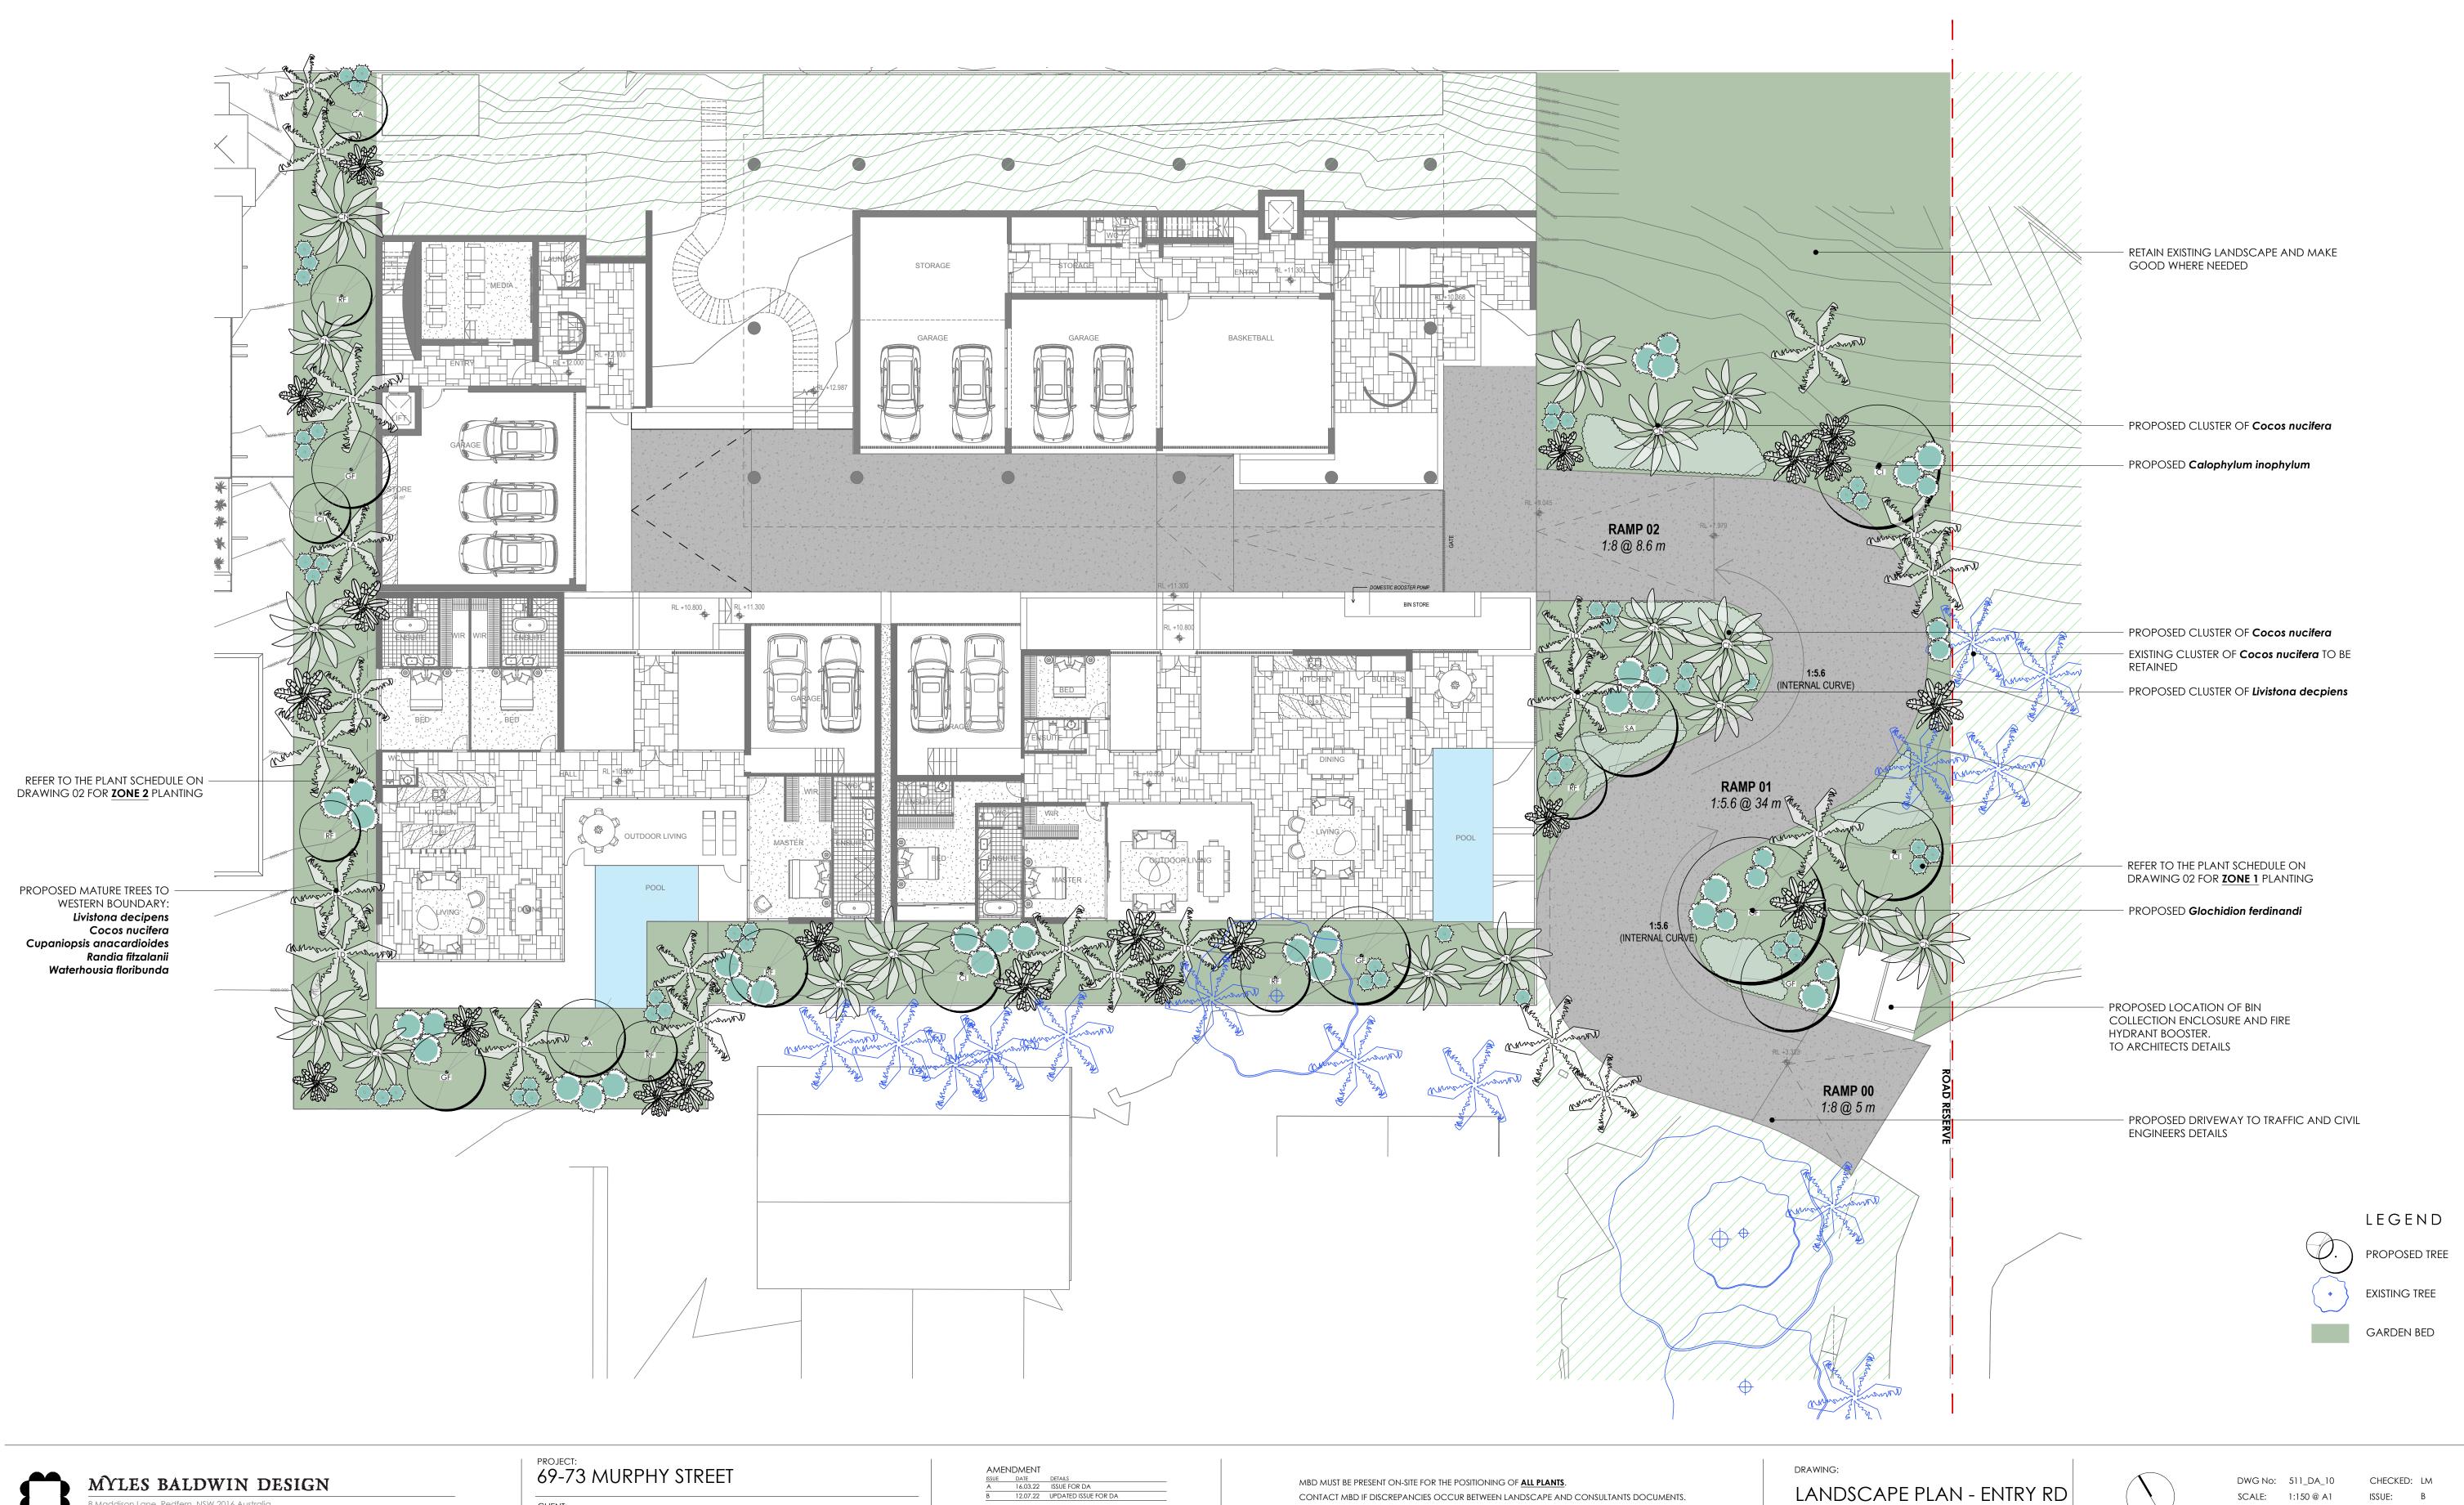

BUILDER TO CHECK AND VERIFY ALL DIMENSIONS ON SITE PRIOR TO CONSTRUCTION.


AND WESTERN BOUNDARY




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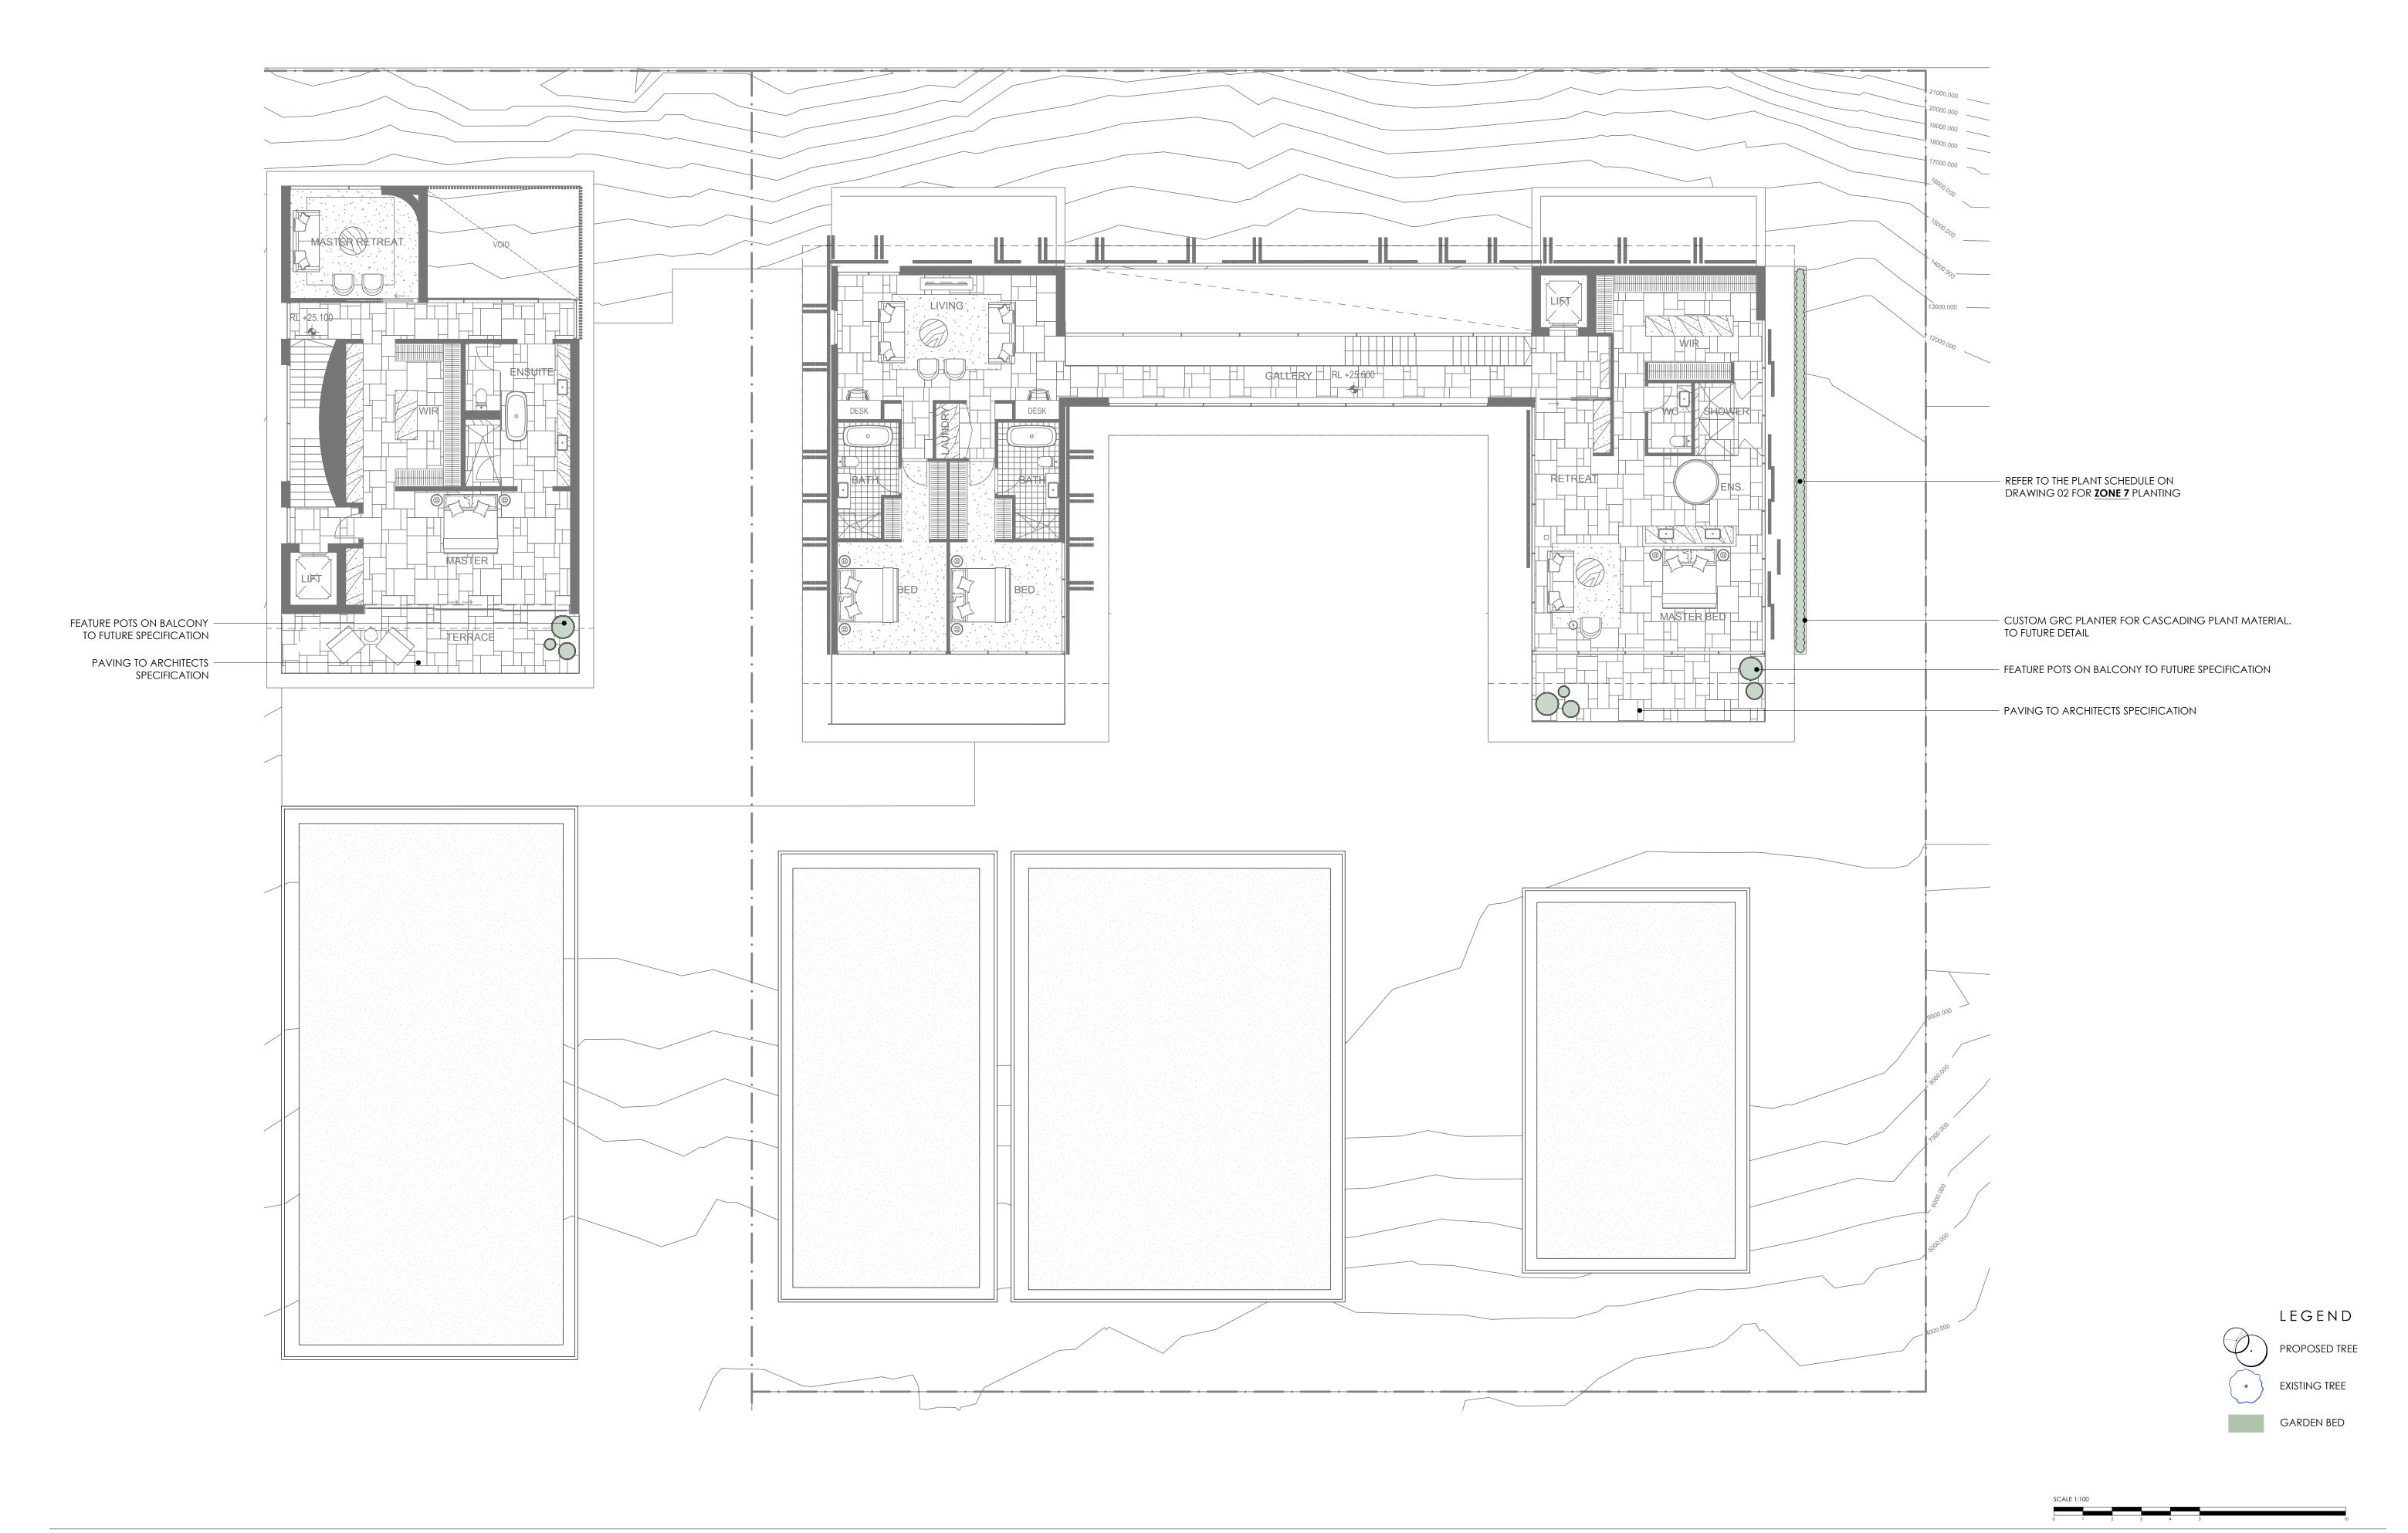





LANDSCAPE PLAN -GROUND LEVEL

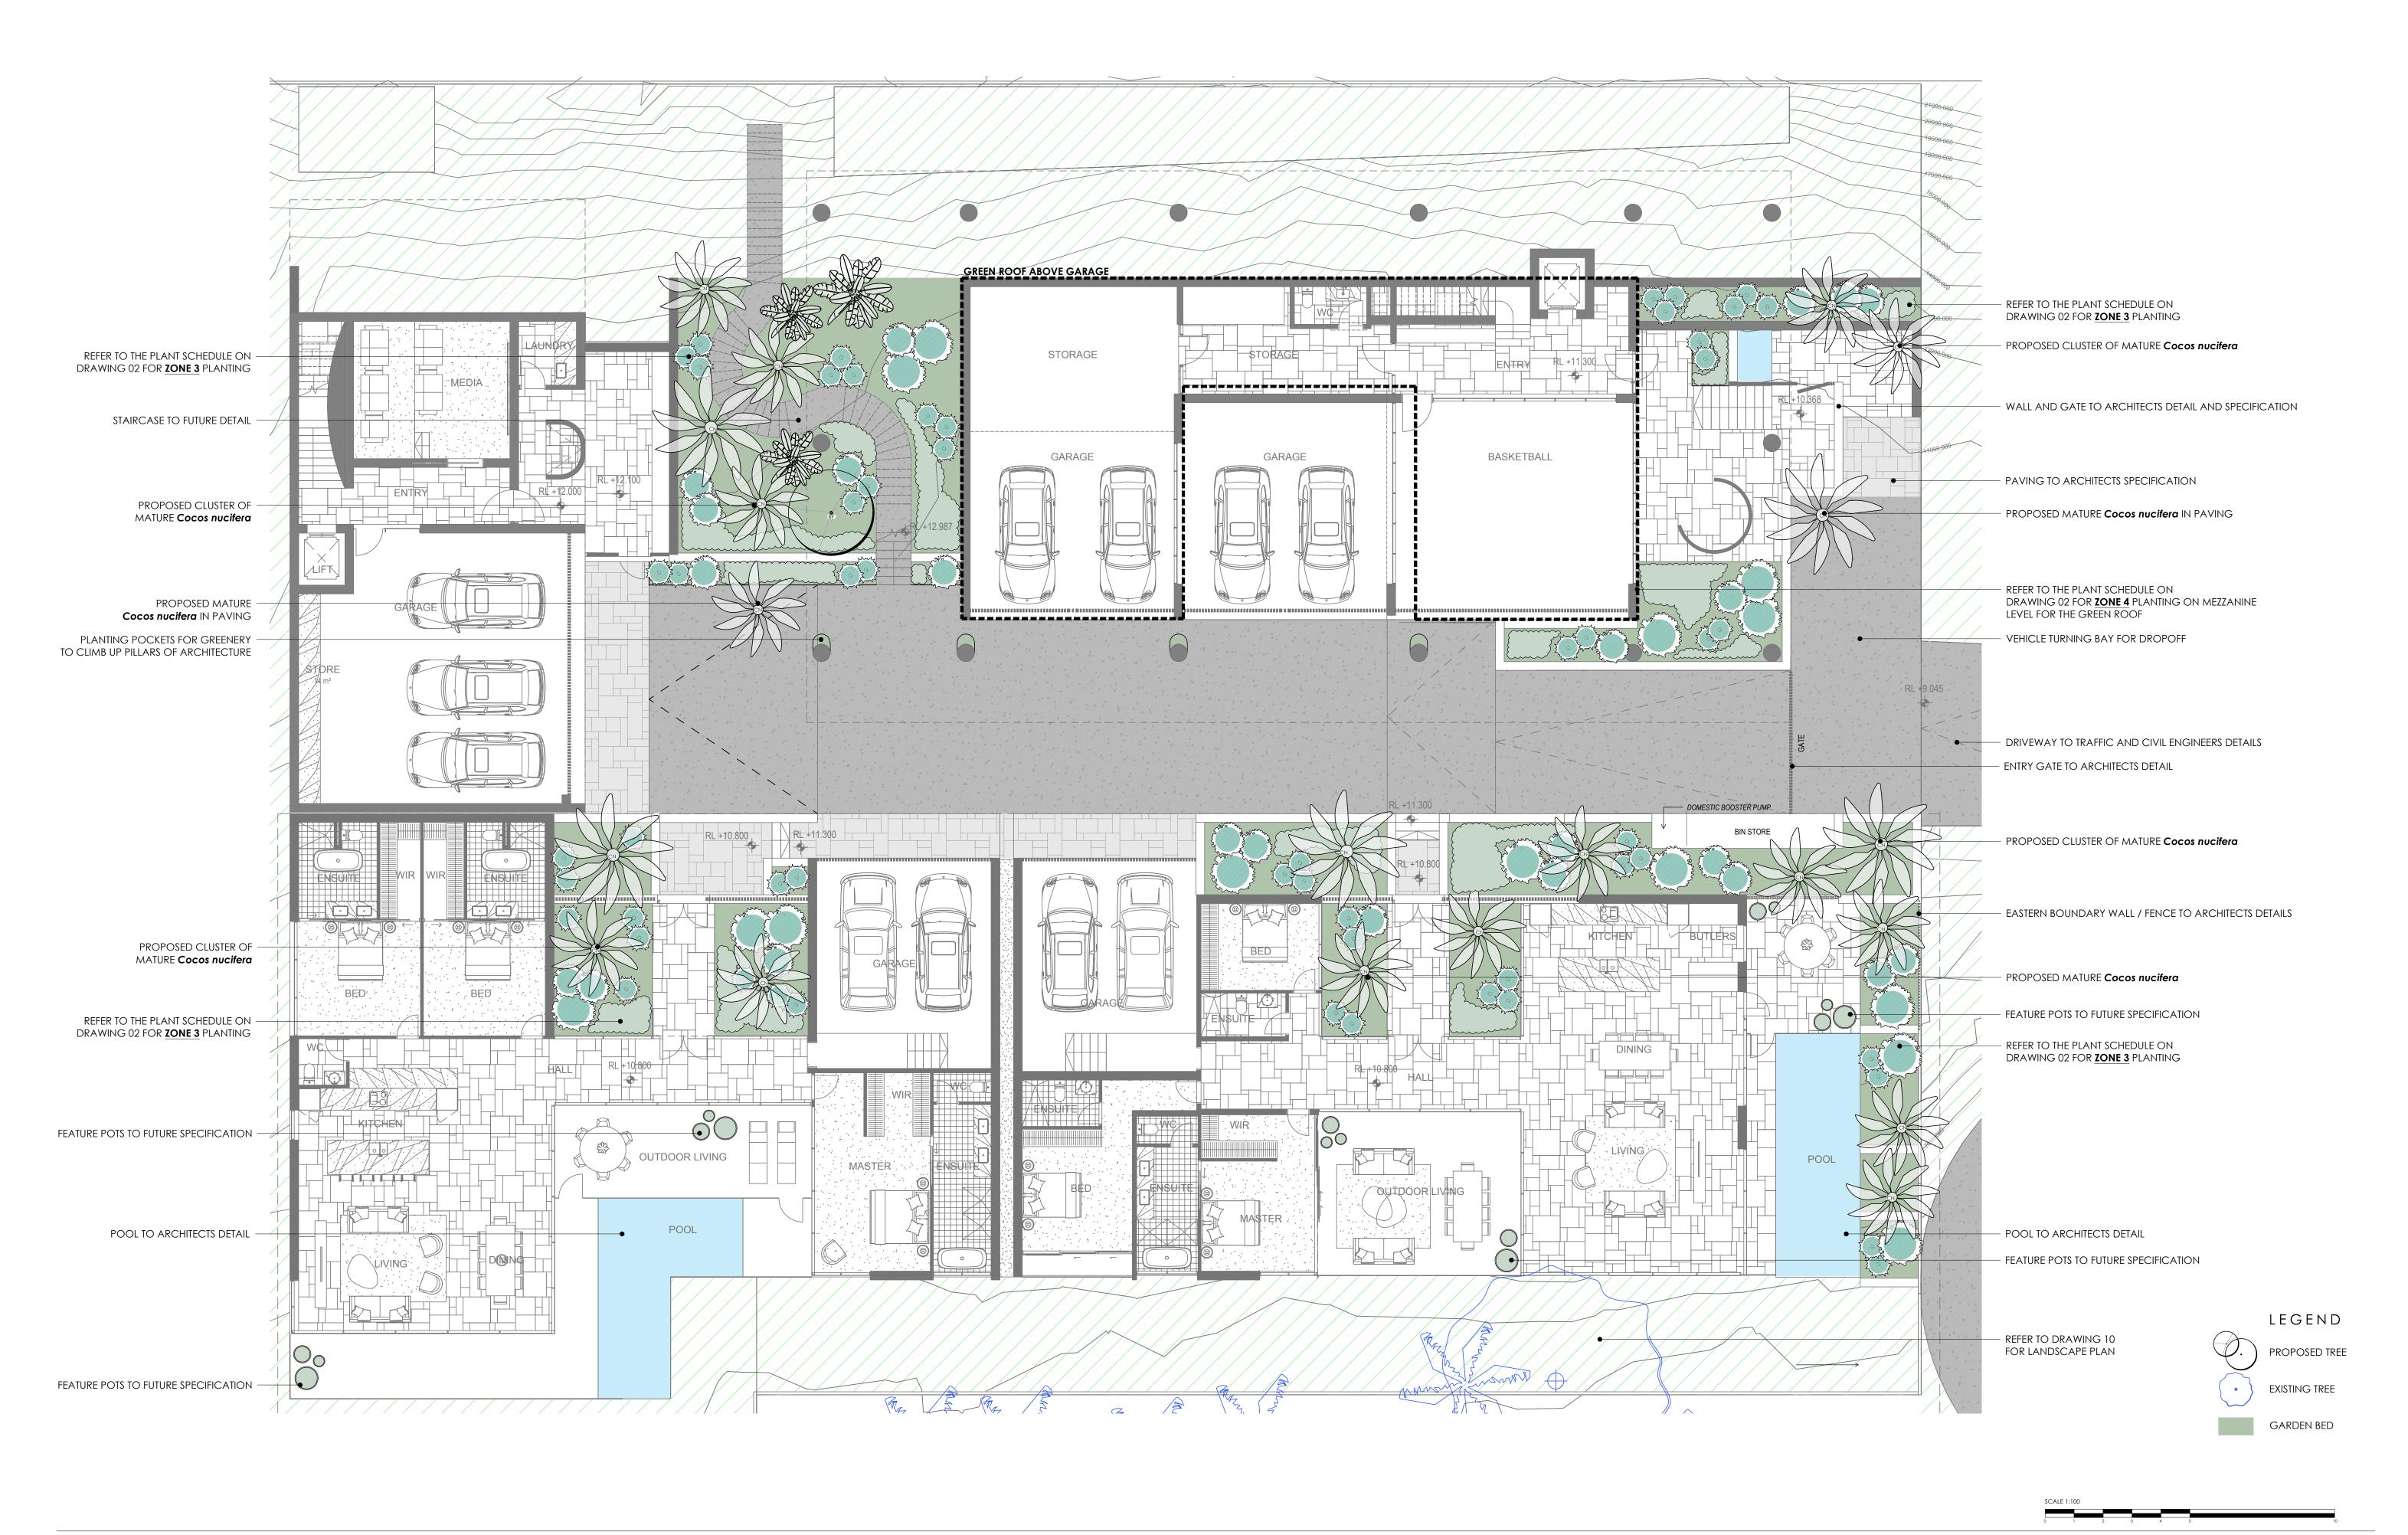

Attachment 5.6.1 824 of 876

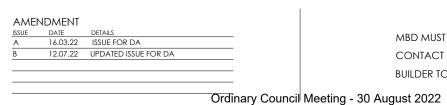

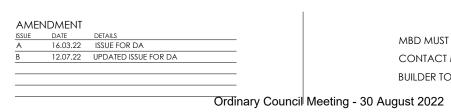

MBD MUST BE PRESENT ON-SITE FOR THE POSITIONING OF <u>ALL PLANTS</u>.

CONTACT MBD IF DISCREPANCIES OCCUR BETWEEN LANDSCAPE AND CONSULTANTS DOCUMENTS.

BUILDER TO CHECK AND VERIFY ALL DIMENSIONS ON SITE PRIOR TO CONSTRUCTION.

LANDSCAPE PLAN - LVL 3




DWG No: 511\_DA\_ SCALE: AS NOTE DRAWN: RM CHECKED: LM


ISSUE: B


THIS DRAWING IS COPYRIGHT

Attachment 5.6.1 825 of 876

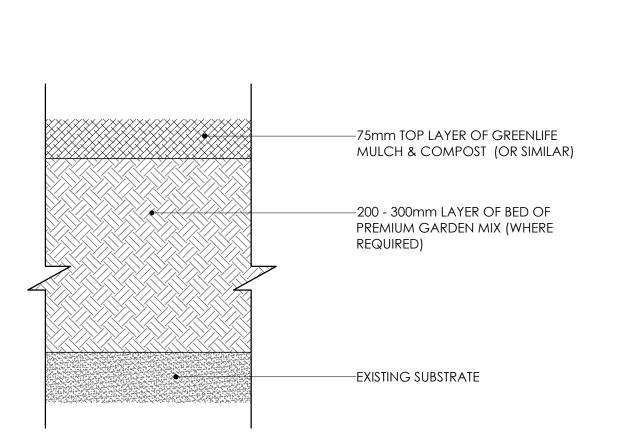


TYPICAL GARDEN SOIL PROFILE SCALE: 1:5 @ A1

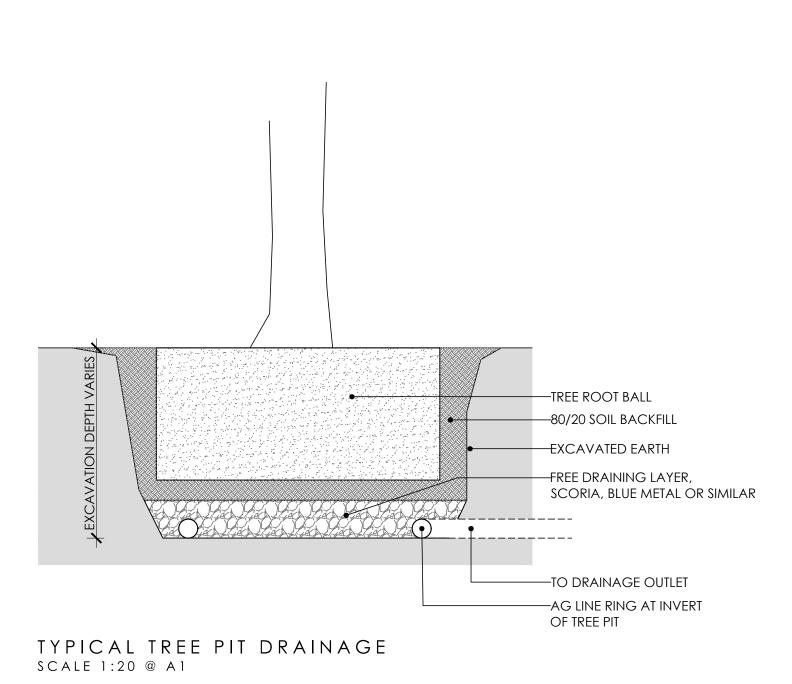


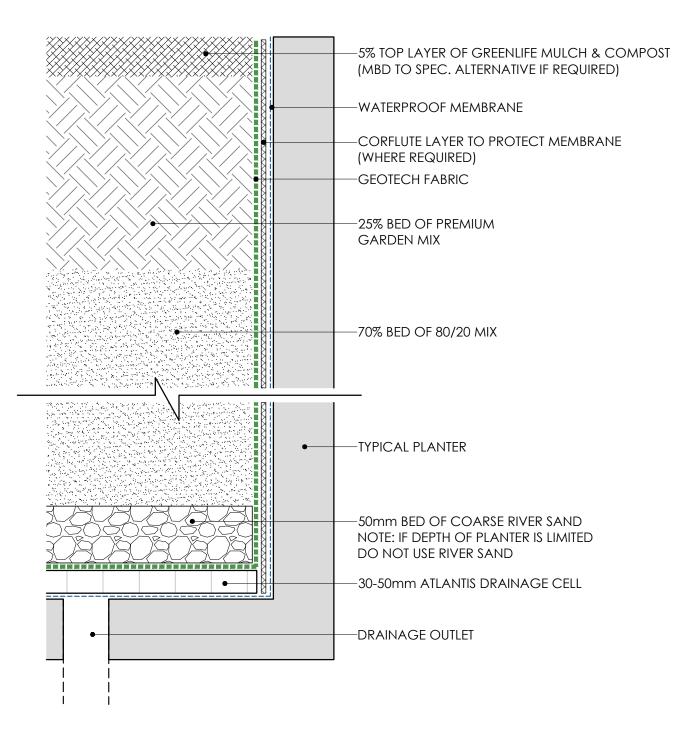


TYPICAL PLANTER SOIL PROFILE SCALE: 1:5 @ A1

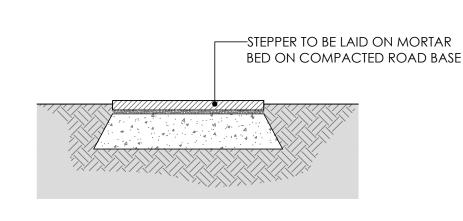


TYPICAL GARDEN STEPPER SCALE: 1:10 @ A1

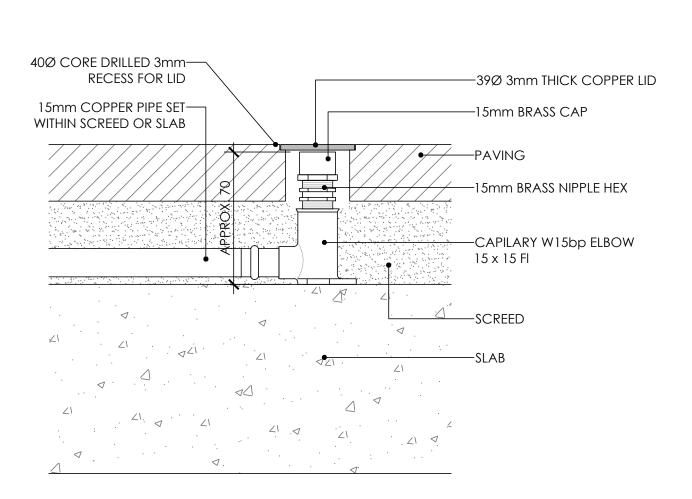

TYPICAL PAVING IRRIGATION CLOSED SCALE 1:2 @ A1

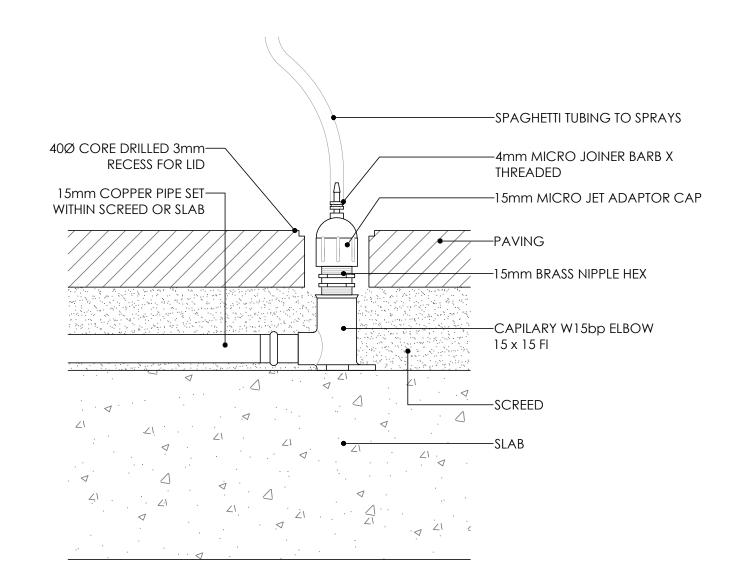

TYPICAL PAVING IRRIGATION OPEN SCALE 1:2 @ A1

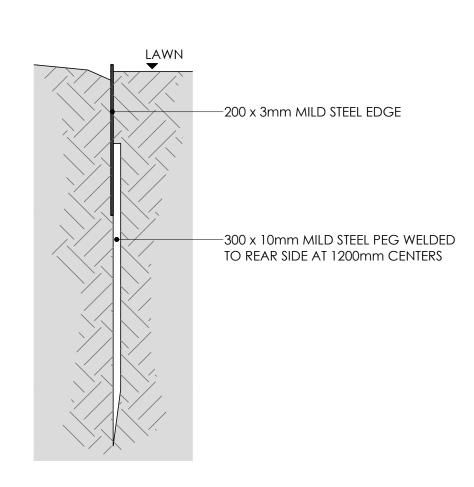

TYPICAL STEEL EDGE SCALE 1:5 @ A1

1.1 SOILS

AS 4419: Soils for Landscaping and Garden Use

AS 3743: Potting Mixes

· AS 4454: Composts, Soil Conditioners and Mulches

1.2 Plants

AS 2303: Tree Stock for Landscape Use

AS 4970: Protection of Trees on Development Sites

2.0 PRODUCTS

2.1 MATERIAL

#### Topsoil

- · Source: Provide topsoil, which contains organic matter, is free from stones, contaminants and weeds
- · Site: If available, provide material recovered from the site

#### Turf

Supplier: Obtain turf from a specialist grower of cultivated turf

· Quality: Provide turf of even thickness, free from weeds and other foreign matter

#### Fertiliser

General: Provide proprietary fertilisers, delivered to the site in sealed bags marked to show manufacturer or vendor, weight, fertiliser type, N:P:K ratio, recommended uses and application rates

#### Plants

- · Health: Supply plants with foliage size, texture and colour at time of delivery consistent with the size, texture and colour shown in healthy specimens of the nominated species
- · Vigour: Supply plants with extension growth consistent with that exhibited in vigorous specimens of the species nominated
- · Damage: Supply plants free from damage and from restricted habit due to growth in nursery rows
- · Pests and disease: Supply plants with foliage free from pest attack or disease
- · Substitutes: Plant substitution (species or quantities) is not acceptable unless approved by Myles Baldwin Design.

## 3.0 EXECUTION

3.1 SITE PREPARATION

#### Weed eradication

- Herbicide: Eradicate weeds with a non-residual glyphosate herbicide in any of its registered formulae, at the recommended maximum rate
- · Placing: Place clean filling in layers approximately 150 mm thick compacted to 85% of the dry density ratio of the surrounding soil as determined by AS

1289.5.4.1. Minimise slumping and further internal packing down

## Edges

Construct changes in grade over a minimum width of 500 mm to smooth, gradual and rounded profiles with no distinct joint

#### Existing trees

- · Tree protection zones (TPZ) shall be established around all trees to be retained and in accordance of AS 4970. The area within the fence shall be mulched
- · No excavation, construction activity, grade changes, storage of materials, stock piling, siting of sheds, preparation of mixes or cleaning of tolls is permitted within the TPZ

## Planting beds

- Excavated: Excavate to bring the subsoil to at least 300 mm below finished design levels. Shape the subsoil to fall to subsoil drains where applicable.

  Break up the subs to a further depth of 100 mm
- · Unexcavated: Remove weeds, roots, building rubble and other debris. Bring the planting bed to 75 mm below finished design levels
- Services and roots: Do not disturb services or tree roots; if necessary, cultivate these areas by hand

## Placing topsoil

- General: Spread the topsoil on the prepared subsoil and grade evenly, making the necessary allowances to permit the following:
- · Required finished levels and contours may be achieved after light compaction

# Grassed areas may be finished flush with adjacent hard surfaces such as kerbs, paths and mowing strips Topsoil depths

- General: Spread topsoil to the following typical depths:
- Excavated planting areas: If using organic soil, 300 mm. Refer to typical soil profile detail
- · Irrigated grassed areas generally: 150 mm
- · Irrigated grassed areas, heavy use (e.g. playing fields, playgrounds, and public parks): 200 mm

## Sediment and Erosion Control

- · Sediment and erosion control measures are required during the construction of all developments and building works. It shall be the contractor's responsibility that works are carried out in accordance with a sediment and erosion control plan and council/approving authority's requirements.
- 3.2 TURFING

## General

- Supply: Deliver the turf within 24 hours of cutting, and lay it within 36 hours of cutting. Prevent the turf from drying out between cutting and laying. If it is not laid within 36 hours of cutting, roll it out on a flat surface with the grass up, and water as necessary to maintain a good condition
- Laying: Lay the turf in the following manner:
- In stretcher pattern with the joints staggered and close butted
- Parallel with the long sides of level areas, and with contours on slopes
- To finish flush, after tamping, with adjacent finished surfaces of ground, paving edging, or grass seeded areas
- Tamping: Lightly tamp to an even surface immediately after laying. Do not use a roller
- Fertilising: Mix the fertiliser thoroughly into the topsoil before placing the turf. Apply lawn fertiliser at the completion of the first and last mowings, and at other times as required to maintain healthy grass cover
- · Watering: Water immediately after laying until the topsoil is moistened to its full depth. Continue watering to maintain moisture to this depth
- Levels: Where levels have deviated from the design levels after placing and watering, lift turf and re-grade topsoil to achieve design levels

#### 3.3 PLANTING

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#### General

- Individual plantings in grassed areas: Excavate a hole twice the diameter of the root ball and at least 100 mm deeper than the root ball. Break up the
- base of the hole to a further depth of 100 mm, and loosen compacted sides of the hole to prevent confinement of root growth

  Watering: Thoroughly water the plants before planting, immediately after planting, and as required to maintain growth rates free of stress
- Placing: Remove the plant from the container with minimum disturbance to the root ball, ensure that the root ball is moist and place it in its final position, in the center of the hole and plumb, and with the top soil level of the plant root ball level with the finished surface of the surrounding soil
- Fertilising plants: In planting beds and individual plantings, place fertiliser pellets around the plants at the time of planting
- · Backfilling: Backfill with topsoil mixture. Lightly tamp and water to eliminate air pockets

#### 3.4 TREES

#### General

· All trees must be planted by an AQF Level 3 Qualified Arborist, Landscape Gardener or Horticulturalist

#### Clay Soils

- · The base of each tree pit within clay soils shall be laid with 100mm deep scoria. A 90mm ag line ring shall sit within the scoria and drain directly to a suitable location. Lay geo-textile fabric evenly above the scoria, prior to tree placement and backfilling with 80/20 mineral soil
- 3.5 MULCHING

#### Placing mulch

- · General: Place mulch to the required depth, clear of plant stems, and rake to an even surface flush with the surrounding finished levels. Spread and roll mulch so that after settling, or after rolling, it is smooth and evenly graded between design surface levels sloped towards the base of plant stems in plantation beds, and not closer to the stem than 50 mm in the case of gravel mulches.
- · Garden beds: Greenlife Mulch and Compost
- · Tree mulch ring: Mushroom compost
- Depths: Spread organic mulch to a depth of 75 mm, and gravel mulch to a depth of 50 mm

#### 3.6 STAKES AND TIES

#### Stakes

- Material: Hardwood, straight, free from knots or twists, pointed at one end
- · Installation: Drive stakes into the ground at least one third of their length, avoiding damage to the root system

#### Ties

· General: Provide 50 mm hessian webbing ties fixed securely to the stakes, one tie at half the height of the main stem, others as necessary to stabilise the

#### 3.7 WATERING

#### Establishment

- Extent: Available soil moisture content of grass areas and garden beds to be monitored on a weekly basis using an approved moisture probe and water applied on a demand basis. Readings should be taken at a depth of 250mm
- · All grass areas and garden beds should be maintained within a range of 50-80% available soil moisture. Under no circumstance should areas under irrigation fall below a level of 30% available soil moisture
- · No visible signs of wilting of leaves or stems, with all plants fully turgid at all times.
- · No sign of over-watering such as constantly wet soil, brown leaf margins, stem rot or brown spots on foliage

## 3.8 LANDSCAPE SUBSOIL DRAINAGE

## General

· Include subsoil drainage behind retaining walls, along path edges and in mass planting beds, including lawn areas. Maintenance access points shall be every 15m

## Material

- Geotextile fabric: shall consist of a woven or a non-woven type to be manufactured from synthetic materials other than polyamide
- Aggregate: shall be a single size with a nominal dimension of 10-40mm
- · Subsoil pipe: shall be 90 mm diameter corrugated flexible slotted PVC pipe in a geofabric sock, or 100mm µPVC if under pavement. All pipes to requirements of AS 1254. Where vehicle loads are encountered, reinforced concrete pipe shall be used only

## Construction

- · Trenches to be minimum 300mm wide and extend 500mm below the subgrade level or 150mm if into bed rock
- $\cdot \quad \text{Trenches to be lined with geotextile fabric and backfilled with aggregate. Pipe to be laid 50mm above trench floor}$
- · Prior to backfilling the trench, drainage and connection to stormwater is to be approved by the site manager

## 3.9 COMPLETION

## Cleaning

- · Stakes and ties: Remove those no longer required at the end of the planting establishment period
- Temporary fences: Remove temporary protective fences at the end of the planting establishment period

## 4.0 ESTABLISHMENT & DEFECTS LIABILITY

## 4.1 ESTABLISHMENT

## General

- · All landscaping works will have an establishment period of 26 weeks in which the subcontractor will be responsible for the maintenance and upkeep of the contracted scope, unless otherwise noted in the project documentation. If applicable refer to the project manager / builder for confirmation
- 4.2 DEFECTS LIABILITY PERIOD

## General


· All landscaping works will be subject to a defects liability period of 52 weeks, commencing from the date of Practical Completion, unless otherwise noted in the project documentation. If applicable refer to the project manager / builder for confirmation

## 4.3 FAILED PLANTINGS

General

· Photographic images of plants shall be approved by Myles Baldwin Design prior to procurement of replacement plant and tree stock

CHECKED: LM

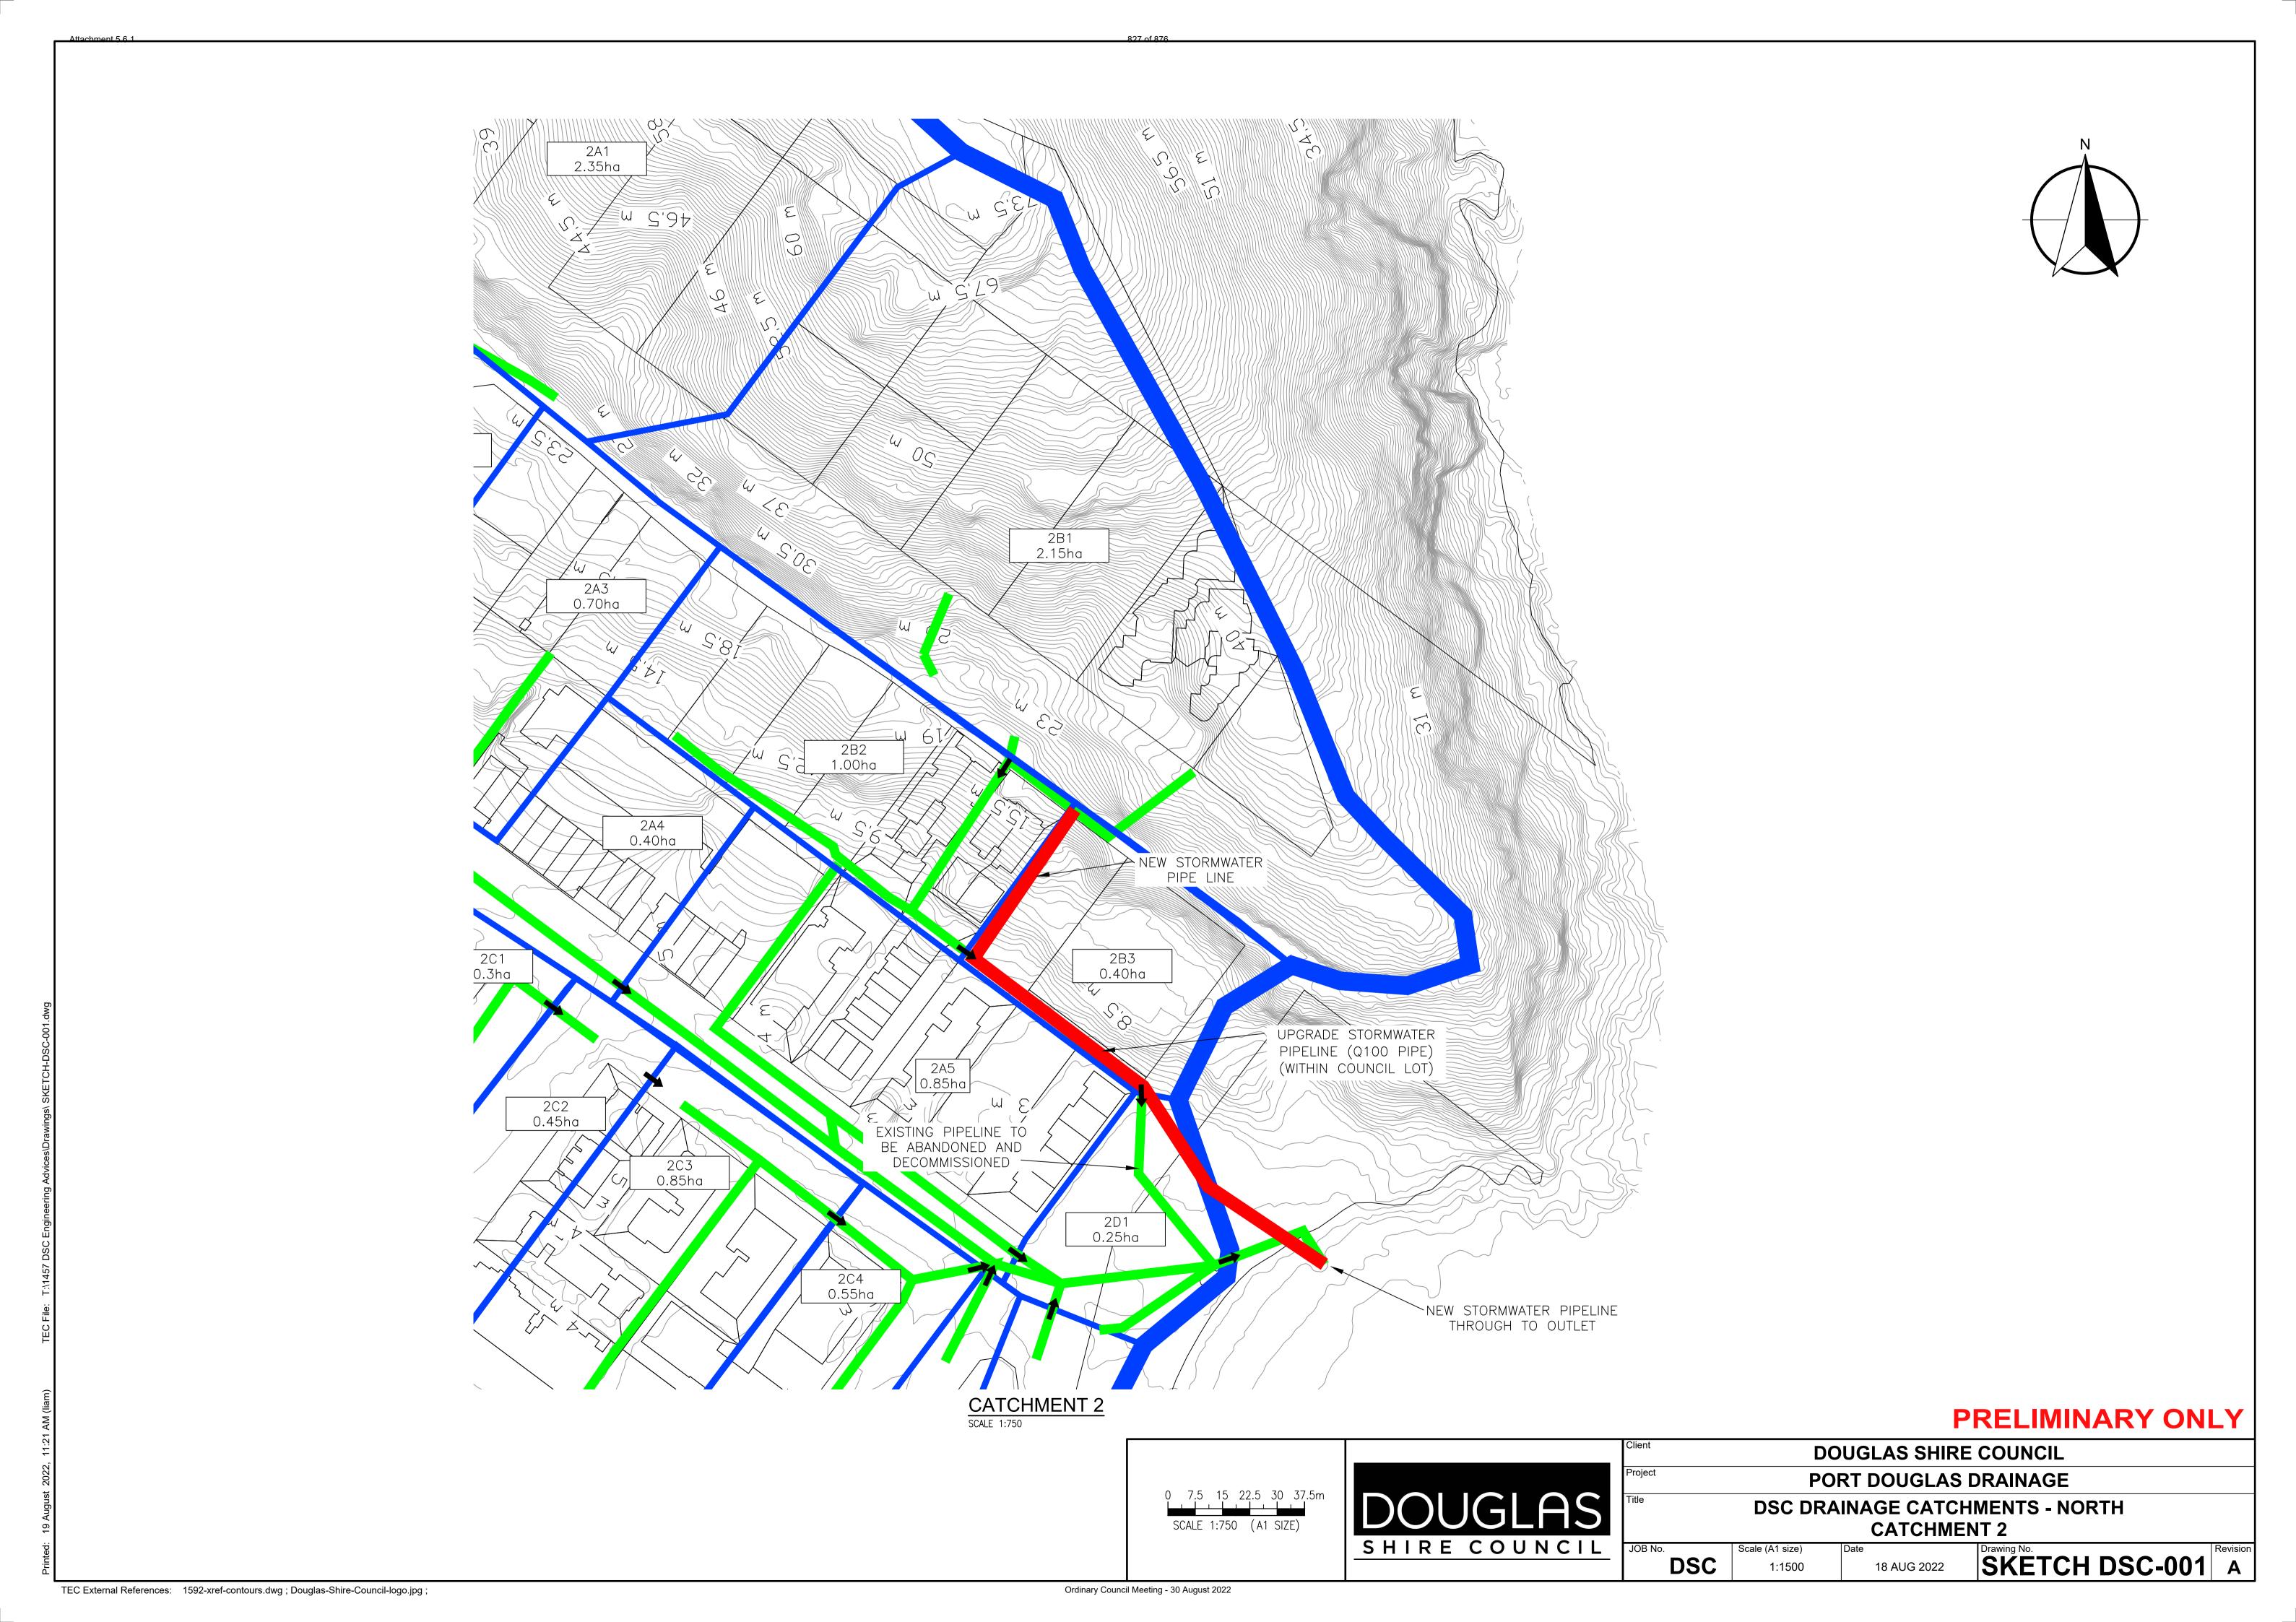

Attachment 5.6.2 828 of 876

	Gurner TM Nominee	•			NA		0	
	DEVELOPERS NA 69, 71-73 Murphy Street	AME	Don't Doubles		ESTATE NAME		STAGE <b>P2344, P2343</b>	
	Port Douglas SUBURB		LOT & RP No.s		P2344, P2343  PARCEL No.			
MCU Mult	STREET No. & NAME	nmodation	COBORD		MCUC 2020_3867  COUNCIL FILE NO.		6 VALIDITY PERIOD (year)	
	DEVELOPMENT TYPE			l				
	1			t of use for MCU; and survey form for ROL				
	DSC Reference Doc . No.		VERSION No.		Thor to sign	ng and scanng or	survey form for ICOL	
frastructure Charge	es as resolved by Council at the	Ordinary Meeting held o	on 23 February 2	2021 (Came	e into effect on 1 March 202	11)		
		Charge per Use	\$ Rate	Floor area/No.	Amount	Amount Paid	Receipt Code & GL Cod	
roposed Demand esidential	Multiple_dwelling	\$_per_3_or_more_bed room_dwelling	24,553.82	4	\$98,215.28			
redit	Total Demand				\$98,215.28			
xisting land use or more bedroom welling	Per Lot	\$_per_3_or_more_bed room_dwelling	24,553.82	2	\$49,107.64			
	Total Credit				\$49,107.64		Code 895 GL GL7500.135.825	
	Required Payment or Credit		TOTAL		\$49,107.64			
repared by	J	Elphinstone			18-Aug-22	Amount Paid		
hecked by		Neil Beck			18-Aug-22	Date Paid		
Date Payable								
	MCU - prior to the commence	ment of use				Receipt No.		
mendments				ı	Date	·		
						Cashier		
s from Council's res	harges in this Notice are payab solution from the Ordinary Meet the Policy are subject to indexir	ting held on 23 Februar		d 120 of th	ne Planning Act 2016			