
QUAID RESIDENCE - 238 TATI ROAD MIALLO MOSSMAN QLD **CONCEPT PLAN**

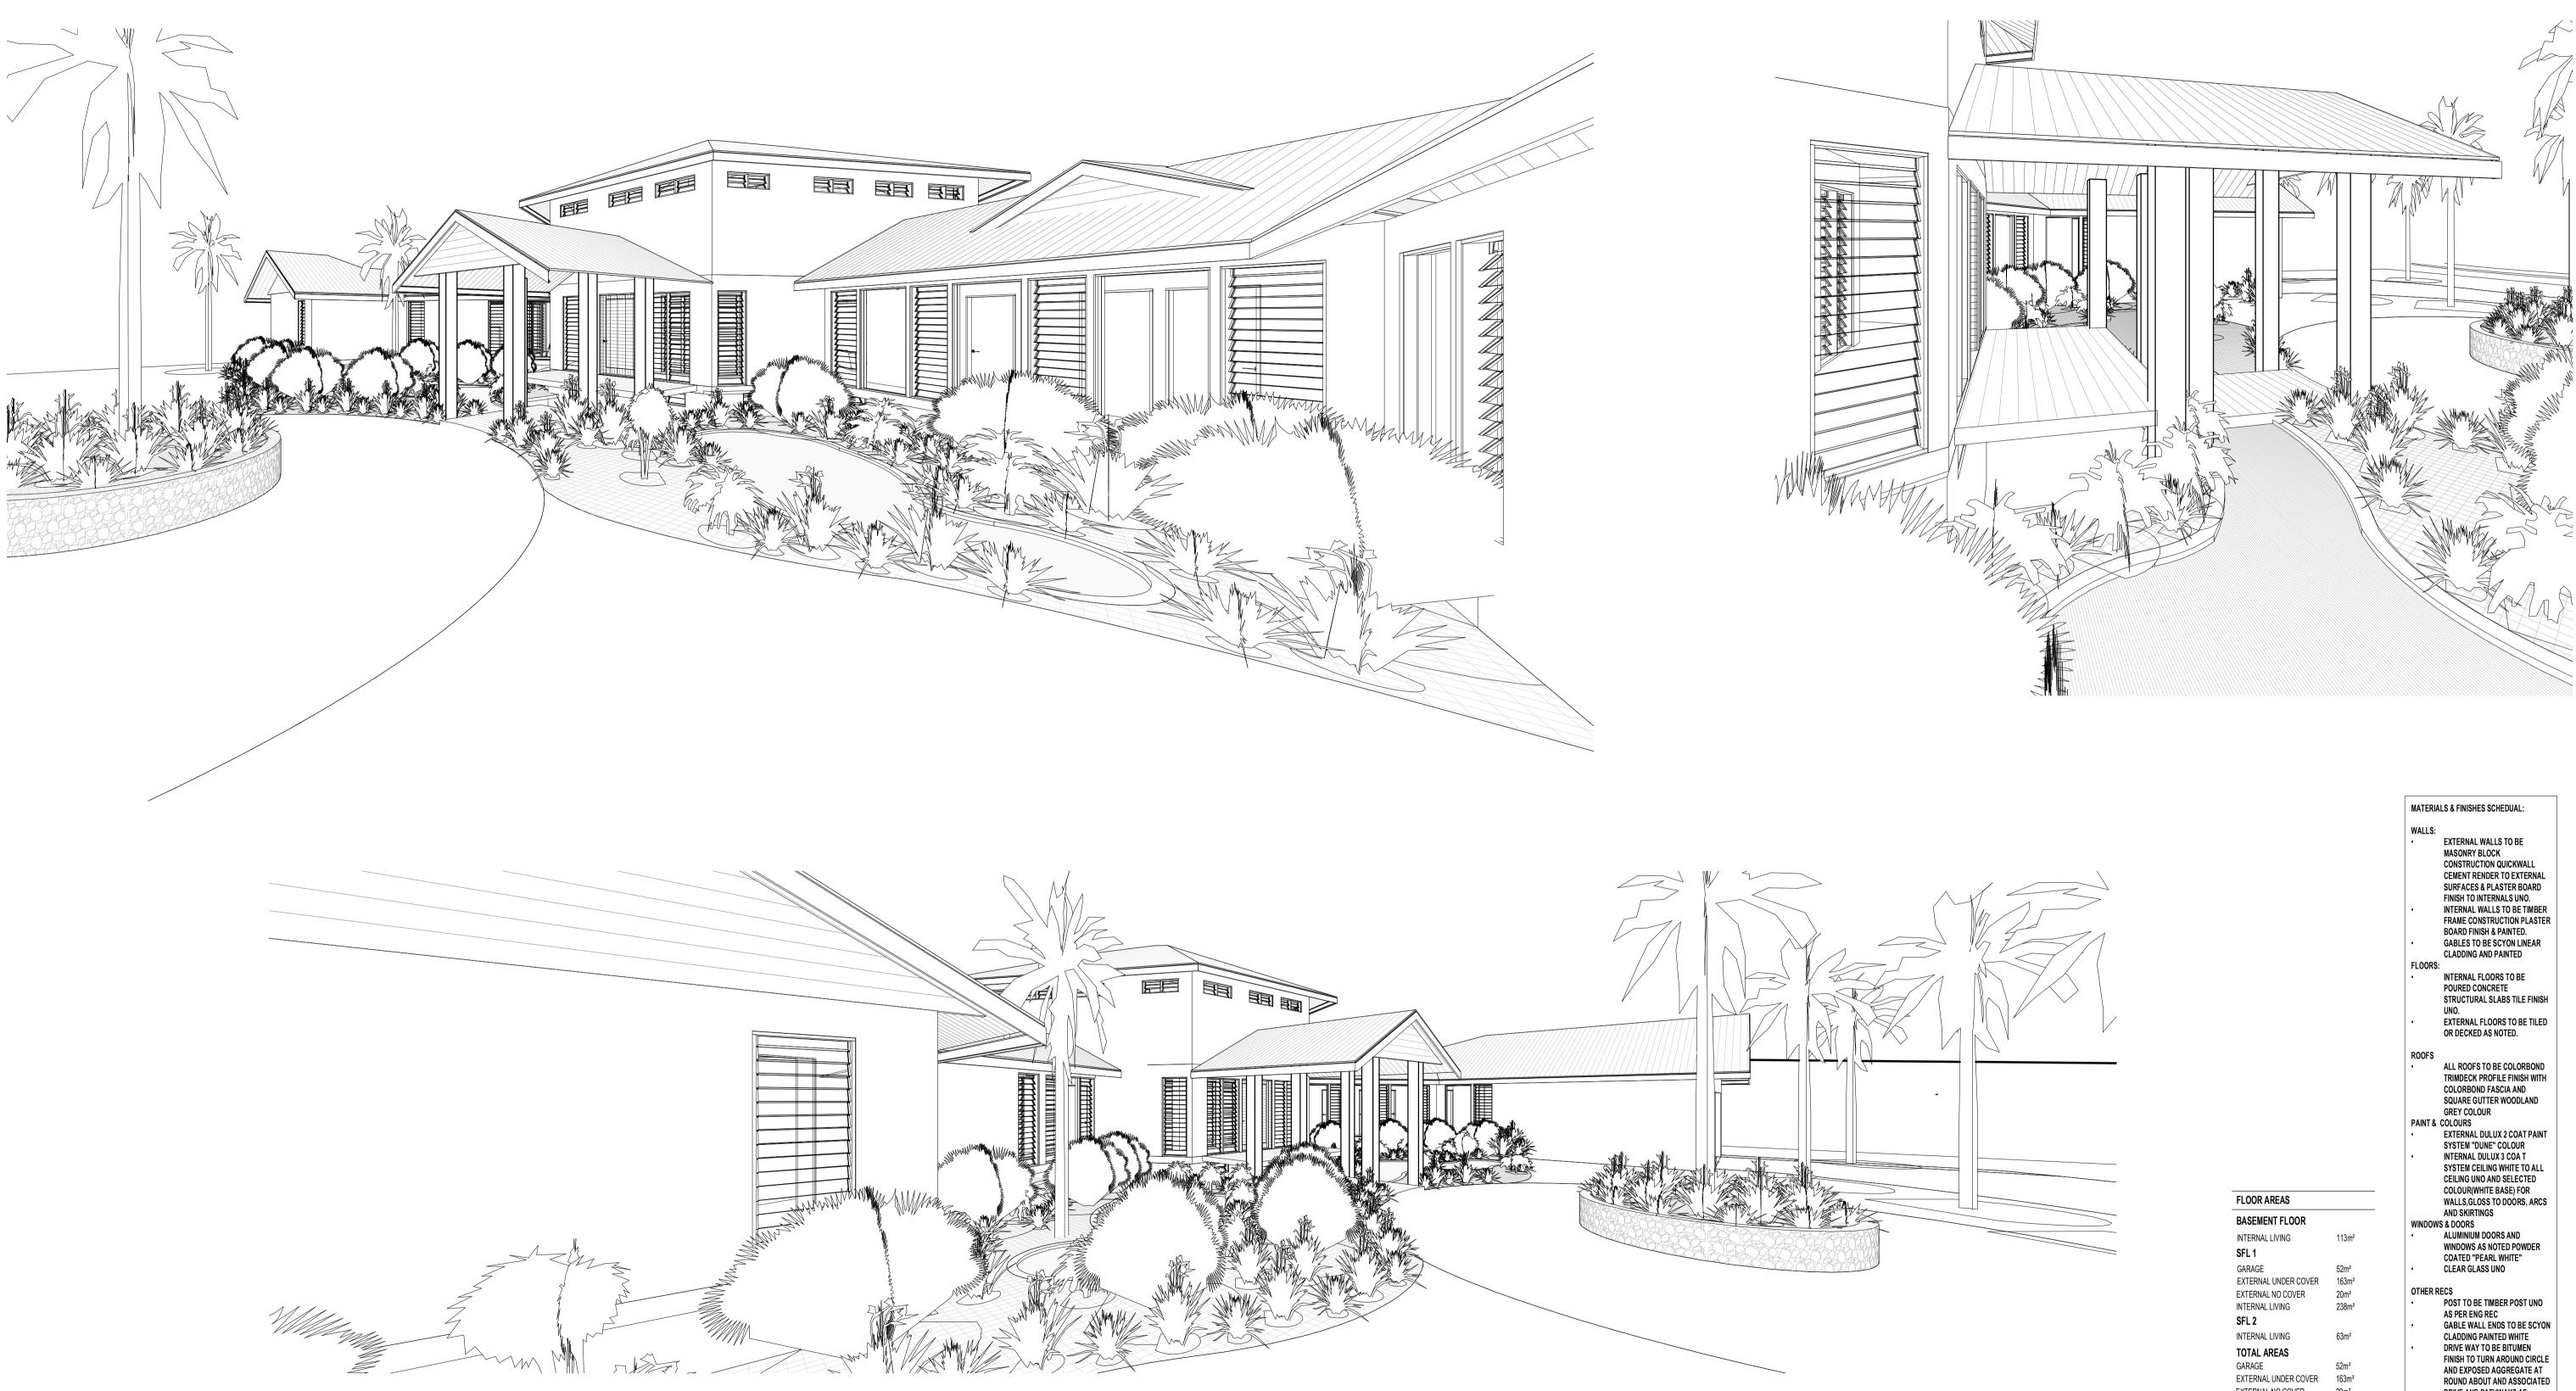



PRELIMINARY ISSUE NOT FOR CONSTRUCTION B 15.05.18 RL'S AMENDED

FLOOR AREAS	
BASEMENT FLOOR	
INTERNAL LIVING	113m ²
SFL 1	
GARAGE	52m²
EXTERNAL UNDER COVER	163m ²
EXTERNAL NO COVER	20m ²
INTERNAL LIVING	238m²
SFL 2	
INTERNAL LIVING	63m²
TOTAL AREAS	
GARAGE	52m²
EXTERNAL UNDER COVER	163m²
EXTERNAL NO COVER	20m²
INTERNAL LIVING	414m²
GFA SITE COVER	473m²
SITE AREA	23117m²
COVERAGE %	2.04%

MATERIA	LS & FINISHES SCHEDUAL:			
WALLS:				
•	EXTERNAL WALLS TO BE			
	MASONRY BLOCK			
	CONSTRUCTION QUICKWALL			
	CEMENT RENDER TO EXTERNAL			
	SURFACES & PLASTER BOARD			
	FINISH TO INTERNALS UNO. INTERNAL WALLS TO BE TIMBER			
•	FRAME CONSTRUCTION PLASTER			
	BOARD FINISH & PAINTED.			
	GABLES TO BE SCYON LINEAR			
	CLADDING AND PAINTED			
FLOORS:				
•	INTERNAL FLOORS TO BE			
	POURED CONCRETE			
	STRUCTURAL SLABS TILE FINISH			
	UNO.			
•	EXTERNAL FLOORS TO BE TILED			
	OR DECKED AS NOTED.			
ROOFS				
•	ALL ROOFS TO BE COLORBOND			
	TRIMDECK PROFILE FINISH WITH			
	COLORBOND FASCIA AND			
	SQUARE GUTTER WOODLAND			
	GREY COLOUR			
PAINT &	COLOURS			
•	EXTERNAL DULUX 2 COAT PAINT			
	SYSTEM "DUNE" COLOUR			
•	INTERNAL DULUX 3 COA T System Ceiling White to All			
	CEILING UNO AND SELECTED			
	COLOUR(WHITE BASE) FOR			
	WALLS, GLOSS TO DOORS, ARCS			
	AND SKIRTINGS			
WINDOW	S & DOORS			
•	ALUMINIUM DOORS AND			
	WINDOWS AS NOTED POWDER			
	COATED "PEARL WHITE"			
•	CLEAR GLASS UNO			
OTHER R	POST TO BE TIMBER POST UNO			
•	AS PER ENG REC			
	GABLE WALL ENDS TO BE SCYON			
	CLADDING PAINTED WHITE			
•	DRIVE WAY TO BE BITUMEN			
	FINISH TO TURN AROUND CIRCLE			
	AND EXPOSED AGGREGATE AT			
	ROUND ABOUT AND ASSOCIATED			
	DRIVE AND PATHWAYS AS			
	NOTED. PROPOSED DRIVE WAY			
	TO MEANDER AROUND EXISTING			
	TREES AND SITE OBJECTS TBD ONSITE.			
	UNUILE.			

PROJECT PAWLOWSKI RESIDENCE

SHEET TITLE

PROJECT NUMBER L39BFM

PROJECT ADDRESS L39 / GTP 107089 BEACHFRONT MIRAGE PORT DOUGLAS 4877









B 15.05.18 RL'S AMENDED




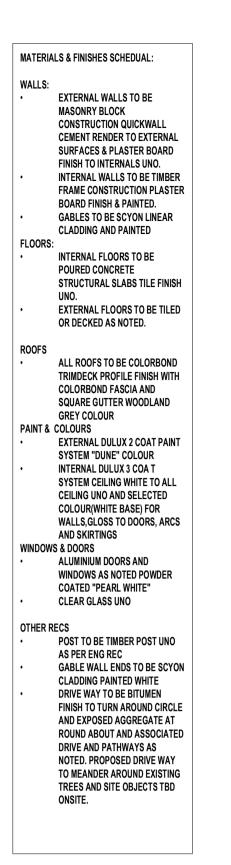

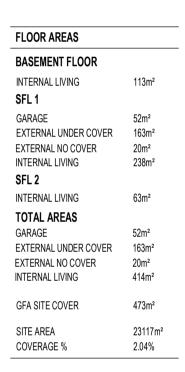

PROJECT NUMBER L39BFM

PROJECT ADDRESS L39 / GTP 107089 BEACHFRONT MIRAGE PORT DOUGLAS 4877

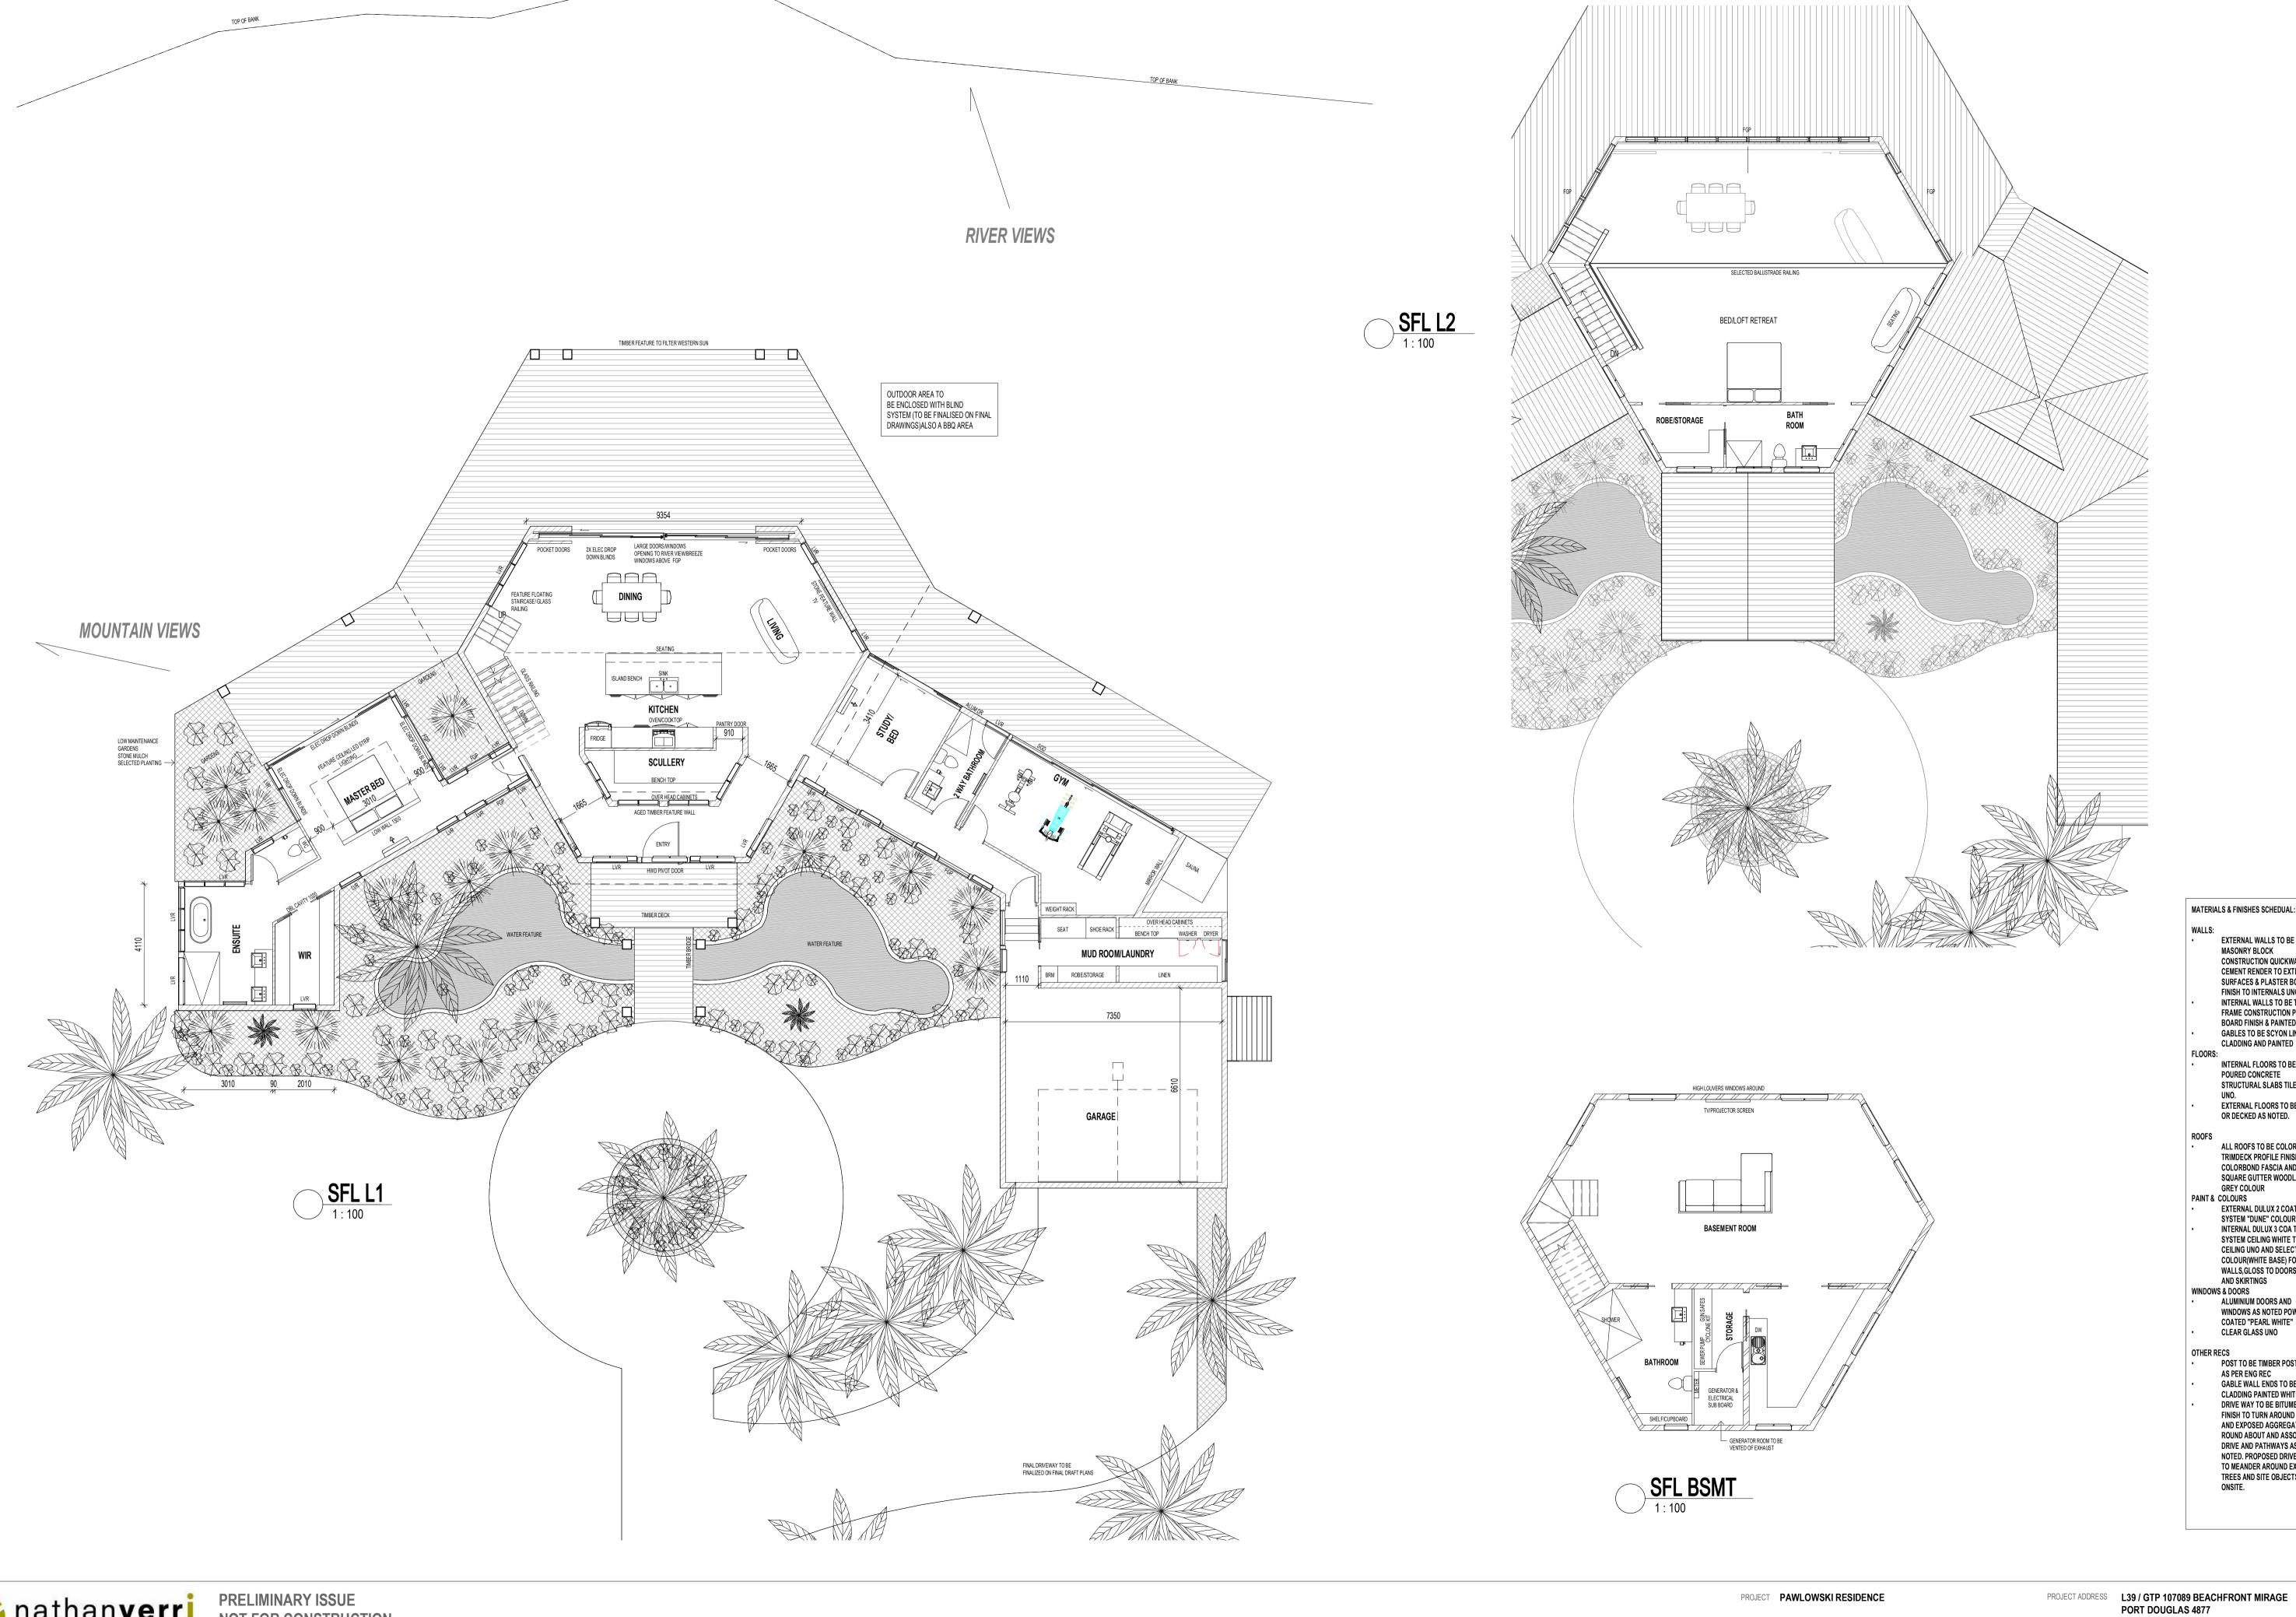



PRELIMINARY ISSUE NOT FOR CONSTRUCTION

B 15.05.18 RL'S AMENDED e : info@nathanverri.com REVISION Mossman Q 4873 ISO A1 18/07/2019 10:43:19 AM

MATERIA	LS & FINISHES SCHEDUAL:
WALLS:	
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	CONSTRUCTION QUICKWALL CEMENT RENDER TO EXTERNAL
	SURFACES & PLASTER BOARD
	FINISH TO INTERNALS UNO.
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	BOARD FINISH & PAINTED. GABLES TO BE SCYON LINEAR
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	ONSITE.

PROJECT PAWLOWSKI RESIDENCE

SHEET FLOOR PLANS





SHEET ELEVATIONS

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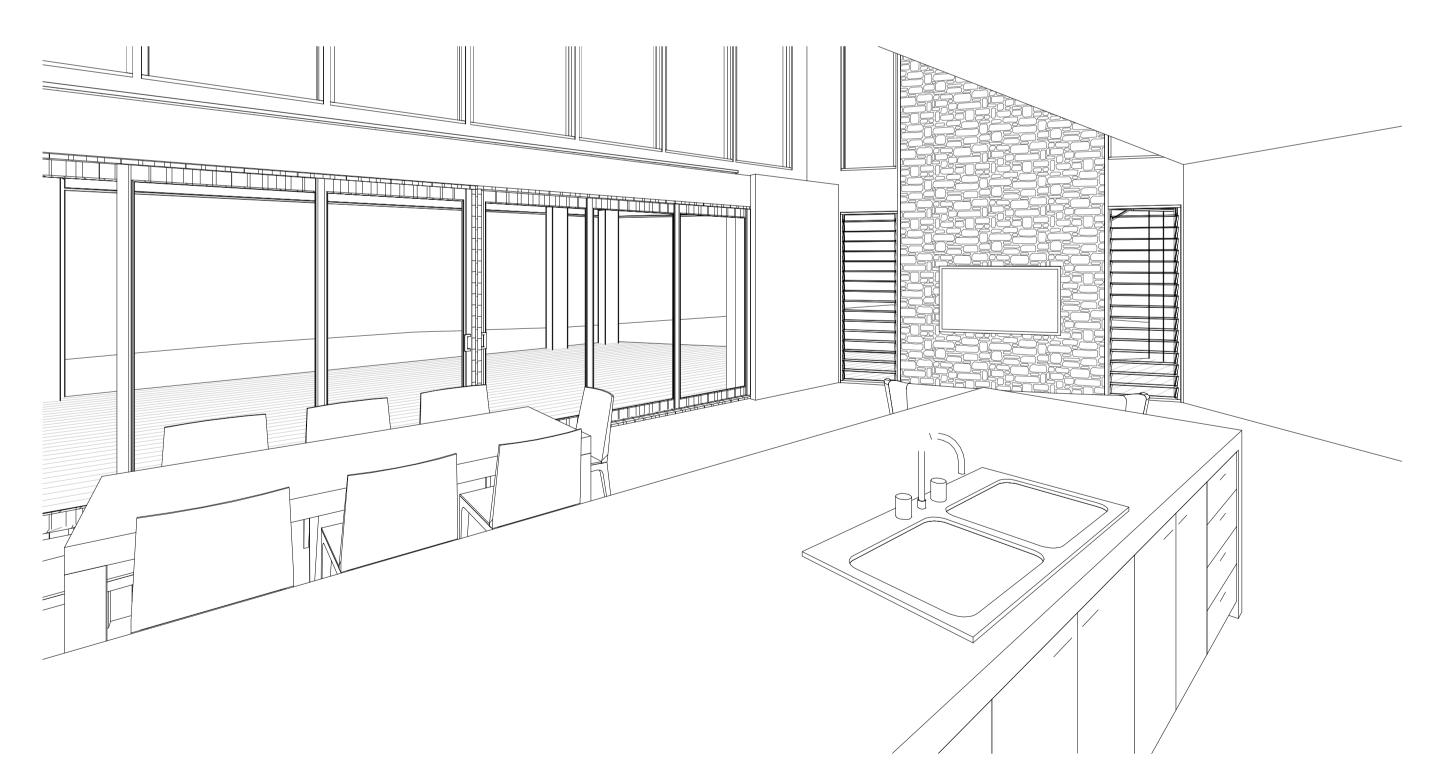
PROJECT PAWLOWSKI RESIDENCE

PROJECT NUMBER L39BFM










SHEET 3DS

PROJECT PAWLOWSKI RESIDENCE

DRAWN NV SCALE AS SHOWN @

PROJECT ADDRESS L39 / GTP 107089 BEACHFRONT MIRAGE PORT DOUGLAS 4877

PROJECT NUMBER L39BFM

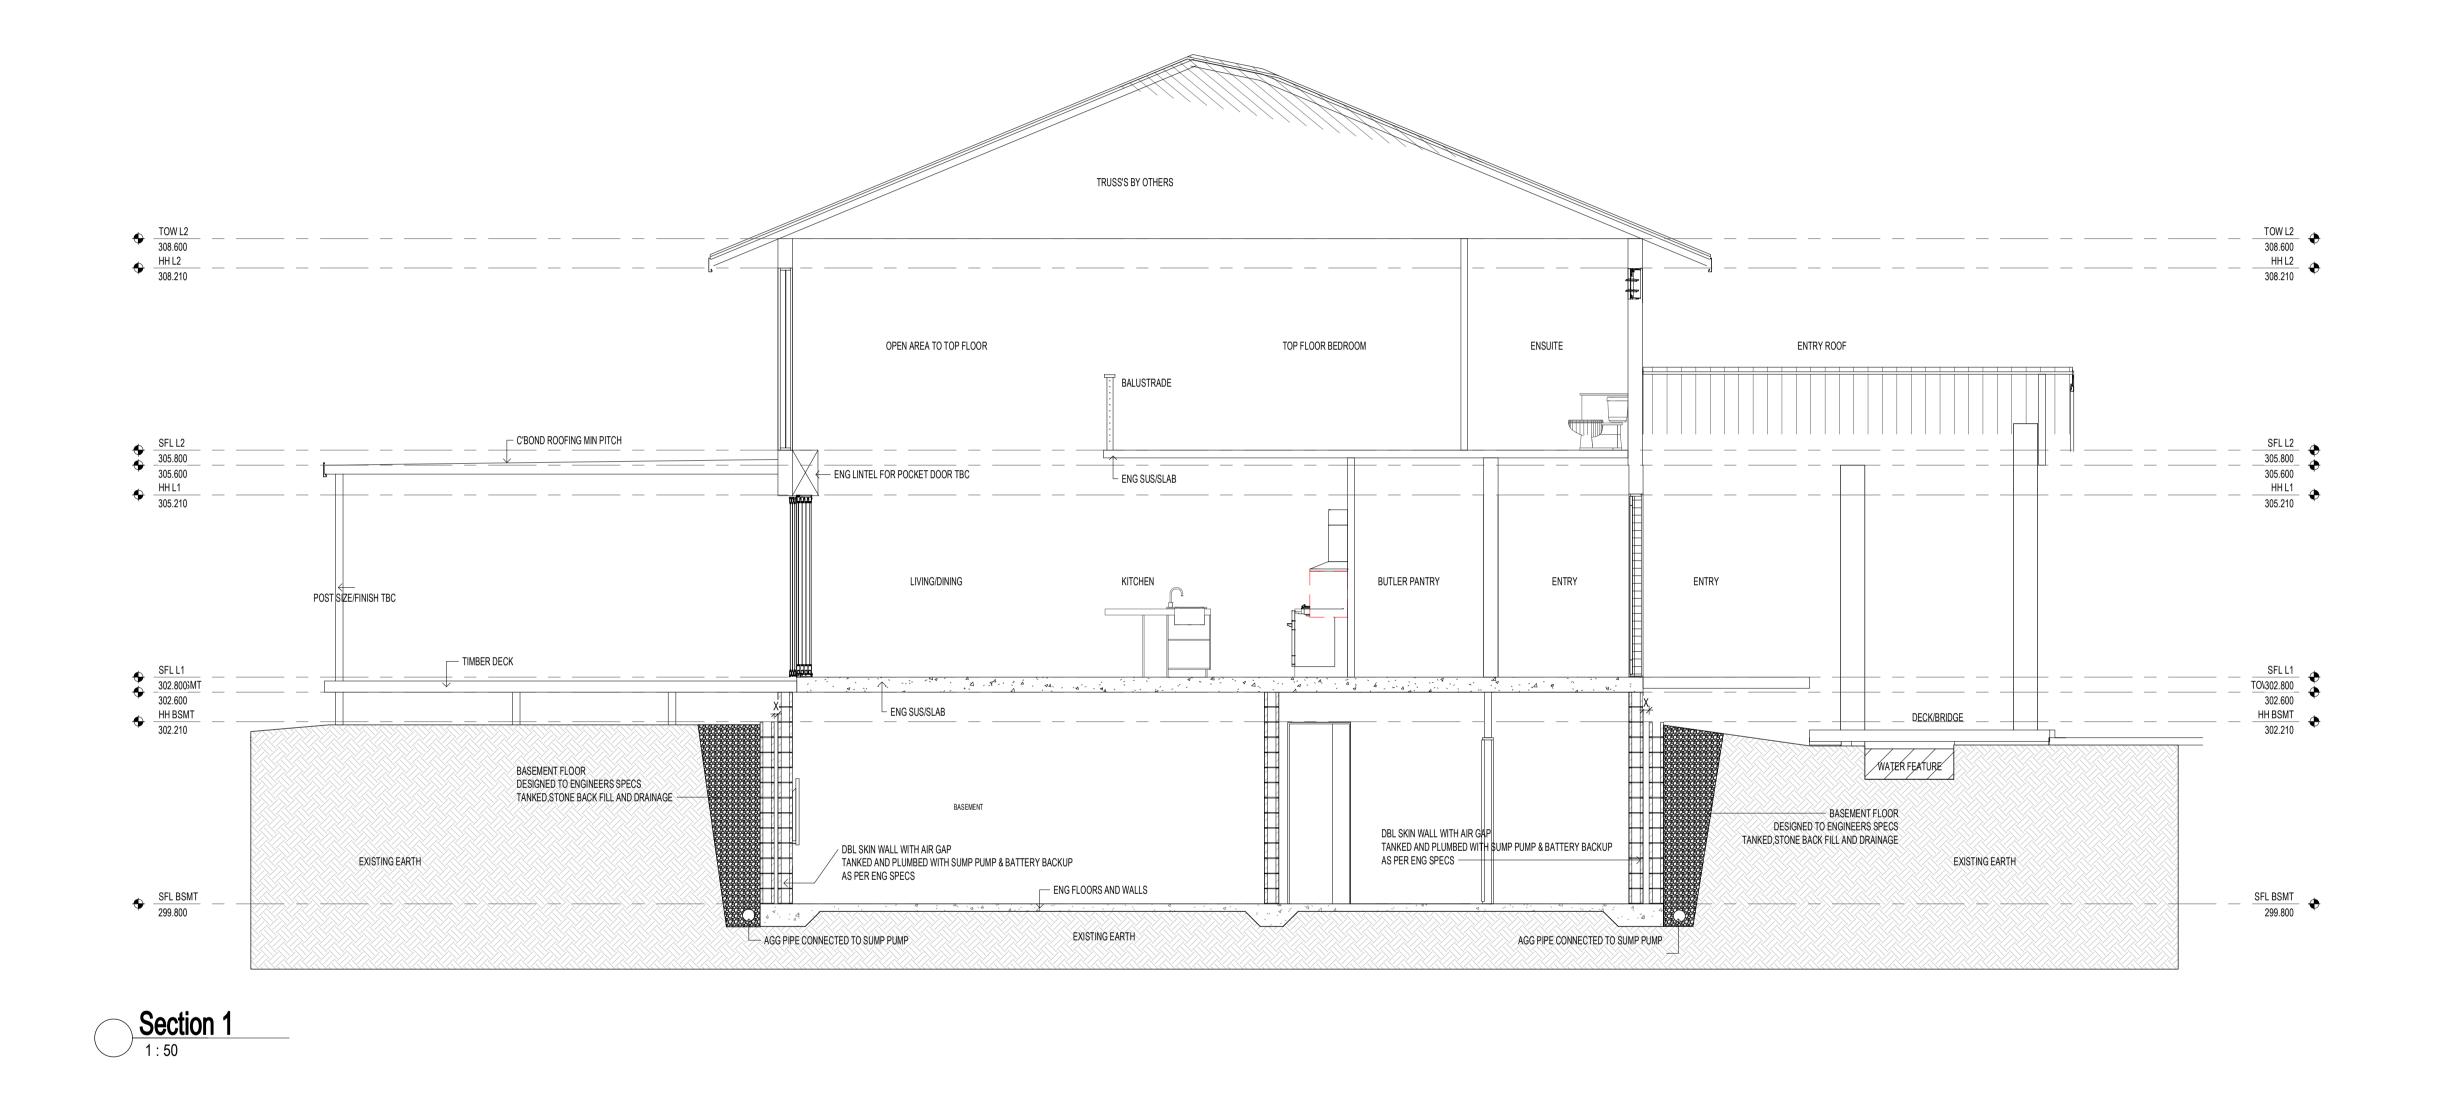



ULTIMATE & SERVICEABILITY LIMIT STATE DESIGN WIND PRESSURES							
WIND CLASS	WIND	N GUST SPEED i/s)	DESIGN PRESSURES (kPa)				
	V h,u	V h,s	GREATER THAN 1.2m FROM CORNERS			UP TO .2m FROM CORNERS	
	ULS	SLS	ULS	SLS	ULS	SLS	
C2	61	39	±2.68	±0.88	-4.02	-1.23	

PROJECT PAWLOWSKI RESIDENCE

SHEET SECTIONS 1