IDAS form 1—Application details

(Sustainable Planning Act 2009 version 3.0 effective 1 July 2013)

This form must be used for ALL development applications.



You MUST complete ALL questions that are stated to be a mandatory requirement unless otherwise identified on this form.

For all development applications, you must:

- complete this form (IDAS form 1—Application details)
- complete any other forms relevant to your application
- provide any mandatory supporting information identified on the forms as being required to accompany your application.

Attach extra pages if there is insufficient space on this form.

All terms used on this form have the meaning given in the Sustainable Planning Act 2009 (SPA) or the Sustainable Planning Regulation 2009.

This form and any other IDAS form relevant to your application must be used for development applications relating to strategic port land and Brisbane core port land under the *Transport Infrastructure Act 1994* and airport land under the *Airport Assets (Restructuring and Disposal) Act 2008*. Whenever a planning scheme is mentioned, take it to mean land use plan for the strategic port land, Brisbane core port land or airport land.

PLEASE NOTE: This form is not required to accompany requests for compliance assessment.

l'his form can also be com	pleted online using My	DAS at www.dsdi	p.qld.gov.au/My/	DAS

Mandatory requirements

Applicant details (Note: the applicant is the person responsible for making the application and need not be the owner of the land. The applicant is responsible for ensuring the information provided on all IDAS application forms is correct. Any development permit or preliminary approval that may be issued as a consequence of this application will be issued to the applicant.)

* '					
Name/s (individual or company name in full)	Gordon	Wellham			
For companies, contact name					
Postal address	3 Captain	Cook Highway			
	Suburb	Craiglie			
	State	QLD	Postcode	4877	
	Country	Australia			
Contact phone number	07 4098 54	473			
Mobile number (non-mandatory requirement)					
Fax number (non-mandatory requirement)	07 4098 50	044			



Εm	ail address (non-mandatory requirement)	g.wellham		
		@ exemplare	online.com.au	
	olicant's reference number (non-mandatory uirement)	•		
1.	What is the nature of the development pr	roposed and v	what type of approval	is being sought?
Tal	ole A—Aspect 1 of the application (If there are	additional asp	ects to the application p	lease list in Table B—Aspect 2.)
a)	What is the nature of the development? (Plea	ase only tick or	ne box.)	
	Material change of use		Building work	Operational work
b)	What is the approval type? (Please only tick	one box.)		
		ry approval 41 and s242	Development permit	
c)	Provide a brief description of the proposal, in applicable (e.g. six unit apartment building de			
	Refurbishment of existing building for use as vehicle washing area.	offices and wh	olesale/retail facility; ere	ection of canopy over
d)	What is the level of assessment? (Please only	/ tick one box.)		
	Impact assessment Code ass	essment		
	ole B—Aspect 2 of the application (If there are litional aspects of the application.)	additional aspe	ects to the application p	lease list in Table C—
a)	What is the nature of development? (Please	only tick one b	ox.)	
	Material change of use Reconfigu	ring a lot	Building work	Operational work
b)	What is the approval type? (Please only tick of	one box.)		
		y approval 41 and s242	Development permit	
c)	Provide a brief description of the proposal, in- applicable (e.g. six unit apartment building de			
d)	What is the level of assessment?			
	Impact assessment Code ass	essment		
	le C—Additional aspects of the application (If t arate table on an extra page and attach to this		ional aspects to the app	lication please list in a
	Refer attached schedule Not require	····		

2.	Location	of the pr	emises (Complet	te Table	D and/or Ta	able E as ap	oplicable	e. Identif	y ead	ch lot in a separate row.)
adjace	nt to the	premises		s to be u	ised for app	lications inv				the land adjoining or ering with water).
X	Str	eet addres	ss and lot on plan	(All lots	s must be lis	ted.)	·········			
			ı nd lot on plan fol water but adjoinir							
Street	address	i				Lot on pl descripti				cal government area . Logan, Cairns)
Lot	Unit no.	Street no.	Street name and suburb/ locality na		Post- code	Lot no.	Plan ty and pla			
i)		57	Davidson Stree Craiglie	t,	4877	57	C225	11		rns, Parish of Salisbury, unty of Solander
ii)										
iii)										
			(if the premises table. Non-mand		s multiple zo	nes, clearly	/ identify	the rele	vant	zone/s for each lot in a
Lot	Applicat	ele zone / pr	ecinct	Applic	able local pla	n / precinct		Applical	ble ov	verlay/s
i)	Port Do	uglas and	Environs	1	try Planning		_	Port Do	ougla	s and Environs Locality
				Servic	ce Industry F	recinct No	3		na Ar	ea Code: Industry
								!	_	Siting of Advertising
								Landso	•	-
								Vehicle	Pari	king and Access
ii)										
iii)										
adjoinir		acent to la	inates (Appropria nd e.g. channel d							t or in water not le if there is insufficient
Coordi (Note:		ch set of c	pordinates in a se	parate i	row)	Zone reference		tum		Local government area (if applicable)
Easting) N	orthing	Latitude	Lo	ngítude			···		
] GDA9	94	
								wgs	84	
								other		
3. Tota	l area of	the prem	ises on which th	e deve	lopment is	proposed ((indicate	square	metro	es)
2810 m	12									
4. Curr	ent use/	s of the p	remises (e.g. vac	ant land	d, house, ap	artment bu	ilding, c	ane farm	etc.)	<u></u>
Current at rear.		until three	years ago premi	ises was	s being used	l as takeaw	ay food	outlet an	id ve	hicle towing operation

5. Are there any current approvals (e.g. mandatory requirement)	a preliminary app	proval) associated	with this application? (Non-
No Yes—provide details belo	w		
List of approval reference/s	Date approved (dd/mm/yy)	Date approval lapses (dd/mm/yy)
6. Is owner's consent required for this a	pplication? (Refe	er to notes at the en	d of this form for more information.)
⊠ No			
Yes—complete either Table F, Table G o	r Table H as appli	cable	
Table F			
Name of owner/s of the land G-LC	Uchham Investi	newh Pt Ltd ATI	= Ge Cuelthan Siper Fund.
I/We, the above-mentioned owner/s of the land			4
Signature of owner/s of the land	7 11/16		
Date 14 th December 2013			
Table G	<u> </u>		
Name of owner/s of the land			
The owner's written consent is attached or	will be provided s	eparately to the ass	sessment manager.
Table H			
Name of owner/s of the land	,		
By making this application, I, the applicant, dec	lare that the owner	has given written con	sent to the making of the application.
7. Identify if any of the following apply to	the premises (T	ick applicable box/	es.)
Adjacent to a water body, watercourse or	r aquifer (e.g. cree	k, river, lake, canal)—complete Table I
On strategic port land under the <i>Transpo</i>	rt Infrastructure Ad	ct 1994—complete	Table J
In a tidal water area—complete Table K			
On Brisbane core port land under the Tra	ansport Infrastructi	ure Act 1994 (No ta	ble requires completion.)
On airport land under the Airport Assets	(Restructuring and	i Disposal) Act 2004	8 (no table requires completion)
Table I			
Name of water body, watercourse or aquifer			
Table J			
Lot on plan description for strategic port land		Port authority for t	ne lot
		-	

Tab	le K			
Nan	ne of local government for the tidal area	(if applicable)	Port author	ority for the tidal area (if applicable)
			# # # *	1.000
8.	Are there any existing easements o water etc)	n the premises?	(e.g. for vehic	cular access, electricity, overland flow,
	No X Yes—ensure the type, loca	ation and dimension	on of each ea	sement is included in the plans submitted
9.	Does the proposal include new buil services)	ding work or ope	erational wor	k on the premises? (Including any
	No Yes—ensure the nature, lo	ocation and dimen	sion of propo	sed works are included in plans submitted
10.	is the payment of a portable long se end of this form for more information.)		applicable to	this application? (Refer to notes at the
X	No-go to question 12 Yes			
11.	Has the portable long service leave information.)	levy been paid?	(Refer to note	es at the end of this form for more
	No			
	Yes—complete Table L and submit with receipted QLeave form	h this application t	he yellow loca	al government/private certifier's copy of the
Tab	le L			
Amo	ount paid	i	Date paid (dd/mm/yy)	QLeave project number (6 digit number starting with A, B, E, L or P)
12.	Has the local government agreed to section 96 of the Sustainable Planni		ded planning	g scheme to this application under
\boxtimes	No			
	Yes—please provide details below			
Nam	ne of local government	Date of written r by local governr (dd/mm/yy)		Reference number of written notice given by local government (if applicable)

13. List below all of the forms and supporting information that accompany this application (Include all IDAS forms, checklists, mandatory supporting information etc. that will be submitted as part of this application. Note: this question does not apply for applications made online using MyDAS)

or anachment	assessment manager
ndices:	
	All hard copy.
	1
Main Building - Ground Floor Proposed	PARAMANA
Main Building - First Floor Existing and Proposed	
Main Building - East and West Elevations	
Main Building - North and South Elevations	
Canopy - Plan	
Landscaping - Detail	
	Title Site Plan Carparking and Pedestrian Flows Main Building - Ground Floor Existing Main Building - Ground Floor Proposed Main Building - First Floor Existing and Proposed Main Building - East and West Elevations Main Building - North and South Elevations

14. Applicant's declaration

Description of attachment or title of attachment

By making this application, I declare that all information in this application is true and correct (Note: it is unlawful to provide false or misleading information)

Notes for completing this form

Section 261 of the Sustainable Planning Act 2009 prescribes when an application is a properly-made application.
 Note, the assessment manager has discretion to accept an application as properly made despite any non-compliance with the requirement to provide mandatory supporting information under section 260(1)(c) of the Sustainable Planning Act 2009

Applicant details

Where the applicant is not a natural person, ensure the applicant entity is a real legal entity.

Question 1

Schedule 3 of the Sustainable Planning Regulation 2009 identifies assessable development and the type of
assessment. Where schedule 3 identifies assessable development as "various aspects of development" the
applicant must identify each aspect of the development on Tables A, B and C respectively and as required.

Question 6

Section 263 of the Sustainable Planning Act 2009 sets out when the consent of the owner of the land is required
for an application. Section 260(1)(e) of the Sustainable Planning Act 2009 provides that if the owner's consent is
required under section 263, then an application must contain, or be accompanied by, the written consent of the
owner, or include a declaration by the applicant that the owner has given written consent to the making of the

Method of lodgement to

application. If a development application relates to a state resource, the application is not required to be supported by evidence of an allocation or entitlement to a state resource. However, where the state is the owner of the subject land, the written consent of the state, as landowner, may be required. Allocation or entitlement to the state resource is a separate process and will need to be obtained before development commences.

Question 11

- The Building and Construction Industry (Portable Long Service Leave) Act 1991 prescribes when the portable long service leave levy is payable.
- The portable long service leave levy amount and other prescribed percentages and rates for calculating the levy
 are prescribed in the Building and Construction Industry (Portable Long Service Leave) Regulation 2002.

Question 12

The portable long service leave levy need not be paid when the application is made, but the Building and
Construction Industry (Portable Long Service Leave) Act 1991 requires the levy to be paid before a development
permit is issued.

Building and construction industry notification and payment forms are available from any Queensland post office
or agency, on request from QLeave, or can be completed on the QLeave website at www.qleave.qld.gov.au. For
further information contact QLeave on 1800 803 481 or visit www.qleave.qld.gov.au.

Privacy—The information collected in this form will be used by the Department of State Development, Infrastructure and Planning (DSDIP), assessment manager, referral agency and/or building certifier in accordance with the processing and assessment of your application. Your personal details should not be disclosed for a purpose outside of the IDAS process or the provisions about public access to planning and development information in the *Sustainable Planning Act 2009*, except where required by legislation (including the *Right to Information Act 2009*) or as required by Parliament. This information may be stored in relevant databases. The information collected will be retained as required by the *Public Records Act 2002*.

		Reference nu	ımbers		
GAGE	MENT OF A PRIVA	TE CERTIFIER			
					e certifier for the
Name	e		BSA Certi number	fication license	Building classification/s
N AND	PAYMENT (For c	ompletion by as	sessment i	manager or private	e certifier if
;	QLeave project number	Amount paid (\$)	Date pa	Date receipte form sighted l assessment manager	
	Name	Name Name NAND PAYMENT (For conclusion) QLeave project	Council. I have building work Name NAME ON AND PAYMENT (For completion by as QLeave project Amount paid	Council. I have been eng building work referred to BSA Certif number Name BSA Certif number ON AND PAYMENT (For completion by assessment and Carte page 1) QLeave project Amount paid Date page 1)	Council. I have been engaged as the private building work referred to in this application Name BSA Certification license number NAND PAYMENT (For completion by assessment manager or private form sighted assessment number QLeave project Amount paid Date paid Session of the paid assessment assessment paid assessment number

The Sustainable Planning Act 2009 is administered by the Department of State Development, Infrastructure and Planning. This form and all other required application materials should be sent to your assessment manager and any referral agency.

Department of State Development, Infrastructure and Planning PO Box 15009 City East Qld 4002 tel 13 QGOV (13 74 68) info@dsdip.qld.cov.au

IDAS form 5—Material change of use assessable against a planning scheme

(Sustainable Planning Act 2009 version 3.0 effective 1 July 2013)

This form must be used for development applications for a material change of use assessable against a planning scheme.

You MUST complete ALL questions that are stated to be a mandatory requirement unless otherwise identified on this form.

For all development applications, you must:

- complete IDAS form 1—Application details
- complete any other forms relevant to your application
- provide any mandatory supporting information identified on the forms as being required to accompany your application.

Attach extra pages if there is insufficient space on this form.

All terms used on this form have the meaning given in the Sustainable Planning Act 2009 (SPA) or the Sustainable Planning Regulation 2009.

This form must also be used for material change of use on strategic port land and Brisbane core port land under the *Transport Infrastructure Act 1994* and airport land under the *Airport Assets (Restructuring and Disposal) Act 2008* that requires assessment against the land use plan for that land. Whenever a planning scheme is mentioned, take it to mean land use plan for the strategic port land, Brisbane core port land or airport land.

Mandatory requirements				
	use. (Note: this is to provide addition details. Attach a separate so			
General explanation of the proposed use	Planning scheme definition (include each definition in a new row) (non-mandatory)	No. of dwelling units (if applicable) or gross floor area (if applicable)	Days and hours of operation (if applicable)	No. of employees (if applicable)
Service industry	Special Management Area	507m2	12	4
	3. Service Industry			
	Precincts (Craiglie)			
2. Are there any current a	pprovals associated with the p	roposed material cha	inge of use?	
	val.) - (3) - (1 1 1 1 1 1 1 1 1 1 1 1 1 1 1 1 1 1			
✓ No Yes—prov	ride details below			
List of approval reference/s	Date approved (dd/mm/vv) D	ate approval laps	es (dd/mm/vv)



3. Does the proposed use involve the following? (Tick all applicable box	xes.)				
The reuse of existing buildings on the premises	Yes				
New building work on the premises	Yes				
The reuse of existing operational work on the premises \(\square\) No \(\sqrt{\sq}}}}}}}}}} \simptintition} \sqrt{\sq}}}}}}}}} \sqrt{\sq}}}}}}}}}} \signt{\sqrt{\sqrt{\sq}}}}}}}} \end{\sqrt{\sqrt{\sqrt{\sin}}}}}}} \end{\sqrt{\sqrt{\sqrt{\sqrt{\sqrt{\sqrt{\sq}}}}}}}}} \	Yes				
New operational work on the premises No Ves					
Mandatory supporting information					
4. Confirm that the following mandatory supporting information according	npanies this applica	ntion			
Mandatory supporting information	Confirmation of lodgement	Method of lodgement			
All applications					
A site plan drawn to an appropriate scale (1:100, 1:200 or 1:500 are recommended scales) which shows the following:	✓ Confirmed				
 the location and site area of the land to which the application relates (relevant land) the north point the boundaries of the relevant land any road frontages of the relevant land, including the name of the road the location and use of any existing or proposed buildings or structures on the relevant land (note: where extensive demolition or new buildings are proposed, two separate plans [an existing site plan and proposed site plan] may be appropriate) any existing or proposed easements on the relevant land and their function the location and use of buildings on land adjoining the relevant land all vehicle access points and any existing or proposed car parking areas on the relevant land. Car parking spaces for persons with disabilities and any service vehicle access and parking should be clearly marked for any new building on the relevant land, the location of refuse storage the location of any proposed retaining walls on the relevant land and their height the location of any proposed landscaping on the relevant land the location of any stormwater detention on the relevant land. 					
A statement about how the proposed development addresses the local government's planning scheme and any other planning instruments or documents relevant to the application.	Confirmed				
A statement about the intensity and scale of the proposed use (e.g. number of visitors, number of seats, capacity of storage area etc.).	✓ Confirmed				
Information that states:	✓ Confirmed				
 the existing or proposed floor area, site cover, maximum number of storeys and maximum height above natural ground level for existing or new buildings (e.g. information regarding existing buildings but not being reused) 	Not applicable				
 the existing or proposed number of on-site car parking bays, type of vehicle cross-over (for non-residential uses) and vehicular servicing arrangement (for non-residential uses). 					

A statement addressing the relevant part(s) of the State Development Assessment Provisions (SDAP).	☐ Confirmed ✓ Not applicable
When the application involves the reuse of existing buildings	
Plans showing the size, location, existing floor area, existing site cover, existing maximum number of storeys and existing maximum height above natural ground level of the buildings to be reused.	Confirmed Not applicable
When the application involves new building work (Including extensions)	
Floor plans drawn to an appropriate scale (1:50, 1:100 or 1:200 are recommended scales) which show the following:	✓ Confirmed
 the north point the intended use of each area on the floor plan (for commercial, industrial or mixed use developments only) the room layout (for residential development only) with all rooms clearly labelled the existing and the proposed built form (for extensions only) the gross floor area of each proposed floor area. 	
Elevations drawn to an appropriate scale (1:100, 1:200 or 1:500 are recommended scales) which show plans of all building elevations and facades, clearly labelled to identify orientation (e.g. north elevation)	☑ Confirmed
Plans showing the size, location, proposed site cover, proposed maximum number of storeys, and proposed maximum height above natural ground level of the proposed new building work.	Confirmed Not applicable
When the application involves reuse of other existing work	
Plans showing the nature, location, number of on-site car parking bays, existing area of landscaping, existing type of vehicular cross-over (non-residential uses), and existing type of vehicular servicing arrangement (non-residential uses) of the work to be reused.	✓ Confirmed Not applicable
When the application involves new operational work	
Plans showing the nature, location, number of new on-site car parking bays, proposed area of new landscaping, proposed type of new vehicle cross-over (non-residential uses), proposed maximum new vehicular servicing arrangement (non-residential uses) of the proposed new operational work.	Confirmed Not applicable
Privacy—Please refer to your assessment manager, referral agency and/or builduse of information recorded in this form.	ding certifier for further details on the
OFFICE USE ONLY	
Date received Reference numbers	

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Department of State Development, Infrastructure and Planning PO Box 15009 City East Qld 4002 tel 13 QGOV (13 74 68) info@dsdip.qld.gov.au



DEVELOPMENT APPLICATION

Development Permit for Material Change of Use for proposed refurbishment of existing building, and addition of vehicle wash bay at

Lot 57 C22511, Parish of Salisbury, County of Solander 57 Davidson Street, CRAIGLIE

For Gordon Wellham Lot 3 Captain Cook Highway. Craiglie, 4877 07 4098 5473

14th December 2013

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Landscaping Code

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1. SUMMARY AND SITE DESCRIPTION

1.1 Introduction

The proposal is to refurbish and add a new lease of life to what was the "Seamarkets" takeaway food store and seafood shop on the highway at Craiglie.

The purpose of the proposal is twofold:

- Exemplar Coaches and Limousines aims to relocate its expanding operations from Lot 3 Davidson St, Craiglie (immediately opposite the subject property). Administration and fleet management will be conducted on the upper floor; the yard will be used for parking and cleaning the fleet of limousines, people-movers and small (20 pax) coaches.
- Port Douglas Electrical Sales and Service, as a tenant, intends relocating from Lot 1 Davidson Street, Craiglie and utilise the ground floor of the building.

The scope of work includes:

- Renovating the existing offices on the mezzanine level.
- Adding additional offices, staff recreation room and female toilet to the upper level. (All under the existing roof.)
- Relocating the stairway to the position shown on Drawing 202.
- Stripping out the seafood processing and cooking equipment, freezer and cold room, and wall partitions on the ground floor to make way for an electrical-goods display and distribution centre.
- Adding a male toilet to the ground level.
- Relocating what was the canopy over the neighbouring Shell Service Station to the yard of No 57 to make a shelter for the washing, cleaning and
 polishing of Exemplar's vehicles.
- The footprint of the existing building will not be increased.

Strong emphasis will be on improving the appearance of what started life as a 'light industrial shed'.

Despite renovations in 2002, the building, and indeed the site in general, have become very tired. Modifications and enhancements to the site and building will aim to complement the high-quality development of the neighbouring bottle shop and the Shell Service Station. At Exemplar we strive for a very high quality of customer service; we aim to operate from a base that is equally as impressive.

The subject property is in the Port Douglas and Environs Locality. Each of the intended uses is a Service Industry

1.2 Site Description

The site is 2,810m² and is described as Lot 57 C22511 Parish of Salisbury, County of Solander.

The boundaries are:


- · Front 31.0 metres
- Rear 30.3 metres
- · Right 89.6 metres
- Left 96.7 metres

To the right (north) of the lot is the Court House Hotel Bottle Shop.

There is no development to the rear of the property.

Hanson Concrete extends along the rear half of the left boundary. The remainder of the left side is a triangular, 50 square metre parcel of land owned by Town and Country. This land is orphaned from the remainder of the Town and Country parcel by a 10 metre wide storm water easement.

Across the road (left to right) is Port Douglas Pool Supplies, the existing Exemplar Coaches and Limousine depot, and the 'Round House'.

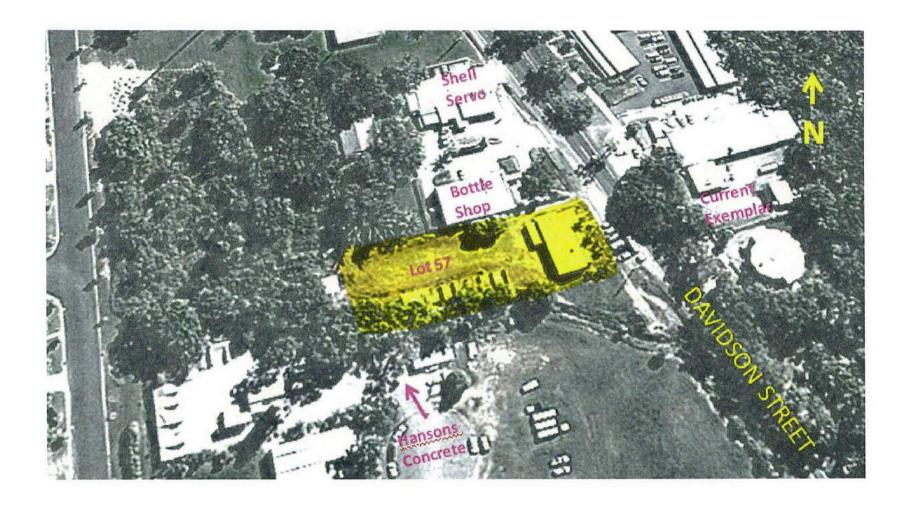



The Existing Building



The Canopy (from the Neighbouring Shell Service Station) to be re-erected

1.3 Summary of Non-Compliant Criteria

It is not possible to comply with all the mandates of the Douglas Shire Planning Scheme. The nature of the building itself (an all-metal 'light industrial shed' dating to the early 1980s), and its positioning close to the front boundary of the property presents particular challenges.

Nevertheless, this proposal attempts to meet/exceed as many requirements as possible. It complies with all acceptable solutions except, perhaps, for the following. Each criteria is dealt with in context below but, for ease of consideration, each is presented in a stand-alone format here. (Note the references relate to paragraph numbers in this document.)

2.1 General Requirements		
Development is connected to available urban services.	A 2.1 Development is connected to available urban services by underground connections wherever possible.	Compliant – continuing use rights apply The development is connected to all available urban services, however undergroun power is not available. Power remains above ground, as it has since 1982. All power along this section of Davidson Street remains on poles. Indeed the neighbouring, overhead power lines have very recently been replaced and upgraded.
2.3 Special Management Area 3	- Service Industry Precincts (Cra	aiglie)
Development on lots adjacent to the Captain Cook Highway is sited, designed and landscaped to provide an attractive visual approach to Port Douglas with all buildings, structures and car parking areas setback a sufficient distance from the Frontage to enable landscaping to screen or soften the appearance of the development	A29.2 The Setback area to the Captain Cook Highway Frontage is landscaped with advanced Dense Planting including trees species (100 litre bag stock), which will, at maturity, exceed the Height of the Building on Site.	Does not comply with acceptable solution. However complies with Performance Criteria. See Details at Section 4.2 below and Landscape Plan at Drawings 301 and 302.

6 metre setback.

Complies. Continuing-use rights apply.

With a setback of 6.9 metres, the building complied with the earlier requirement for a

A4.1 Buildings/structures on

sites with frontage to a State-

Controlled Road are Setback

8 metres from the Road

Frontage.

3.3 Design and Siting

The siting of industrial

other land uses.

Buildings/structures contributes

area and protects the amenity of

to the desired amenity of the

3.5 Landscaping and Amenity		
P6 Industrial Sites are landscaped to enhance the amenity of	A 6.2 Dense Planting along the Road Frontage is a minimum of 4 metres in width	Does not comply with acceptable solution. However complies with Performance Criteria.
industrial areas and provide a pleasant working environment33.	where adjacent to the Captain Cook Highway.	Constructed and developed in accordance with previous scheme's requirements
		See Details at Section 4.2 below and Landscape Plan at Drawings 301 and 302.

2. PORT DOUGLAS AND ENVIRONS LOCALITY CODE (INDUSTRY)

2.1 General Requirements

(Ref: p67)

PERFORMANCE CRITERIA	ACCEPTABLE SOLUTIONS	COMPLANCE APPRAISAL
Buildings and structures complement the Height of surrounding development, AND Buildings are limited to two Storeys; OR In the High Scale locations depicted on the Locality Plan, development of three Storeys is appropriate.	A1.1 The maximum height of the building is limited to 6.5 metres, with a roof high not to exceed 3.5 metres.	Compliant The current, and remaining, maximum height of the structure is 6.4 metres. The roof height will remain at 1.3 metres
Development is connected to available urban services.	A 2.1 Development is connected to available urban services by underground connections wherever possible.	Compliant – continuing use rights apply The development is connected to all available urban services, however underground power is not available. Power remains above ground, as it has since 1982. All power along this section of Davidson Street remains on poles. Indeed the neighbouring, overhead power lines have very recently been replaced and upgraded.

Landscaping of development sites complements the existing tropical seaside resort town character of Port Douglas and creates a dominant tropical vegetated streetscape.	A3.1 Landscaping of a development Site complies with Planning Scheme Policy No 7 – Landscaping, with particular emphasis on appropriate species for Port Douglas.	 Compliant Within the constraints of the building's positioning on the site, every effort will be made to: Conceal the original, ugly architectural design elements at the south end of the building Enhance the more aesthetically pleasing, new features on the northern end. Blend the landscaping with the new plantings at both the neighbouring bottle shop and at the new Shell Service Station. See Section 4.2 of this submission, and Drawings 301 and 302 for details
Development Sites are provided with efficient and safe vehicle Access and manoeuvring areas on Site and to the Site, to an acceptable standard for the Locality.	A 4.1 All Roads, driveways and manoeuvring areas on Site and adjacent to the Site are designed and maintained to comply with the specifications set out in the Planning Scheme Policy No 6 – FNQROC Development Manual.	Complies. Acceptable solution The footprint of development on the site represents only 18% of the total area of the (2,810 m2) site. The remainder of the site (apart from landscaped areas) is dedicated to client and company- vehicle parking, and vehicle manoeuvring. (This, after all, is the primary purpose/utilisation of the site.) There will be almost zero gradient across the entire site. All surfaces will be effectively drained and surfaced Each of the eight client car parking spaces, and ten of the spaces for Exemplar vehicles will be concreted/ bitumened. The remaining areas for additional company vehicles and the manoeuvring areas be constituted of clean, crushed aggregate. This is an acceptable solution that was approved in 2001 for Exemplar to use in its current site at Lot 3 Captain Cook Highway, shown here:



It has proved successful in both providing an adequate drainage solution and in also not walking grit and grime into company limousines and coaches.

Similarly, the crushed aggregate has proved successful in ensuring that:

 Drivers do not walk dust, mud or grit into vehicles (especially relevant to the limousines), and the vehicles egress to the main road with clean tyres. (Clear of mud and stones.)

The volume of traffic to and through the site will be relatively small.

Exemplar only has two to three staff on site at any one time.

Passengers do not embark/disembark at the site

The proposed tenant predominantly provides to trade customers; their visits are relatively infrequent, for large orders.

The expense of fully concreting/bitumening such a large expanse (approx 2,300 m²) would be unreasonable in terms of the nature and extent of the development of this site.

Routine maintenance of all parking and standing areas will be done (as it is at our

2.2 Other Development

(Ref: p 75)

Industrial development is limited to Service Industry and is	A19.1 Service Industry development is located in the	Complies.
located in existing or identified Industrial areas and is of a scale	identified Industrial areas of: • Special Management	The intended use is Service Industry.
and intensity of development which is acceptable in the Locality.	Area 3 - Service Industry Precincts (Craiglie); and • Special Management Area 4 - Service Industry Precincts (Mahogany Street)	The development is situated in Special Management Area 3, Service Industry Precincts (Craiglie).

current premises) to level, top-up and clean the aggregate surfaces.

2.3 Special Management Area 3 – Service Industry Precincts (Craiglie)

G		701
1	KOT.	n/41
А	Ref:	p79)

Development within the Craiglie Service Industry Precinct	A28.1 Only Service Industry uses are located	Complies.
supports the tourism and marine	in the Service Industry	There are two Service Industry proponents:
industries within Port Douglas.	Precincts (Craiglie).	Exemplar Coaches and Limousines.
	AND The proponent of the proposed Service	Exemplar has been operating in Port Douglas for 19 years, and has been based immediately opposite the subject property for 12 of those years. The company specialises in the coach and limousine transport of tourists to and from the resorts and accommodation houses of Port Douglas and Palm Cove.
	Industry use provides written evidence to Council that it	Port Douglas Electrical Sales and Services.
	supports/services the tourism or marine industry in Port Douglas.	This leading company has operated for over thirty years in Port Douglas, the majority of the time having been based at Lot 1, Davidson Street. (150 metres from the subject property). Port Douglas Electrical provides electrical equipment to trades people who service tourist accommodation, restaurants and the marine industry.
Development on lots adjacent to the Captain Cook Highway is	A29.1 Buildings and structures are setback 8	Complies – continuing use rights apply
sited, designed and landscaped to provides an attractive visual approach to Port Douglas with all buildings, structures and car parking areas setback a sufficient distance from the Frontage to enable landscaping	metres from the Captain Cook Highway Frontage, or no closer to the Captain Cook Highway Frontage than buildings and structures on adjoining Sites (averaged), whichever is the greater.	With a setback of 6.7 metres, the building complied with the earlier requirement for a six metre setback.
to screen or soften the	A29.2 The Setback area to	Does not comply with acceptable solution. However complies with
appearance of the development.	the Captain Cook Highway Frontage is landscaped with	Performance Criteria.
	advanced Dense Planting including trees species (100 litre bag stock), which will, at maturity, exceed the Height of the Building on Site.	See Landscape Plan at Drawings 301 and 302.

A29.3 Advertising signs are discreet in appearance with no	Complies. Acceptable solution.
large advertising signs including tenancy signs located on or near the Captain Cook Highway Frontage, or within any landscaped setback area adjacent to the highway.	Signs will be discreet, minimum in number, and set well back from the highway and within the landscaped setback. See Drawings 204 and 205 for intended signs
A29.4 Car parking areas, loading and other	Complies. Acceptable solution.
service areas are designed to be screened from the Captain Cook Highway and are located so as not to be visually prominent from the Captain Cook Highway.	All such areas will be at the rear of the building. See Drawing 102

3. PLANNING AREA CODE: INDUSTRY

3.1 Consistent and Inconsistent Uses

(Ref: p138)

P1 The establishment of uses is consistent with the outcomes sought for the Industry Planning Area.	A1.1 Uses identified as inconsistent uses in the Assessment Table are not established in the Industry Planning Area.	Complies. Acceptable solution. No inconsistent uses will be undertaken.
P2 A Caretaker's Residence is only established in association with an industrial use or activity operating	A2.1 Only one Caretaker's Residence is established on the parent Site in association with an industrial use or activity located on one industrial allotment identified on a Standard Format Plan.	Complies. Acceptable solution. There is no intention to have a Caretaker's Residence, nor any other form of on-site residence.

3.2 Site Coverage

(Ref: p138)

The Site Coverage of Buildings ensures that there is sufficient area for the	A3.1 The Site Coverage of all Buildings does not exceed 60% of the Site area	Complies. Acceptable solution.
provision of services and Landscaping	The Three water to the part of	The site coverage will be only 18% . (507m ² of 2,810 m ²⁾
		See Drawing 101 (Site Plan)

3.3 Design and Siting

(Ref: p138)

The siting of industrial Buildings/structures contributes to the desired amenity of the	A4.1 Buildings/structures on sites with frontage to a State-Controlled Road are Setback 8 metres	Complies. Continuing-use rights apply.
area and protects the amenity of other land	from the Road Frontage.	With a setback of 6.9 metres, the building
uses.		complied with the earlier requirement for a 6 metre
		setback.

3.4 Loading and Unloading Facilities

(Ref: p140)

P5 The transport of goods and materials to and from industrial Sites does not adversely affect the movement of traffic on the Roads adjacent to the Site.	A5.1 All delivery/pick up vehicles are contained wholly within the Site when being loaded/unloaded.	Complies. Acceptable solution. All delivery/pickup vehicles have flat, unobstructed access to the site, with a clear view both left and right. All deliveries and pickups will be done at the rear
	A.S. O. C. officient annual in a case in	of the premises. See Drawing 102 - Car Parking and Pedestrian Flows
	A5.2 Sufficient manoeuvring area is provided on Site to allow a single unit	Complies. Acceptable solution.

truck to ingress and egress the Site in a forward gear.	An unobstructed, 17-meter diameter turning space is available adjacent to the loading/unloading area. See Drawing 102
A5.3 Site Access is limited to one Access point for each street Frontage.	Complies. Acceptable solution. See Drawing 102

3.5 Landscaping and Amenity

(See also Section 4.2 below)

(Ref: p 141)

P6 Industrial Sites are landscaped to enhance the amenity of industrial areas and provide a pleasant working environment.	A6.1 A minimum of 20% of the area of the Site is landscaped.	Complies. Acceptable solution. Intended area of landscaping will cover 22% See Drawings 301 and 302
	A 6.2 Dense Planting along the Road Frontage is a minimum of 4 metres in width where adjacent to the Captain Cook Highway.	Does not comply with acceptable solution. However complies with Performance Criteria. Constructed and developed in accordance with previous scheme's requirements See detailed landscape plan. Drawings 301 and 302
	A6.4 Areas used for loading and unloading, storage, utilities and car parking are screened from public view by a combination of Landscaping and screen fencing.	Complies. Acceptable solution. Unloading and loading will be done out of sight, at the rear of the building. See Drawing 102
P7 Industrial areas are not characterised by a proliferation of advertising signs and/or the use of large advertising signs.	A7.1 Signage complies with the Design and Siting of Advertising Devices Code. And No wall signs are located on the walls of industrial Buildings facing the Captain Cook Highway or any other	Complies. Acceptable solution.

State-Controlled Road.	

4. OVERLAYS - OTHER ELEMENTS OF THE CODE:

4.1 Miscellaneous

Acid Sulphate Soil	(Ref: p158)	Not applicable. This proposal does not involve any disturbance of Acid Sulphate Soils.
Cultural Heritage and Valuable Sites	(Ref: p160)	Not applicable
Natural Hazards	(Ref: p165)	Not applicable
Land Use Code	(Ref: p171)	Not applicable
Advertising Devices	(Ref: p237)	Complies. Acceptable solution.
Filling and Excavation Code	(Ref: p245)	Not applicable There will be no fill or excavation work.
Natural Areas and Scenic Amenity	(Ref: p257)	Not applicable
Vehicle Parking and Access	(Ref: p278)	Complies. Acceptable solution.
Sustainable Development	(Ref: p293)	Not applicable

4.2 Landscaping Code (Ref: p248)

4.2.1 Overview

Given the close proximity of the main building to the front boundary (at 6.7m) much closer than the neighbouring bottle shop (at and the (existing) protruding toilet block, it will be difficult to establish further front buffering than indicated in this plan.

A dominant consideration is that of the safety of vehicles entering and egressing the property

The primary objectives are to:

- Hide the toilet complex and southern wall to the maximum extent possible with vegetation.
- Buffer the northern end to a moderate level, but enhance the architectural features of the building to achieve a pleasing streetscape. Within the constraints of what was an industrial shed, try to achieve a 'Queenslander' theme:
 - a formal, symmetrical architectural style
 - light (white-ish) colour paint scheme
 - extensive use of lattice
 - incorporation of a traditional bull-nose verandah across the entire front of the building.
- Achieve synergies in streetscape appeal with the neighbouring bottle shop and Shell Service Station by planting in a common style and by removing the front section of the common fence to expose a 'shared hedge'.
- Soften the landscaping/facade by removing:
 - shade-sail poles,
 - a large, concrete (outdoor dining) slab. This will also remove a large heat-sink that radiates heat into the adjacent windows,
 - a large area of brick pavers,
 - the Black Stump (a three metre high, one metre diameter log at the front of the building)

Frontage of Lot 57 looking south



Frontage of the bottle shop, looking south towards Lot 57.....





4.2.2 <u>Details</u>

Landscape Design	
4. Landscape design satisfies the purpose and the detailed requirements of the Code.	The landscaping will be constructed and maintained in alignment with all relevant requirements as set out in the Code and Planning Scheme Policy No 7 – Landscaping.
Landscape – Character and Planning	
5. Landscaping contributes to a sense of place, is functional to the surroundings and provides dominant visual interest and form.	The landscaping comprises of stepped layers with higher plants towards the building, and ground covers closer to the verge, this not only adds to an aesthetically pleasing frontage, but ensures the safety of those entering and exiting the premises. Native plants and those similar to neighbouring properties are used to ensure a uniformed streetscape and a consistent flora palette to that of the natural surround.
6. Landscaping is consistent with the existing landscape character of the area and native vegetation existing on the Site is to be retained wherever possible and integrated with new Landscaping.	As the site is bare of vegetation (except for mature trees), the importation of plants is needed. The four existing palms will be retained at the front to enable a multi layered landscape. Plants being brought in will include those endemic to the area as well as used by neighbouring properties.
7. Plant species are selected with consideration to the scale and form of development, screening, buffering, streetscape, shading and the locality of the area.	The species selected for this landscape have been chosen for their aesthetic, acoustic, safety and maintenance benefits. They have also been chosen in accordance with the Planning Scheme Policy No 7 – Landscaping.

8. Shade planting is provided in car parking areas where	No extra trees will be planted in the car park area as all spaces are undercover.
uncovered or open, and adjacent to driveways and	The driveways and internal roadways have insufficient clearances for trees to be
internal Roadways.	10 10 10 10 10 10 10 10 10 10 10 10 10 1
	planted to ensure the safety of drivers and pedestrians.
	All garden beds next to driveways are protected by garden edging.
Screening	
9. Fences along street Frontages are articulated with	No fences are proposed for this landscaping project, however a low hedge to match
appropriate Landscaping.	that of the neighbouring property will be installed.
10. Landscaping within Recreation Areas of residential	Not applicable.
development are functional, well designed and enhance	
the residential amenity.	
11. Undesirable features are screened with	A large wooden screen is proposed for the left of the building to hide the ground
Landscaping.	level office. This screen will then be curtained by a dense multi-layered canopy
	tapering out to the right to ensure a clear site of the entry way and sightlines for the
	driveway.
12. The environmental values of the Site and adjacent	The landscaping uses similar plants as to those in adjoining land and to those in the
land are enhanced.	natural surrounds.
Streetscape and Site Amenity	
13. Landscaping for residential redevelopment	Not applicable.
enhances the streetscape for the visual appearance of	
the development.	
14. Landscaping for non-residential development	Landscaping this site will enhance the aesthetic properties of this development by
enhances the streetscape and the visual appearance of	ensuring a uniformed streetscape is kept with the surrounding buildings and the

the development.	native flora.
	Dense planting will be used to hide walls and as much of the building front as possible, while maintaining the security of the building and safety of its users. Low ground covers and mulch will be used in areas of the landscape in which sight lines
	need to be kept un-obstructed.
	Existing trees will be retained in the front and rear of the building.
Maintenance and Drainage	
15. Landscaped areas are designed in order to be maintained in an efficient manner.	The landscape design has been created to not only ensure it is maintained in an efficient manner, but an effective manner also.
	Access to all areas is made easy by the use of the gravel swale, and hidden paths. There will be minimal grass installed, to ensure no mowing is necessary. Gardens will be mulched to minimise weed growth and plants will only need to be pruned to keep their shape.
16. Stormwater runoff is minimised and re-used in Landscaping through water infiltration, where appropriate.	Gravel swales are being placed around the entire front boundary of the building, this will collect the water runoff from the hard surfaces, in addition to this, shallow swales will be placed along the boundary of the front entrance path to not only capture water from the pavement, but ensure water does not pool eliminating a safety hazard.
	Hardstands are kept at a minimum and are only being installed to ensure movement across the site can be done safely.
	In addition to this, a space has been allocated behind the wooden screen for the future installation of a rain water tank, to enable the use of water harvesting from


	the roof line.
Safety	
17. Tree species and their location accommodate vehicle and pedestrian sight lines.	No additional trees will be installed during this landscape project. The existing palm trees are outside of the vehicle and pedestrian sight lines.
18. The landscape design enhances personal safety and reduces the potential for crime and vandalism.	The landscape design enhances personal security by ensuring the entry is clearly visible from the street.
	Plants within sight lines are of the low growing variety to ensure movement around the premises is also done in a safe manner.
	In addition to this, the gravel swale will also act as a clear passage around the building in which security lights and surveillance cameras can operate without being obstructed by vegetation.
Utilities and Services	J
19. The location and type of plant does not adversely affect the function and accessibility of services and facilities and service areas.	There are no major services within the landscaped area. All service pits will be kept free from vegetation, and access will be unrestricted ensure ease of servicing when necessary.

5. APPENDICES

Drawings

NUMBER	TITLE
101	Site Plan
102	Carparking and Pedestrian Flows
201	Main Building - Ground Floor Existing
202	Main Building - Ground Floor Proposed
203	Main Building - First Floor Existing and Proposed
204	Main Building - East and West Elevations
205	Main Building - North and South Elevations
206	Canopy - Plan
207	Canopy - Elevations
301	Landscaping - Overview
302	Landscaping - Detail

COURT HOUSE HOTEL BOTTLE SHOP

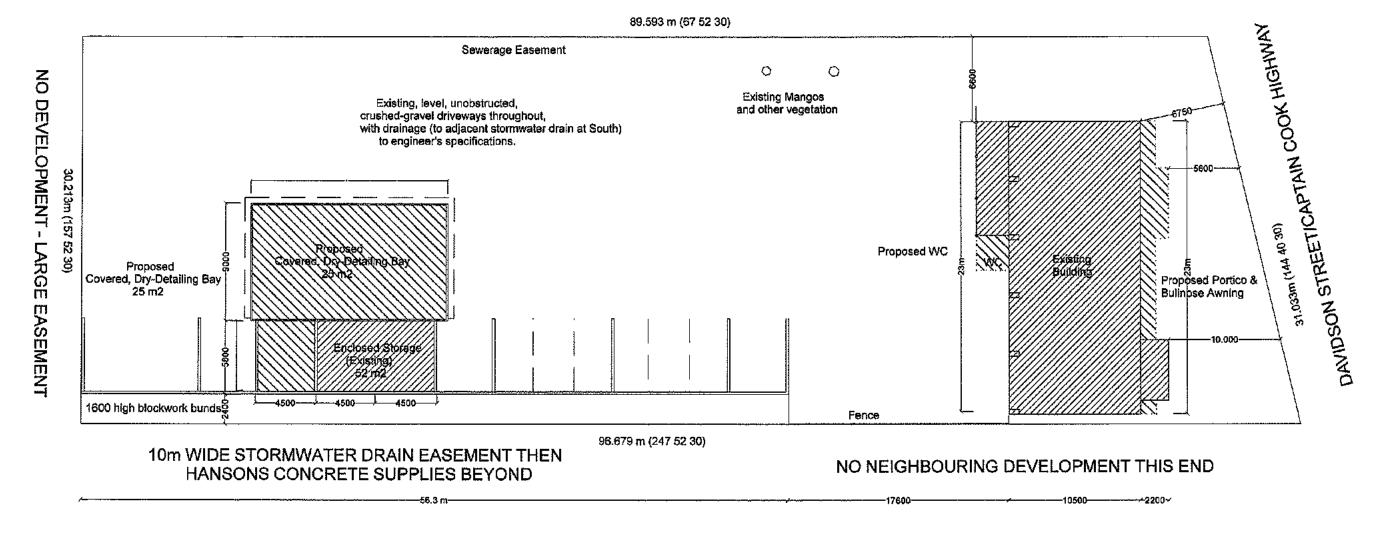

 SITE
 Total site area:
 2,810 m2

 UTILISATION
 Utilised area:
 Percentage Utilisation:

 Existing
 290 + 52 = 342
 507 m2 / 2810 m2
 18%

 Proposed
 142 + 25 = 165
 507 m2






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Lot 57 Captain Cook, Highway, Craiglie Title Reference 20780231

SITE PLAN

Issue	Rev	Date
DA Submission	Α	06DEC13
	1.	
Drawing Number	101	

COURT HOUSE HOTEL BOTTLE SHOP

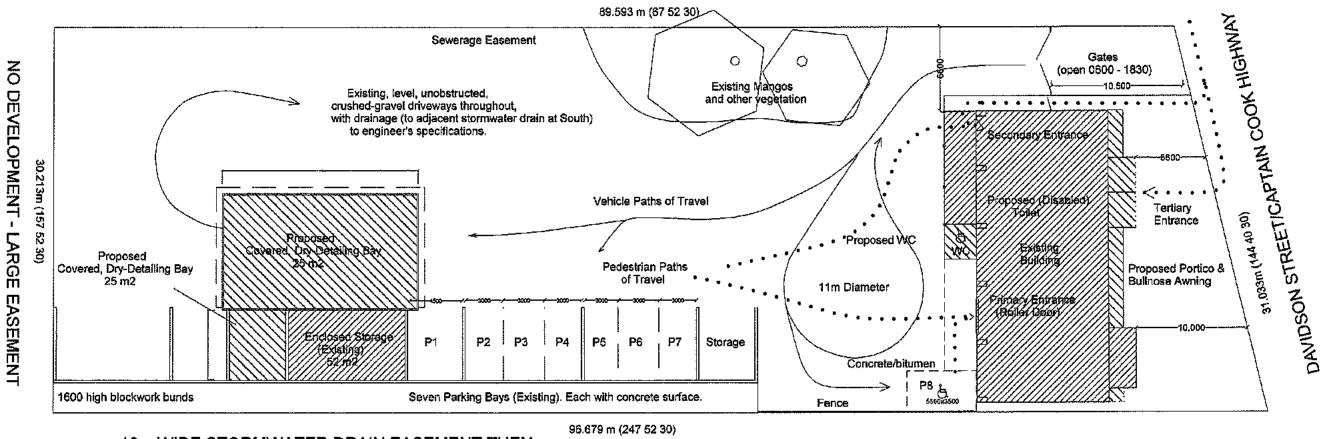

10m WIDE STORMWATER DRAIN EASEMENT THEN HANSONS CONCRETE SUPPLIES BEYOND

NO NEIGHBOURING DEVELOPMENT THIS END

CARPARKING Net Letable Area Main building t Main building t Storage and d

Main building first floor 180
Main building ground floor 224
Storage and detailing areas 77
48

Requirement : One per 90m2 of net letable area 481/90 = 5.3 (That is, 6 spaces)
Actual: 8 spaces, including one Disabled

EXEMPLAR

COACHES and LIMOUSINES




Scale: As Shown

Lot 57 Captain Cook, Highway, Craiglie Title Reference 20780231

CARPARKING and PEDESTRIAN FLOWS

Issue	Rev	Date
DA Submission	Α	06DEC13
Drawing Number	102	
	DA Submission	DA Submission A

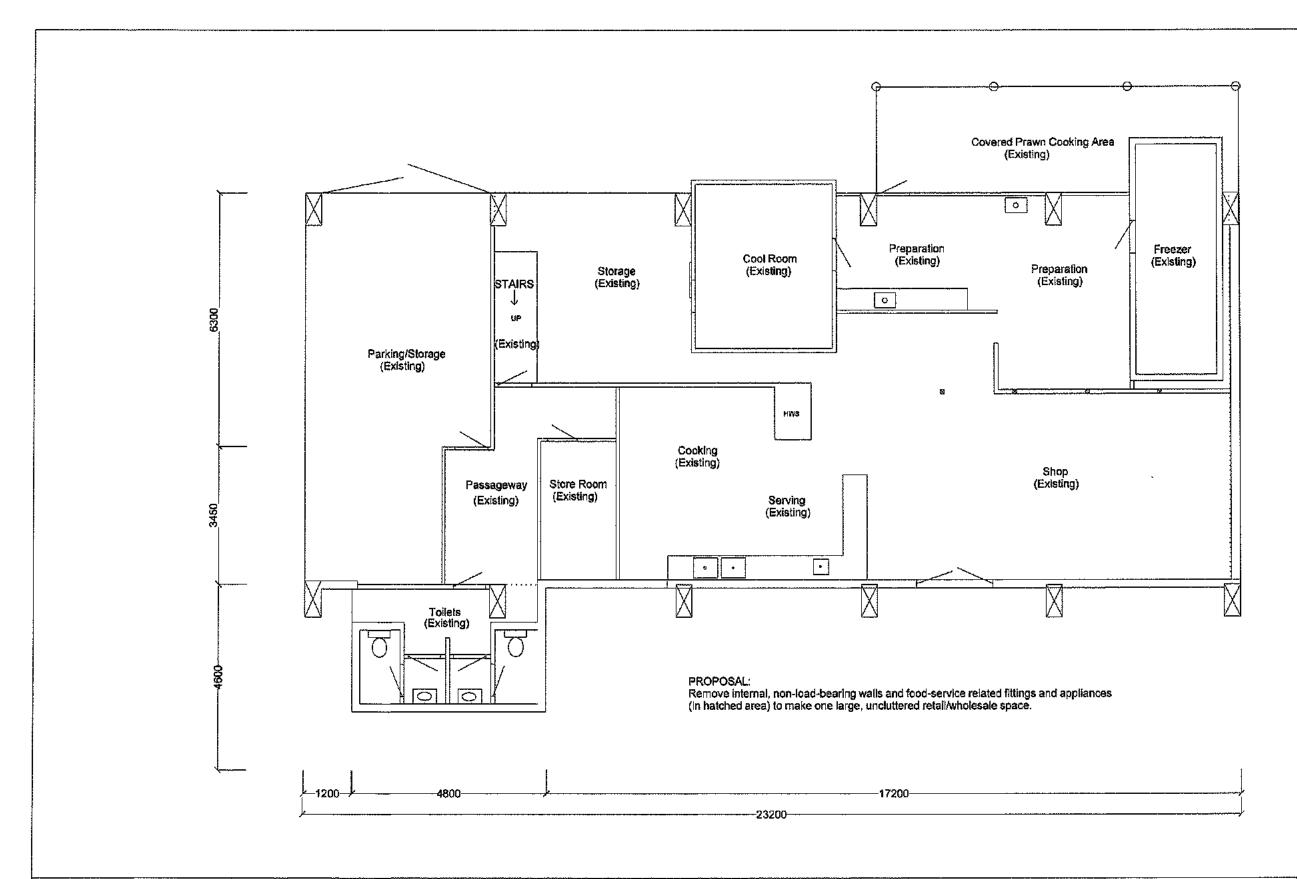






Lot 57 Captain Cook, Highway, Craiglie Title Reference 20780231

GROUND FLOOR EXISTING

	Issue	Rev	Date
	DA Submission	Α	06DEC13
-			
-			
-	Drawing Number	201	

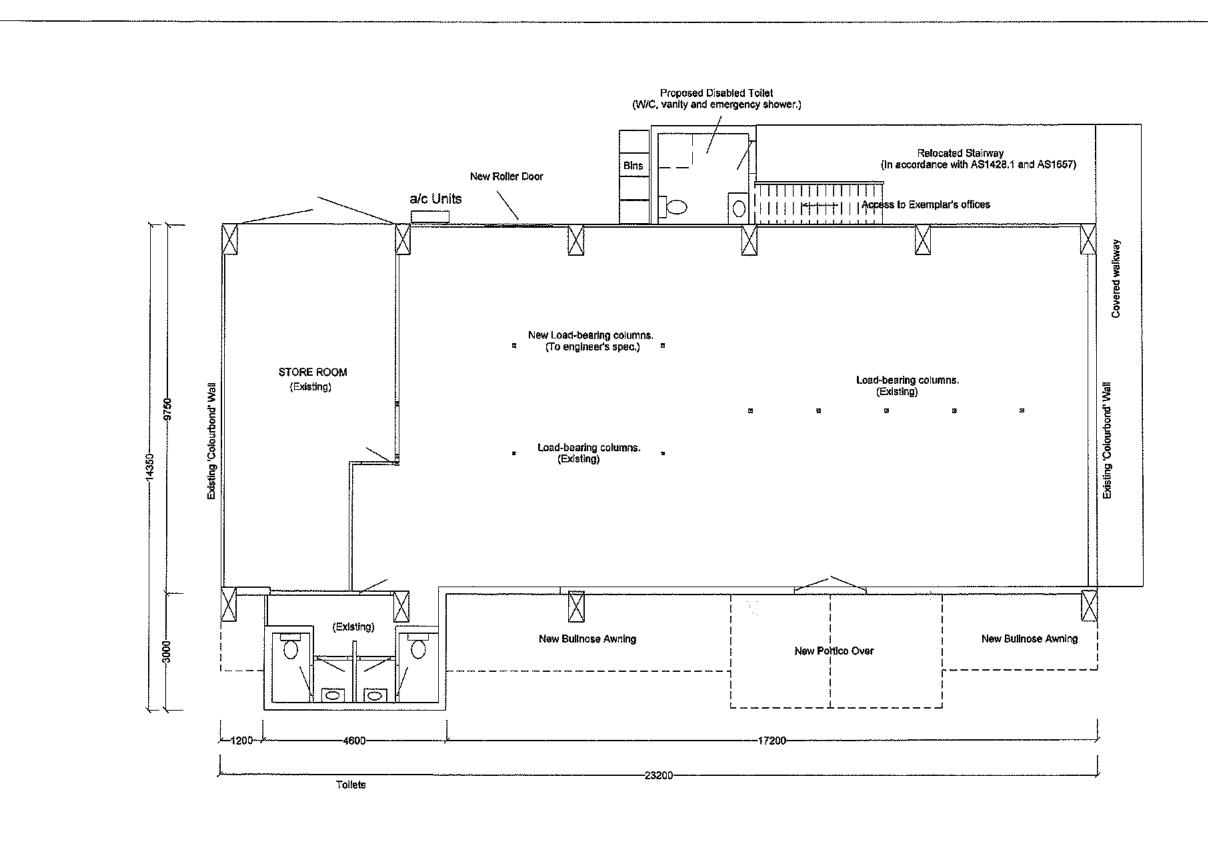






Lot 57 Captain Cook, Highway, Craiglie Title Reference 20780231 GROUND FLOOR PROPOSED

Issue	Rev	Date
DA Submission	Α	06DEC13
Drawing Number	202	

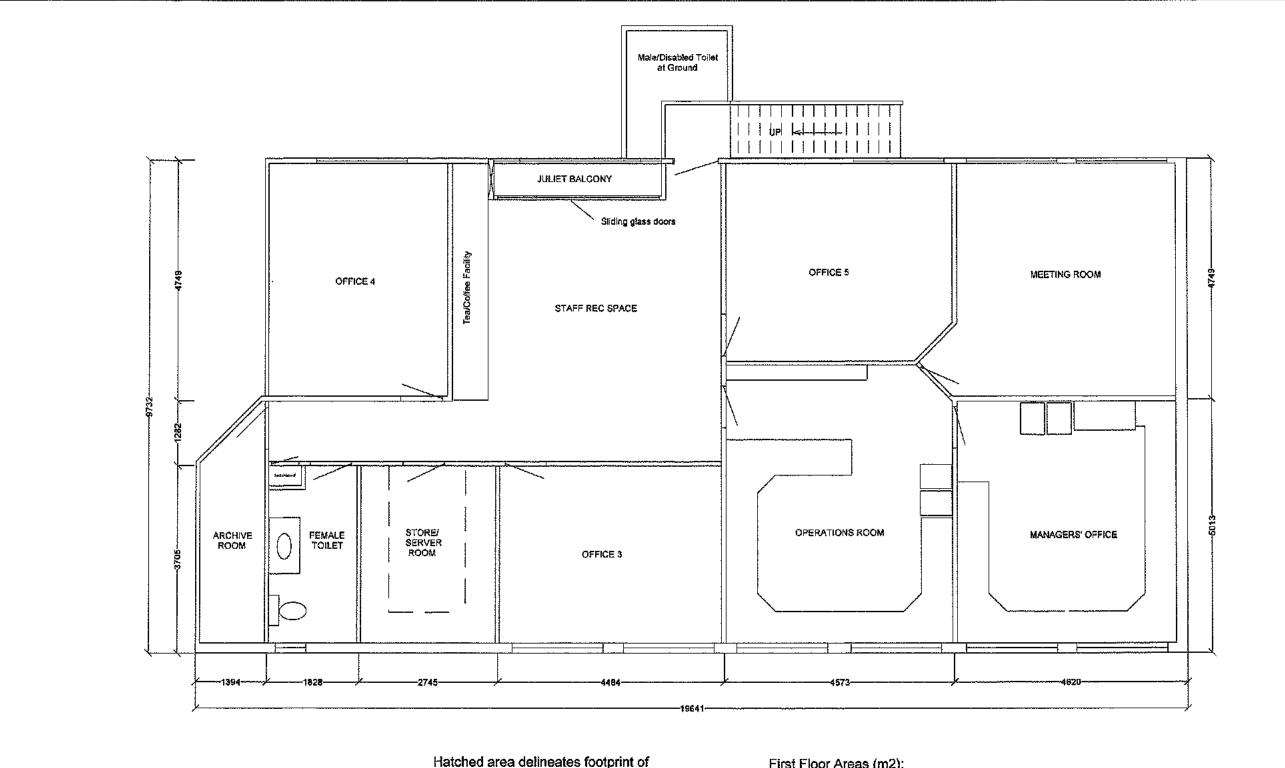

Hatched area delineates footprint of existing, approved development.

All rennovations are under existing roof-line.

First Floor Areas (m2): Existing 91.5 Proposed 82.7 Total 173.2







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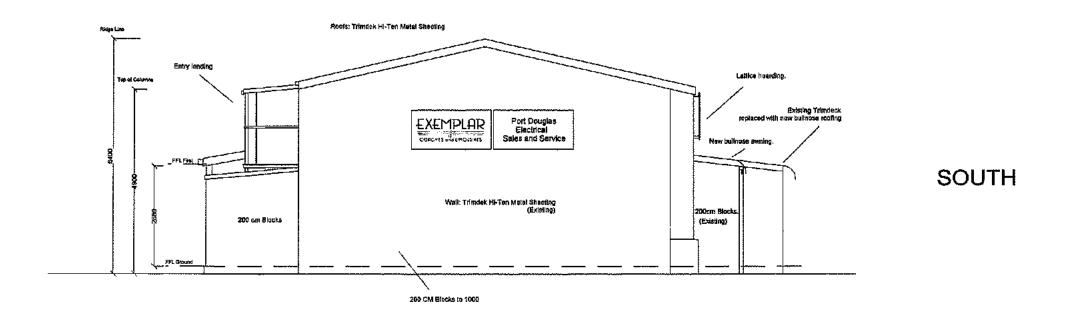
Lot 57 Captain Cook, Highway, Craiglie Title Reference 20780231

FIRST FLOOR **EXISTING AND PROPOSED**

Issue	Rev	Date
DA Submission	Α	01 DEC 13
Drawing Number	203	



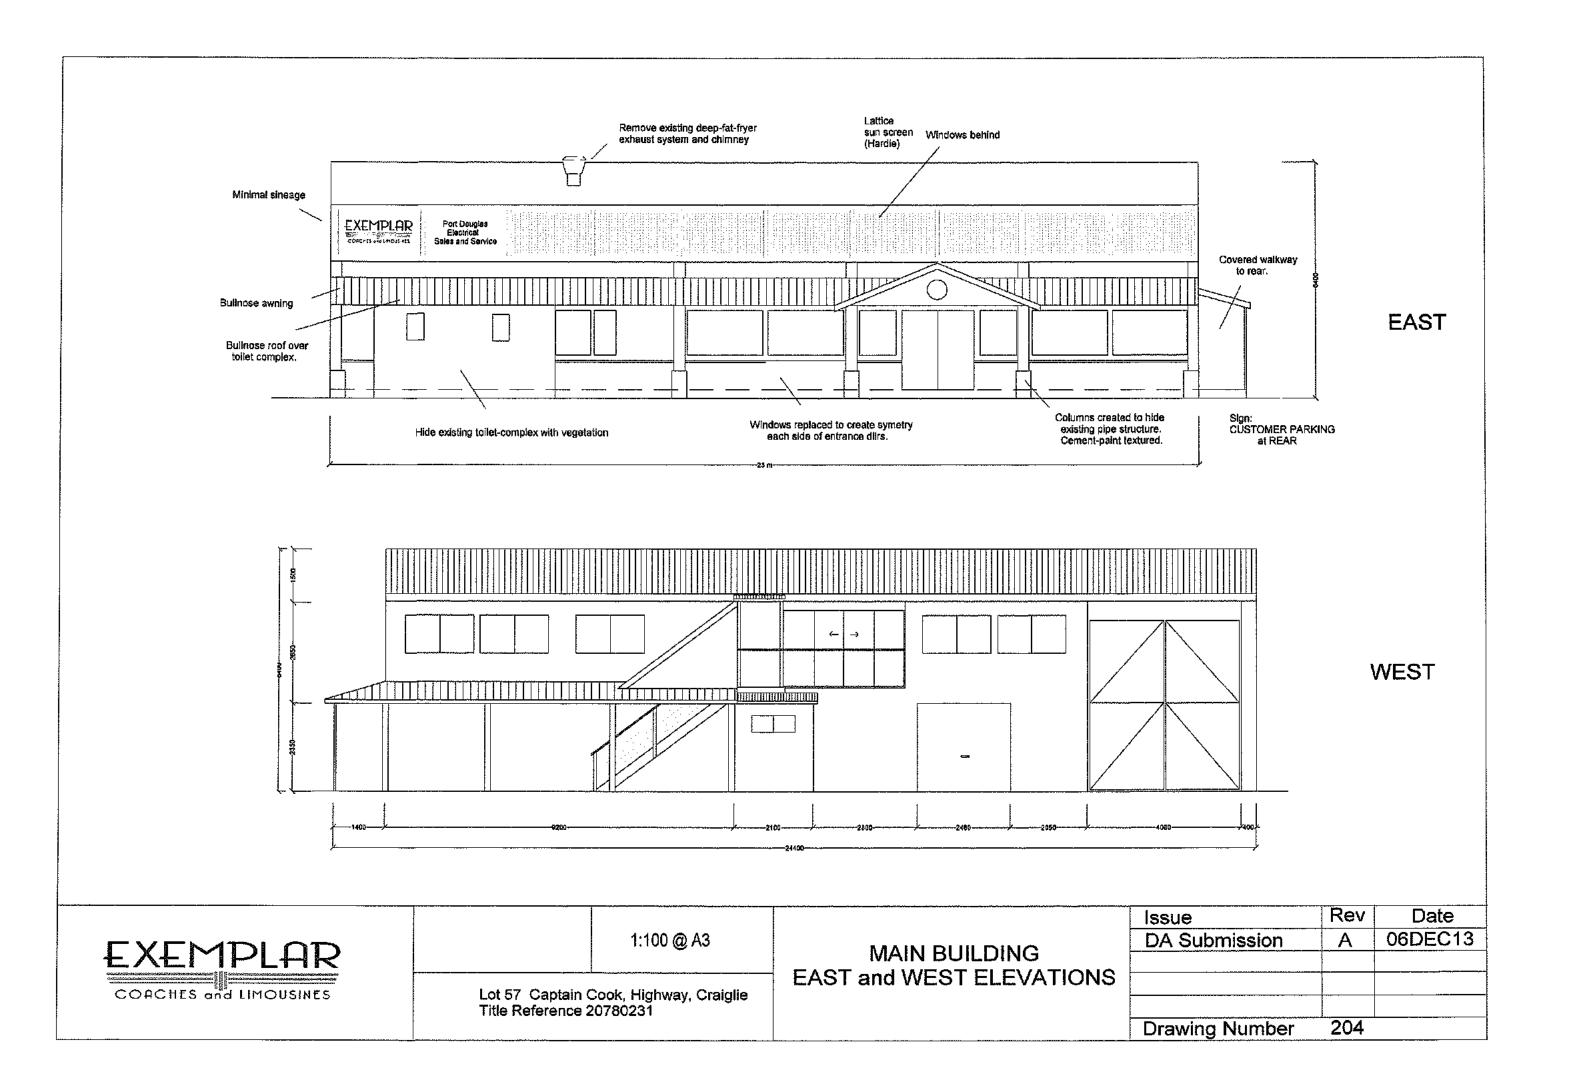


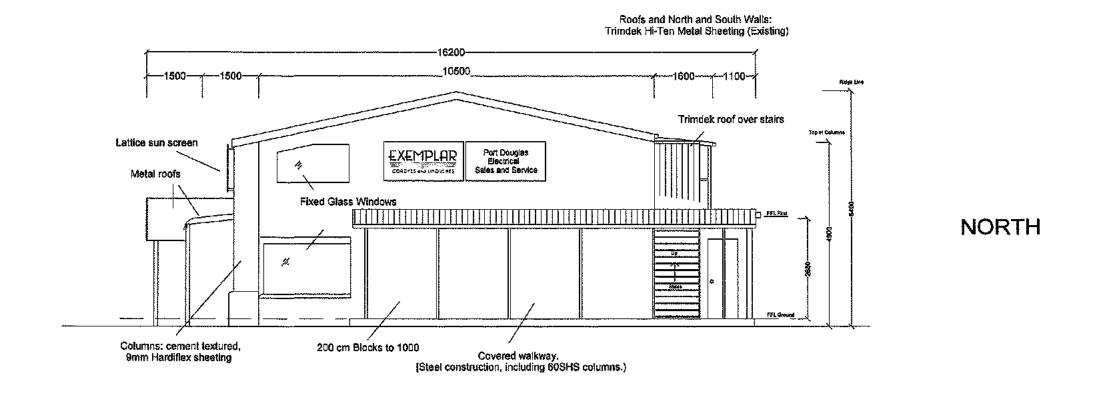



Lot 57 Captain Cook, Highway, Craiglie Title Reference 20780231 MAIN BUILDING NORTH and SOUTH ELEVATIONS

Issue		Rev	Date
DA Submi	ssion	Α	06DEC13
Drawing N	umber	205	

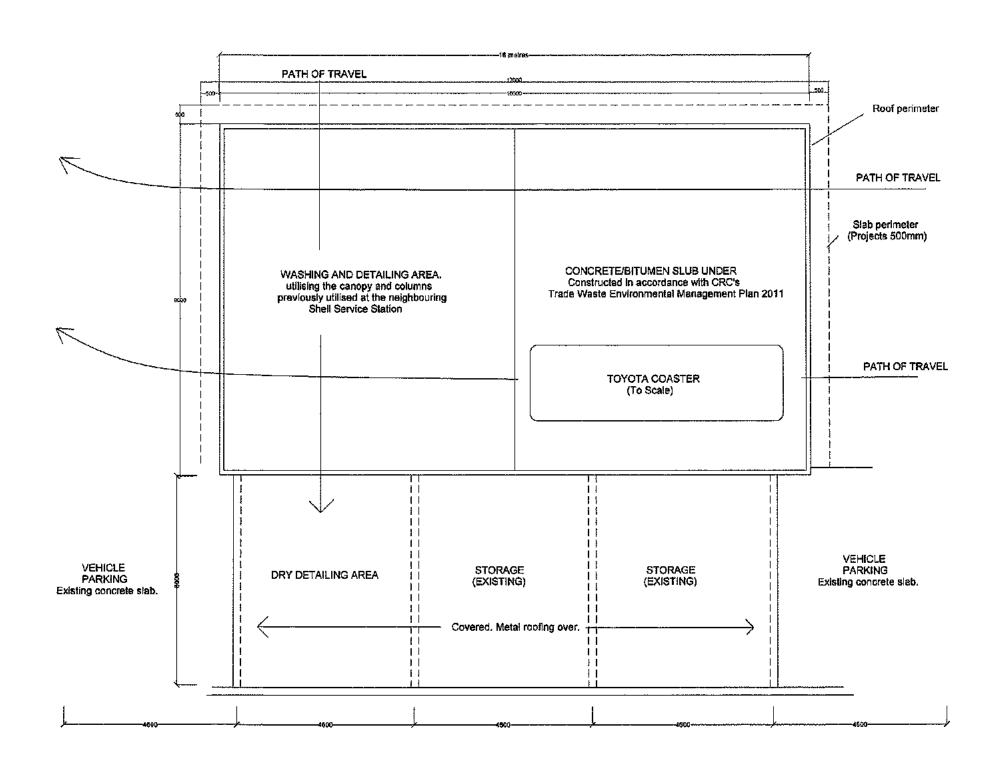






Lot 57 Captain Cook, Highway, Craiglie Title Reference 20780231 **CANOPY PLAN**

Issue	Rev	Date
DA Submission	Α	06DEC13
Drawing Number	206	

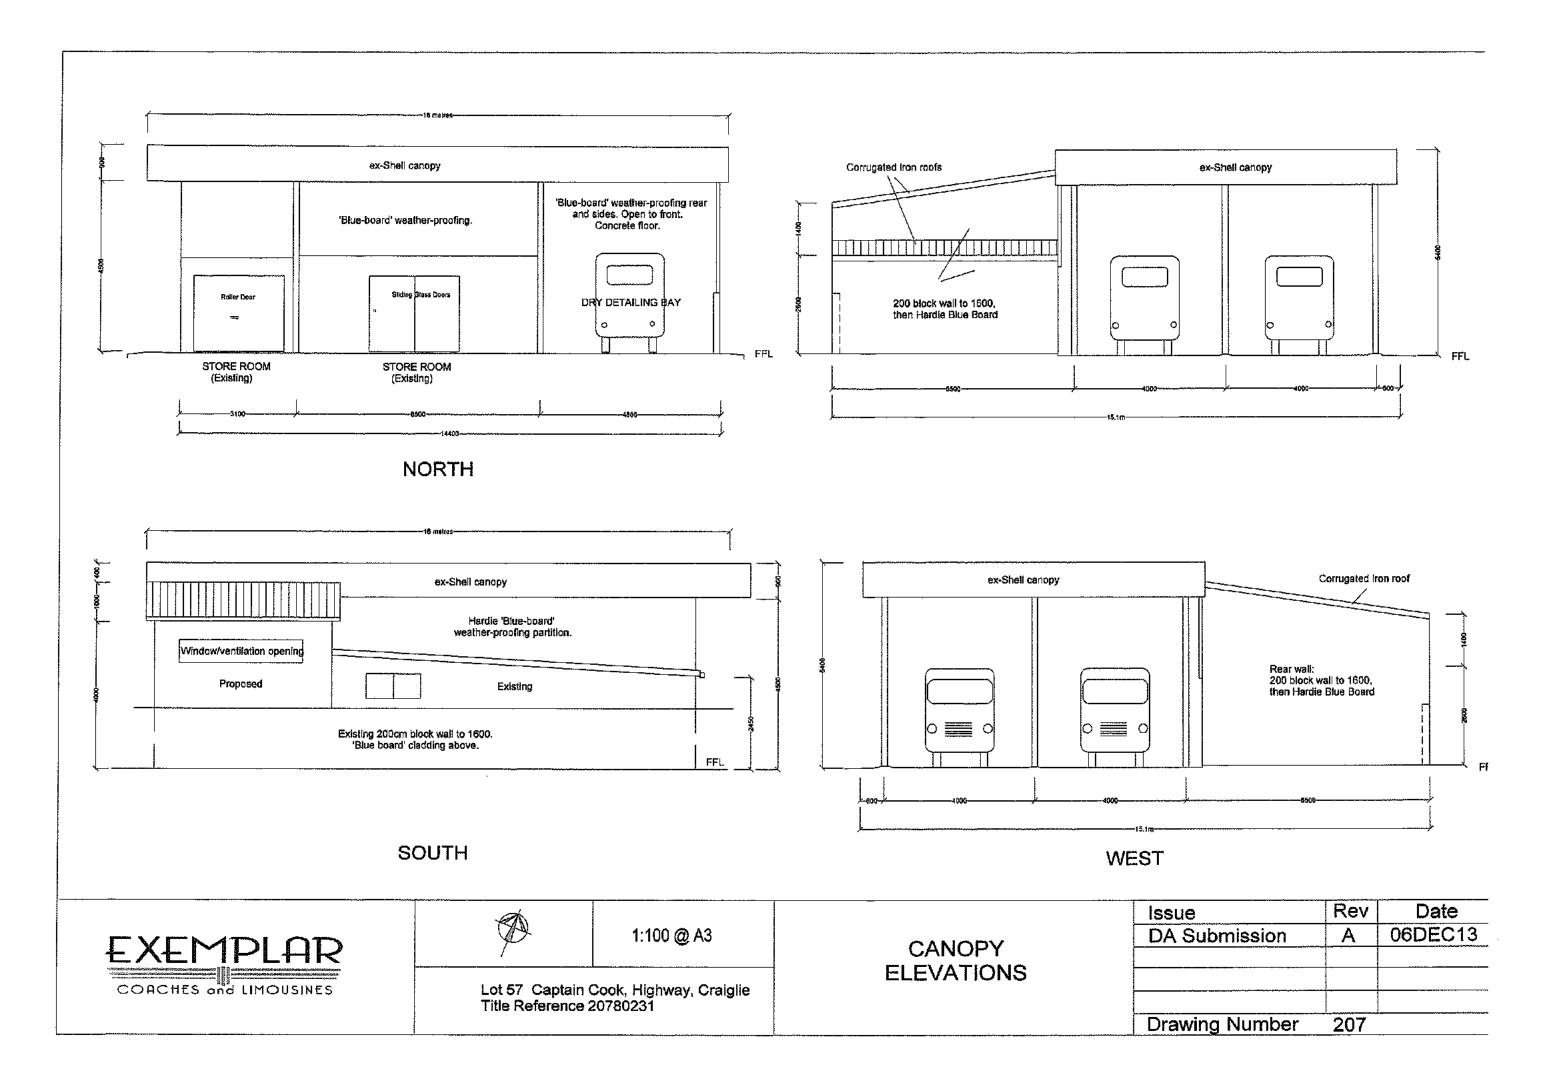

COURT HOUSE HOTEL BOTTLE SHOP DAVIDSON STREETICAPTAIN COOK HIGHWAY Gates (open 0600 - 1830) NO DEVELOPMENT - LARGE EASEMENT Existing manges and vegetation beneath. 187 m2 30.213m (157 52 30) ф wc Existing Building Proposed Canopy 240 m2 See detailed drawing. à Existing mature, high vegetation. 182 m2 Metal Fence Existing plantings in easement. To hide fence. 96.679 m (247 52 30) 10m WIDE STORMWATER DRAIN EASEMENT THEN NO NEIGHBOURING DEVELOPMENT THIS END HANSONS CONCRETE SUPPLIES BEYOND LANDSCAPING 2,810 m2 Total site area: Landscape coverage: 187 + 240 + 182 =

609 m2

21.7%






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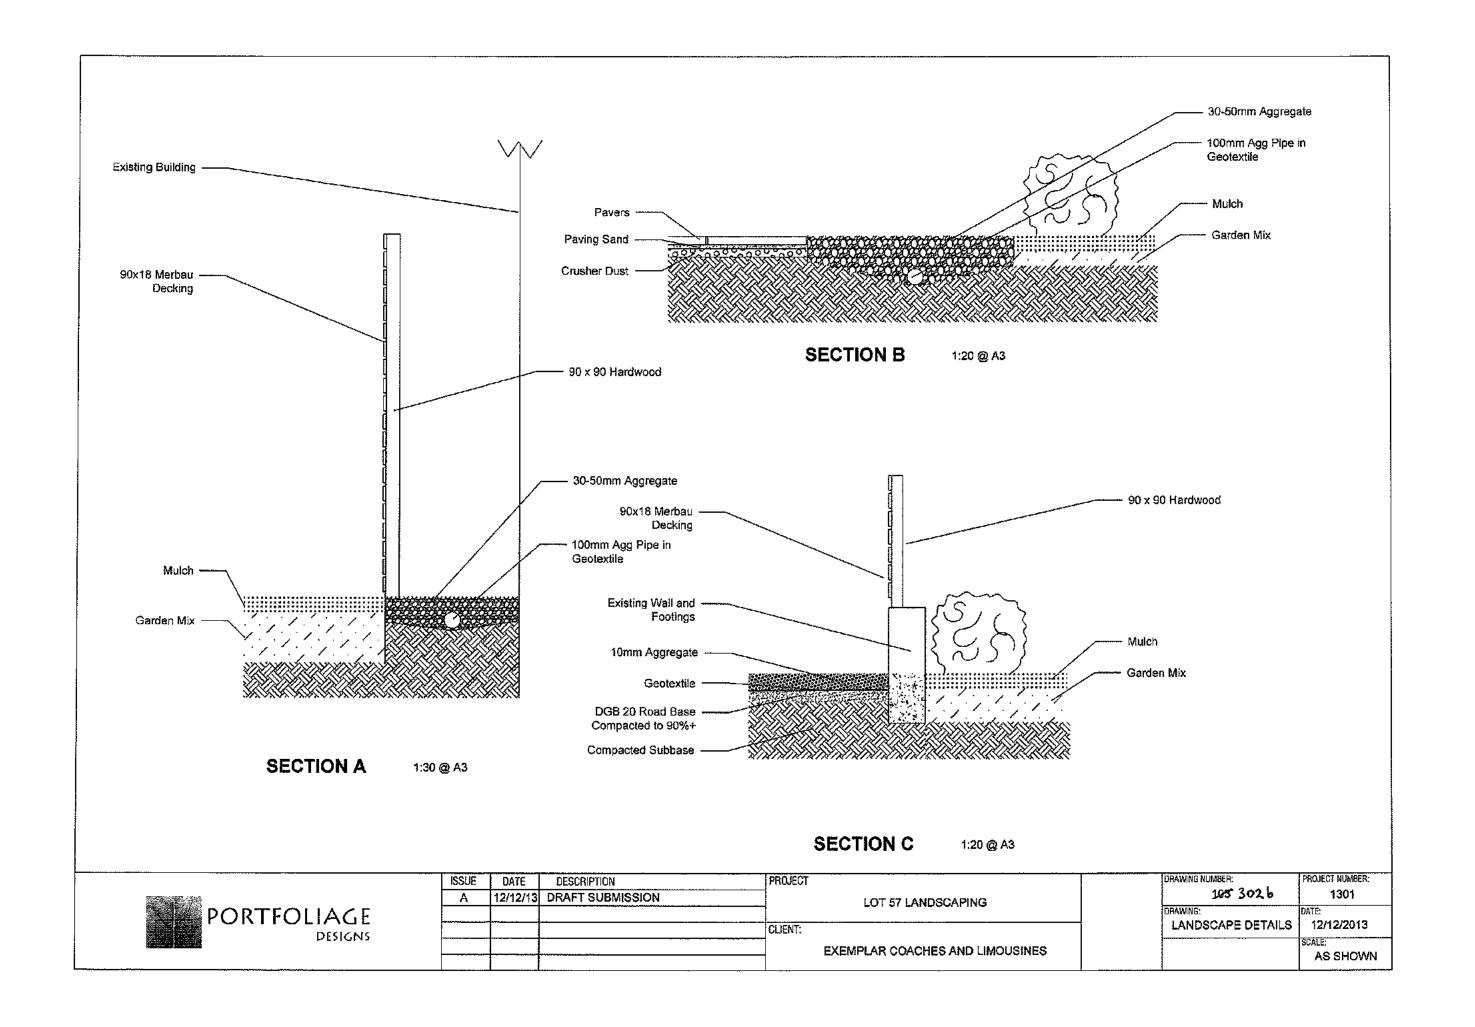
Percentage Coverage: 609/2810 =


Lot 57 Captain Cook, Highway, Craiglie Title Reference 20780231

LANDSCAPING OVERVIEW

Issue	Rev	Date
DA Submission	Α	06DEC13
		<u> </u>
Drawing Number	301	



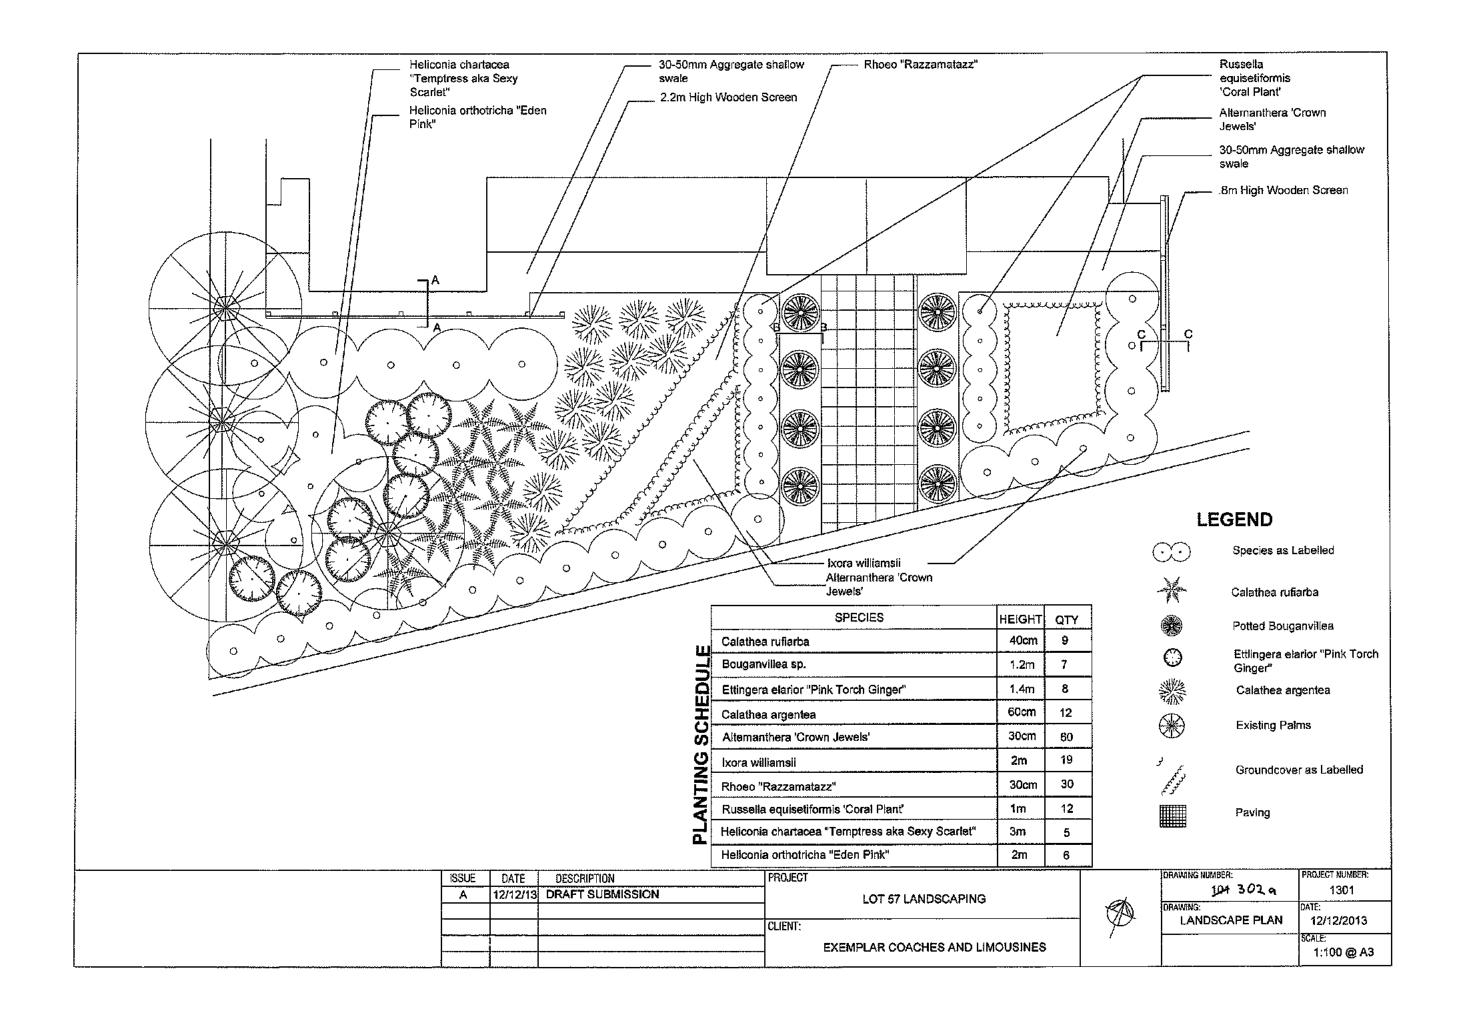

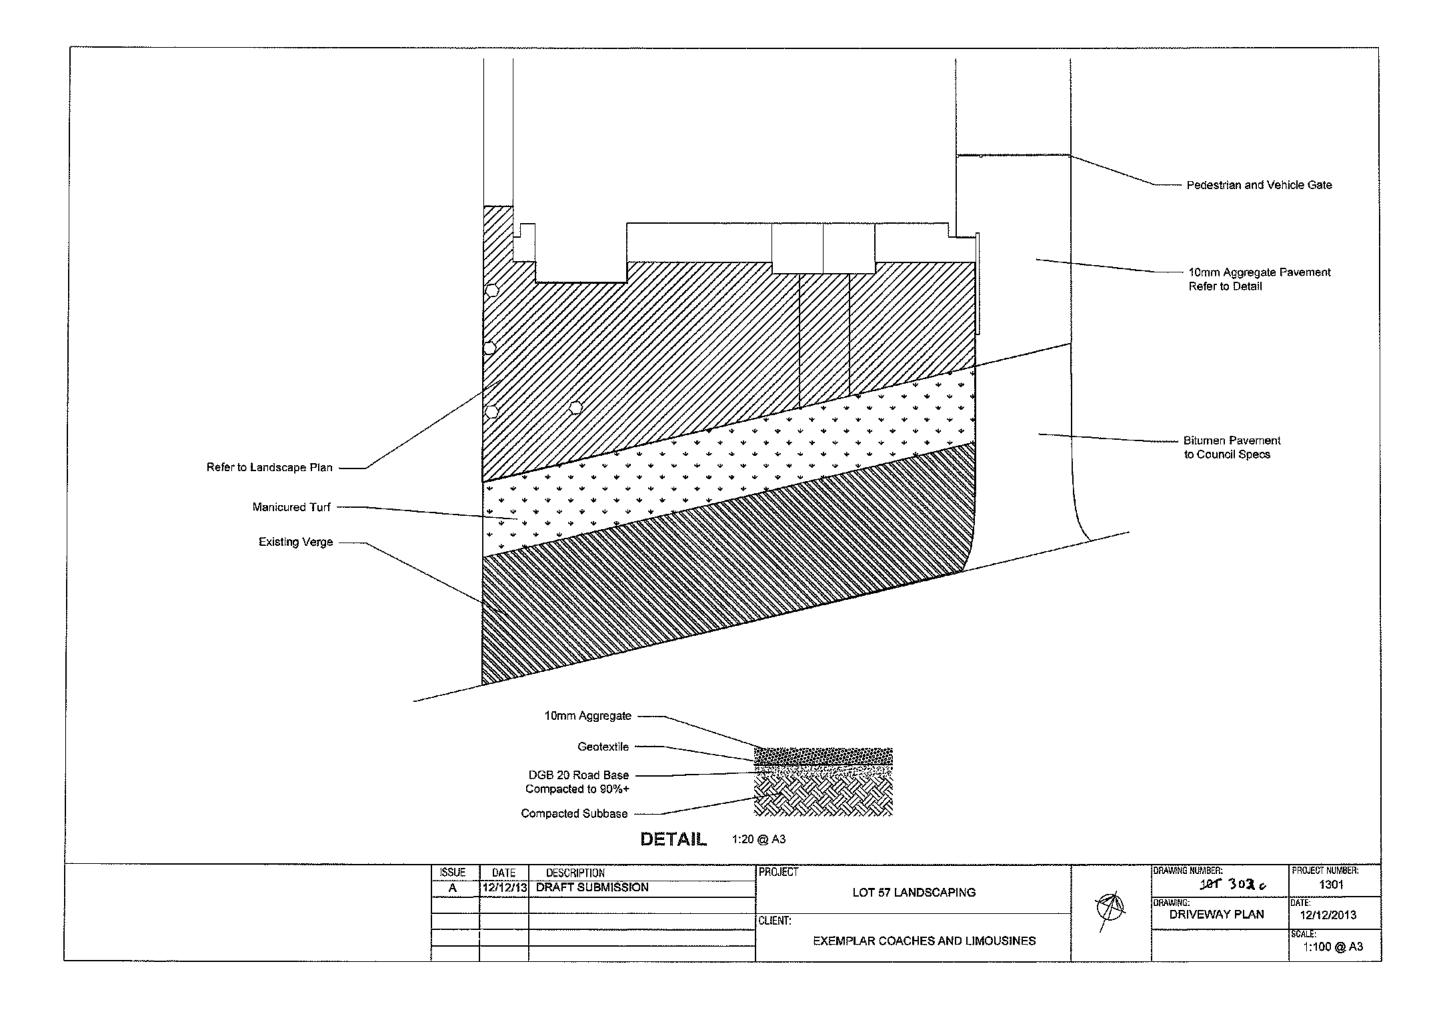



DOUGLAS

DEVELOPMENT ASSESSMENT - RECEIPT SHEET

COUNCIL				
APPLICATION NO:	DATE; _ /	16/12/13 REG	CEIPT NO:	
APPLICANT: Qordon	J WELLDAN	CONTACT NA	AME: <u>4098</u>	5044
ADDRESS OF APPLICAN	T: 3 Captain Con	OK HWY CARIL	glie	
PHONE: 4098 504	<u>4</u> EMAIL:	g. wellham @	exemplano	nline. Com. au
SITE LOCATION: 57	Davidson Bress	- Cracylie.		
LOT & PLAN: Lot 5	_	<u> </u>		<u>, , , , , , , , , , , , , , , , , , , </u>
REGEIPT	TYPE OF A	PPLICATION		AMOUNT PAID

***************************************	-	Language and the second
RECEIPT CODE	TYPE OF APPLICATION	AMOUNT PAID
133	Planning and Development Certificates	
1810	Consideration of Atternative Acceptable Measure / Report to Council Prelodgement Enquiry / Report to Council / Compliance Check for Self Assessable Development	
1852	 Application for Material Change of Use and Preliminary Approvals for Building Work – Code and Impact. Extension of Currency Period / Reconsider Lapsed Approval for Material Change of Use Request for Superseded Scheme application Signage under DSC Scheme (Op Works) 	12,692
1806	 Application for Reconfiguring a Lot Extension of Currency Period / Reconsider Lapsed Approval for Reconfiguring a Lot 	
1852/1806	Combined application	1840 MCU
	(Split fee: Code: 1840 for MCU and Gode: /1814 for ROL)	1814 ROL
135	Modification or Cancellation of Application or Consent Order	
395	Landscape Plan Assessments	RETURNS SERVED
492	Vegetation Protection Permit to Damage Protected Vegetation	- C OCC 2013
1816	Applications for Operational Works/Re-assessment (Excludes Signage - DSC Scheme)	1 0 0 L 0 10 0 0 0 0 0 0 0 0 0 0 0 0 0 0
302	Applications for Engineering Work on the Road Reserve	Mongaconnist Color
1816	Works/Final Works Inspections, Re-inspections	* **Semanting graphy a party of graphy
513	Bonds for Outstanding Works, Construction Security, Defects Liability, EPS	
1814	Endorsement of Survey Plans	,
	SALES:	
129	Public Notification Signs	
125	Sale of Planning Documents (including Hard Copies of CairnsPlan / Douglas Shire Planning Scheme)	
419	CDs of Cairns Plan / Douglas Shire Planning Scheme and superseded schemes CDs - copy of application CData Manipulation CD supplied to customer	
1852	Copies of Development Application,	
134	Letter of Enquiry to determine land use history	

1752826 v5 Updated 01/07/13

CSO NAME	NATAUE

DATE 16-12-13