

Our Ref: GC120023 20141219 OPW Submission Letter-Andreassen Drain Enquiries to: Mr Philip Bell

19 December 2014

The Chief Executive Officer Douglas Shire council PO Box 723 MOSSMAN QLD 4873

### ATTENTION: MR PAUL

Dear Sir.

### Re: Andreassen Road Drainage Channel Craiglie Lot 1 on RP 725770 and Lot 2 SR 431 **OPW Application for Civil Roadworks & Drainage**

We submit, for Council's information and approval, the following engineering drawings and supporting information for proposed civil works for the reconstruction of roadworks on Andreassen Road, and for trunk stormwater drainage in Andreassen Road and in Lot 1 RP 725770. This OPW application complements a previously lodged OPW on Lot 2 SR431 reference DSC No. OP5141/2013. This application shall be progressed to determine if the conditions of approval will affect the information response for the previous application DSC No. OP5141/2013. This application shall initially take precedence.

DOUGLAS SHIRE COUNCIL

72 DEC 2014

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Received

File Name OPS141/2014

Document No.....

Attention

Information

RN 56283

- (a) Two (2) full sets of engineering drawings numbered GC120023-01-C200-A, C201-A, C202-A, C203-A, C210-A, C211-A and C212-A (A3 size) detailing the works proposed.
- (b) Completed IDAS Application Form 1 and Form 6.
- Cheque for \$3,455.10 being payment of the Operational Works Application Fee for Civil (c) Infrastructure Works.
- (d) We advise that the applicable QLeave payment will be made by the Client prior to the approval being granted.
- (e) Copies of Registered Survey Plans available upon request.
- (f) Copy of Revised Stormwater Management Plan - Not included but will be forwarded as soon as we have council feedback from the submission.

40, 2013. 5141. 1



(g) Copy of Geotechnical Investigation and Acid Sulfate Soils Report – not included but will be submitted prior to approval being issued.

A digital copy of all the above information has also been included on the attached CD.

We trust the above is satisfactory to Council's requirements.

Yours faithfully

PAB

Philip Bell Principal Engineer CPEng RPEQ

Enc:

cc: Douglas Gardens Pty Ltd - Attn: Mr Alan Franks





## Submission to Douglas Shire Council Operational Works Application

Client: Coral Gardens NZ Limited & Others Project No: GC120023 Document No: GC120023 OPW Submission – December 2014 Report Date: December 2014



# **Submission Contents**

### PART 1: FORMS

- SUBMISSION LETTER
- IDAS FORM 1 APPLICATION DETAILS
- IDAS FORM 6 BUILDING OR OPERATIONAL WORKS ASSESSABLE AGAINST A PLANNING SCHEME

### PART 2: SUPPORTING DOCUMENTS AND CODES

• N/A

### PART 3: PLANS AND DRAWINGS

• BURCHILLS ENGINEERING DRAWINGS

### PART 4: SPECIALIST REPORTS

• N/A



### **PART 1: FORMS**

- SUBMISSION LETTER
- IDAS FORM 1 APPLICATION DETAILS
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Yours faithfully

PAB

Philip Bell Principal Engineer CPEng RPEQ

Enc:

cc: Douglas Gardens Pty Ltd – Attn: Mr Alan Franks

# **IDAS form 1**—Application details

(Sustainable Planning Act 2009 version 4.1 effective 4 July 2014)

This form must be used for ALL development applications.

You **MUST** complete **ALL** questions that are stated to be a mandatory requirement unless otherwise identified on this form.

For all development applications, you must:

- complete this form (IDAS form 1—Application details)
- complete any other forms relevant to your application
- provide any mandatory supporting information identified on the forms as being required to accompany your application.

Attach extra pages if there is insufficient space on this form.

All terms used on this form have the meaning given in the *Sustainable Planning Act 2009* (SPA) or the Sustainable Planning Regulation 2009.

This form and any other IDAS form relevant to your application must be used for development applications relating to strategic port land and Brisbane core port land under the *Transport Infrastructure Act 1994* and airport land under the *Airport Assets (Restructuring and Disposal) Act 2008.* Whenever a planning scheme is mentioned, take it to mean land use plan for the strategic port land, Brisbane core port land or airport land.

PLEASE NOTE: This form is not required to accompany requests for compliance assessment.

This form can also be completed online using MyDAS at <u>www.dsdip.qld.gov.au/MyDAS</u>

### Mandatory requirements

**Applicant details** (Note: the applicant is the person responsible for making the application and need not be the owner of the land. The applicant is responsible for ensuring the information provided on all IDAS application forms is correct. Any development permit or preliminary approval that may be issued as a consequence of this application will be issued to the applicant.)

Philip Bell

Name/s (individual or company name in full)

For companies, contact name

Postal address

### CORAL GARDENS NZ LIMITED & OTHERS C/- BURCHILLS ENGINEERING SOLUTIONS

PO BOX 3799 AUSTRALIA FAIR								
Suburb	SOUTHPORT							
State	QLD	Postcode	4215					
Country								

Contact phone number

07 5509 6400

Mobile number (non-mandatory requirement)

Fax number (non-mandatory requirement)



Email address (non-mandatory requirement)		philip.bell					
l		@ burchills.com.au					
Applicant's reference number (non-mandatory requirement)		GC120023					
1. What is the nature of the	development p	proposed and what type of approval is being sought?					
Table A—Aspect 1 of the applica	tion (If there are	e additional aspects to the application please list in Table B—Aspect 2.)					
a) What is the nature of the de	velopment? (Plea	ease only tick one box.)					
Material change of use	Reconfigu	guring a lot 🛛 Building work 🖾 Operational work					
b) What is the approval type? (	Please only tick	k one box.)					
Preliminary approval under s241 of SPA		ary approval					
		including use definition and number of buildings or structures where defined as a <i>multi-unit dwelling</i> , 30 lot residential subdivision etc.)					
Andreassen Road & Captair Works	ı Cook Highway ∙	/ - Intersection Design and Andreassen Road - Road & Drainage					
d) What is the level of assessm	ent? (Please only	nly tick one box.)					
Impact assessment	Code ass	sessment					
Table B         Aspect 2 of the applica           Additional aspects of the applicat		e additional aspects to the application please list in Table C—					
a) What is the nature of develo	pment? (Please	e only tick one box.)					
Material change of use	Reconfigu	guring a lot Duilding work Operational work					
b) What is the approval type?	Please only tick	k one box.)					
Preliminary approval under s241 of SPA		ary approval Development 241 and s242 permit					
		including use definition and number of buildings or structures where defined as a <i>multi-unit dwelling</i> , 30 lot residential subdivision etc.)					
d) What is the level of assessm	ent?						
Impact assessment	Code ass	sessment					
Table C         Additional aspects of the separate table on an extra page and table on an extra p		If there are additional aspects to the application please list in a is form.)					
Refer attached schedule	Not requir	iired					

2. Location of the premises (Complete Table D and/or Table E as applicable. Identify each lot in a separate row.)									
Table D—Street address and lot on plan for the premises or street address and lot on plan for the land adjoining or adjacent to the premises (Note: this table is to be used for applications involving taking or interfering with water). (Attach a separate schedule if there is insufficient space in this table.)         Image: Street address and lot on plan for the land adjoining or adjacent to the premises (Appropriate for development in water but adjoining or adjacent to land, e.g. jetty, pontoon. All lots must be listed.)									
Street	addre	SS				Lot on plan description			<b>cal government area</b> g. Logan, Cairns)
Lot	Unit no.	Street no.	Street name and o suburb/ locality na		Post- code		Plan typ and pla		
i)	i) Captain Cook Hwy & 4877 Andreassen Road Craiglie					-	SR431 RP725	R431 Douglas Shire Cour P725770	
ii)									
iii)									
			<b>s</b> (If the premises table. Non-mand		multiple zon	es, clearly io	dentify	the relevant	zone/s for each lot in a
Lot	Applic	able zone / pr	recinct	Applical	ble local plan	al plan / precinct Applicable overlay/s			verlay/s
i)									
ii)									
iii)									
adjoini	Table E       Premises coordinates (Appropriate for development in remote areas, over part of a lot or in water not adjoining or adjacent to land e.g. channel dredging in Moreton Bay.) (Attach a separate schedule if there is insufficient space in this table.)								
	inates		oordinates in a se	parate ro	ow)	Zone reference	Dat	um	Local government area (if applicable)
Eastin	g	Northing	Latitude	Lon	gitude				
			-16.547310	145	5.473476			GDA94 WGS84 other	Douglas Shire Council

3. Total area of the premises on which the development is proposed (indicate square metres)

11700m2

4. Current use/s of the premises (e.g. vacant land, house, apartment building, cane farm etc.)

Cane Farm

5.	Are there any current approvals (e.g. a preliminary approval) associated with this application? (Non- mandatory requirement)								
	No 🔀 Yes-	-provide details belo	W						
List o	of approval reference	e/s	Date approved (dd/mm/yy)	Date approval lapses (dd/mm/yy)					
OP5	OP5141/2013 05/07/2013								
6.	Is owner's conser	nt required for this a	application? (Refer to notes at the en	d of this form for more information.)					
	No								
	Yes—complete eith	er Table F, Table G	or Table H as applicable						
Tabl	e F								
Nam	e of owner/s of the la	and							
l/We	, the above-mention	ed owner/s of the lan	d, consent to the making of this applic	ation.					
Sign	ature of owner/s of th	he land							
Date									
Tabl	e G								
Nam	e of owner/s of the la	and							
	The owner's written o	consent is attached o	r will be provided separately to the as	sessment manager.					
Tabl	e H								
Nam	e of owner/s of the la	and Coral G	ardens NZ Limited & Others						
	By making this applica	tion, I, the applicant, de	clare that the owner has given written cor	sent to the making of the application.					
7.	Identify if any of t	the following apply	to the premises (Tick applicable box/	es.)					
$\square$	Adjacent to a water	r body, watercourse o	or aquifer (e.g. creek, river, lake, canal	)—complete Table I					
	On strategic port la	and under the <i>Transp</i>	ort Infrastructure Act 1994—complete	Table J					
	In a tidal water area	a—complete Table K							
	On Brisbane core p	port land under the Tr	ansport Infrastructure Act 1994 (No ta	ble requires completion.)					
	On airport land und	der the Airport Assets	(Restructuring and Disposal) Act 200	8 (no table requires completion)					
	<ul> <li>Listed on either the Contaminated Land Register (CLR) or the Environmental Management Register (EMR) under the Environmental Protection Act 1994 (no table requires completion)</li> </ul>								
Tabl	e l								
Nam	e of water body, wat	ercourse or aquifer							
Sma	Small drainage channel along Andreassen Road								

Table J									
Lot on plan description for strategic port land		Port author	rity for the lot						
Table K									
Name of local government for the tidal area (if applicable) Port authority for the tidal area (if applicable)									
8. Are there any existing easements or water etc)	n the premises?	(e.g. for vehicu	ular access, electricity, overland flow,						
No Yes—ensure the type, loca	ation and dimensio	on of each eas	ement is included in the plans submitted						
9. Does the proposal include new build services)	ding work or ope	rational work	on the premises? (Including any						
No Xes—ensure the nature, lo	cation and dimen	sion of propos	ed works are included in plans submitted						
<b>10.</b> Is the payment of a portable long see end of this form for more information.)	ervice leave levy	applicable to	this application? (Refer to notes at the						
No—go to question 12 Xes									
11. Has the portable long service leave information.)	levy been paid?	(Refer to note	s at the end of this form for more						
No									
Yes—complete Table L and submit with receipted QLeave form	n this application t	he yellow loca	I government/private certifier's copy of the						
Table L									
Amount paid		Date paid (dd/mm/yy)	QLeave project number (6 digit number starting with A, B, E, L or P)						
12. Has the local government agreed to section 96 of the Sustainable Plann		ded planning	scheme to this application under						
No									
Yes—please provide details below									
Name of local government	Date of written r by local governr (dd/mm/yy)		Reference number of written notice given by local government (if applicable)						

**13.** List below all of the forms and supporting information that accompany this application (Include all IDAS forms, checklists, mandatory supporting information etc. that will be submitted as part of this application. Note: this question does not apply for applications made online using MyDAS)

Description of attachment or title of attachment	Method of lodgement to assessment manager
IDAS FORM 1	Post
IDAS FORM 6	Post
Full submission package	Post

### 14. Applicant's declaration

By making this application, I declare that all information in this application is true and correct (Note: it is unlawful to provide false or misleading information)

### Notes for completing this form

• Section 261 of the Sustainable Planning Act 2009 prescribes when an application is a properly-made application. Note, the assessment manager has discretion to accept an application as properly made despite any noncompliance with the requirement to provide mandatory supporting information under section 260(1)(c) of the Sustainable Planning Act 2009

### **Applicant details**

• Where the applicant is not a natural person, ensure the applicant entity is a real legal entity.

### **Question 1**

• Schedule 3 of the Sustainable Planning Regulation 2009 identifies assessable development and the type of assessment. Where schedule 3 identifies assessable development as "various aspects of development" the applicant must identify each aspect of the development on Tables A, B and C respectively and as required.

### **Question 6**

• Section 263 of the Sustainable Planning Act 2009 sets out when the consent of the owner of the land is required for an application. Section 260(1)(e) of the Sustainable Planning Act 2009 provides that if the owner's consent is required under section 263, then an application must contain, or be accompanied by, the written consent of the owner, or include a declaration by the applicant that the owner has given written consent to the making of the application. If a development application relates to a state resource, the application is not required to be supported by evidence of an allocation or entitlement to a state resource. However, where the state is the owner of the subject land, the written consent of the state, as landowner, may be required. Allocation or entitlement to the state resource is a separate process and will need to be obtained before development commences.

### **Question 7**

• If the premises is listed on either the Contaminated Land Register (CLR) or the Environmental Management Register (EMR) under the *Environmental Protection Act 1994* it may be necessary to seek compliance assessment. Schedule 18 of the Sustainable Planning Regulation 2009 identifies where compliance assessment is required.

#### Question 11

- The Building and Construction Industry (Portable Long Service Leave) Act 1991 prescribes when the portable long service leave levy is payable.
- The portable long service leave levy amount and other prescribed percentages and rates for calculating the levy are prescribed in the Building and Construction Industry (Portable Long Service Leave) Regulation 2002.

### Question 12

- The portable long service leave levy need not be paid when the application is made, but the *Building and Construction Industry (Portable Long Service Leave) Act 1991* requires the levy to be paid before a development permit is issued.
- Building and construction industry notification and payment forms are available from any Queensland post office or agency, on request from QLeave, or can be completed on the QLeave website at www.qleave.qld.gov.au. For further information contact QLeave on 1800 803 481 or visit www.qleave.qld.gov.au.

**Privacy**—The information collected in this form will be used by the Department of State Development, Infrastructure and Planning (DSDIP), assessment manager, referral agency and/or building certifier in accordance with the processing and assessment of your application. Your personal details should not be disclosed for a purpose outside of the IDAS process or the provisions about public access to planning and development information in the *Sustainable Planning Act 2009*, except where required by legislation (including the *Right to Information Act 2009*) or as required by Parliament. This information may be stored in relevant databases. The information collected will be retained as required by the *Public Records Act 2002*.

#### **OFFICE USE ONLY**

Date received

Reference numbers

### NOTIFICATION OF ENGAGEMENT OF A PRIVATE CERTIFIER

То		Council. I have been engaged as the private certifier for the building work referred to in this application
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Date of engagement	Name	BSA Certification license number	Building classification/s

### QLEAVE NOTIFICATION AND PAYMENT (For completion by assessment manager or private certifier if applicable.)

Description of the work	QLeave project number	Amount paid (\$)	Date paid	Date receipted form sighted by assessment manager	Name of officer who sighted the form

The Sustainable Planning Act 2009 is administered by the Department of State Development, Infrastructure and Planning. This form and all other required application materials should be sent to your assessment manager and any referral agency.

# **IDAS form 6**—Building or operational work assessable against a planning scheme

(Sustainable Planning Act 2009 version 3.0 effective 1 July 2013)

This form must be used for development applications for building work or operational work assessable against a planning scheme.

You **MUST** complete **ALL** questions that are stated to be a mandatory requirement unless otherwise identified on this form.

For all development applications, you must:

- complete IDAS form 1—Application details
- complete any other forms relevant to your application
- provide any mandatory supporting information identified on the forms as being required to accompany your application.

Attach extra pages if there is insufficient space on this form.

All terms used on this form have the meaning given in the *Sustainable Planning Act 2009* (SPA) or the Sustainable Planning Regulation 2009.

This form must be used for building work or operational work relating on strategic port land and Brisbane core port land under the *Transport Infrastructure Act 1994* and airport land under the *Airport Assets (Restructuring and Disposal) Act 2008* that requires assessment against the land use plan for that land. Whenever a planning scheme is mentioned, take it to mean land use plan for the strategic port land, Brisbane core port land or airport land.

This form can also be completed online using MyDAS at www.dsdip.qld.gov.au/MyDAS

### **Mandatory requirements**

1. What is the nature of the work that requires assessment against a planning scheme? (Tick all applicable boxes.)

	Building work—complete Table A	$\square$	Operational work—c	omplete Table B					
Та	ble A								
a)	What is the nature of the building work (e.g. bubuilding)?	uilding	, repairing, altering, un	derpinning, moving or demolishing a					
b)	<ul> <li>b) Are there any current approvals associated with this application? (e.g. material change of use.)</li> <li>No Yes— provide details below</li> </ul>								
	List of approval reference/s D	ate ap	proved (dd/mm/yy)	Date approval lapses (dd/mm/yy)					



Tak	Table B									
a) What is the nature of the operational work? (Tick all applicable boxes.)										
Road works Stormwater Water infrastructure										
	Drainage works									
	Landscaping       Signage       Clearing vegetation under the planning scheme									
	Other—provide details									
b)	Is the operational work necess	-				,	g. subdivision.)			
c)	Are there any current approva			vith this a	applica	ation? (E.g. ma	terial change of us	se.)		
	List of approval reference/s			Date app	proved	l (dd/mm/yy)	Date approval	lapses (dd/mm/yy)		
	OP5141 / 2013		(	05/07/20	013					
2. What is the dollar value of the proposed building work? (Inc GST, materials and labour.)										
		, any								
3.	What is the dollar value of (Inc GST, materials and labo	the prop	osed	operatio	onal w	ork?		\$200,000.00		
	What is the dollar value of	the prop our.)	osed	operatio	onal w	ork?		\$200,000.00		
	What is the dollar value of (Inc GST, materials and labo	the prop our.)					panies this app			
Ма 4.	What is the dollar value of (Inc GST, materials and labo indatory supporting informatio	the propo our.) on mandato					npanies this app Confirmation of lodgement	lication		
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Ma A. Mar All A s rec • • • •	What is the dollar value of (Inc GST, materials and labor indatory supporting information Confirm that the following indatory supporting information applications involving buildin ite plan drawn to an appropriate commended scales) which shows the location and site area of the ( <i>relevant land</i> ) the north point the boundaries of the relevant la the allotment layout showing ex dimensions of those lots), existi envelopes and existing or propor required for all lots) any existing or proposed easem	the property of the property o	ory su or ope :100, 1 owing: which t s, any p posed n spac the rele	pporting rational 1:200 or he applic propose road res ce (note: evant lar	g info work 1:500 cation d lots serves numb	rmation accorr are relates (including the , building ering is their	Confirmation of lodgement	lication Method of		

A statement about how the proposed development addresses the local government's planning schemes and any other planning documents relevant to the application.	Confirmed	
A statement addressing the relevant part(s) of the State Development Assessment Provisions (SDAP).	Confirmed	
Applications for building work (including extensions and demolition that i	s assessable develo	opment)
<ul> <li>Floor plans drawn to an appropriate scale (1:50, 1:100 or 1:200 are recommended scales) which show the following:</li> <li>the north point</li> <li>the intended use of each area on the floor plan (for commercial, industrial or mixed use developments only)</li> <li>the room layout (for residential development only) with all rooms clearly labelled</li> </ul>	Confirmed	
<ul> <li>the existing and the proposed built form (for extensions only)</li> <li>the gross floor area of each proposed floor area.</li> </ul>		
Elevations drawn to an appropriate scale (1:100, 1:200 or 1:500 are recommended scales) which show plans of all building elevations and facades, clearly labelled to identify orientation (e.g. north elevation).	Confirmed	
Plans showing the size, location, proposed site cover, proposed maximum number of storeys, and proposed maximum height above natural ground level of the proposed new building work.	Confirmed	
Plans showing the extent of any demolition that is assessable development.	Confirmed	
Applications for operational work involving earthworks (filling and excava	ating)	
<ul> <li>Drawings showing:</li> <li>existing and proposed contours</li> <li>areas to be cut and filled</li> <li>the location and level of any permanent survey marks or reference stations used as datum for the works</li> <li>the location of any proposed retaining walls on the relevant land and their height</li> <li>the defined flood level (if applicable)</li> <li>the fill level (if applicable).</li> </ul>	Confirmed	
Applications for operational work involving roadworks		
Drawings showing:	Confirmed	
<ul> <li>existing and proposed contours</li> <li>the centreline or construction line showing chainages, bearings, offsets if the construction line is not the centreline of the road and all intersection points</li> </ul>	Confirmed	
<ul> <li>information for each curve including tangent point chainages and offsets, curve radii, arc length, tangent length, superelevation (if applicable) and curve widening (if applicable)</li> <li>kerb lines including kerb radii (where not parallel to centreline) and</li> </ul>		
<ul> <li>tangent point changes (where not parallel to centreline)</li> <li>edge of pavement where kerb is not constructed</li> <li>position and extent of channelisation</li> <li>location and details of all traffic signs, guideposts, guardrail and other</li> </ul>		
<ul> <li>street furniture</li> <li>pavement markings including details on raised pavement markers</li> </ul>		

•	catchpit, manhole and pipeline locations		
•	drainage details (if applicable)		
•	cross road drainage culverts (if applicable)		
•	concrete footpaths and cycle paths		
•	location and details for access points, ramps and invert crossings changes in surfacing material.		
	oplications for operational work involving stormwater drainage		
-			
Dr	awings showing:		
•	existing and proposed contours	Not applicable	
•	drainage locations, diameters and class of pipe, open drains and easements		
•	manhole location, chainage and offset or coordinates and inlet and outlet		
	invert levels		
•	inlet pit locations, chainage and offset or coordinates and invert and kerb		
	levels.		
A	oplications for operational work involving water reticulation		
Dr	awings showing:	Confirmed	
•	kerb lines or edge of pavement where kerb is not constructed	Not applicable	
•	location and levels of other utility services where affected by water reticulation works		
•	pipe diameter, type of pipe and pipe alignment		
•	water main alignments		
•	water supply pump station details (if applicable)		
•	minor reservoir details (if applicable)		
•	conduits		
•	location of valves and fire hydrants location of house connections (if applicable)		
•	location of bench marks and reference pegs.		
Ar	oplications for operational work involving sewerage reticulation		
	awings showing:	Confirmed	
	location of all existing and proposed services	Not applicable	
	location of all existing and proposed services		
•	location of all house connection branches		
•	kerb lines or edge of pavement where kerb is not constructed		
•	chainages		
•	design sewer invert levels		
•	design top of manhole levels		
•	type of manhole and manhole cover		
•	pipe diameter, type of pipe and pipe alignment		
•	location of house connections (if applicable) sewer pump station details (if applicable).		
۰ ۸.			
-	oplications for operational work involving street lighting		
Dr	awings showing:		
	location of all light poles and service conduits	Not applicable	
	location of all other cross road conduits type of wattage and lighting		
	any traffic calming devices		
•	additional plans for roundabouts and major roads (if applicable)		
•	details of any variations to normal alignment		

٠	details of lighting levels.		
Ap	plications for operational work involving public utility services		
Dr	awings showing:	Confirmed	
•	any existing light poles and power poles	Not applicable	
٠	any existing underground services		
•	details of proposed services		
•	alteration to existing services.		
Ap	plications for operational work involving landscaping works		
Dr	awings showing:	Confirmed	
•	the location of proposed plant species	Not applicable	
•	a plant schedule indicating common and botanical names, pot sizes and numbers of plants		
•	planting bed preparation details including topsoil depth, subgrade preparation, mulch type and depth, type of turf, pebble, paving and garden edge		
٠	the location and type of any existing trees to be retained		
•	construction details of planter boxes, retaining walls and fences		
•	the proposed maintenance period		
•	irrigation system details.		

**Privacy**—Please refer to your assessment manager, referral agency and/or building certifier for further details on the use of information recorded in this form.

### OFFICE USE ONLY

Date received

Reference numbers

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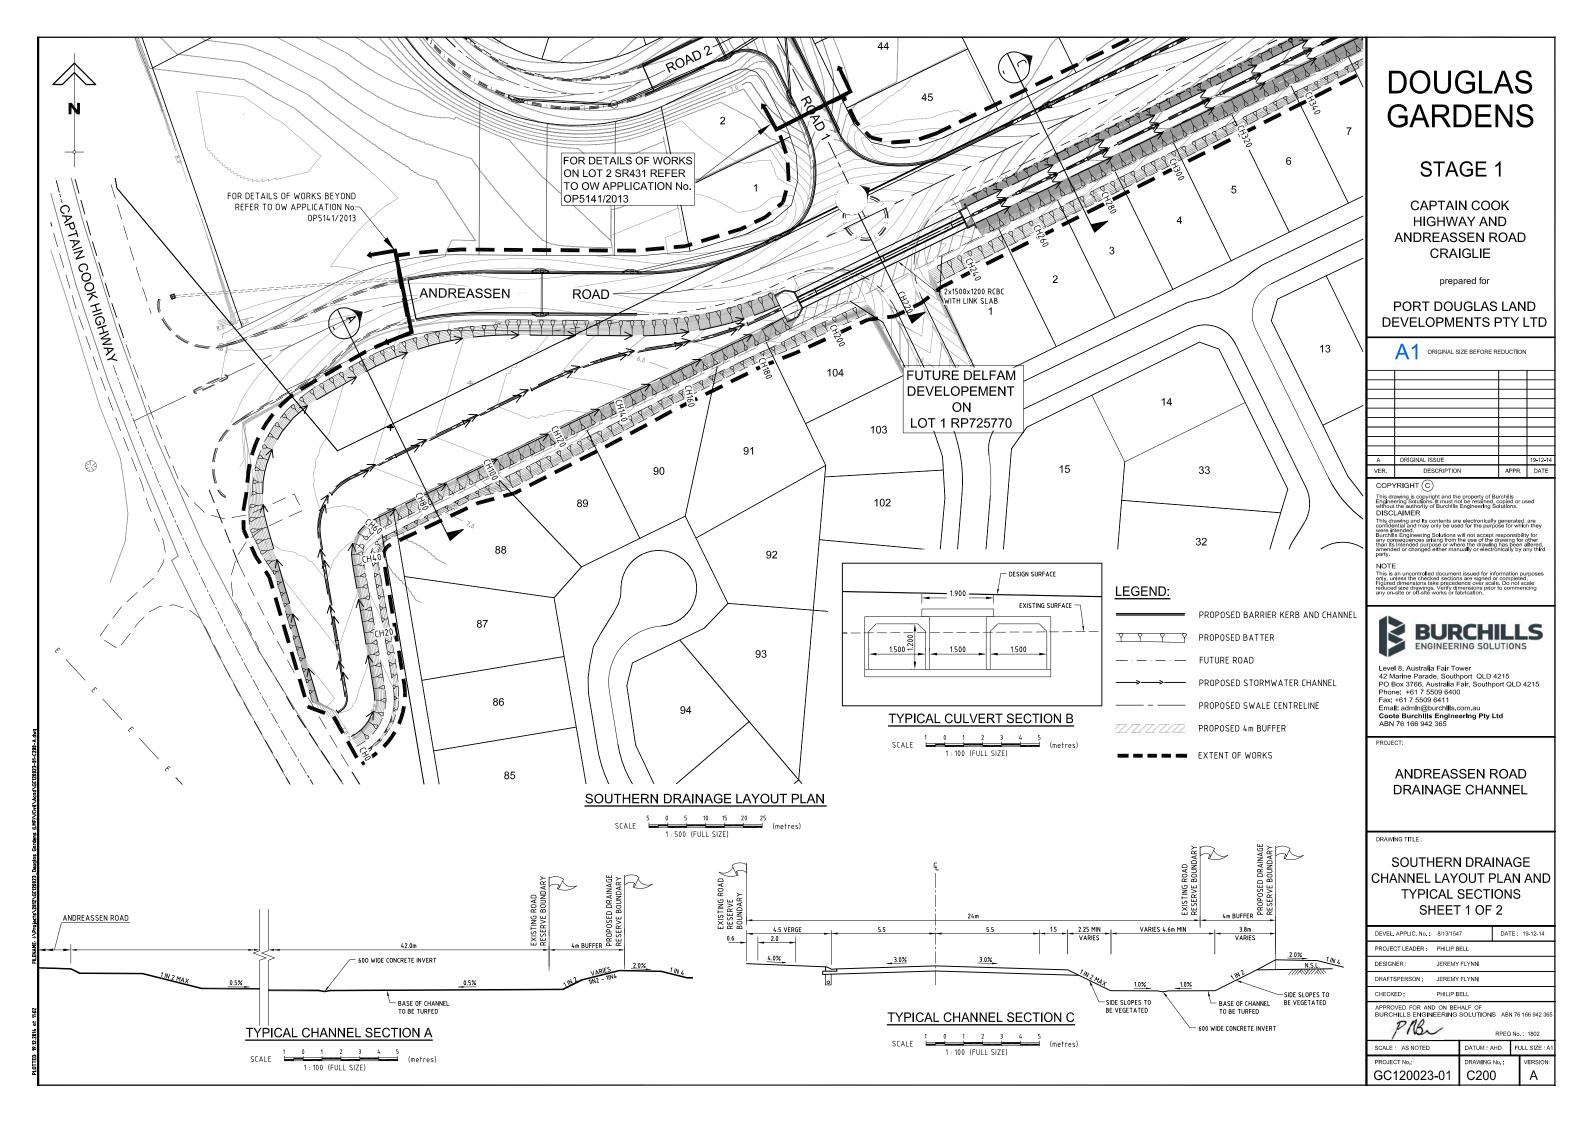
PART 2: SUPPORTING DOCUMENTS AND CODES


• N/A



### PART 3: PLANS AND DRAWINGS

BURCHILLS ENGINEERING DRAWINGS



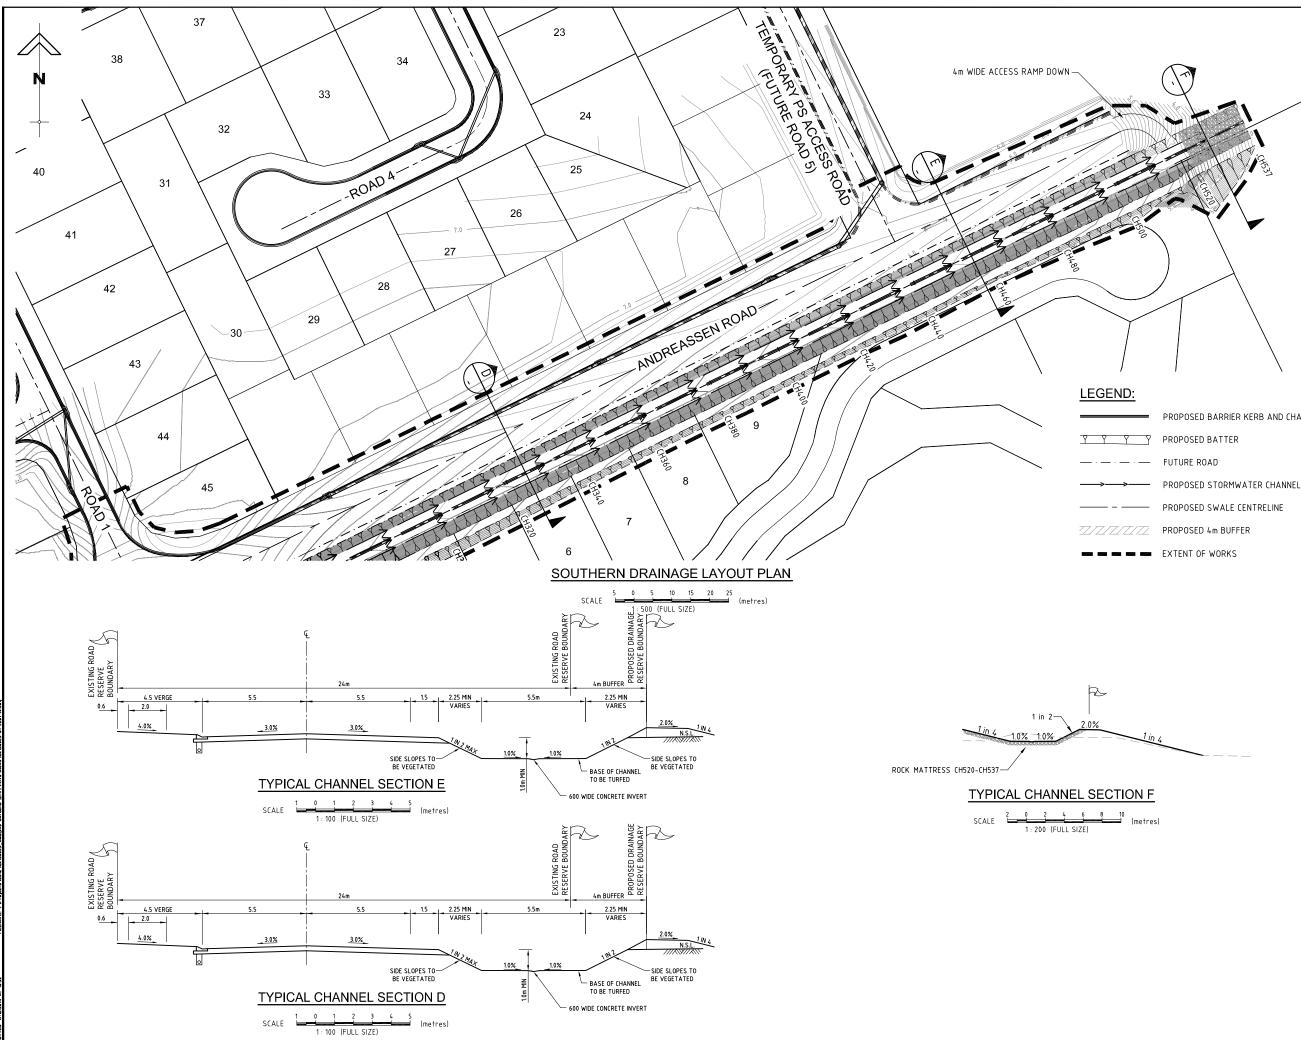

- PROPOSED BARRIER KERB AND CHANNEL

# DOUGLAS GARDENS

### STAGE 1

CAPTAIN COOK HIGHWAY AND ANDREASSEN ROAD CRAIGLIE

prepared for

PORT DOUGLAS LAND DEVELOPMENTS PTY LTD

A1 ORIGINAL SIZE BEFORE REDUCTION

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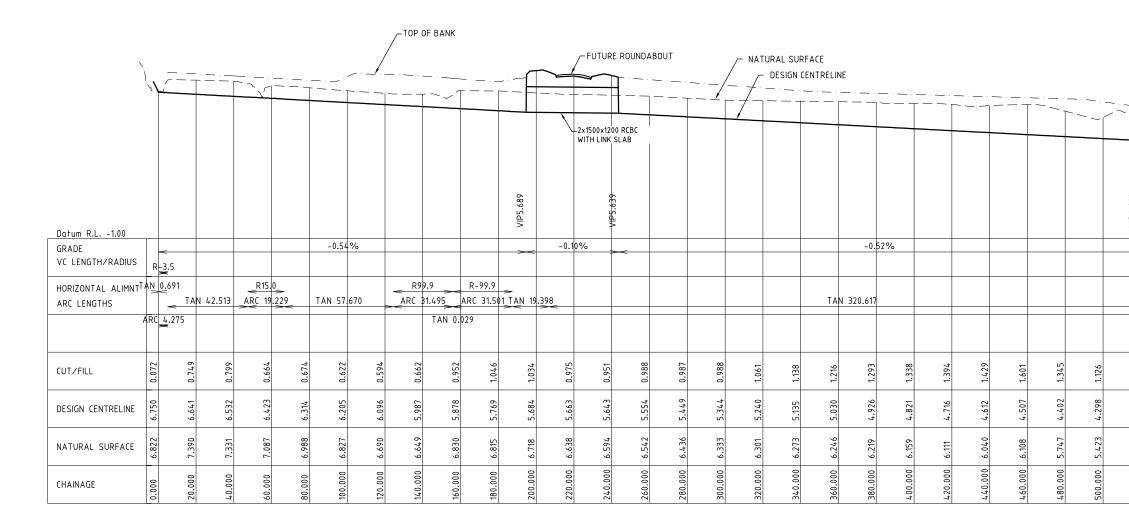
PROJECT:

### ANDREASSEN ROAD DRAINAGE CHANNEL

DRAWING TITLE :

### SOUTHERN DRAINAGE CHANNEL LAYOUT PLAN AND TYPICAL SECTIONS SHEET 2 OF 2


DEVEL APPLIC. No. : 8/13/1	8/13/1547 DATE: 19-12-14						
PROJECT LEADER : PHILI	PHILIP BELL						
DESIGNER : JEREI	JEREMY FLYNN						
DRAFTSPERSON : JEREI	MY FLYNN						
CHECKED : PHILI	PHILIP BELL						
APPROVED FOR AND ON E BURCHILLS ENGINEERIN		S ABN 7					
SCALE : AS NOTED	DATUM : /	AHD F	ULL SIZE : A1				
PROJECT No.: DRAWING No.: VERSIO GC120023-01 C201 A							



### SOUTHERN DRAINAGE CHANNEL

LONGITUDINAL SECTION

	10	<u> </u>	10	20	30	40	50	1:1000 HORIZ.
SCALES	1	Q	_1_	2	3	4	5	1:100 VERT.
			(r	netre	s)			(FULL SIZE)

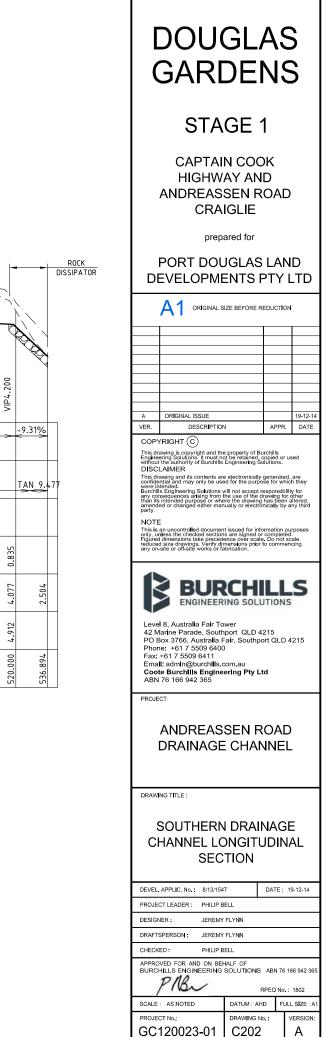

				WORKS REFE			4 SAG CH 109.923 R.L.7.512					•	+-	•			DESIGN C ~ NATUR	ENTRELIN AL SURF/					
Datum R.L. 1.00	770 2017			0.509/		0.50	VIP7.481		0.500/		VIP7.961	1.01	VIP7.089			/			VIP6.400			0 / 00/	 
GRADE VC LENGTH/RADIUS	-5.91 R=1	3.0m 47.77m	- (	0.50%	>	-0.50°	25.0m 2495.5	<u>≯</u> 3m	0.50%	R=	20.0m 828.46	-1.91 5m	25.0m R=1919.5		-0.4	61%			><			-0.40%	
HORIZONTAL ALIMNT ARC LENGTHS	<	TAN	57.421	*	R90 ARC 4	<u> </u>	TAN	41.634 >	R-80.0 ARC 36.930	-							TAN 32	3.369					
CUT/FILL	-0.047	-0.494	-0.495	-0.409	-0.426	-0.517	-0.557	400.0- 897 0-	-1.205	-1.383 -1.493	-1.493	-1.287	-0.916	-0./34	-0.660	-0.603	-0.568	-0.484	-0.398	-0.290	-0.129	-0.077	807 0
DESIGN CENTRELINE	8.734	7.931	7.831	7.731	7.631	7.532	7.512		7.732	7.921	7.921	7.689	7.306	1.040 6 916	6.791	6.669	6.547	6.424	6.336	6.256	6.176	6.096	
NATURAL SURFACE	8.687	7.437	7.336	7.322	7.205	7.015	6.955	42000 6833	6.527	6.448 6.428	6.428	6.402	6.390	6.306 6.305	6.131	6.066	5.979	5.941	5.938	5.966	6.047	6.019	- 10 - 10
CHAINAGE	0.000	20.000	40.000	60.000	80.000	100.000	109.923	000 071	160.000	180.000 199.940	200.000	220.000	240.000	260.000	300.000	320.000	340.000	360.000	380.000	400.000	420.000	440.000	

ANDREASSON ROAD LONGITUDINAL SECTION

<i>د</i>			
		>	
		~~~~	
-0.698	-0.640	-1.207	
6.016	5.936	5.856	
460.000 5.318 6.016	480.000 5.296	500.000 4.649 5.856	
460.000	480.000	500.000	

# DOUGLAS GARDENS

### STAGE 1

CAPTAIN COOK HIGHWAY AND ANDREASSEN ROAD CRAIGLIE

prepared for

PORT DOUGLAS LAND DEVELOPMENTS PTY LTD

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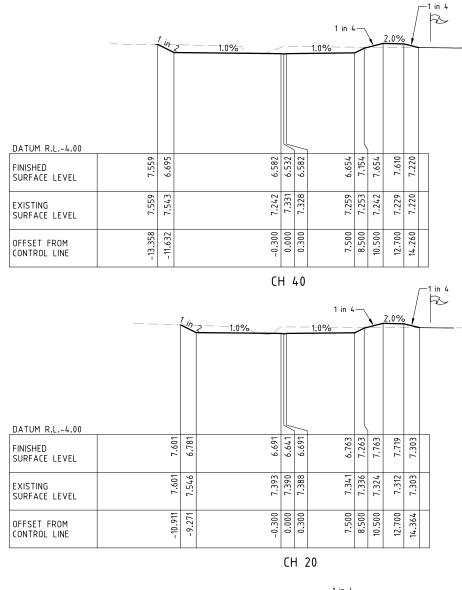
PROJECT:

### ANDREASSEN ROAD DRAINAGE CHANNEL

DRAWING TITLE :


### ANDREASSON ROAD LONGITUDINAL SECTION


DEVEL APPLIC. No.: 8/13/154	8/13/1547 DATE: 18-12-14						
PROJECT LEADER : PHILIP B	PHILIP BELL						
DESIGNER : JEREMY	JEREMY FLYNN						
DRAFTSPERSON: JEREMY	JEREMY FLYNN						
CHECKED : PHILIP B	PHILIP BELL						
APPROVED FOR AND ON BEHALF OF BURCHILLS ENGINEERING SOLUTIONS ABN 76 166 942 36 PHBA RPEO No.: 1802							
		RPEQ N					




	<u> </u>		1.0%	1	4	2.0%	ĥ	
DATUM R.L.3.00		Ĺ			,			
FINISHED SURFACE LEVEL	6.750	6.800	6.872	7.372	7.872	7.828	7.600	
EXISTING SURFACE LEVEL	6.822	6.826	7.344	7.540	7.572	7.592	7.600	
OFFSET FROM CONTROL LINE	0.000	0.300	7.500	8.500	10.500	12.700	13.612	

CH 0

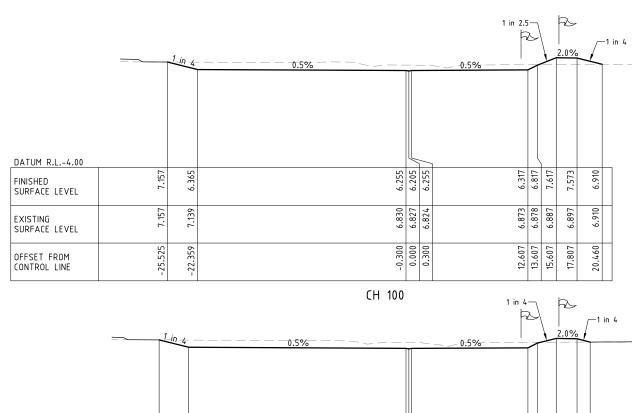

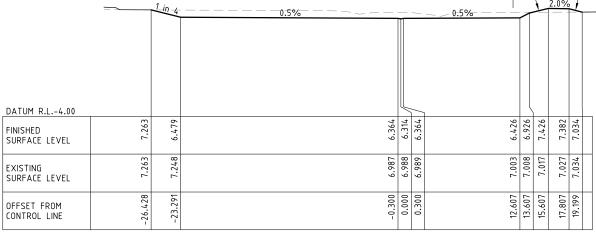

CH 80

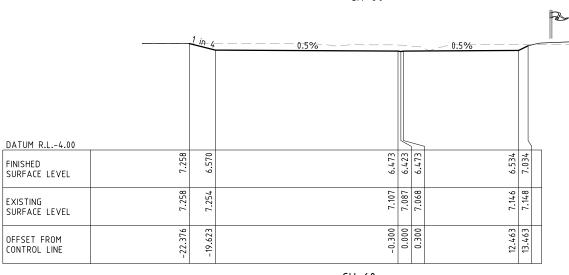

CH 60

### CHANNEL CROSS SECTIONS

SCALE 2 0 2 4 6 8 10 (metres) 1 : 200 (FULL SIZE)

RESERVE BOUNDA EXISTING SURFACE DESIGN SURFACE

ARY	
CE	

R

SCALE : AS NOTED

GC120023-01

PROJECT No.:

DATUM : AHD FULL SIZE : A


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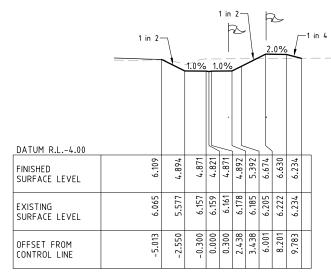
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DRAWING No.


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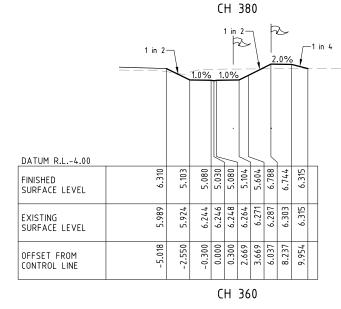
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	STAGE 1									
	CAPTAIN COOK HIGHWAY AND ANDREASSEN ROAD CRAIGLIE									
		prepared f	or							
		DOUGL PMENT								
	A1 of	RIGINAL SIZE BEFO	DRE R	EDUCTION						
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ABN	76 166 942			u						
-	ANDR	EASSEN AGE CH								
DRAW	NG TITLE :									
	NNEL	IERN DR CROSS IEET 1 C	SE	ECTIC						
	APPLIC, No.	8/13/1547		DATE: 1	9-12-14					
PROJEC		PHILIP BELL								
	PERSON	JEREMY FLYNN								
CHECKE		PHILIP BELL								
BURCH		O ON BEHALF OF		ABN 76 16	56 942 365					









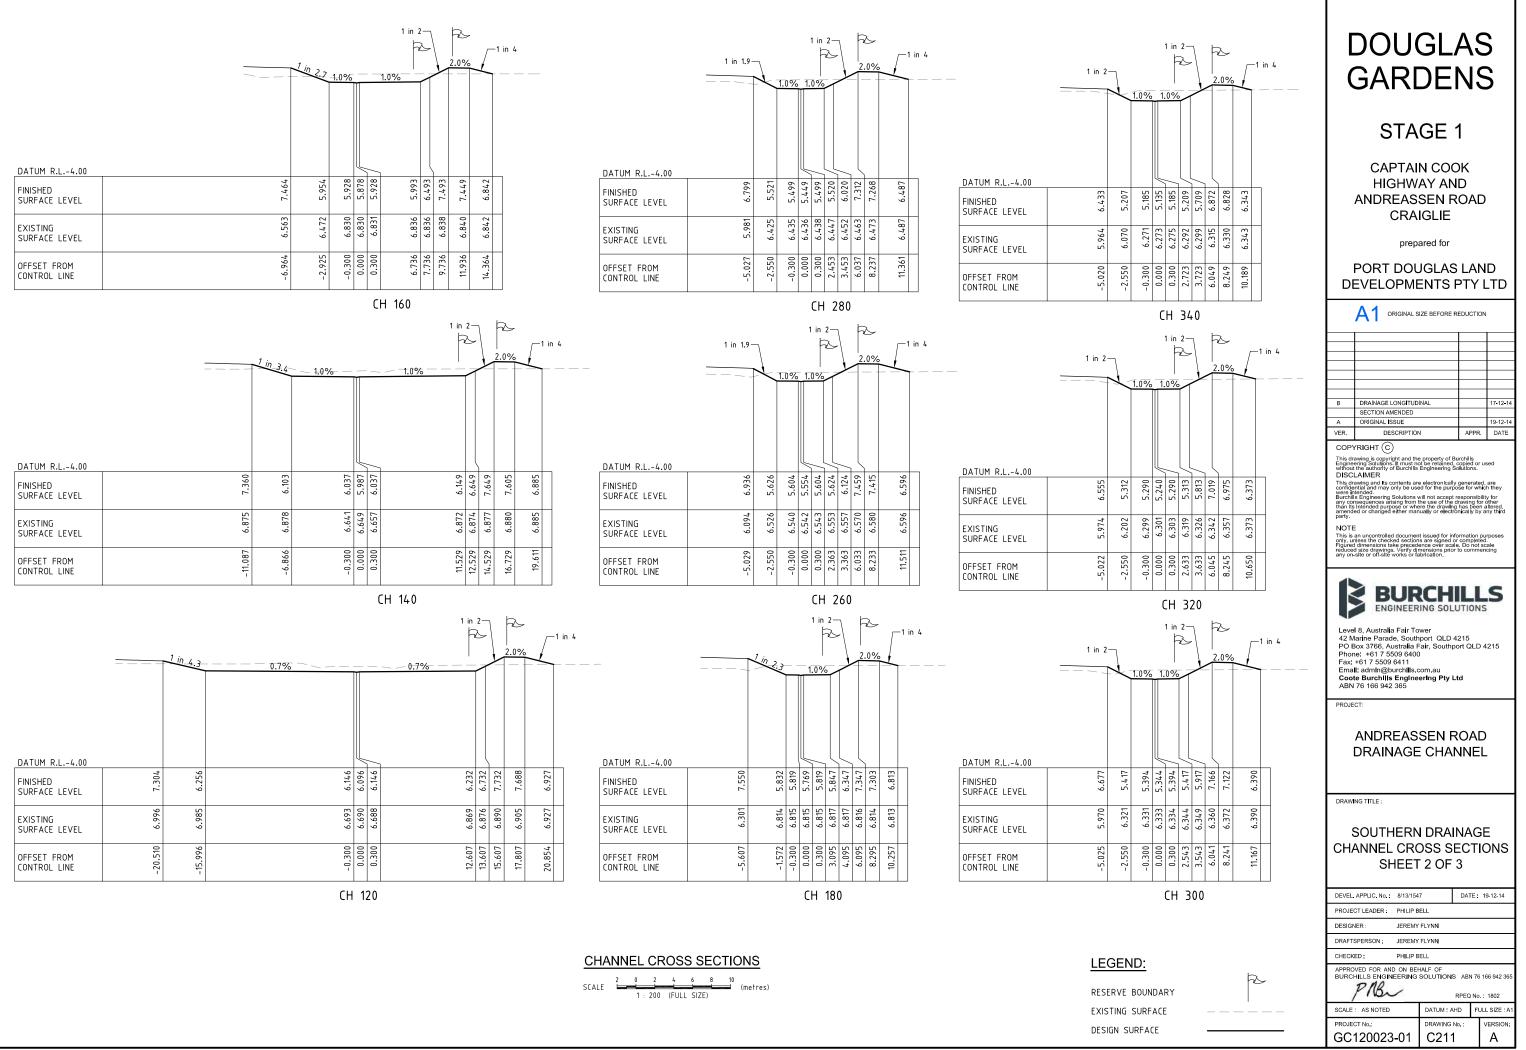

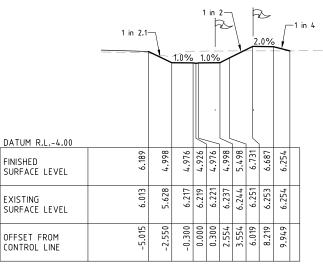

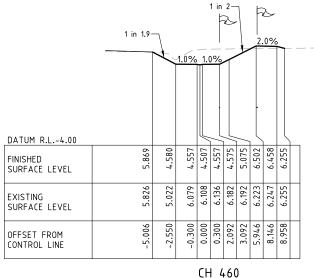

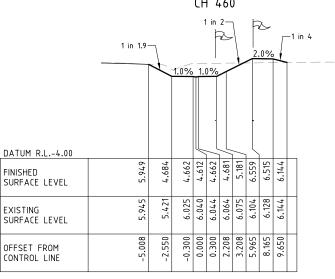

FINISHED


EXISTING


SURFACE LEVEL


SURFACE LEVEL


OFFSET FROM

CONTROL LINE

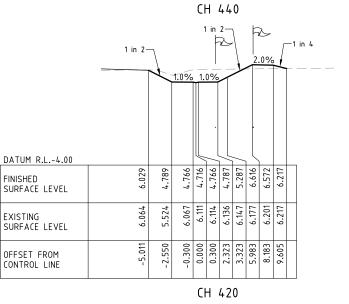

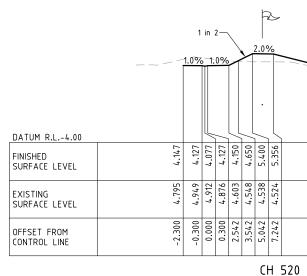

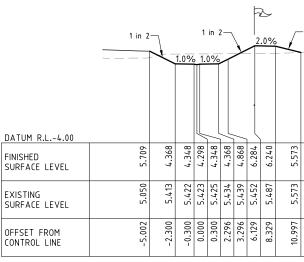

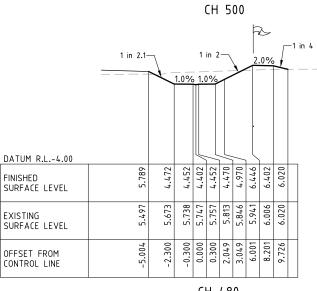



CHANNEL CROSS SECTIONS

1 : 200 (FULL SIZE) SCALE (metres)

LEGEND:

RESERVE BOUND EXISTING SURFA DESIGN SURFACE

<u>1 in 4</u>			
	2.639		
	18.107 2.639 2.639		
	18.107		
—1 in 4			
	-		

	1-
DARY	R
ACE	 
-	

# DOUGLAS GARDENS

### STAGE 1

CAPTAIN COOK HIGHWAY AND ANDREASSEN ROAD CRAIGLIE

prepared for

PORT DOUGLAS LAND DEVELOPMENTS PTY LTD

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BURCHILLS ENGINEERING SOLUTIONS

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PROJECT:

### ANDREASSEN ROAD DRAINAGE CHANNEL

DRAWING TITLE :

### SOUTHERN DRAINAGE CHANNEL CROSS SECTIONS SHEET 3 OF 3

DEVEL APPLIC No 8/13/154	8/13/1547 DATE: 17-12-14			
PROJECT LEADER : PHILIP E	PHILIP BELL			
DESIGNER : JEREMY	JEREMY FLYNN			
DRAFTSPERSON : JEREMY	JEREMY FLYNN			
CHECKED : PHILIP E	PHILIP BELL			
APPROVED FOR AND ON BEHALF OF BURCHILLS ENGINEERING SOLUTIONS ABN 76 166 942 365 PTB				
SCALE : AS NOTED	DATUM : AHD FULL SIZE : A1			
PROJECT NO.: GC120023-01	DRAWING No.: VERS			



### PART 4: SPECIALIST REPORTS

• N/A