

BULK EARTHWO No.307-01 PRKS - STAGE PRAWN FARM & 02

		SCHEDULE OF DRAWINGS
NUMBER	REV NO TITLE	3 100
GENERAL		
307-01-000	0	COVER SHEET
307-01-001	Α	GENERAL NOTES & LEGEND
307-01-003	Α	KEY PLAN
307-01-005	۸	EXISTING SURFACE PLAN-SHEET 01
307-01-006	۸	EXISTING SURFACE PLAN-SHEET 02
307-01-007	Þ	EXISTING SURFACE PLAN-SHEET 03
SEDIMENT & EROSION	ON NO	
307-01-010	В	CONTROL PLAN-SHEET 01
307-01-011	В	CONTROL PLAN-SHEET 02
307-01-012	В	CONTROL PLAN-SHEET 03
307-01-013	В	CONTROL PLAN-SHEET 04
307-01-014	В	CONTROL PLAN-SHEET 05
307-01-015	В	CONTROL PLAN-SHEET 06
307-01-016	В	CONTROL PLAN-SHEET 07
307-01-017	В	CONTROL PLAN-SHEET 08
BULK EARTHWORKS	S	
307-01-030	В	CUT FILL PLAN-SHEET 01
307-01-031	В	CUT FILL PLAN-SHEET 02
307-01-032	В	CUT FILL PLAN-SHEET 03
307-01-033	В	CUT FILL PLAN-SHEET 04
307-01-034	0	CUT FILL PLAN-SHEET 05
307-01-035	В	CUT FILL PLAN-SHEET 06
307-01-036	0	CUT FILL PLAN-SHEET 07
307-01-037	0	CUT FILL PLAN-SHEET 08
307-01-050	В	EARTHWORKS SECTIONS KEY PLAN
307-01-051	В	BULK EARTHWORK SECTIONS SHEET 01
307-01-052	В	BULK EARTHWORK SECTIONS SHEET 02
307-01-053	>	BULK EARTHWORK SECTIONS SHEET 03
TYPICAL SECTIONS AND DETAILS	AND DET	TAILS
307-01-090	۸	7:777 >>
,		SHEEL OIL



GOLD COAST MARINE AQUACULTURE



GENERAL

1. CONTRACT SPECIFICATIONS
ALL DRAWINGS ARE TO BE READ IN CONJUNCTION WITH THE CONTRACT SPECIFICATION.

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SETOUT

SURVEY SETOUT INFORMATION HAS BEEN ESTABLISHED ON SITE BY THE PRINCIPAL'S SURVEYOR

ENABLE THE CONTRACTOR TO ACCURATELY SETOUT THE WORKS TO THE CO-ORDINATES SHOWN.

SETOUT INFORMATION SHALL NOT BE OBTAINED BY SCALING FROM THESE DRAWINGS.

DATUM

LOCATION AND TO ALLO

LEVELS SHOWN ARE TO A.H.D.

EXISTING SERVICES - External Works

EXISTING SERVICES - EXTERNAL WORK

THE LOCATIONS OF ALL EXISTING SERVICES WITHIN THE WORK AREA SHALL BE CONFIRMED BY THE
CONTRACTOR PRIOR TO CONSTRUCTION COMMENCING. IT IS THE CONTRACTOR'S RESPONSIBILITY TO
CONTACT THE RELEVANT AUTHORITIES AND TO ENSURE THAT THE EXISTING SERVICES ARE NOT
DAMAGED OR DISTURBED IN ANY WAY.

ALL MATERALS ARISING FROM PAOADS AND SERVICES ARE TO BE COMPACTED TO FUTURE STAGES.

LEVEL 1 OR IF DIRECTED BY THE SUPERINTENDENT SHALL BE TRUCKED TO A LICENSED TIP.

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10 IH

CONSTRUCTION SEQUENCE/SILT MANAGEMENT PROGRAM

CONSTRUCT VEHICLE WASHDOWN AREA AND ASSOCIATED SILT MANAGEMENT DEVICES.

CONSTRUCT SITE OFFICE AND STORAGE COMPOUND AREA.

CONSTRUCT SITE OFFICE AND STORAGE COMPOUND AREA.

ERECT SILT FENCE AT LOW POINTS OF THE SITE AS DEMONSTRATED.

ERECT TEMPORARY TREE PROTECTION FENCING FOR VEGETATION TO BE RETAINED IN ACCORDANCE WITH AN OPW (TREE CLEARING) APPROVAL AND IN ACCORDANCE WITH AS4970 PROTECTION OF TREES ON DEVELOPMENT SITES.

CONSTRUCT ROCK CHECK DAMS AND SILT FENCES DOWNSTREAM OF BASIN. CONSTRUCT BASIN TO FULL DEPTH.

CONSTRUCT BALANCE OF BASIN IN CONJUNCTION WITH CLEARING AND BULK EARTHWORKS OPERATIONS. BASIN TO BE UTILISED AS TEMPORARY SEDIMENT BASIN. DO NOT FILL IN FILTRATION MATERIAL UNTIL CONSTRUCTION OF DEVELOPMENT IS COMPLETE & DIRECTED BY SUPERINTENDENT.

CLEARING AND BULK EARTHWORKS
THERE SHALL BE NO CLEARING OF PROTECTED SIZE VEGETATION WITHOUT AN APPROVED TREE CLEARING PLAN WHICH SHALL BE IN ACCORDANCE WITH AS 4.970.

SILT FENCE. SAND BAGS AND EARTH RILLS TO BE ERECTED AS INDICATED OR REQUIRED DURING CLEARING.
SUPERING.

WORKS. SILT FENCES AND EARTH RILLS WITHIN ROADS TO BE ERECTED AS INDICATED OR REQUIRED DURING EARTHWORKS.

EARTHWORKS.

CONSTRUCTION OF SEWER/ROOFWATER/STORMWATER/SERVICES

EXCAVATED MATERIAL TO BE PLACED ON HIGH SIDE OF TRENCH AND TO PROTECT PIPE WORK AND

EXCAVATED MATERIAL TO BE PLACED ON HIGH SIDE OF TRENCH AND TO PROTECT PIPE WORK AND

DIRECT SURFACE MATERIAL AWAY TROM EXCAVATIONS.

TOPSOIL AND GRASS SEED AREAS IN ALLOTHENTS IMMEDIATELY AFTER COMPLETING THE SEWER AND

ROOFWATER DRAINAGE CONSTRUCTION.

DEPRESS GROUND AROUND TEMPORARY FIELD INLETS TO CREATE SILT POND.

CONSTRUCTION - SEDIMENT BASIN SEDIMENT BASIN SEDIMENT BASIN TO BE CONSTRUCTION OF ALL STAGES.

PLACE SPOIL FROM SEDIMENT DASIN INTO ALLOCATED AREA AS ENGINEERED FILL IN ACCORDANCE WITH THE STAKING ORDER.

SECONSTRUCTION - STOCKPILING

TEMPORARY SILT FRUCE TO BE REFECTED 5m FROM TOE OF BATTER ON LOW SIDE OF STOCKPILING.

STOCKPILE SITE TO BE CLEAR OF ADJACENT PROPERTY BOUNDARIES SO AS NOT TO CAUSE A NUISANCE TO ADJOINING PROPERTIES.

NO STOCKPILES ARE TO BE LOCATED WITHIN THE DRIP ZONE OR STRUCTURAL ROOT ZONE OF ANY

RETAINED VEGETATION.

CONSTRUCTION - ROADWORKS

SILT FRUCES TO ALLOTMENTS TO BE REFECTED.

KERB INLET PROTECTION TO BE PROVIDED TO ALL GUILLES.

TOPSOIL AND SEED ALLOTMENTS.

TOPSOIL AND SEED ALLOTMENTS TO BE REFECTED.

SUFFICIENT (BROW WITHIN 30 CALENDAR DAYS OF FINAL ALLOTMENT TRIMMING).

POST CONSTRUCTION - ALLOTMENTS.

TOPSOIL AND TIRFING IS TO BE REMOVED IF THE SUPERINTENDENT INDICATED THE GRASS STRIKE IS SUFFICIENT (BROW WITHIN 30 CALENDAR DAYS OF FINAL ALLOTMENT TRIMMING).

POST CONSTRUCTION - ALLOTMENTS.

TOPSOIL AND TIRFING IS TO BE REPOVEDE DEHNID KERB.

THE SULT FRUCES ARE TO POST CONSTRUCTION WEREN.

ANY DEPARTS REQUIRED ARE TO BE SUPECIFIED WEEKLY.

ANY DEPARTS REQUIRED ARE TO SOST CONSTRUCTION.

AND TERPARS TROUBED ARE TO BE MSPECTED WEEKLY.

ANY DEPARTS REQUIRED ARE TO BE REFORMED FROM STREETS AND ALLOTMENTS IMMEDIATELY AND CORRECTIVE ACTION TAKEN TO AVOID A RE-OCCURRENCE OF THE FAILURE.

BASIN CONSTRUCTION

1. PRIOR TO COMMENCING CONSTRUCTION OF THE DETENTION BASIN THE DIVERSION OF SURFACE WATER FROM THE PROPOSED WORKS AREA, USING MEASURES SUCH AS OPEN DRAINS/SUMPS, ARE REQUIRED TO AID IN SITE DEWATERIG.

2. BASIN TO CONTINUE ACTING AS SEDIMENT BASIN UNTIL 85% OF CATCHMENT CONSTRUCTION IS COMPLETE.

3. THE CLAY FILLING FOR THE BASIN WALLS SHALL BE PLACED IN HORIZONTAL LAYERS OF ZOOMM THICKNESS AND COMPACTED TO A DENSITY RATIO WITHIN THE RANGE 98% - 102% STANDARD COMPACTION (AS 1289.5.1.1), PLACEMENT MOISTURE CONTENTS FOULD BE WITHIN THE RANGE OMC - 0PTIMUM MOISTURE CONTENTS TANDARD COMPACTION).

4. CONTRACTOR TO PROVIDE SAFETY FENCING TO BASINS DURING CONSTRUCTION & APPROPRIATE SIGNAGE (PERMANENT OR TEMPORARY).

SEDIMENT 1. THE OBJECT

AND EROSION
TIVE OF THE EROSION AND SEDIMENT CONTROL PROGRAM ARE TO:
STORMWATER TO PASS THROUGH THE SITE IN A CONTROLLED MANNER AT

A ALLOW STORMANTER TO PASS THROUGH THE SITE IN A CONTROLLED MANNER AT NON-EROSIVE FLOW VELOCITIES.

AN ALLOW YELDOWN ALLOW AND SEDIMENT CONTROLLED WITH DISCHARGE FLOW VELOCITIES.

I) MINIMES SOL EROSON FROM MATER AND WIND.

I) MINIMES SOL EROSON FROM MATER AND WIND.

I) MINIMES SOL EROSON AND SEDIMENT CONTROLLED WITH DISCHARGE FROM THE CONSTRUCTION STIE.

E) ENSURE THAT THE VALUE AND USE OF RESIDENTIAL PROPERTIES ADJACENT TO THE DEVELOPMENT ARR NOT DIMINISHED AS A RESULT OF THE MIGRATION OF SEDIMENT REGISSION AND SEDIMENT CONTROLLED WITH THE EDWINDERNIAL BEST PRACTICE FOR EPOSION AND SEDIMENT CONTROLLED WITH THE SOL EROSON AND SEDIMENT CONTROLLED WITH THE GONERAL MAD SEDIMENT CONTROLLED WITH THE DIAMNING THE CONTRACTOR SHALL TAKE ALL NECESSARY PRECAUTIONS TO CONTROL HE DIAMNING THE FINISHED EARTHWORKS DESIGN SHOWN ON THE DRAWINGS THE CONTRACTOR STREAM SEDIMENT ATION DURING ALL STAGES OF CONSTRUCTION INCLUDING THE MANNER PRACTICES AS NECESSARY TO MINIMISE THE CONTRACTOR MAD SEDIMENT CONTROLLED WITH THE DIAMNING THE CONTRACTOR IS TO POLICIPAL THE CONTRACTOR IS TO POLICIPAL THE CONTRACTOR IS TO POLICIPAL THE CONTRACTOR IS TO FOLLOW THE CONSTRUCTION PHASE AS OUTLINED IN THE CONSTRUCTION SEDIMENT CONTROLLED WITH STABLE OF THE SOLICIPAL WITH SEDIMENT REQUEST THE CONTRACTOR IS TO POLICIPAL THE CONTRACTOR IS TO FOLLOW THE CONSTRUCTION PHASE AS OUTLINED IN THE CONSTRUCTION AND DONE THE PROPECTION AND DONE EARTHWORKS.

3. THE CONTRACTOR IS TO POLICIPAL THE CONTRACTOR SHALL BE WINNIESTED POSITIVE GRADE TO AN OUTLIET. AT ALL THESE THE CONTRACTOR SHALL BE STRIPPED AND STORYELD BY SUFFERNING SHALL MONTROL THE PREVAILING MEATHER CONDITIONS AND PROPECT ANY DOWNSTREAM CONSTRUCTION AND CONTRACTOR SHALL BE STRIPPED AND STORYELD BY THE SUBMENT MEATHER THE DISPERSANT CHARACTOR SHALL BE STREAMED AND STORYELD BY THE SUBMENT CONTROLLED WITH THE SUBMENT CONTROLLED BY THE SUBMENT CONTROLLED WITH THE SUBMENT CONTROLLED BY THE SUBMENT C

BATTERS WITHIN PUBLIC OPEN SPACE TO BE VEGETATED IN ACCORDANCE WITH APPROVED OPEN SPACE MANAGEMENT BLAN (IOSMP).

BATTERS WITHIN PUBLIC OPEN SPACE TO BE VEGETATED IN ACCORDANCE WITH APPROVED OPEN SPACE MANAGEMENT PLAN (IOSMP).

IT IS THE CONTRACTORS RESPONSIBILITY TO CLEAN OUT GPT'S, FOREBAYS AND ALL OTHER SEDIMENT CONTROL DEVICES AT BOTH ON AND OFF MAINTENANCE. THE CONTRACTOR SHALL ALLOW FOR THE COST OF THESE WORKS WITHIN HIS SUBMITTED TENDER PRICE.

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EARTHWORKS/ROADWORKS 1. TOPSOIL STRIPPING

TESTING AUTHORITY.

TOPSOIL STRIPPING

TOPSOIL STAIL BE STRIPPED ACROSS THE ENTIRE LIMIT OF THE EARTHWORKS CUT AND FILL AREAS AND SHALL BE STOCKPILED IN A LOCATION APPROVED BY THE SUPERINTENDENT. THE EXISTING STRATA IS TO BE TREATED IN ACCORDANCE WITH THE SPECIFICATION PRIOR TO PLACING ANY FILL.

2. EARTHWORKS LEVELS

EARTHWORKS LEVELS SHOWN ON DRAWINGS ARE TO FINISHED SURFACE LEVELS AND INCLUDE 100mm OF TOPSOIL.

3. COMPACTION STANDARD

SITE FILLING AND TRENCH BACKFILL SHALL BE COMPACTED TO THE STANDARDS OUTLINED IN DSC STANDARD SPECIFICATION SSA.

4. PAVEMENT DEPTHS

THE DESIGN PAVENENT DEPTHS ALLOWED IN EARTHWORKS CALCULATIONS ARE BASED ON THE DESIGN DEPTHS ONLY AND MAY BE VARIED AFTER SUBGRADE TESTS ARE TAKEN.

5. TESTING

ALL COMPACTION TESTING SHALL BE TESTED AT LEVEL 1 REQUIREMENTS.

6. TOPSOIL FROM ONSITE STOCKPILES. THE TOPSOIL SHALL BE SCREENED PRIOR TO PLACING IF DIRECTED BY SUPERINTENDENT. THE CONTRACTORS SHALL BE TOPSOIL SHALL BE SCREENED PRIOR TO PLACING IF DIRECTED BY SUPERINTENDENT. THE CONTRACTOR SHALL ALLOW IN HIS RATE FOR SCREENING, THE DISPOSAL OF REJECT MATERIAL TO TIP OFFSITE INCLUDING ALL FEES.

7. GRASSING

ALL CUT-FILL AREAS, DISTURBED AREAS AND TRENCHED AREAS SHALL BE GRASSED TO THE SUBSOIL DRAINS ARE TO BE CONSTRUCTED IN ACCORDANCE WITH DSC STD DAG SCREENING. THE SUPERINTENDENT.

8. SUBSOIL DRAINS

8. SUBSOIL DRAINS ARE TO BE PLACED UNDER ALL KERB STRUCTURES AND ARE TO BE CONSTRUCTED TO A DEPTH GREATER THAN THAT OF THE INVERTION OF THE DEEPEST SERVICE CROSSING.

7. FORCK

THE CONTRACTOR STANDARD AND SHALL BE PLACED UNDER ALL KERB STRUCTURES AND ARE TO BE CONSTRUCTED TO A DEPTH GREATER THAN THAT OF THE INVERTION OF THE DEEPEST SERVICE CROSSING.

THE CONTRACTOR IS TO INCLUDE ROCK EXCAVATION AS PART OF THEIR EARTHWORKS RATE.

I. EARTHWORKS ZONE

I. EARTHWORKS ZONE

II. EARTHWORKS ZONE

II. EARTHWORKS ZONE

III. FOLLOWING ACTIVITIES ARE PROHIBITED OUTSIDE THE EARTHWORKS ZONE - STORAGE AND MIXING OF MATERIALS, VEHICLE PARKING, LIQUID DISPOSAL, MACHINERY REPAIRS/REFUELING, PLACEMENT OF SITE OFFICES OR SHEDS, COMBUSTION OF ANY MATERIAL, STOCKPULING OF SOIL, RUBBLE OR DEBRIS, ANY FILLING OR EXCAVATION UNCLUDING TRENCHES, TOSSOIL, SAMMING AND OR SURFACE EXCAVATION UNLESS OTHERWISE APPROVED BY DSC CHIEF EXECUTIVE OFFICER.

STOCKPILES

THE CONTRACTOR SHALL NOT CREATE STOCKPILES OF SURPLUS MATERIALS UNLESS DIRECTED BY THE SUPERINIENDANT. ALL MATERIALS ARISING FROM THE WORKS SHALL BE COMPACTED TO FUTURE FILL AREAS AS NOMINATED.

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EXISTING RISING MAIN	PROPOSED GAS, ELECTRICITY, TELSTR	— PROPOSED ELECT, TELSTRA	— PROPOSED GAS, TELSTRA	— PROPOSED GAS, ELECT	PROPOSED COMMUNICATIONS	PROPOSED TELSTRA	PROPOSED LIGHTING	PROPOSED OVERHEAD ELECTRICITY	— PROPOSED UNDERGROUND ELECTRICITY	— PROPOSED HIGH VOLTAGE ELECTRICITY	PROPOSED PIPELINE	PROPOSED GAS	— PROPOSED FUEL	— PROPOSED OIL	PROPOSED RECYCLED WATER	PROPOSED WATER	PROPOSED SUBSOIL	PROPOSED ROOFWATER	PROPOSED STORMWATER	PROPOSED SEWER	PROPOSED RISING MAIN	SERVICES LEGEND

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FE A TURE LEGEND ION FENCE FLAGGING TAPE FENCE FLAGGING TAPE FENCE FLAGGING LL (PILED) LL (WITH FOOTINGS) R / BERM IW PATH/SWALE (NOT LINED) ONCRETE LINED)

NATIONAL CALLOS E POR POR POR SERVICE DE CONTRACTOR DE CON	**************************************	W S RM S RM	SS		
	SEWER MAIN SEWER STORMWATER STORMWATER SUBSOIL WATER OIL HIGH VOLTAGE ELECTRICT UNDERGROUND ELECTRICTY OVERHEAD ELECTRICTY	RISING MAIN SEWER STORMWATER ROOFWATER SUBSOIL WATER RECYCLED OIL FIEL GAS PPELINE GAS COMMUNICATIONS COMMUNICATIONS	RISING MAIN SEWER STORMWATER SOUSON EVERTER RECYCLED WATER OIL WATER FUEL GAS PIPELINE HIGH VOLTAGE ELECTRIC UNDERGROUND ELECTRIC UNDERGROUND ELECTRIC OVERHEAD ELECTRICITY LIGHTING TELSTRA COMMUNICATIONS GAS, ELECT GAS, ELECT GAS, ELECTRICITY, TELSTRA ELECT, TELSTRA	PROPERTY LINE WITH F PROPERTY LINE WITH F PROPERTY LINE WITH F PROPERTY LINE WITH F PROPERTY KERB COUNTY BOUNDARY KERB COUNTY BOUNDARY KERB RAILWAY (MAJOR) RAILWAY (MINOR) RAILWAY (MINOR) RAILWAY (MINOR) RAILWAY (MINOR) RAILWAY (MINOR) RAILWAY WORKS VI BOUNDARY CONTOURS ONTOURS ONTOURS ONTOURS	Y LINE Y LINE WITH FENCE KERB, FOOTPATHS KERB, OF KERB LINE / CENTER OF ROA

R. P. DESCRIPTION	BULK EARTHWORKS-STAGE 01 &	CHANGE OF LEVEL OF LAND	MOSSMAN	PROJECT NAME


LOT 8, NR153 MOSSMAN FARM

	GOLD COAST MARINE
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DESIGNED RB	mortons@urbansolutions.net.au www.urbansolutions.net.au Tel 07 5571 1099 Fax 07 5571 1088	MUS Pty Ltd T/As: Mortons-Urban Solutions ABN: 39 116 375 065	Urban & Regional Pla Civil Engineering Project Coordination	
DRAWN RV	Gold Coast Office Suite 9, 19 Short St Southport QLD 4215	Postal Address PO Box 2484 Southport QLD 4215	onal Planning ring dination	SNOI


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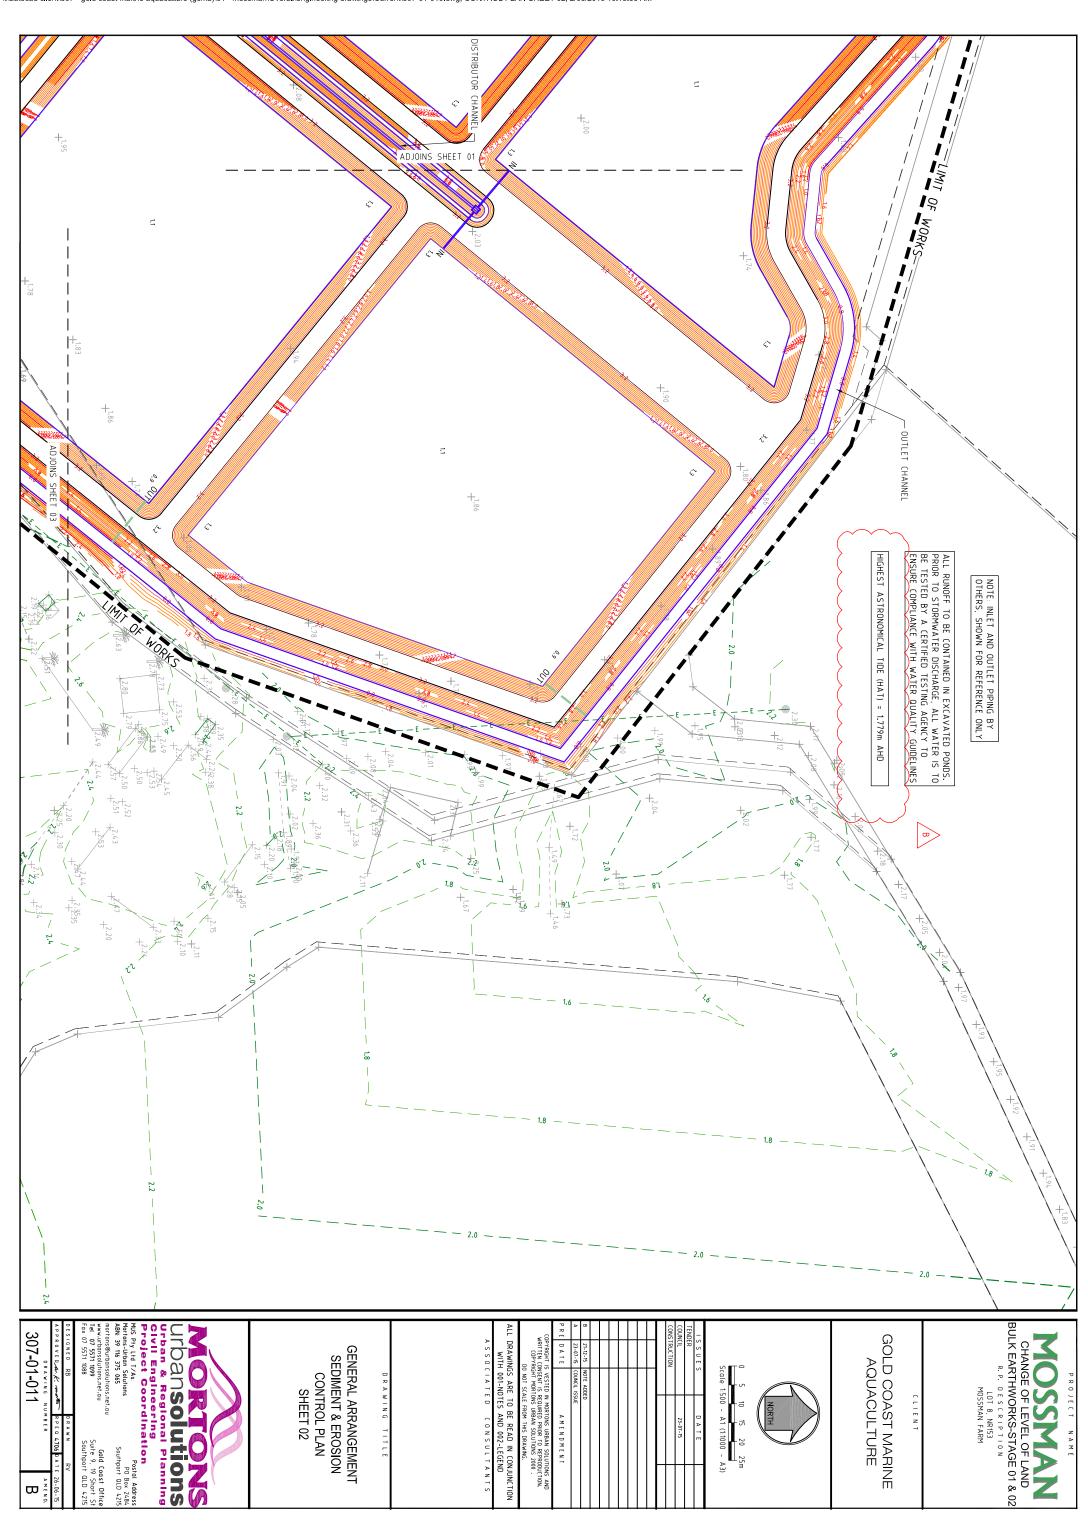








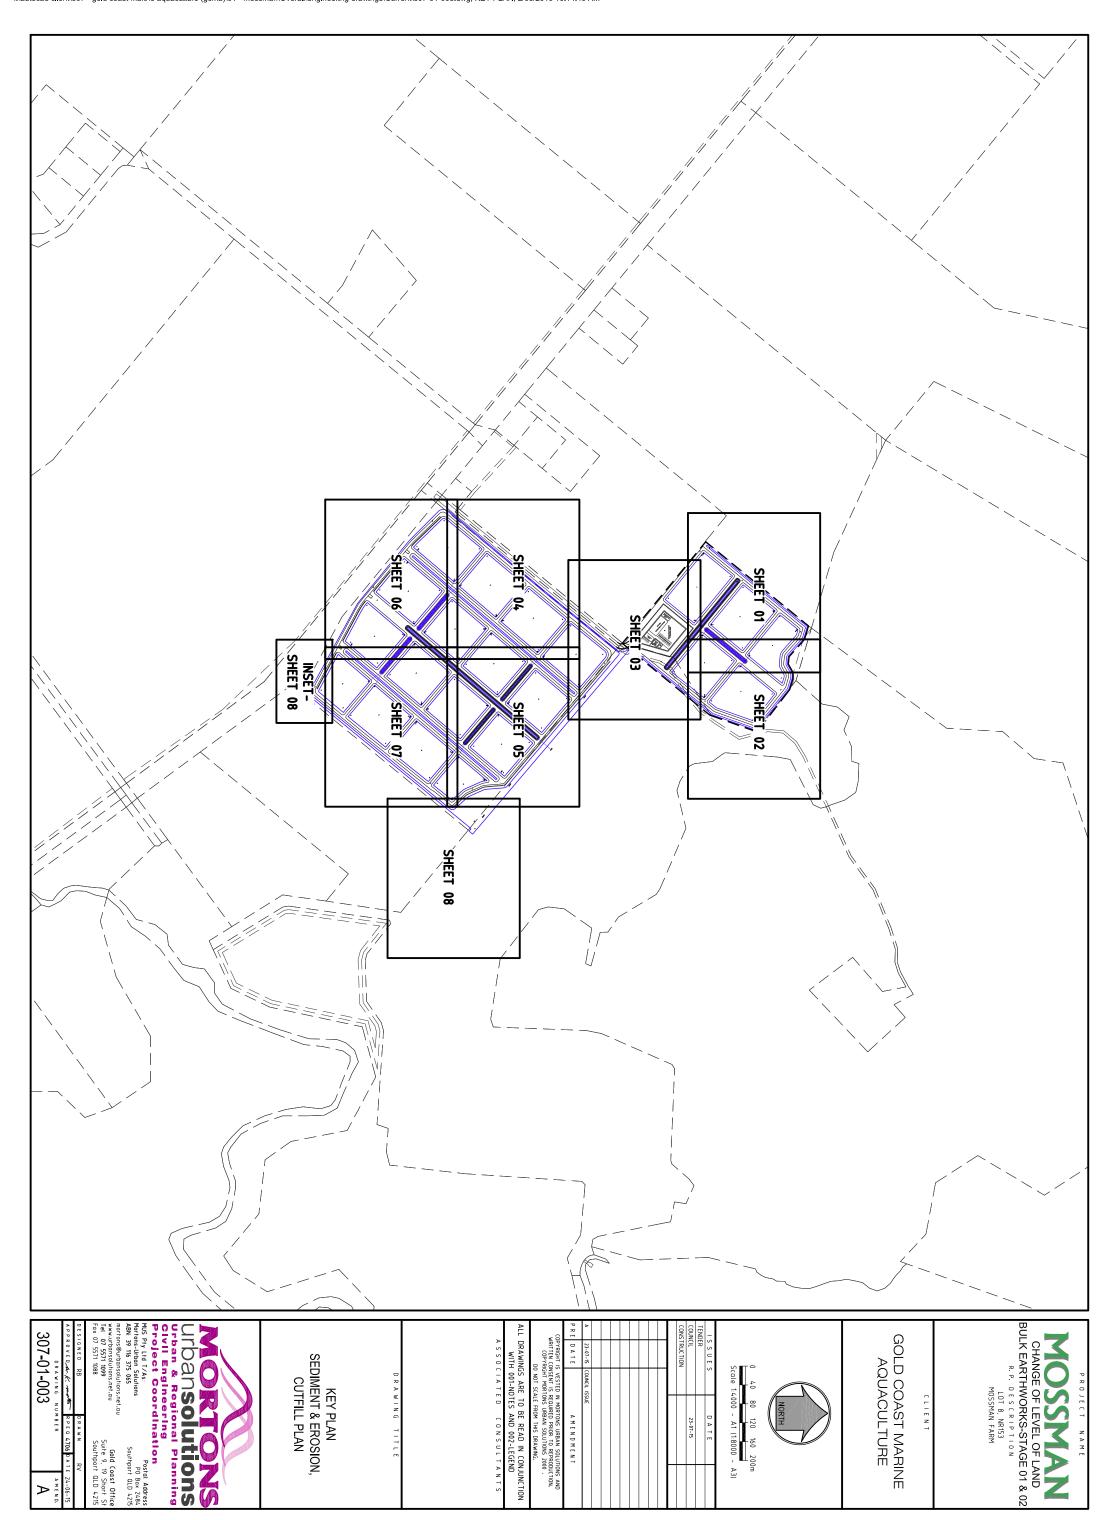





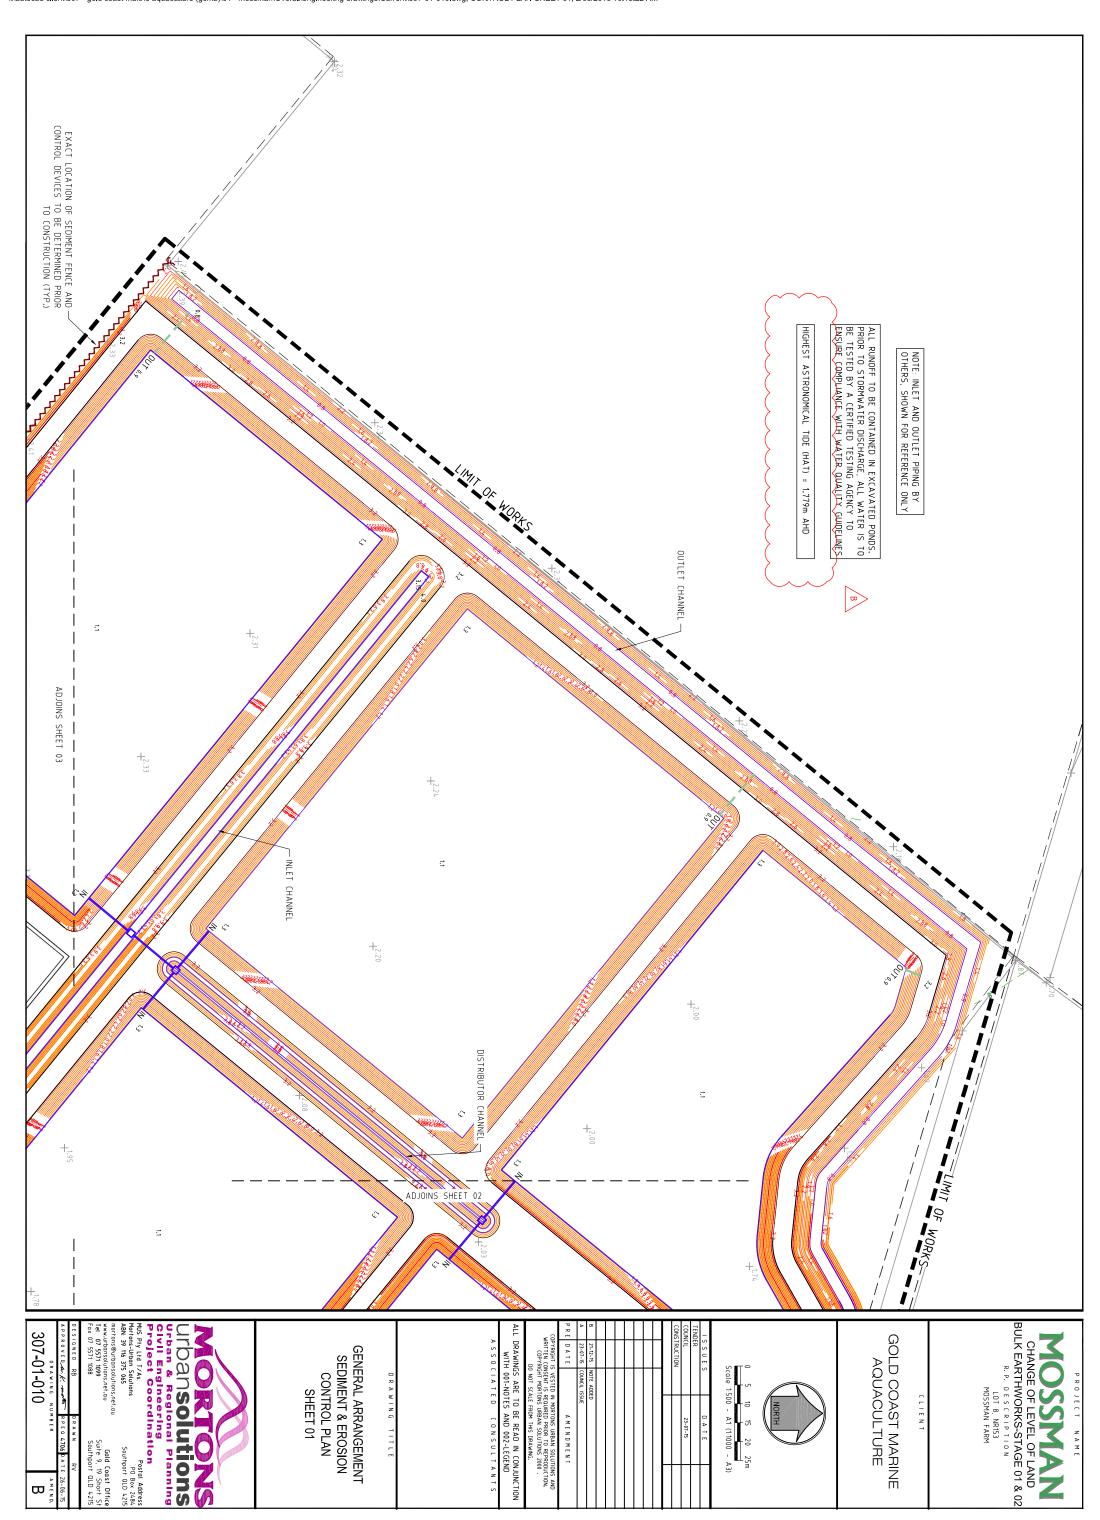


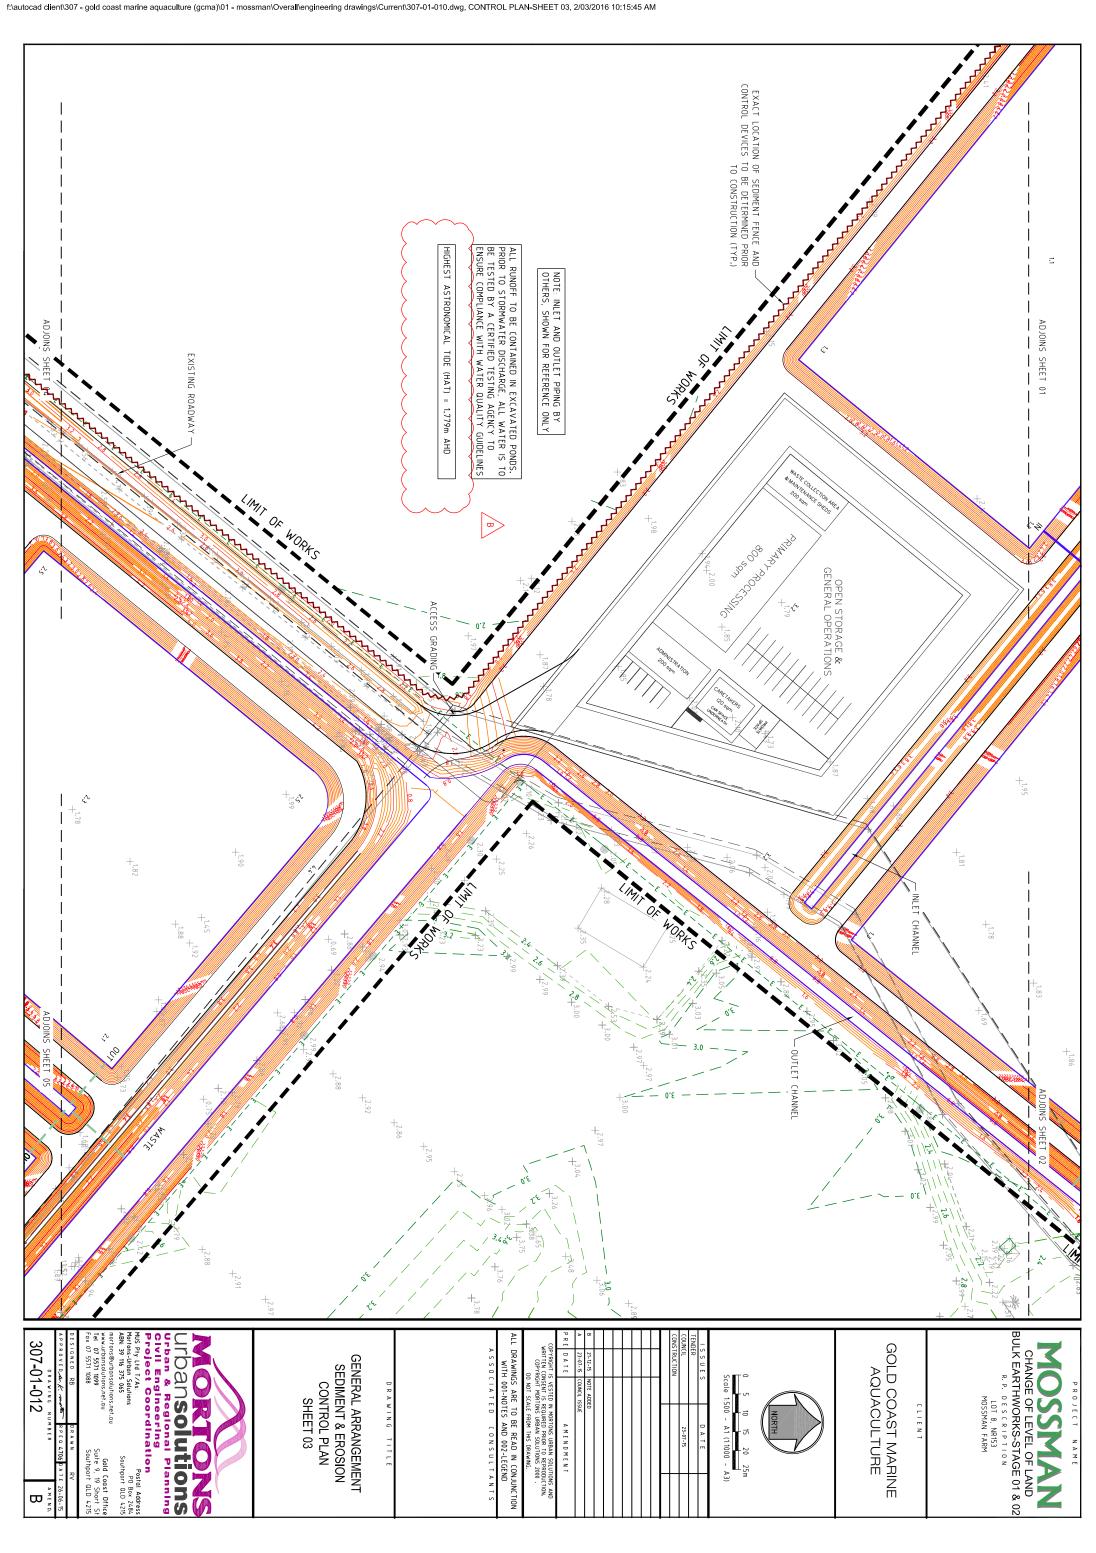


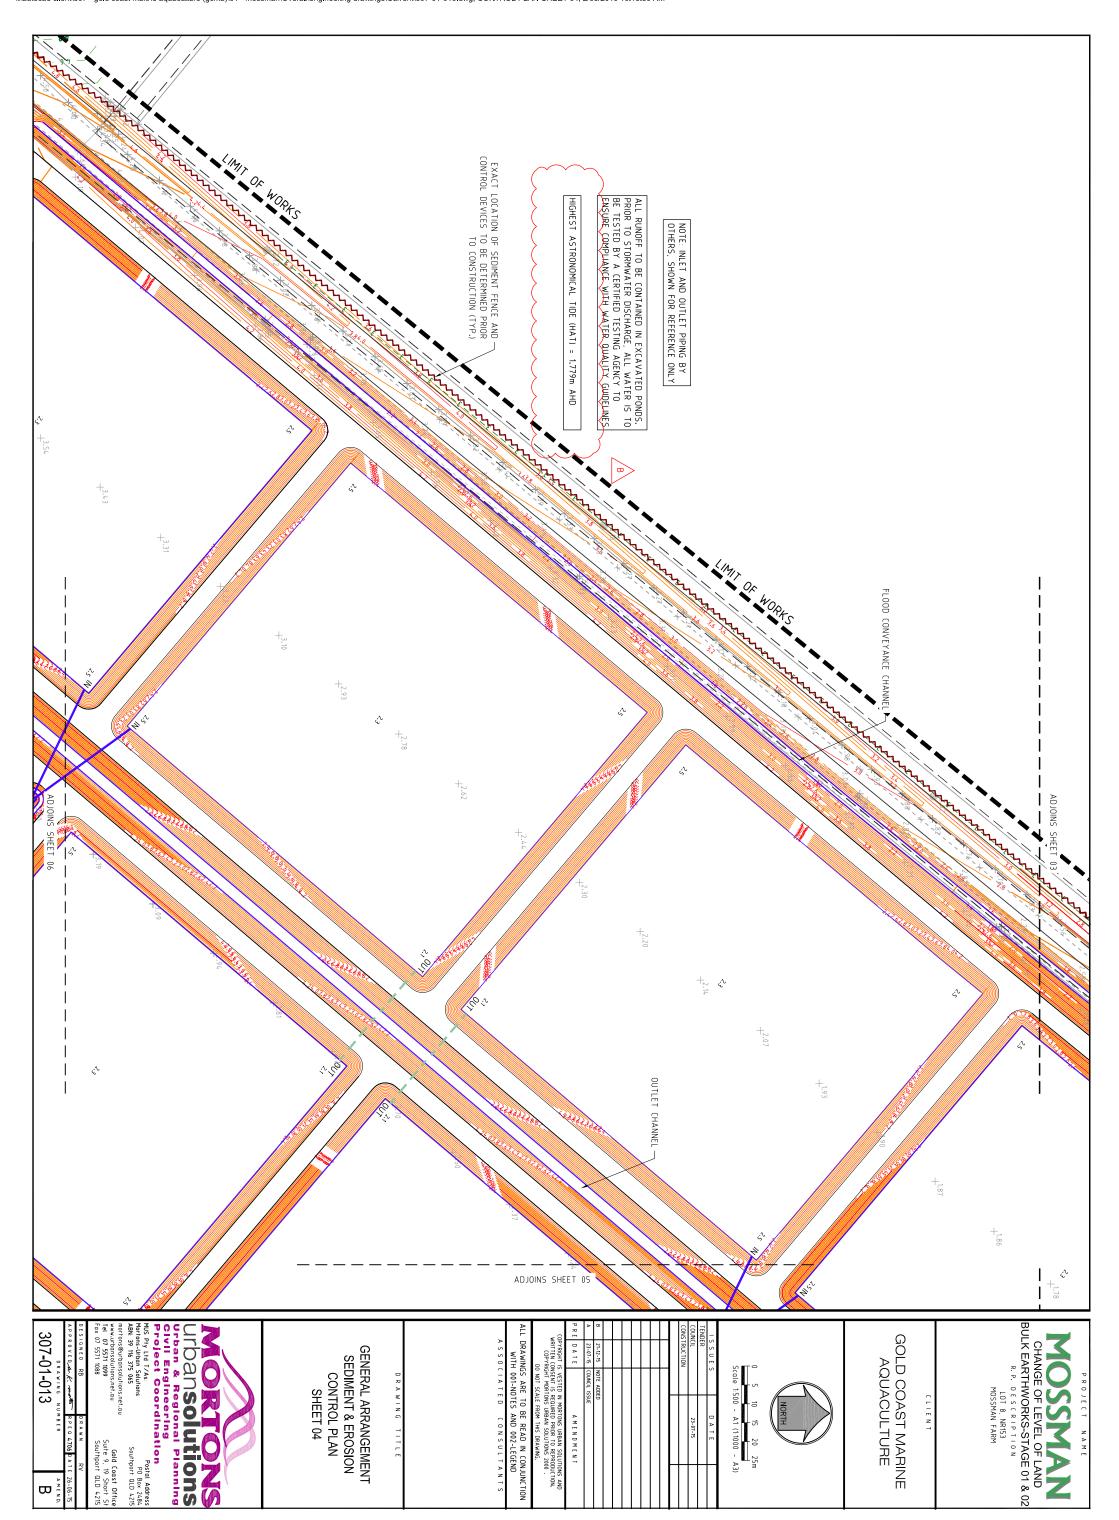


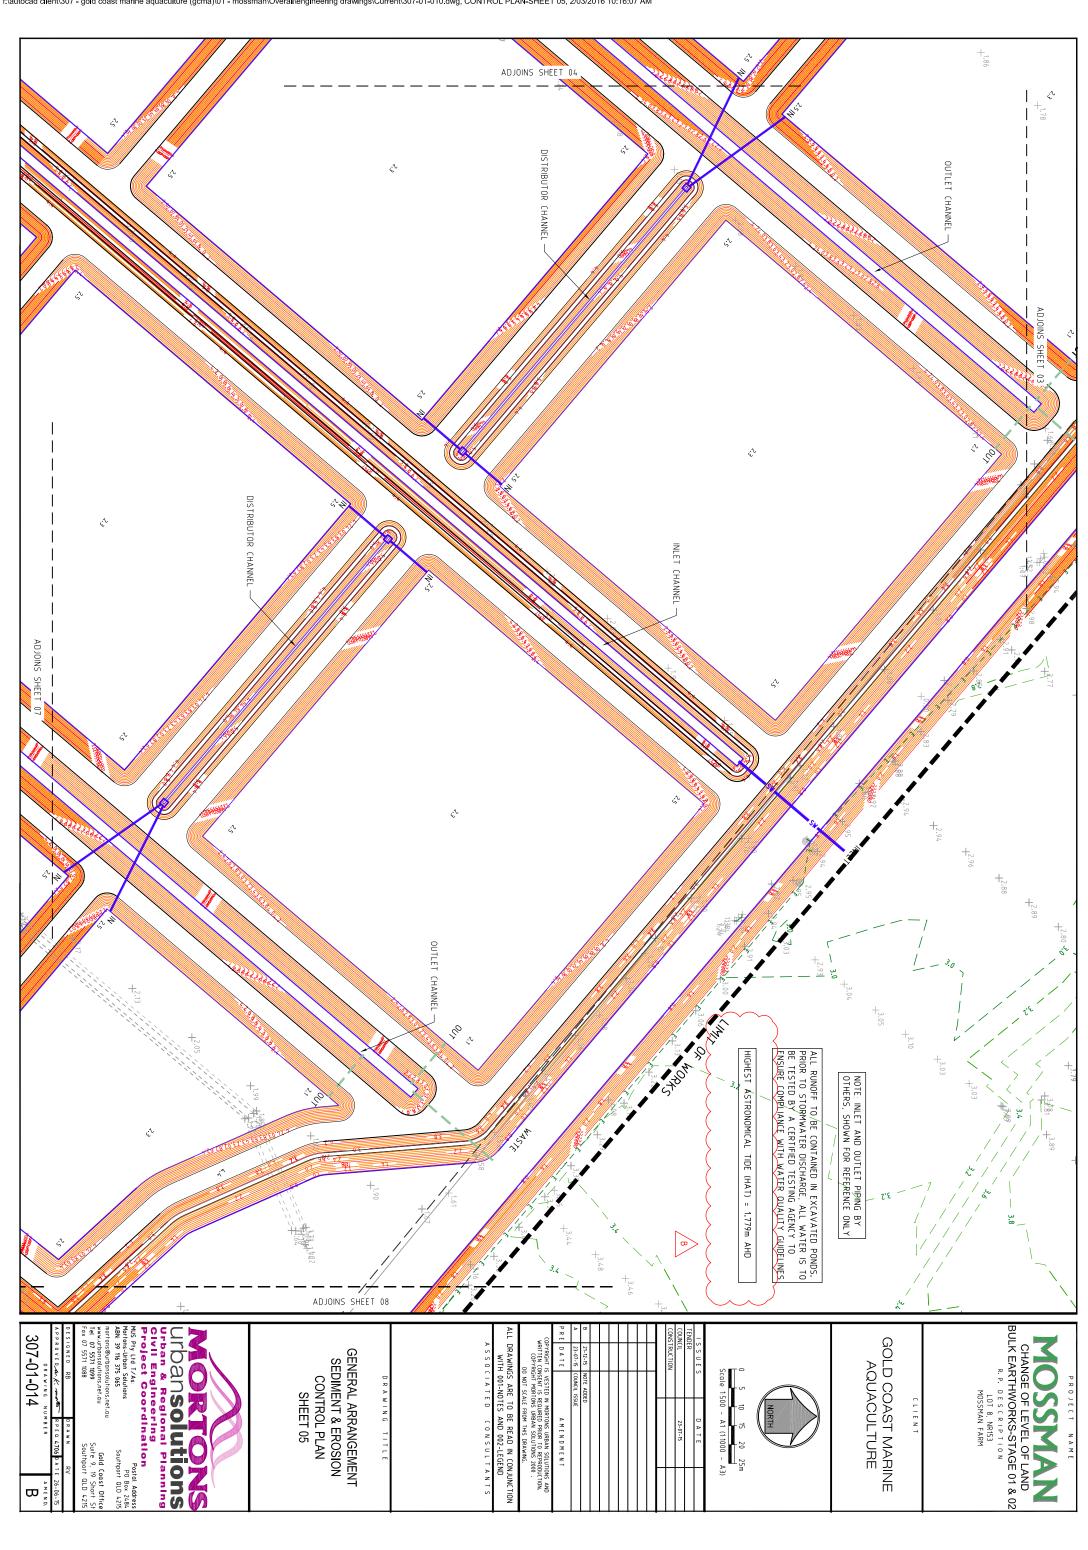


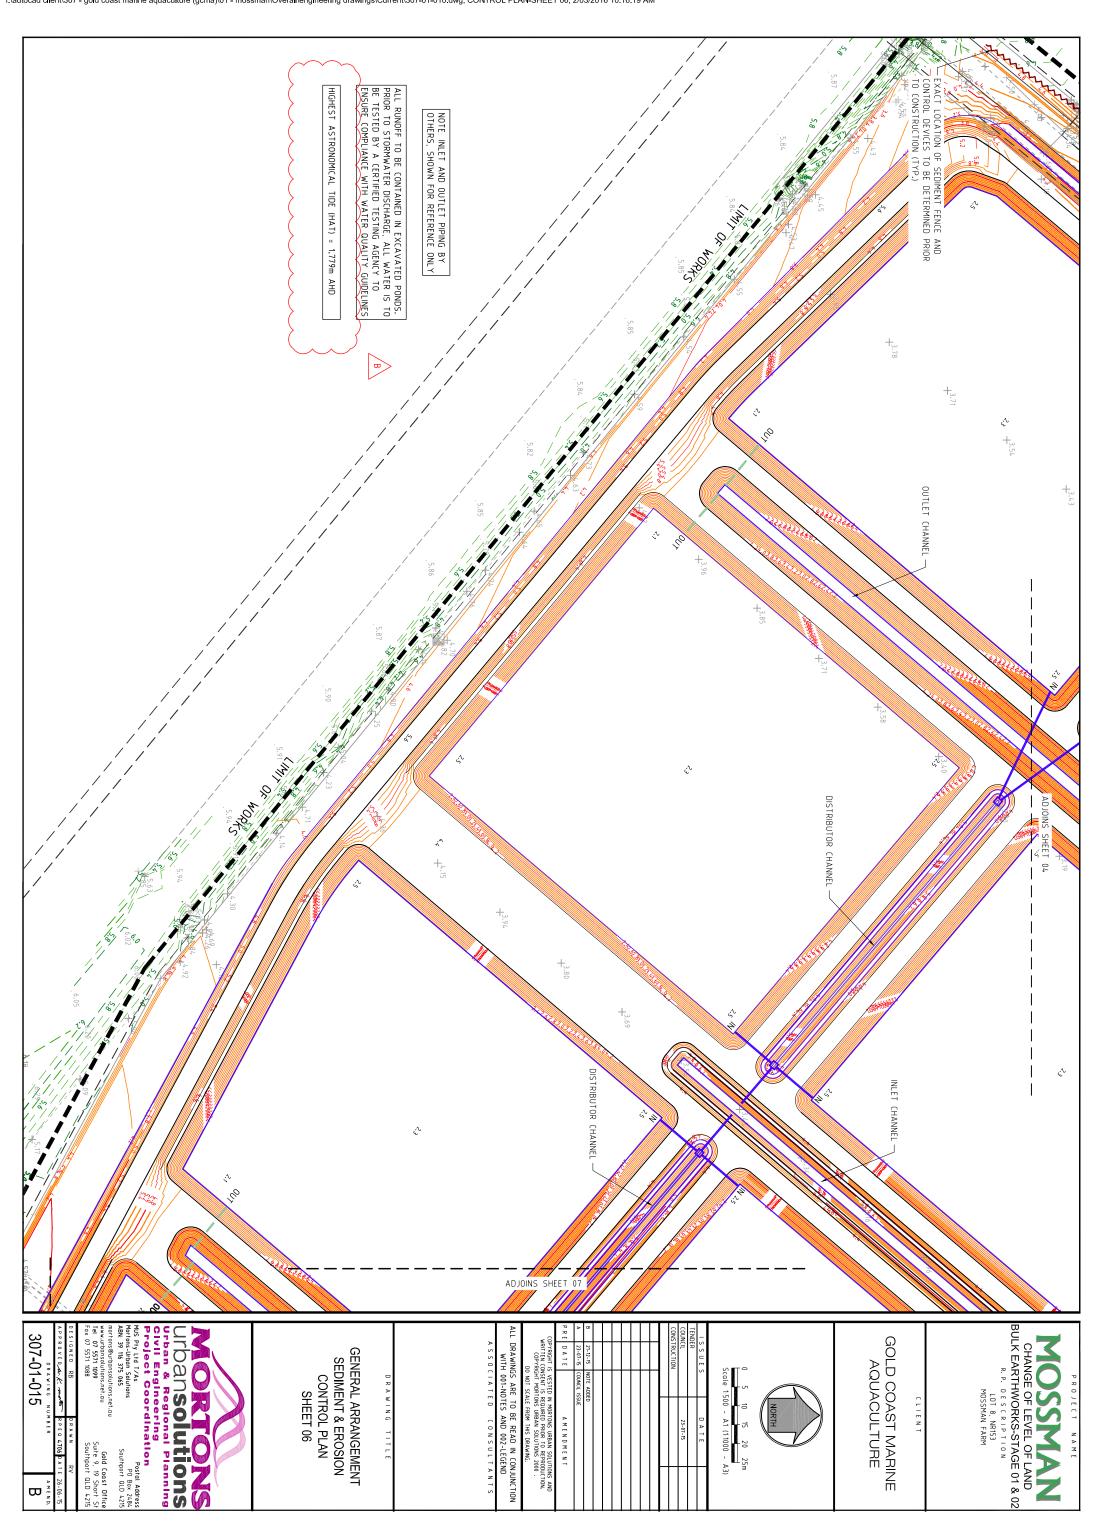


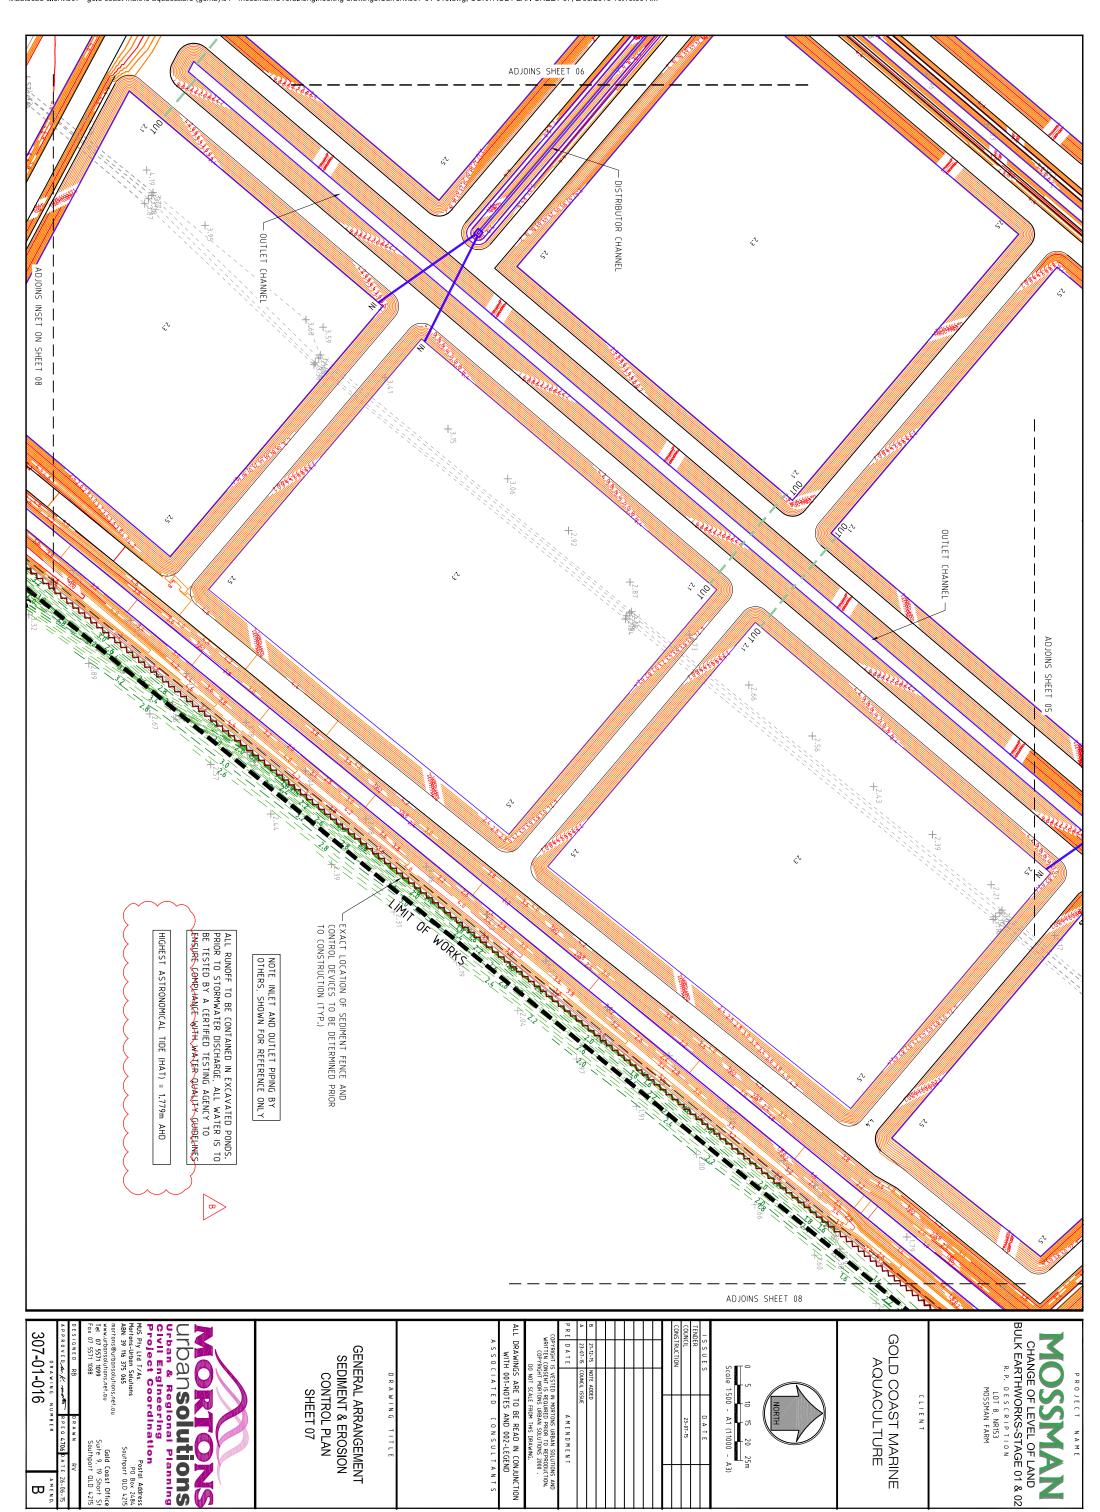


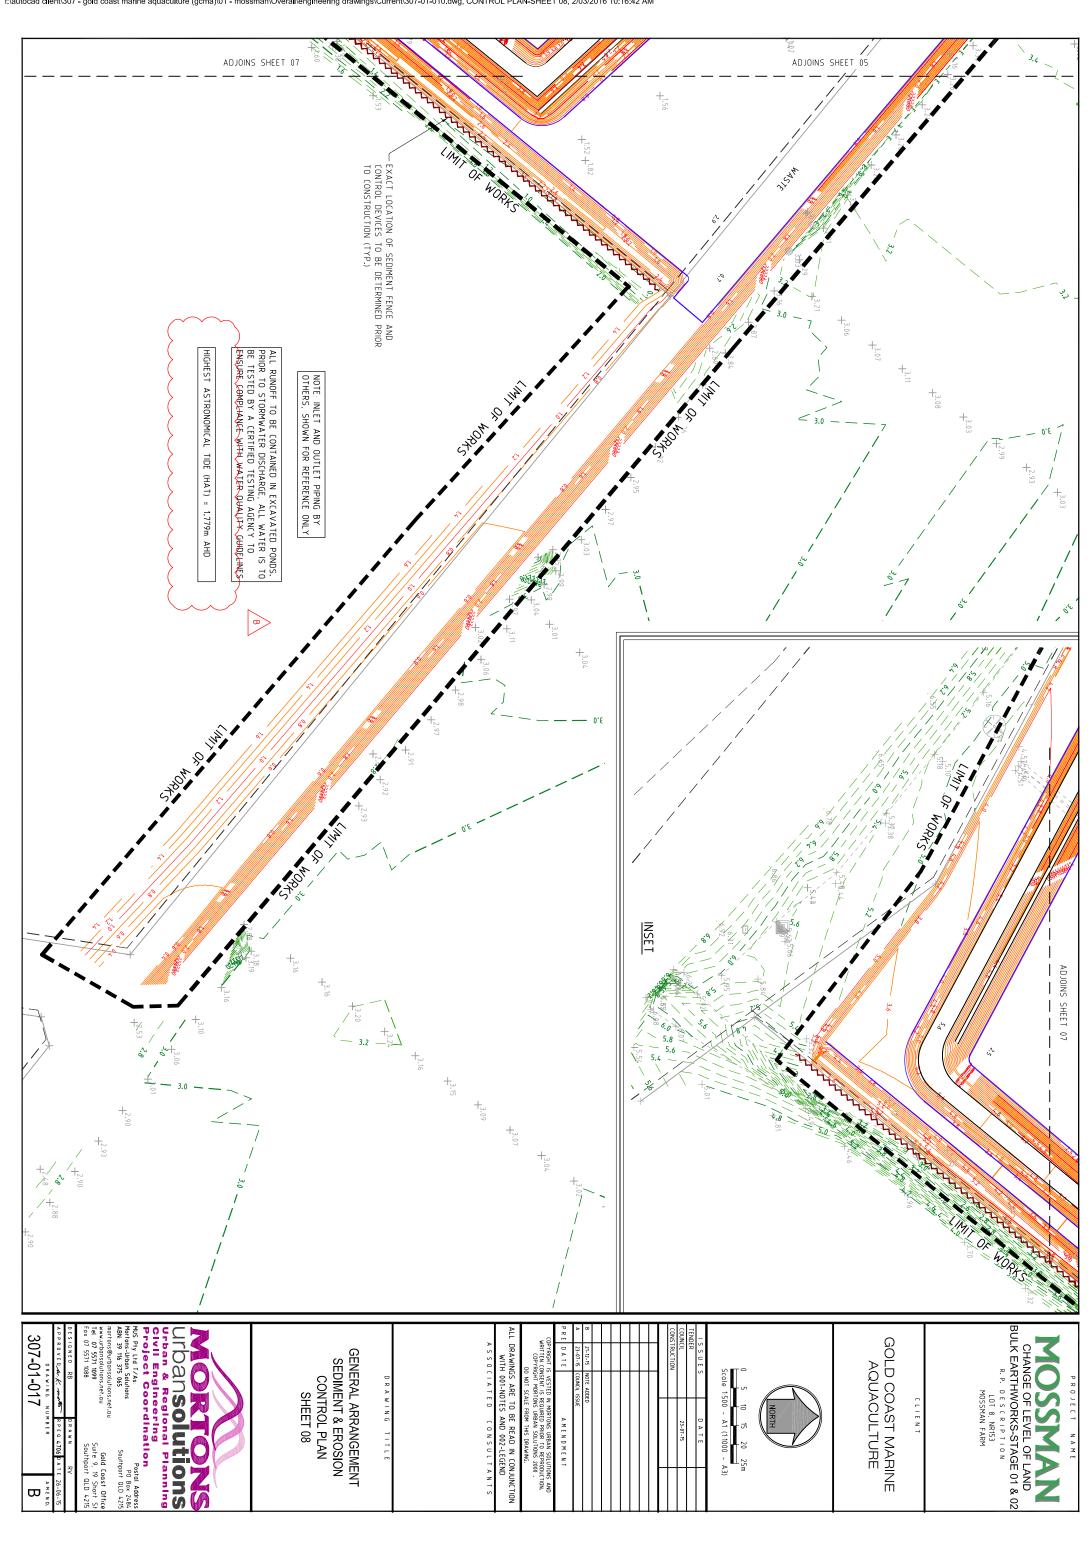


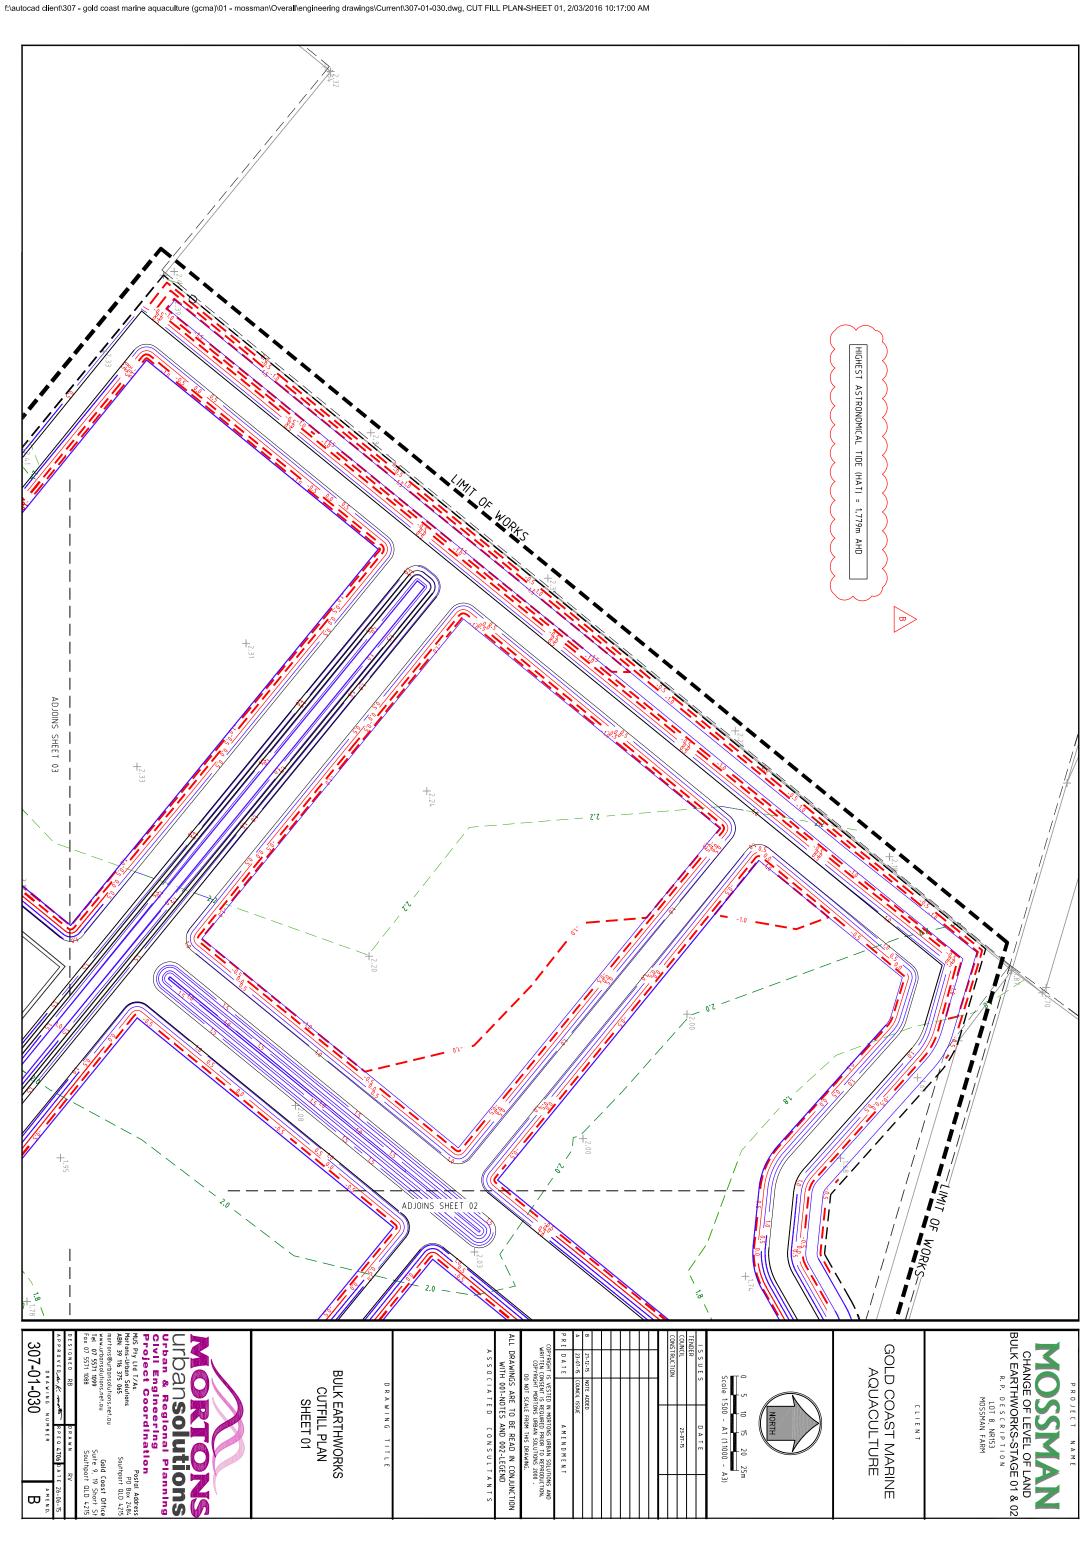


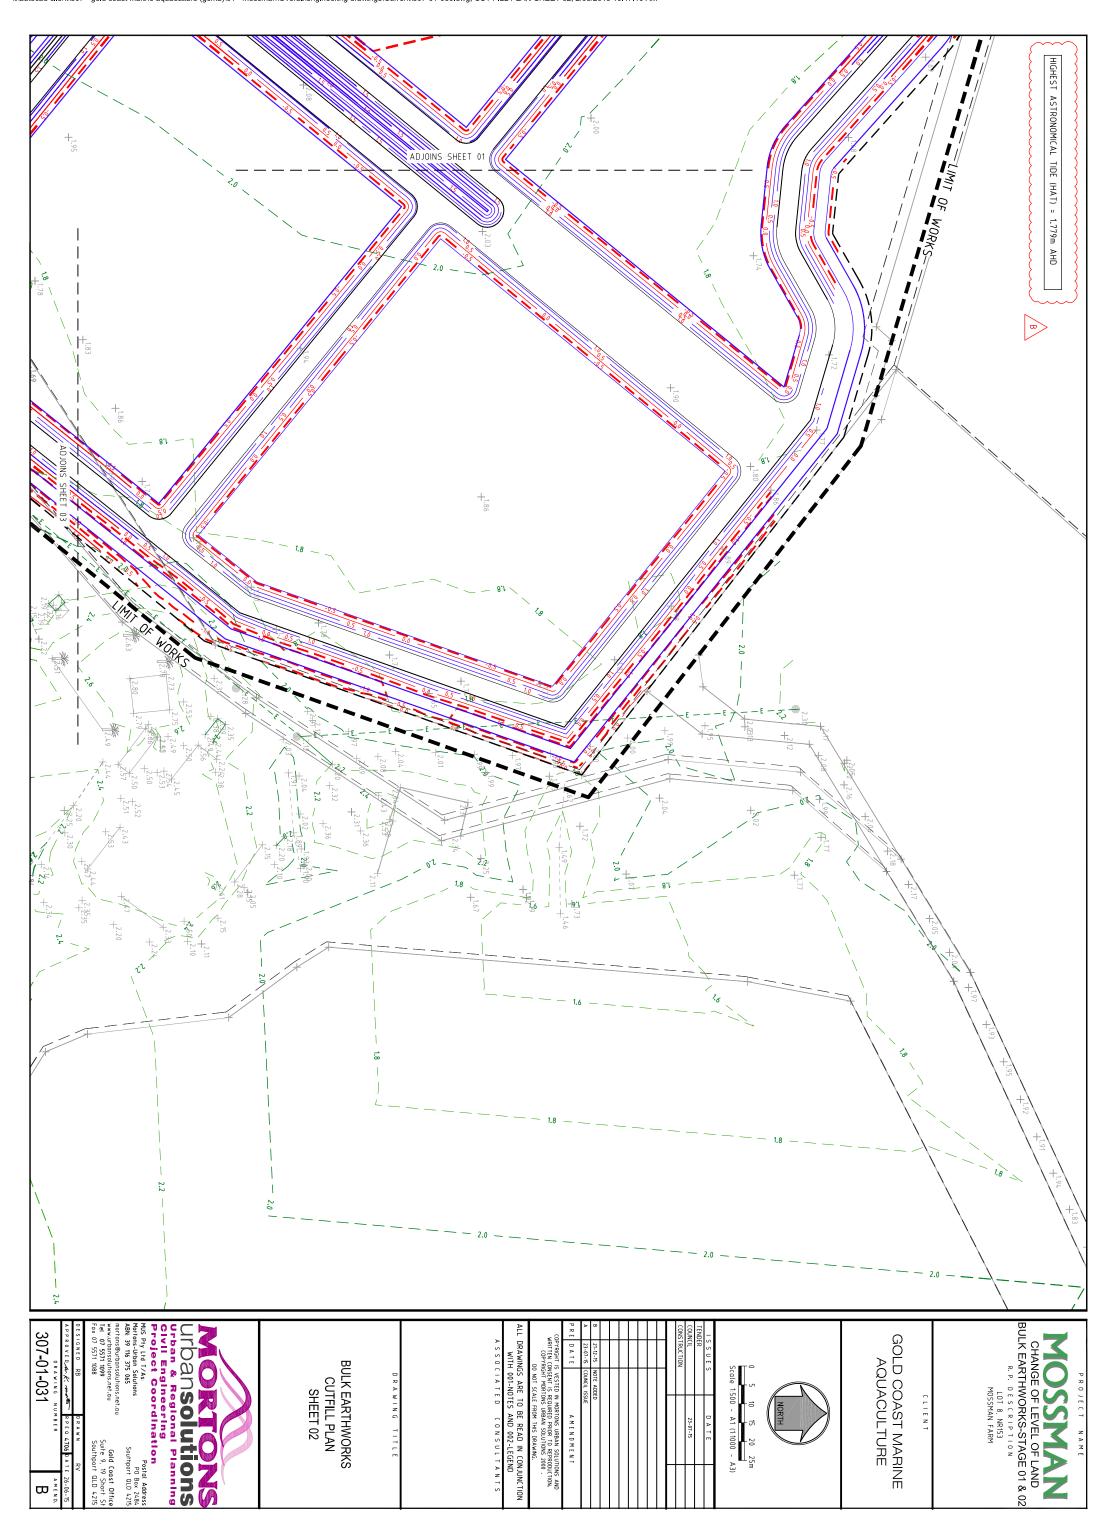


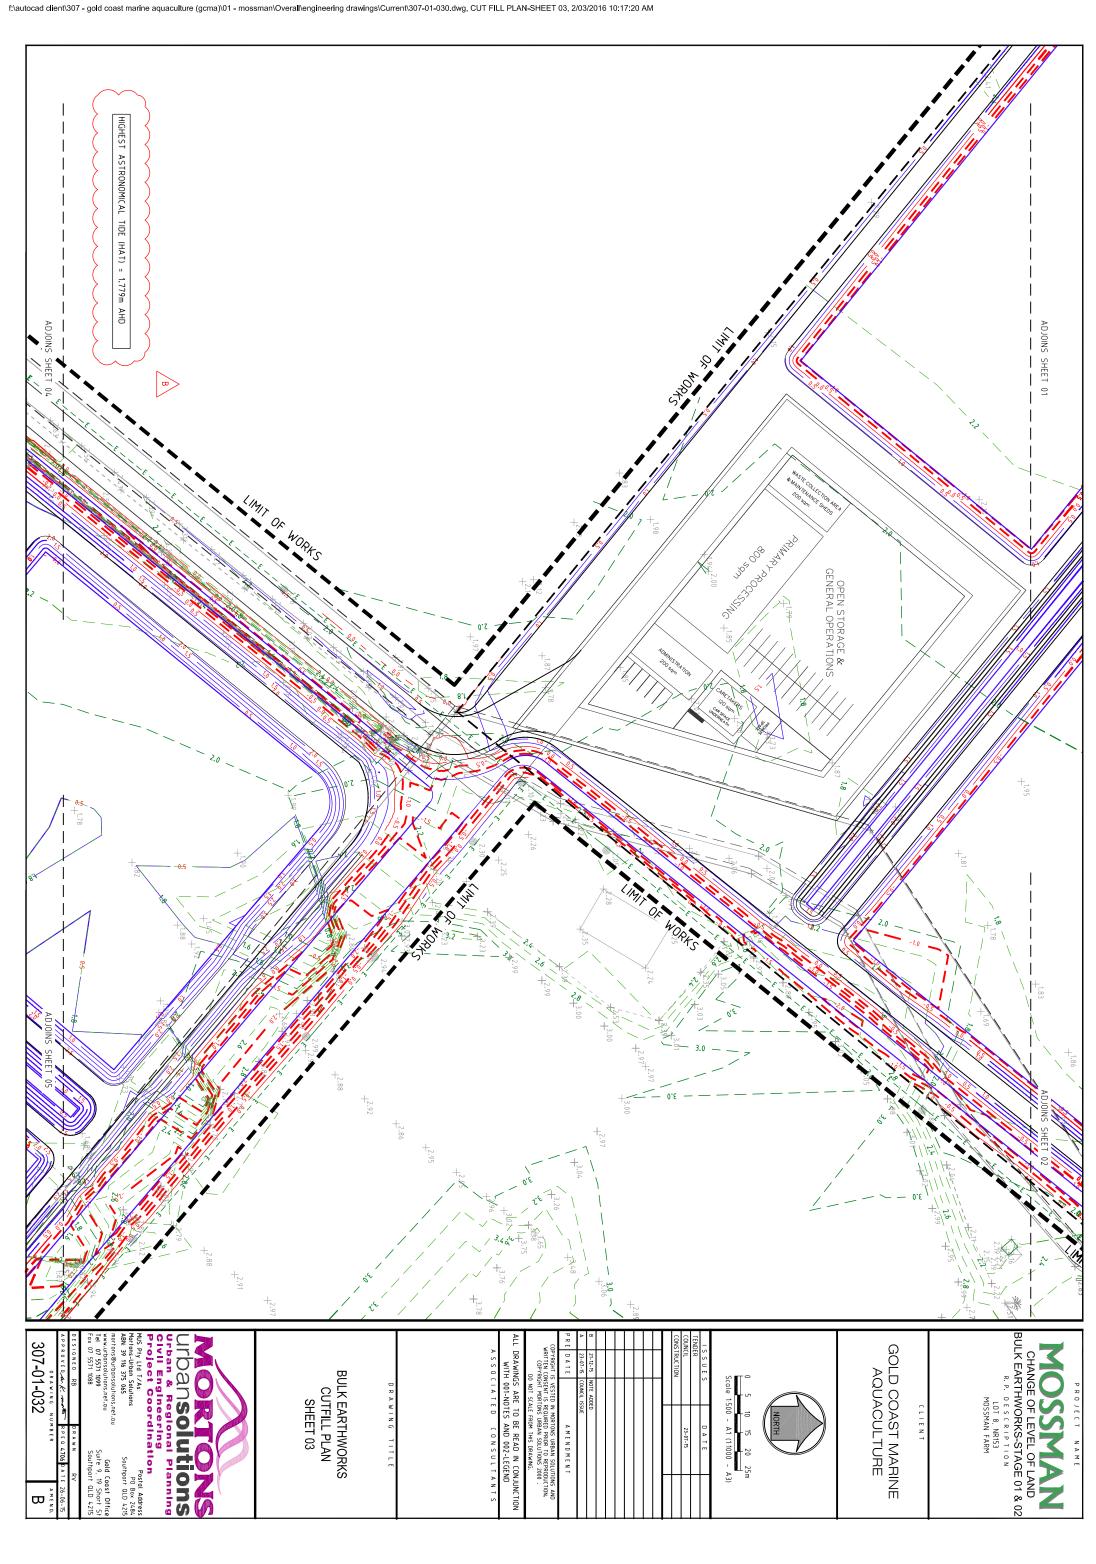


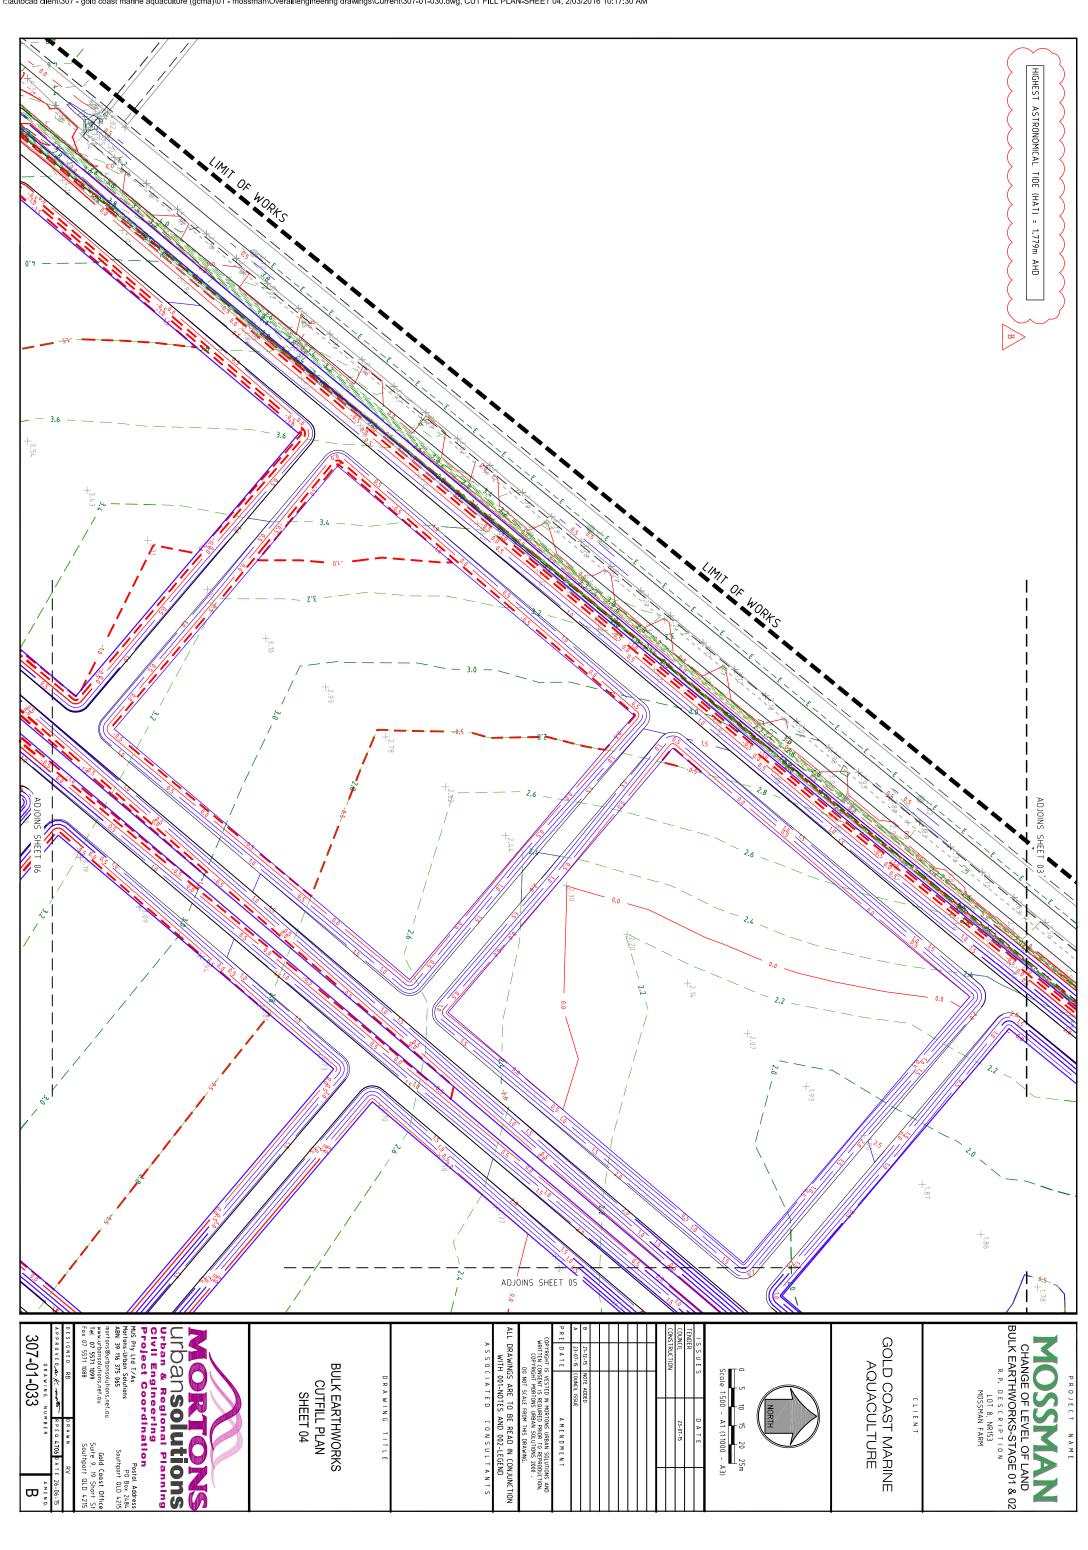

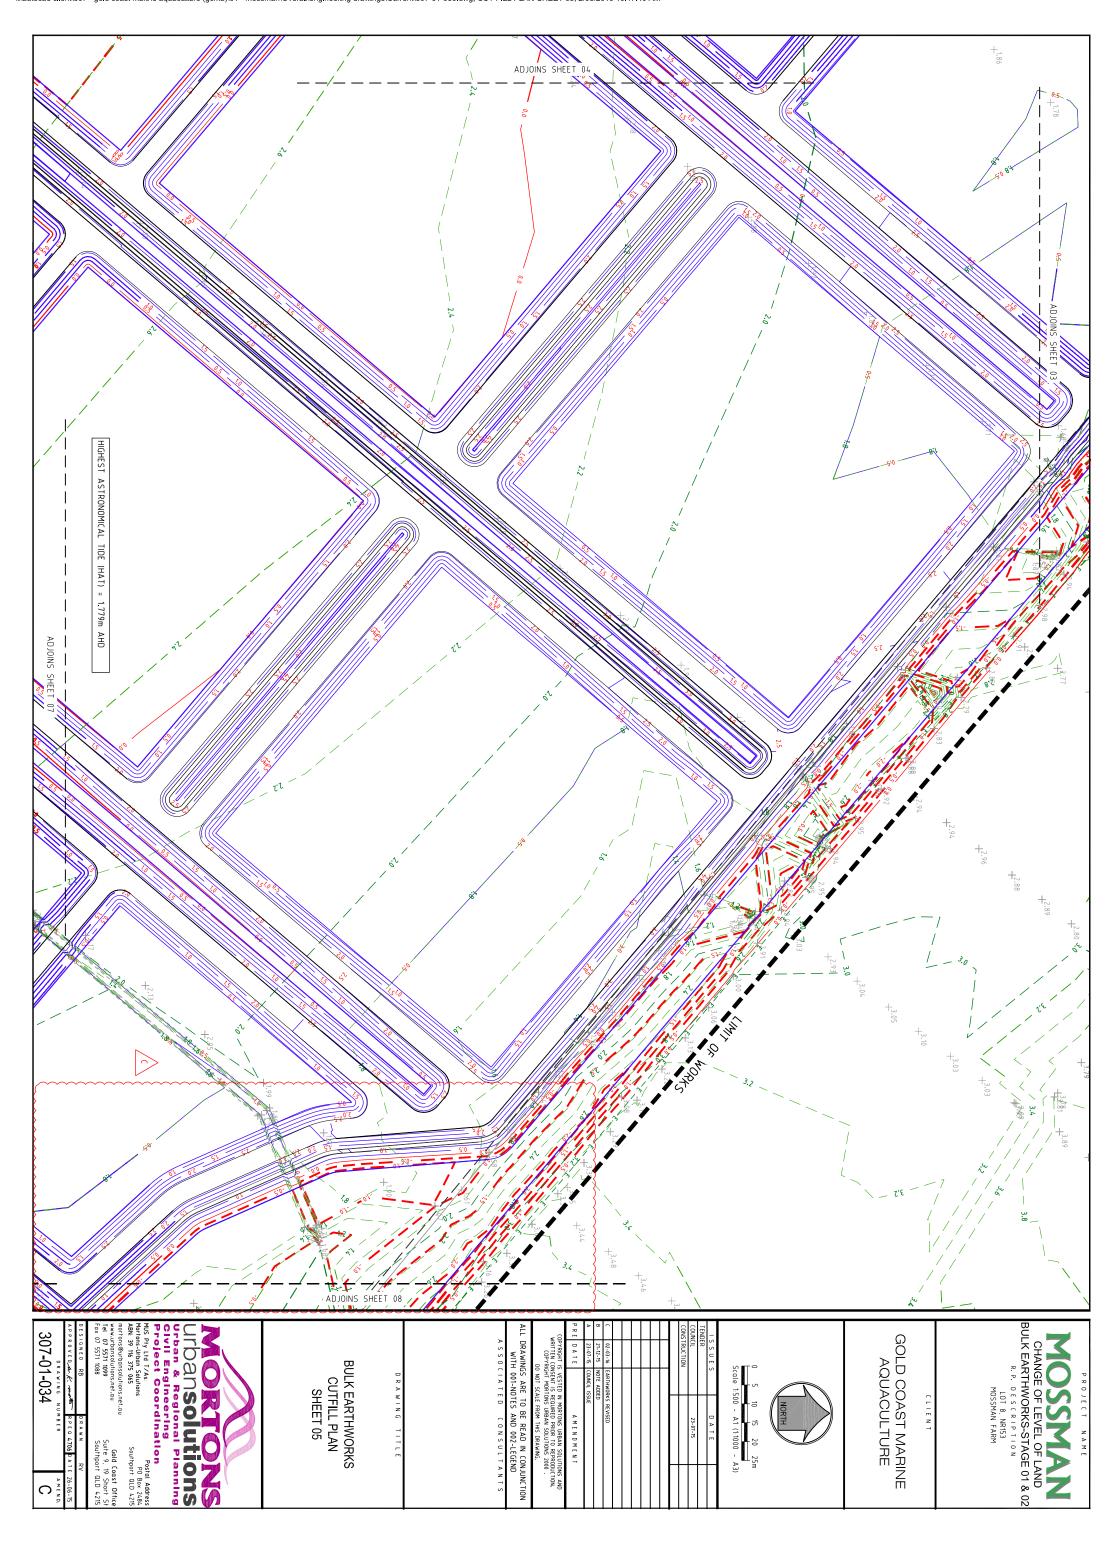


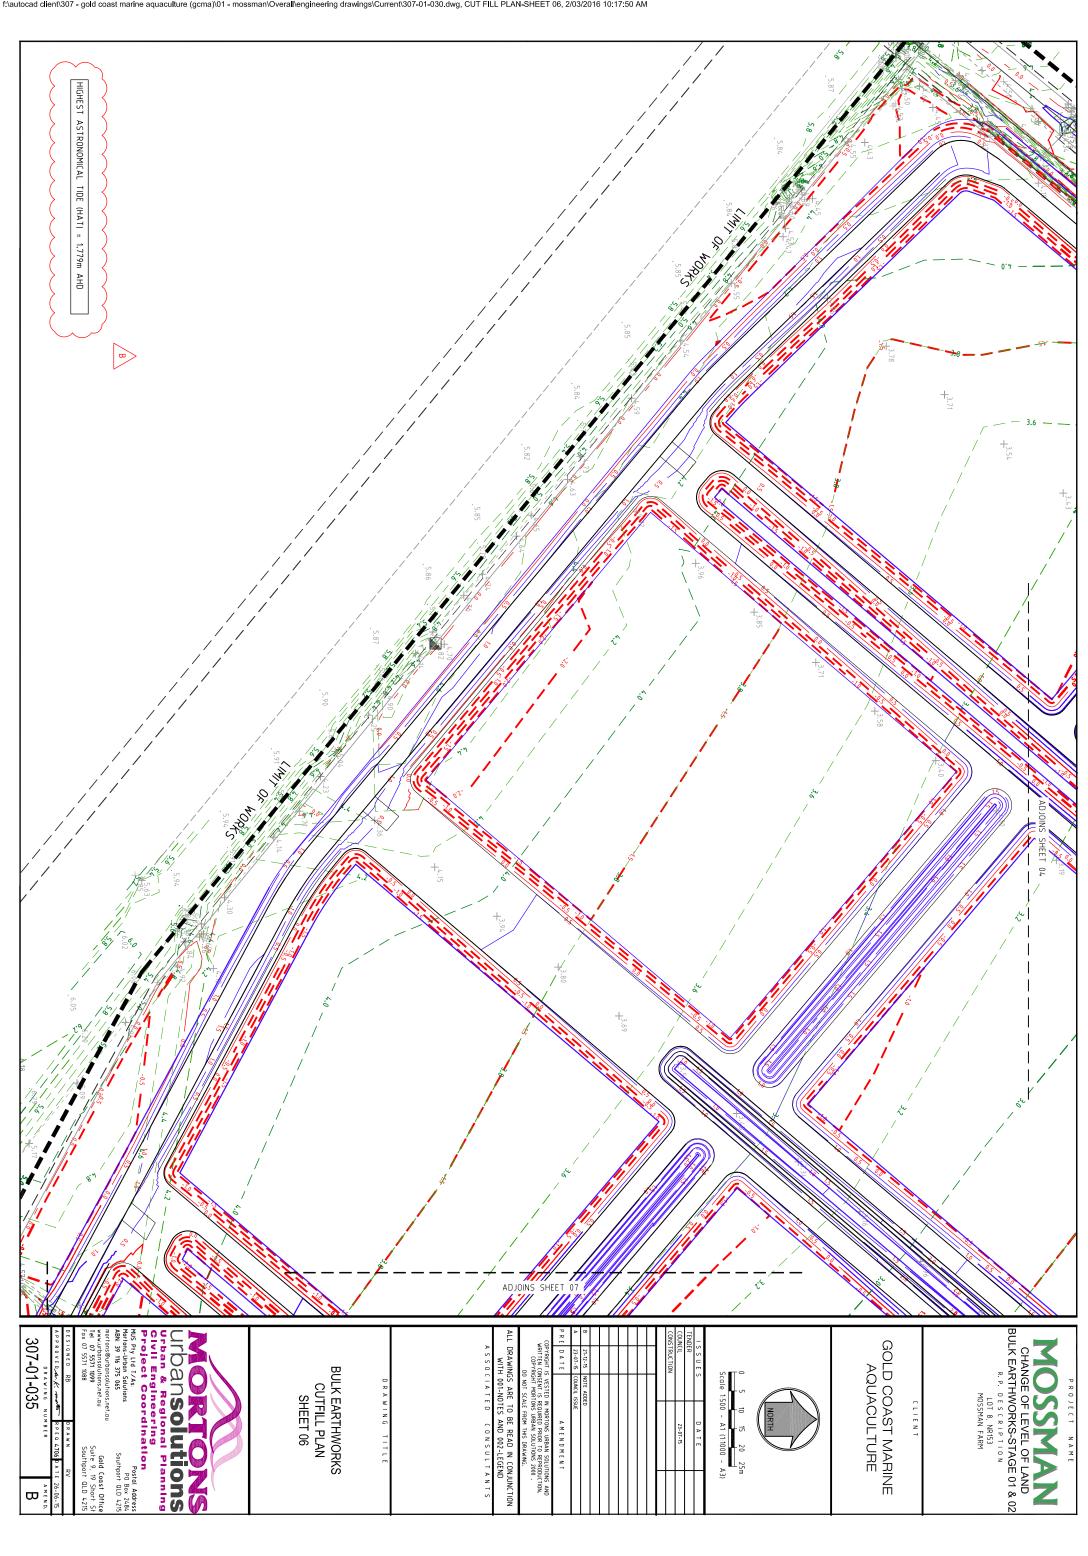


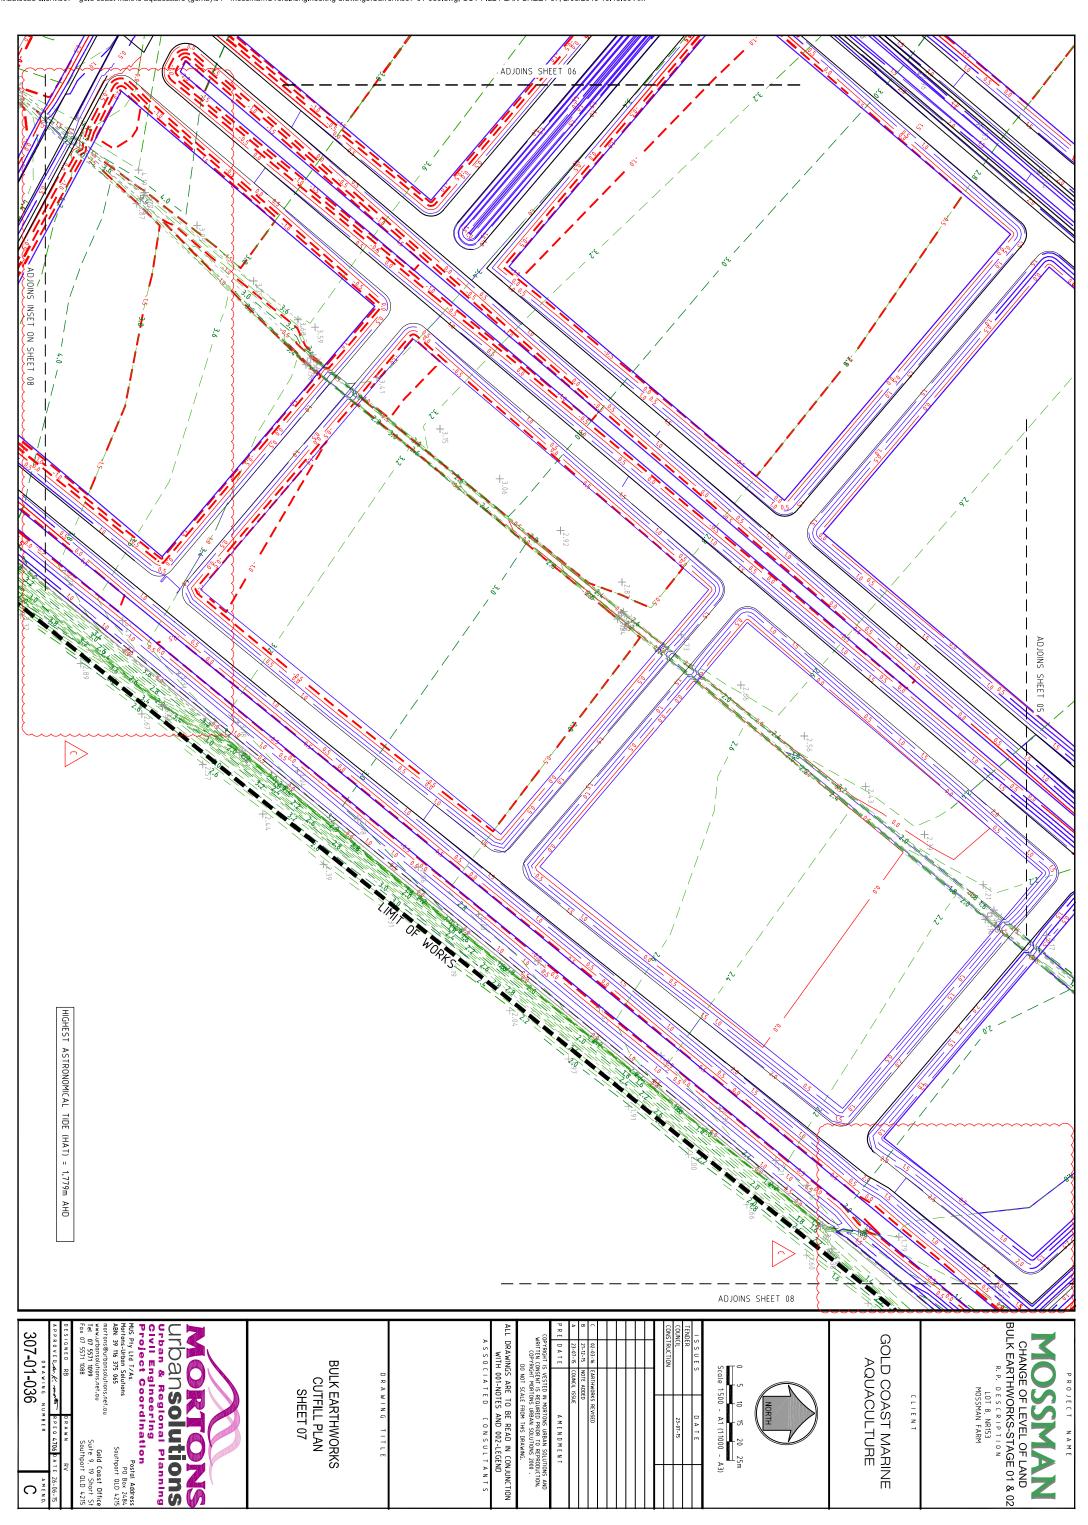


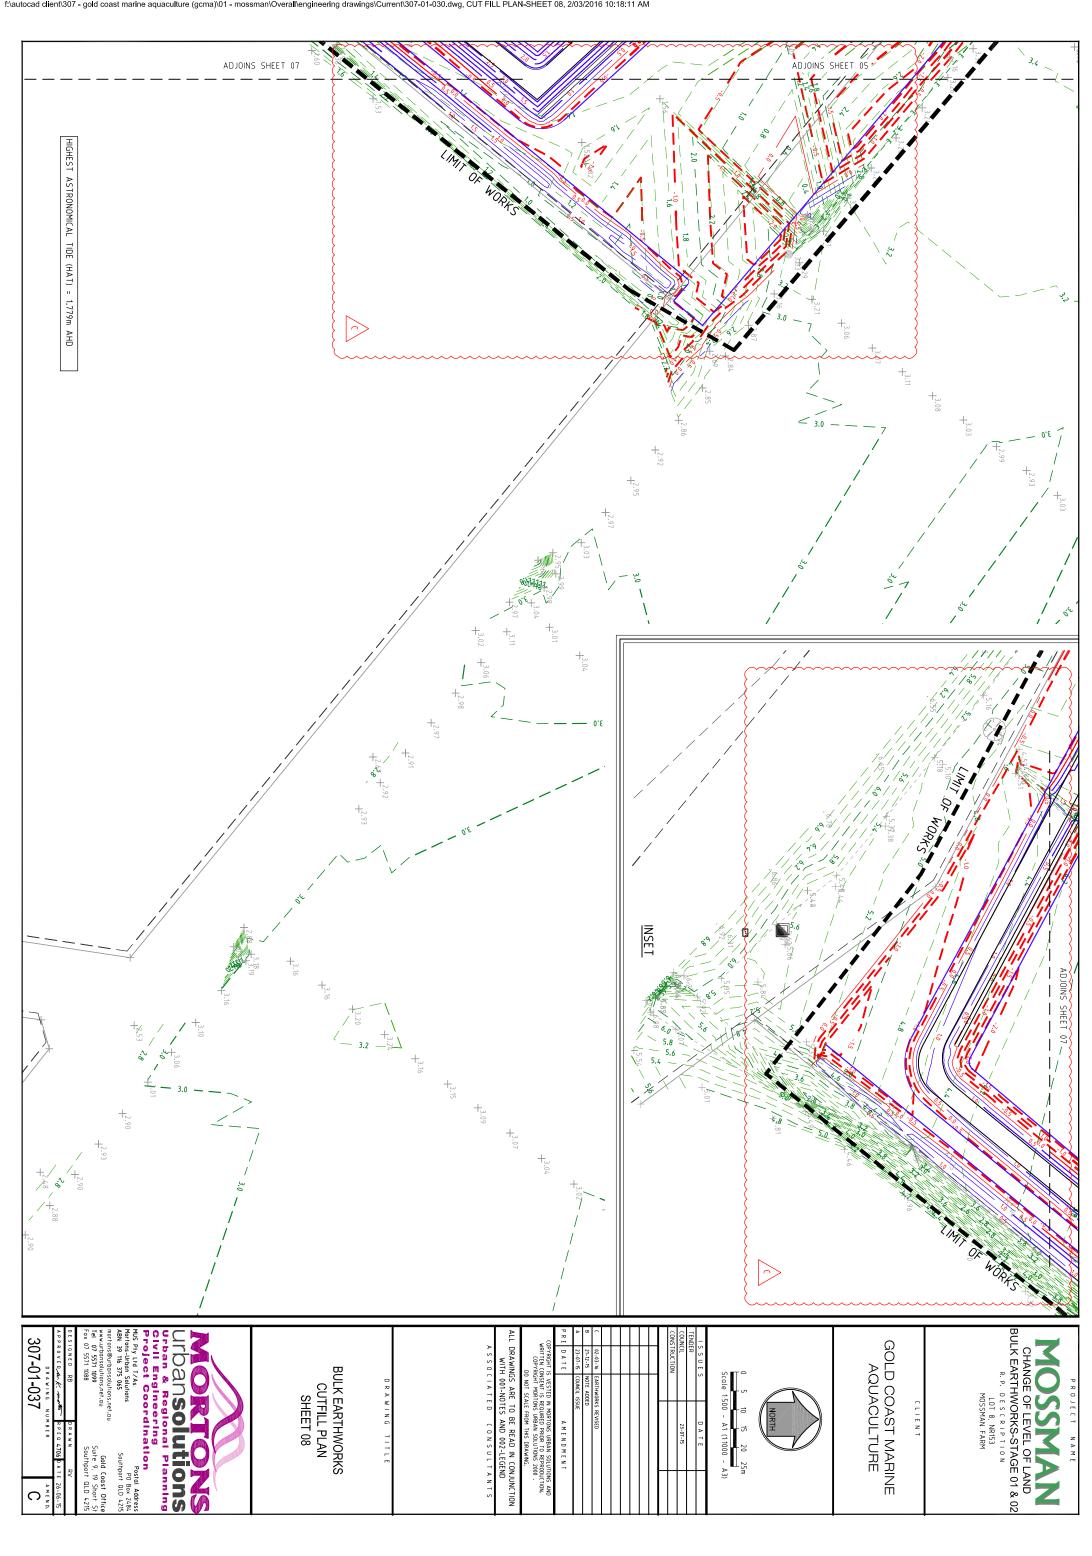



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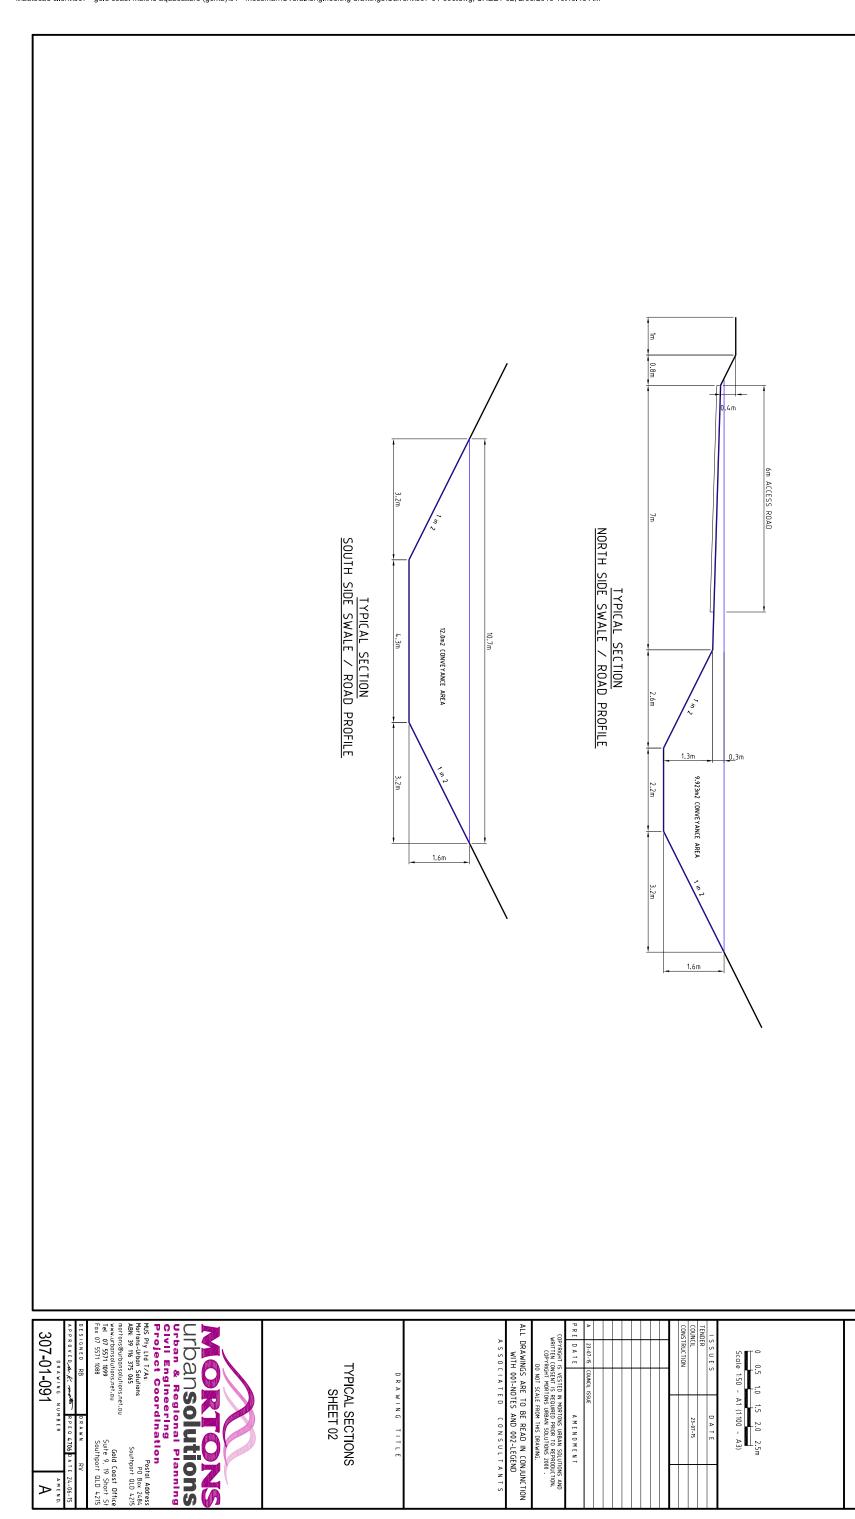


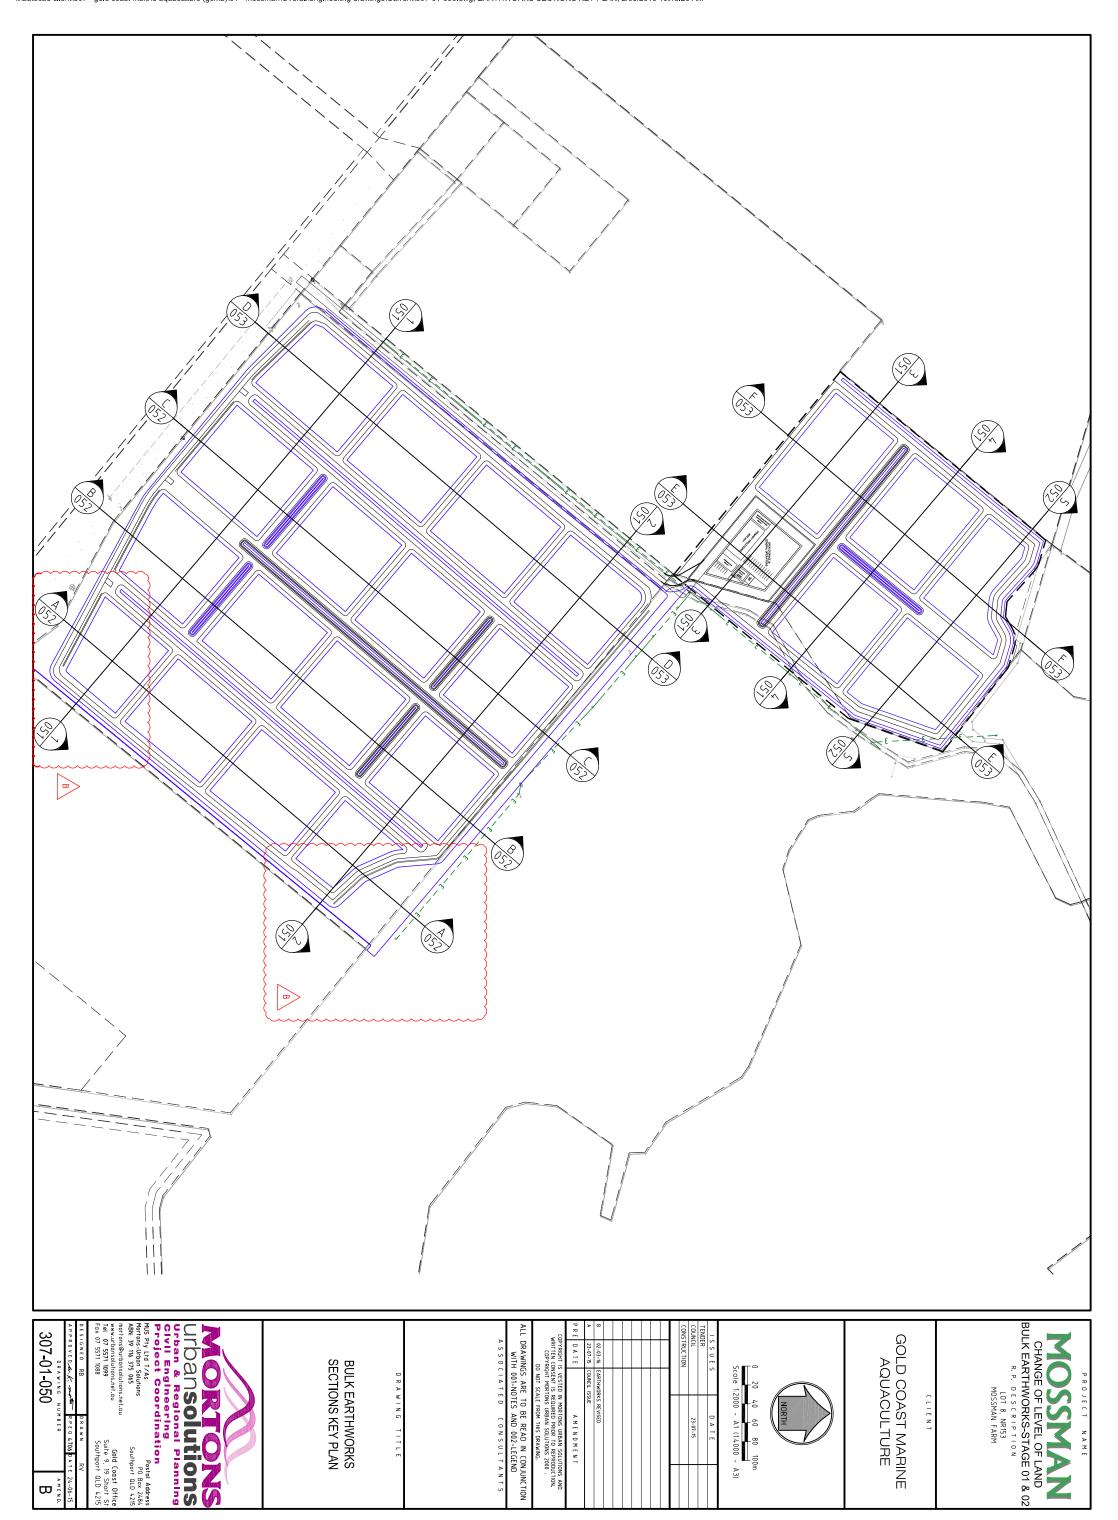

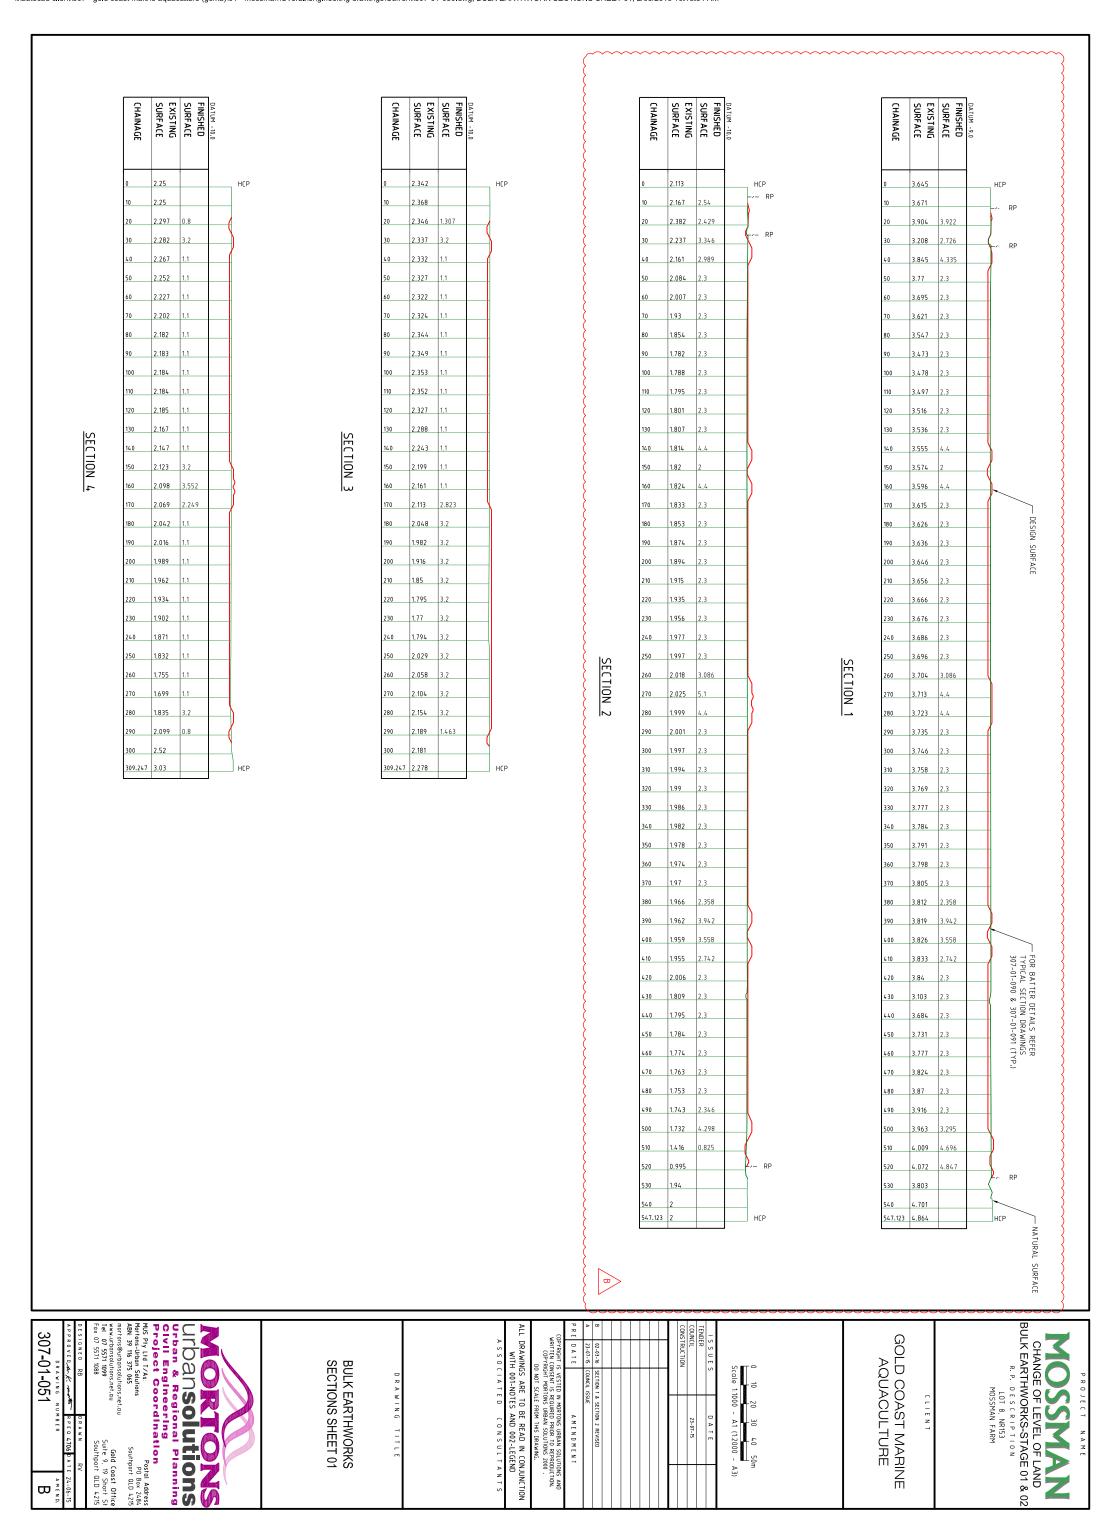

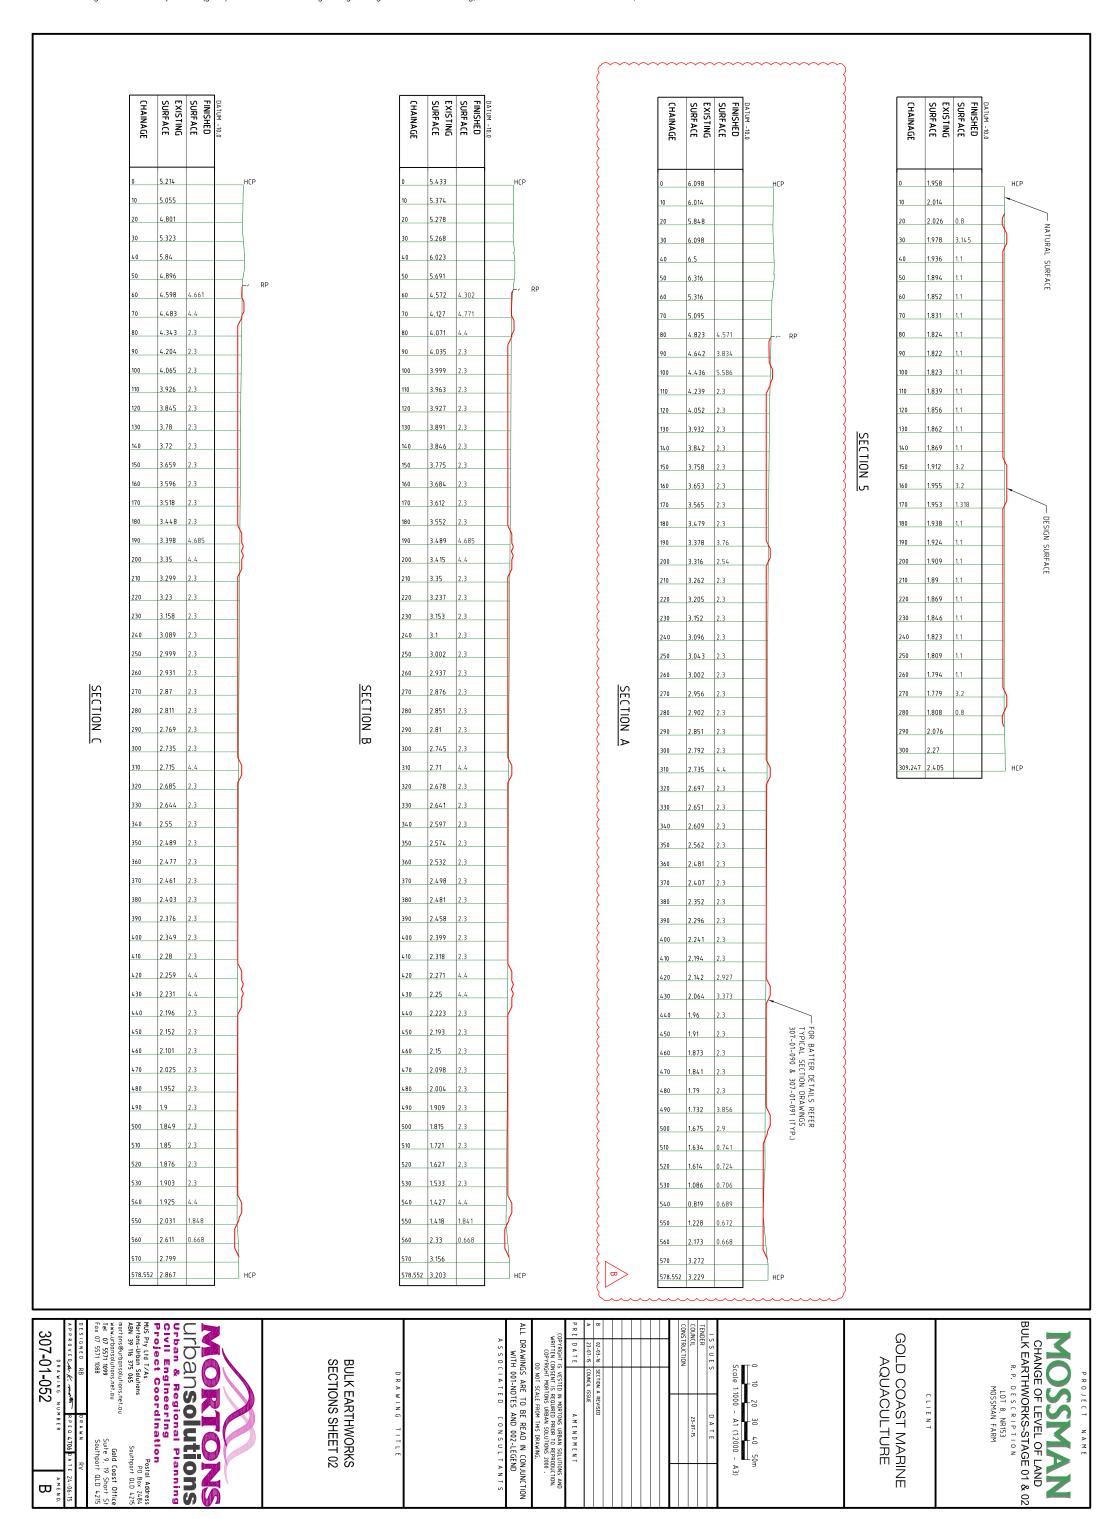

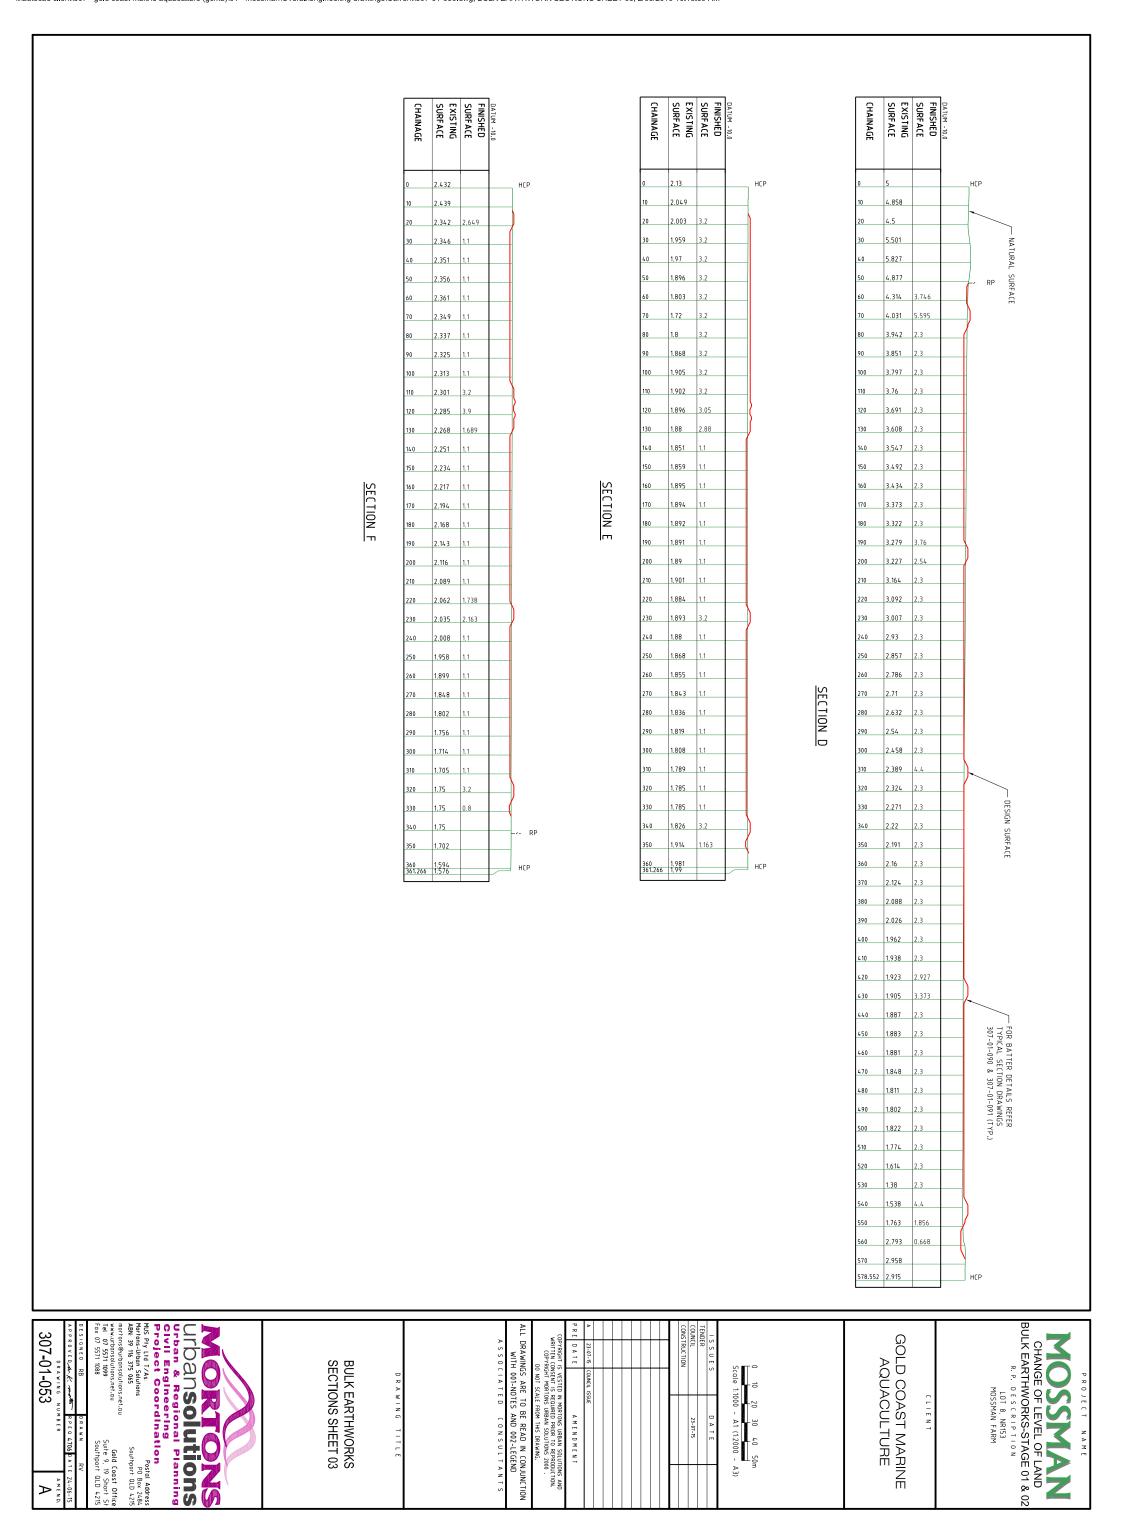

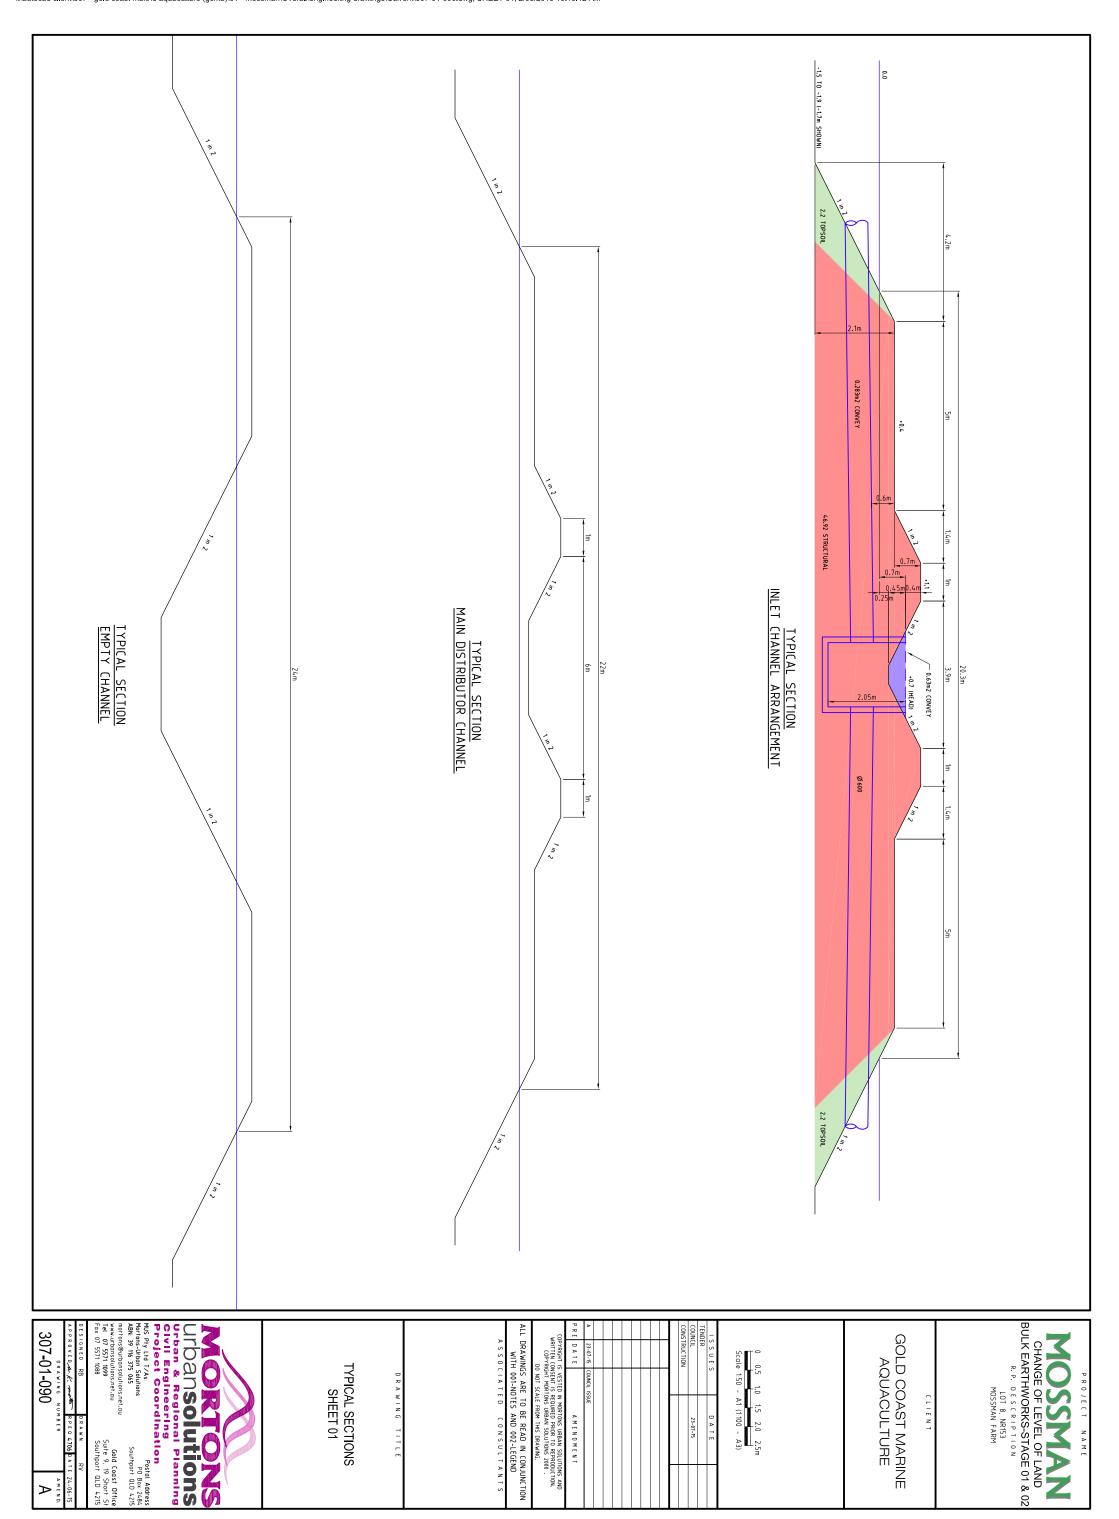

AMENDMENT

Gold Coast Office Suite 9, 19 Short St Southport QLD 4215

CHANGE OF LEVEL OF LAND
BULK EARTHWORKS-STAGE 01 & 02

R. P. DESCRIPTION
LOT 8, NR153
MOSSMAN FARM

GOLD COAST MARINE AQUACULTURE





Statement of Landscape Intent Client - Gold Coast Marine Aquaculture

Client - Gold Coast Marine Aquaculture
Address - Captain Cook Highway, Killaloe

Date: 30/06/2015 Scale: 1:3000 @ A3 Dwg No: 5555 L LI 01 Sheet: 1 of 3







Statement of Landscape Intent Client - Gold Coast Marine Aquaculture

Address - Captain Cook Highway, Killaloe

30/06/2015 Scale: 1:500 @ A3 Dwg No: 5555 L LI 01 Sheet: 2 of 3



PLANTING HAS BEEN SELECTED FOR EASE OF MAINTENANCE AS WELL AS THE SUITABILITY AND TOLERANCE TO THE VARYING CONDITIONS OF THE

THE PLANTING SCHEME USED IS PREDOMINATELY NATIVE WHICH SOFTENS THE BUILT FORM, IMPROVES NATURAL ECOSYSTEMS AND MINIMISED WATER USAGE.

THE SCALE AND NATURE OF THE LANDSCAPING MATERIALS SHALL BE APPROPRIATE TO THE SIZE OF THE STRUCTURES AND THE AVAILABLE SPACE.

CODE	BOTANIC NAME	COMMON NAME
ACA red	Acalypha wilkesiana "red"	Fijian fire plant
ACE smi	Acmena smithii	Lilly pilly
ACH spp	Acehmea spp	Bromeliad
AGA blu	Agapanthus orientalis "blue"	Agapanthus blue
AGA whi	Agapanthus orientalis "white"	Agapanthus white
ARC ale	Archontophoenix alexandrae	Alexendra Palm
ARC cun	Archontophoenix cunninghamia	Pickabean Palm
BUC cel	Buckinghamia celcissima	Ivory Curl
BAC cit	Backhousia citriodora	Lemon Scented Myrtle
BAR syu	Barklya syingifolia	Crown of Gold
BIS nob	Bismarkia nobilis	Bismark Palm
BRA bid	Brachychiton bidwillii	Little Kurrajong
BRA mul	Brachyscome multifida	Cut Leaf Daisy
BRA pop	Brachychiton populneus	Kurrajong
CAL pro	Callistemon "Prolific Pink"	Bottle Brush
CAL red	Caladiums 'red flash'	Elephant ear
CAR acu	Carpentaria acuminata	Carpentaria Palm
CAS que	Cassia queenslandica	Queensland Cassia
CLI min	Clivia miniata	Clivia
COR can	Cordyline cannifolia	Palm lily
COR red	Cordyline australis "Red Sensation"	Cordyline
CRI ped	Crinum pedunculatum	Swamp Lily
CUR rec	Curculigo recurvata	Palm Grass
DIA bre	Dianella brevipedunculata	Pin Cushion Flax Lily
DIA cae	Dianella caerulea	Flax Lily
DIA can	Dianella congesta	Coast Flax Lily
DIP aus	Diploglottis australis	Native tamarind
DOR exc	Doryanthes excelsa	Gymea Lily
ELA eum	Elaeocarpus eumundii	Eumundi Quandong
FLI aus	Flindersia australis	Crows ash
HEL spp	Heliconia spp.	Golden Torch
HIB het	Hibiscus heterophyllus	Native Hibiscus
HIB til	Hibiscus tiliaceus	Cottonwood Hibiscus
XO spp	Ixora species	Ixoras
LIV aus	Livistona australis	Cabbage Palm, Fan Palm
LIV dec	Livistonia decipiens	Weeping Cabbage tree palm
MEL ell	Melicope elleryana	Pink Euodia
RAN fit	Randia fitzalani	Native Gardenia
STR nic	Strelitzia nicolai	Gaint Bird of Paradise
STR reg	Strelitzia reginae	Bird of Paradise
THY max	Thysanolaena maxima	Tiger Grass


































































Statement of Landscape Intent Client - Gold Coast Marine Aquaculture

Address - Captain Cook Highway, Killaloe

30/05/2015 Scale: NTS Dwg No: 5555 L LI 01 Sheet: 3 of 3



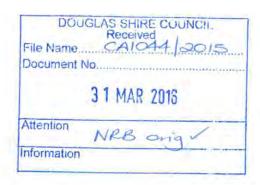



Department of Infrastructure, Local Government and Planning

Our reference: SDA-1015-024906 Your reference: CA 1044/2015

24 March 2016

Chief Executive Officer Douglas Shire Council PO Box 723 Mossman QLD 4873

Att: Neil Beck

Dear Sir / Madam

Concurrence agency response—with conditions

Development application for a material change of use (expansion of existing aquaculture facility & caretaker's residence), Reconfiguration of a lot (boundary realignment) and Operational work on land located at Captain Cook Highway, Killaloe and more particularly described as Lot 8 on NR153, Lot 201 on SP222765 and Lot 7 on RP846941

(Given under section 285 of the Sustainable Planning Act 2009)

The referral agency material for the development application described below was received by the Department of Infrastructure, Local Government and Planning under section 272 of the Sustainable Planning Act 2009 on 20 October 2015.

Applicant details

Applicant name: Gold Coast Marine Aquaculture

c/- Gassman Development Perspectives

Applicant contact details: PC

PO Box 392

Beenleigh QLD 4207

bcraddock@gassman.com.au

Site details

Street address: Captain Cook Highway, Killaloe

Lot on plan: Lot 8 on NR153, Lot 201 on SP222765 and Lot 7 on

RP846941

Local government area: Douglas Shire Council

Page 1

Application details

Proposed development:

Development permit (combined application) for a material change of use (expansion of existing aquaculture facility & caretaker's residence), Reconfiguration of a lot (boundary realignment) and Operational work for change to ground level

Aspects of development and type of approval being sought

Nature of Development	Approval Type	Brief Proposal of Description	Level of Assessment
Material Change of Use	Development permit	Expansion of existing aquaculture facility & caretaker's residence	Impact Assessment
Reconfiguring a Lot	Development permit	Boundary realignment	Impact Assessment
Operational Work	Development permit	Change to ground levels	Impact Assessment

Referral triggers

The development application was referred to the department under the following provisions of the *Sustainable Planning Regulation 2009*:

Referral trigger

Schedule 7, Table 2, Item 13 - Tidal works, or development in a

coastal management district

Schedule 7, Table 2, Item 28 - Certain aquaculture

Schedule 7, Table 3, Item 1 - State-controlled road

Schedule 7, Table 3, Item 5 - Coastal management districts

Conditions

Under section 287(1)(a) of the *Sustainable Planning Act 2009*, the conditions set out in Attachment 1 must be attached to any development approval.

Reasons for decision to impose conditions

Under section 289(1) of the *Sustainable Planning Act 2009*, the department must set out the reasons for the decision to impose conditions. These reasons are set out in Attachment 2.

Further advice

Under section 287(6) of the *Sustainable Planning Act 2009*, the department offers advice about the application to the assessment manager—see Attachment 3.

Approved plans and specifications

The department requires that the following plans and specifications set out below and in Attachment 4 must be attached to any development approval.

			T	1
│ Drawing/Report Title	Prepared by	∣ Date	Reference	Version/Issue

			no.	
Aspect of development: Ma	aterial change of use	and operationa	l work	
Proposal Plan - Lot 7 on RP846941, Lot 8 on NR153, Lot 201 on SP222765	Gassman Development Perspectives	09-02-16	555 P PP 100	А
Concept Plan Operational Area	Gassman Development Perspectives	04-09-15	555-P CP 01.C	_
Statement of Landscaping Intent	Gassman Development Perspectives	30/06/2015	5555 L LI 01 (Sheet 1 of 3)	-
General Arrangement Sediment & Erosion Control Sheet 06	Mortons Urban Solutions	21-12-15	307-01-015	В
General Arrangement Sediment & Erosion Control Sheet 08	Mortons Urban Solutions	21-12-15	307-01-017	В
Bulk Earthworks CutFill Plan Sheet 06	Mortons Urban Solutions	21-12-15	307-01-035	В
Bulk Earthworks CutFill Plan Sheet 08	Mortons Urban Solutions	02-03-16	307-01- 037	С
TMR Layout Plan (20A – 64.48km)	Queensland Government Transport and Main Roads	17/11/2015	275/20A (500- 924)	А
Rural Property Access – Single or Dual Carriageway (Conditional)	Austroads: Part 4 - Intersections and Crossings - General	2009	Figure 7.2	-
Aspect of development: Re	configuration of a lo	t		
Existing & Proposed Reconfiguration of Land (Boundary Relocation)	Gassman Development Perspectives	05-02-16	5555 P ROL 02 – 2OF 2 (Sheet 2 of 2)	А

A copy of this response has been sent to the applicant for their information.

For further information, please contact Joanne Manson, Principal Planning Officer, SARA Far North QLD on 4037 3228 or email joanne.manson@dilgp.qld.gov.au who will be pleased to assist.

Yours sincerely

Graeme Kenna

Manager (Planning)

ghava

Gold Coast Marine Aquaculture, c/- Gassman Development Perspectives CC:

email: bcraddock@gassman.com.au

enc:

Attachment 1—Conditions to be imposed Attachment 2—Reasons for decision to impose conditions Attachment 3—Further advice

Attachment 4—Approved Plans and Specifications

Your reference: 5555:BC

Attachment 1—Conditions to be imposed

No.	Conditions	Condition timing				
	Material change of use (expansion of existing aquaculture facility & caretaker's residence), and Operational work					
(operation change executive Environ this device)	Schedule 7, Table 2, Item 13 – Tidal work, or development in a coastal management district (operational work) and Schedule 7, Table 3, Item 5 - Coastal management districts (material change of use) —Pursuant to section 255D of the Sustainable Planning Act 2009, the chief executive administering the Act nominates the Director-General of the Department of Environment and Heritage Protection to be the assessing authority for the development to which this development approval relates for the administration and enforcement of any matter relating to the following condition(s):					
1.	 The development must be carried out generally in accordance with the following plan: Existing & Proposed Reconfiguration of Land (Boundary Relocation), prepared by Gassman Development Perspectives, dated 05-02-16, drawing no. 555P ROI02-OF2, Sheet 2 of 2, Issue A Proposal Plan - Lot 7 on RP846941, Lot 8 on NR153 and Lot 201 on SP222765, prepared by Gassman Development Perspectives, dated 09-02-16, drawing no. 555 P PP100, Issue A Concept Plan Operational Area, prepared by Gassman Development Perspectives, dated 04-09-15, drawing no. 555-P CP 01.C 	Prior to the commencement of use and to be maintained at all times				
2.	Erosion and sediment control measures are to be installed and maintained to prevent the release of sediment to tidal waters.	Prior to commencement of the works and maintained until their completion				
3.	Any disturbed or oxidised acid sulphate soil must be treated and managed in accordance with the current Queensland Acid Sulfate Soil Technical Manual: Soil Management Guidelines v4.0, prepared by the Department of Science, Information Technology, Innovation and the Arts, 2014.	For the duration of the works the subject of this approval				
Materia	Material change of use (expansion of existing aquaculture facility)					
Schedule 7, Table 2, Item 28 — Certain aquaculture - Pursuant to section 255D of the Sustainable Planning Act 2009, the chief executive administering the Act nominates the Director-General of the Department of Agriculture and Fisheries to be the assessing authority for the development to which this development approval relates for the administration and enforcement of any matter relating to the following condition(s):						
4.	The development must be carried out generally in accordance with following plans: • Proposal Plan Lot 7 on RP846941, Lot 8 on NR153, Lot 201 on SP222765 prepared by Gassman Development Perspectives dated 09-12-16, reference 5555 P PP 100, Issue A	Prior to the commencement of use and to be maintained at all times				

No.	Conditions	Condition timing	
5.	Development authorised under Conduct aquaculture in being limited to 62.42 here. Plan Lot 7 on RP84694 SP222765 prepared by Perspectives dated 09-lssue A	At all times	
6.	The operator is authorised to co	At all times	
	Common Name	Scientific Name	
	Australian bass	Macquaria novemaculeata	
	Banana prawn	Penaeus merguiensis	
	Barcoo grunter	Scortum barcoo	
	Barramundi	Lates calcarifer	
	Barramundi cod	Cromileptes altivelis	
	Barred-cheek coral trout	Plectropomus maculatus	
	Batik Lobster	Panulirus longipes	
	Black Lobster	Panulirus penicillatus	
	Black Slipper Lobster	Parribacus antarcticus	
	Black tiger prawn	Penaeus monodon	
	Blue endeavour prawn	Metapenaeus endeavouri	
	Blue-spot coral trout	Plectropomus laevis	
	Blunt Slipper Lobster	Scyllarides squammosus	
	Brown tiger prawn	Penaeus esculentus	
	Cobia	Rachycentron canadum	
	Common coral trout	Plectropomus leopardus	
	Eel tail catfish	Tandanus tandanus	
	Estuary cod	Epinephelus coioides	
	Flowery cod	Epinephelus fuscoguttatus	
	Golden perch (Cooper Creek strain)	Macquaria ambigua n.sp	
	Golden perch (Dawson River strain)	Macquaria ambigua oriens	
	Golden perch (Murray-Darling strain)	Macquaria ambigua ambigua	
	Golden Snapper	Lutjanus johnii	
	Green Tropical Lobster	Panulirus versicolor	
	Gulf Saratoga	Scleropages jardinii	

No.	Conditions	Condition timing	
	Kuruma prawn	Penaeus japonicus	
	Mahi Mahi	Coryphaena hippurus	
	Mangrove jack	Lutjanus argentimaculatus	
	Moreton Bay bug	Thenus orientialis	
	Moreton Bay bug	Thenus indicus	
	Mud Lobster	Panulirus polyphagus	
	Mulloway	Argyrosomus japonicus	
	Murray cod	Maccullochella peeli peeli	
	Passionfruit trout	Plectropomus areolatus	
	Queensland groper	Epinephelus lanceolatus	
	Sand Lobster	Panulirus homarus	
	Sand whiting	Sillago ciliata	
	Silver perch	Bidyanus bidyanus	
	Sleepy cod	Oxyeleotris lineolatus	
	Snapper	Pagrus auratus	
	Southern saratoga	Scleropages leichardti	
	Tropical rock lobster	Panulirus ornatus	
7.	The administering authority notifications@daf.qld.gov.au contact details for this devel	ı of any changes to the personal	Within 28 days
8.	An aquaculture production reapproved form to the Depart	eturn must be submitted in the tment of Agriculture and Fisheries es lodging a nil return when no activity	By 31 July each year
9.	The possession and use of the Fisheries Regulation 200 Subdivision 1 (freshwater) a	regulated fishing apparatus" under 08, Chapter 4, Part 1, Division 4, and Subdivision 2, sections 188 and the approved aquaculture area.	At all times
10.	Aquaculture fisheries resour Queensland waters (as definable) other than those water approval.	At all times	
	must not be sold, traded or g	d, aquaculture fisheries resources given away for the purposes of using se of whole fish and any part of the	
11.	The movement of animals o approval must comply with t protocol. If the species bein not have a species specific conditions 12 and 13 apply.	At all times	
12.	Animals of a species approving development approval must rearing without a health cert	At all times	

No.	Conditions	Condition timing
	the exporting state or territory's fisheries, or a veterinary authority certifying the animals health, which must include a statement that the specimens originate from:	
	(a) a hatchery, farm, aquaculture premises or region which is recognised as free from infection by the diseases on the Queensland Declared Disease List based on the requirements listed in the OIE Manual of Diagnostic Tests for Aquatic Animals, current edition (Fourth Edition 2003 or later) for recognition as free from infection; or	
	(b) a hatchery, farm, aquaculture premises or region in which an appropriate targeted surveillance scheme over 2 years has been undertaken under the supervision of State or Territory Fisheries agencies or fisheries approved Veterinary authorities and where the requirements for recognition as free from infection by diseases of concern for that species on the OIE Manual of Diagnostic Tests for Aquatic Animals, current edition (Fourth Edition 2003 or later) have been met; or	
	(c) a single batch of gametes, larvae, fry, post-larvae, spat or early juvenile or adult of a species of finfish, crustaceans or molluscs, isolated from open waters, which has been tested using suitable techniques (refer to DAF Health Translocation Protocols appropriate for the approved species) to provide evidence that the batch is free from infection by diseases of concern on the Queensland Declared Disease List for that species.	
	(d) an animal of an aquatic species that is not finfish, crustacean or mollusc must not be brought into Queensland for rearing without a specific risk assessment and under a specific translocation protocol for that species.	
13.	(a) Animals of a species approved for aquaculture under this development approval must not be brought into Queensland for rearing unless an "Application to allow the Translocation of Live Aquatic Animals into and within Queensland form" (FDU1398) and Pathology Report has been completed and the administering authority has provided written acknowledgement and approval of the "Details of translocation form" and the Pathology Report.	(a) At all times (b) A minimum three working days prior to
	(b) The "Application to allow the Translocation of Live Aquatic Animals into and within Queensland form" and a signed copy of the Pathology Report (as detailed above) must be provided to the administering authority via translocation@daf.qld.gov.au, a minimum of three (3) working days prior to all shipments into Queensland. It is a requirement that the pathology report/health certificate is dated no more than 14 days before shipment date.	shipments into Queensland
	(c) After arrival, any unusual clinical signs or mortalities in the stock must be reported immediately to the Queensland Boating and Fisheries Patrol. If directed by an officer of the administering authority, specimens must be forwarded to a veterinary laboratory as directed by the officer.	(c) At all times
14.	The control over the release of water from all ponds, tanks and	At all times

No.	Conditions	Condition timing
	drainage systems within the approved aquaculture area must be maintained at all times.	
15.	The aquaculture area is secured to prevent the overland escape of aquaculture product by maintaining a perimeter barrier that is impervious to all size classes of the aquaculture fisheries resources that are capable of overland escape.	At all times
16.	All reasonable and practicable measures to ensure that all waters (ponds, tanks, aquaria drainage systems etc.) on the approved aquaculture area are screened in such a way to prevent the escape of any specimens (eggs, juveniles or adults) into Queensland waters (as defined in the <i>Acts Interpretation Act 1954</i>).	At all times
17.	Where waters are introduced for the aquaculture of the approved species, all reasonable measures must be taken to ensure all waters are sufficiently screened to prevent the movement of any juvenile or adult wild fauna (excepting zooplankton) into the approved aquaculture area.	At all times
18.	This development approval authorises the purchase of broodstock and/or culture stock from the holder of a commercial fishing boat licence, a commercial fisher, or holder of any other authority that allows the sale of the approved species	At all times
19.	Any Development Approval and/or Resource Allocation Authority area, and any associated areas which are used for activities related to the approved aquaculture operation (including processing), and all records relating to the aquaculture activity, must be made available for inspection by an inspector under the Fisheries Act 1994 during reasonable hours.	At all times

Schedule 7, Table 3, Item 1— State-controlled road (material change of use) - Pursuant to section 255D of the Sustainable Planning Act 2009, the chief executive administering the Act nominates the Director-General of the Department of Transport and Main Roads to be the assessing authority for the development to which this development approval relates for the administration and enforcement of any matter relating to the following condition(s):

In accordance with approved plans

1			
	20.	The development must be carried out generally in accordance with the following plans:	Prior to the commencement of
		Existing & Proposed Reconfiguration of Land (Boundary Relocation), prepared by Gassman Development Configuration of Land (Boundary Relocation), prepared by Gassman Development Configuration of Land (Boundary Relocation), prepar	use and to be maintained at all times
		Perspectives, dated 05-02-16, drawing no. 555P ROl02- OF2, Sheet 2 of 2, Issue A	umes
	Proposal Plan Lot 7 on RP846941, Lot 8 on NR153, Lot 201 on SP222765, prepared by Gassman Development Perspectives, dated 09-02-16, Drawing No 555 P PP 100, Issue A		
		 Statement of Landscaping Intent, prepared by Gassman Development Perspectives, dated 30/06/2015, Dwg No 5555 L LI 01, Sheet 1 of 3 	
		 General Arrangement Sediment & Erosion Control Sheet 06 prepared by Mortons Urban Solutions, dated 21-12- 15, Drawing No 307-01-015, Amend B 	
		 General Arrangement Sediment & Erosion Control Sheet 	

No.	Conditions	Condition timing
	 08, prepared by Mortons Urban Solutions, dated 21-12-15, Drawing No 307-01-017, Amend B Bulk Earthworks CutFill Plan Sheet 06 prepared by Mortons Urban Solutions, dated 21-12-15, Drawing No 307-01-035, Amend B Bulk Earthworks CutFill Plan Sheet 08 prepared by Mortons Urban Solutions, dated 02-03-16, Drawing No 	
	 307-01-037, Amend C TMR Layout Plan (20A – 64.48km) prepared by Queensland Government Transport and Main Roads, dated 17/11/2015, File Ref: 275/20A (500-924), Issue A. 	
In acco	rdance with approved report	
21.	The development must be in accordance with the Development Application, prepared by Gassman Development Perspectives, dated September 2015, and given reference/revision number Section 6.0: The Proposal and in particular: • Creation of an additional 21 aquaculture ponds and associated buildings. • No excavated fill will be transported from the land (balance cut/fill). • No retail sales to the general public all deliveries are freighted to the Cairns Airport	Prior to the commencement of use and to be maintained at all times
Locatio	on of the direct vehicular access to the state-controlled road	
22.	The permitted road access location, for which approval under section 62 of the <i>Transport Infrastructure Act 1994</i> must be obtained, is to be located generally in accordance with TMR Layout Plan (20A – 64.48km) prepared by Queensland Government Transport and Main Roads, dated 17/11/2015, File Ref: 275/20A (500-924), Issue A.	At all times
Design	vehicle and traffic volume	
23.	Road access works comprising of a sealed property access to the development, for which approval under section 33 of the <i>Transport Infrastructure Act 1994</i> must be obtained, at the permitted road access location, must be provided generally in accordance with TMR Layout Plan (20A – 64.48km) prepared by Queensland Government Transport and Main Roads, dated 17/11/2015, File Ref: 275/20A (500-924), Issue A.	Prior to the commencement of use and to be maintained at all times
	The road access works must be designed and constructed in accordance with Guide to Road Design - Part 4 of Austroads: Intersections and Crossings - General, Figure 7.2 (rural property access – single or dual carriageway (conditional)).	
Stormy	ater and Drainage impacts on the state-controlled road	
24.	(a) The development must be in accordance with the Stormwater Management Plan entitled Proposed Prawn Farm Expansion - Flood Assessment, prepared by BMT WBM Pty Ltd, dated 24/08/15, and given reference/revision number R.B21286.00:	(a) and (b) At all times
	 (b) Any works on the land must not: create any new discharge points for stormwater runoff onto the state-controlled road; ii. interfere with and/or cause damage to the existing stormwater drainage on the state-controlled road; 	

No.	Conditions	Condition timing	
	iii. surcharge any existing culvert or drain on the state- controlled road; iv. reduce the quality of stormwater discharge onto the state- controlled road.		
	AND	and the first state of the first	
	(c) RPEQ certification must be provided to the Program Delivery and Operations Unit, Department of Transport and Main Roads, Far North Queensland Region: (Far.North.Queensland.IDAS@tmr.qld.gov.au), within the Department of Transport and Main Roads, confirming that the development has been designed and constructed in accordance with parts (a) and (b) of this condition.	(c) Prior to the commencement of use	

Your reference: 5555:BC

Attachment 2—Reasons for decision to impose conditions

The reasons for this decision are:

- To ensure the development is carried out generally in accordance with the plans of development submitted with the application.
- To ensure the development carried out generally in accordance the aspects of the planning report submitted with the application.
- To ensure the development is carried out in the location and to the extent specified on the approved plans of development.
- To ensure the development avoids or minimises adverse impacts on coastal resources and their values.
- To ensure that the authorised species are managed for the net benefit of the species in question and to avoid or acceptably minimise biosecurity risks to any rare, threatened or endangered fish.
- To facilitate the monitoring of the development works for compliance purposes.
- To ensure that the aquaculture facility is designed to maintain integrity of the aquaculture product.
- To ensure that the aquaculture facility is designed and constructed to mitigate risks of impact on the natural environment and to allow for the management of disease.
- To ensure that the aquaculture facility is designed and constructed to mitigate risks of impact on the natural environment and to allow for the management of disease and to ensure that land based aquaculture facilities that hold fish capable of overland escape are designed to prevent such escape.
- To ensure the aquaculture facility is designed, constructed and maintained to avoid leakage, to ensure immunity from flooding and minimise biosecurity and disease risks.
- To ensure that the authorised species are managed for the net benefit of the species in question and to avoid or acceptably minimise biosecurity risks to any rare, threatened or endangered fish.
- To ensure the road access location to the state-controlled road from the site does not compromise the safety and efficiency of the state-controlled road.
- To ensure the design of any road access maintains the safety and efficiency of the statecontrolled road.
- To ensure that the impacts of stormwater events associated with development are minimised and managed to avoid creating adverse impacts on the state transport corridor.
- To ensure the development achieves the outcomes in 3.1 Aguaculture state code, 10.1 Tidal works, or development in a coastal management district and 19.1 Access to state-controlled roads state code in the State Development Assessment Provisions version 1.6.


Your reference: CA 1044/2015

Attachment 3—Further advice

Gene	General advice				
Ref	State Planning Policy July 2014 interim development assessment provisions				
1.	Douglas Shire Council, in its role as assessment manager, must assess the development application against the State Planning Policy July 2014, and in particular the interim development assessment provisions (Part E), such Coastal environment, Water quality and Natural hazards, risk and resilience and to the extent it is relevant to the proposed development.				
Furth	ner development permits, compliance permits or compliance certificates				
Ref	Road access works approval				
2.	Under sections 62 and 33 of the <i>Transport Infrastructure Act 1994</i> , written approval is required from the Department of Transport and Main Roads to carry out road works that are road access works (including driveways) on a state-controlled road.				
	Please contact the Department of Transport and Main Roads on 4045 7144 at the Cairns district office to make an application for road works approval. This approval must be obtained prior to commencing any works on the state-controlled road reserve.				
	The approval process may require the approval of engineering designs of the proposed works, certified by a Registered Professional Engineer of Queensland (RPEQ).				
	The road access works approval process takes time – please contact the Department of Transport and Main Roads as soon as possible to ensure that gaining approval does not delay construction.				
Appl	icable self-assessable codes				
Ref	Self-assessable code MPO3 On-farm drain maintenance works involving the removal, destruction or damage of marine plant (Department of Agriculture and Fisheries)				
3.	Section 6.10 Marine plants are only removed from the bed and one bank from drains that are 2 to 8 metres wide.				
4.	Section 6.5 The removal of marine plants is only undertaken where necessary to maintain the function of existing on-farm drains.				
5.	Section 6.6 a. Mangroves are pruned or trimmed no more frequently than every 12 months; b. Mangroves are pruned or trimmed by no more than a third of their height.				


Your reference: 5555;BC

Attachment 4—Approved plans and specifications

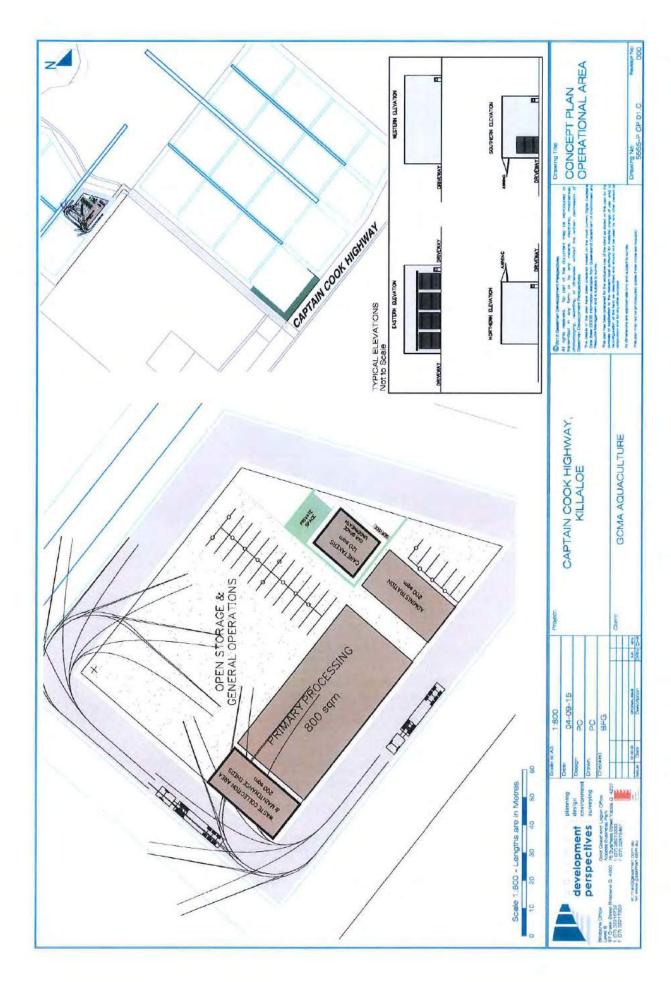





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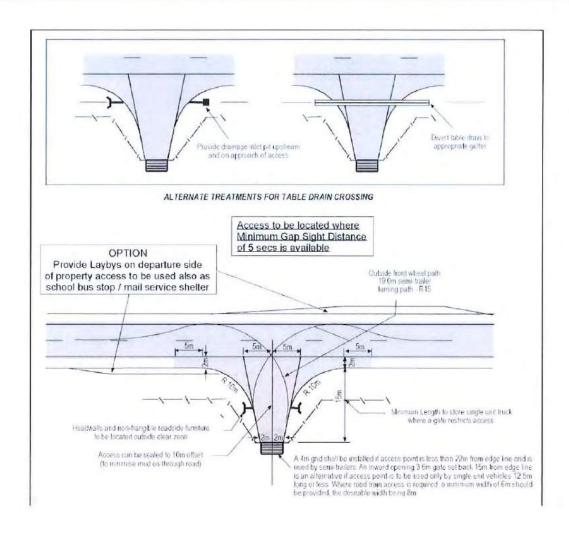

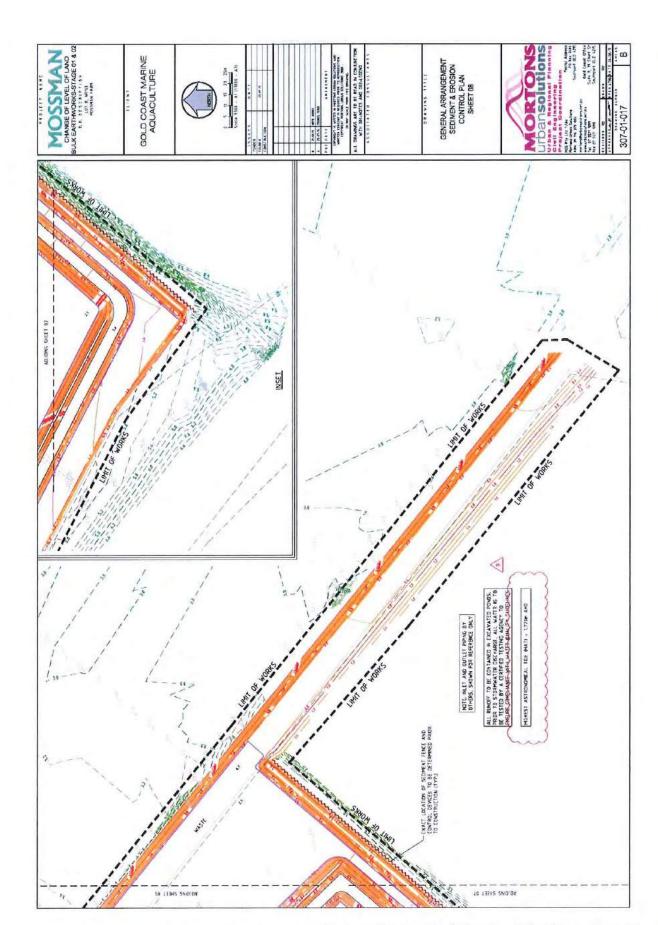
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2006 & 2008 Douglas Shire Planning Schemes Application

INFRASTRUCTURE CHARGES NOTICE

Gold Coast Marine Aq	<u>juaculture</u>		0		0
DEVELOPERS N	AME		ESTATE NAME		STAGE
Captain Cook Highway	Killaloe	8NR153, 201SP222765, 7RP846941		5000, 151233, 5004	
STREET No. & NAME		SUBURB	LOT & RF	No.s	PARCEL No.
Combined; ROL, MCU, Ops W	/rks	1044/2015	25-May	·-16	Four (4)
DEVELOPMENT TYPE		COUNCIL FIL	l		VALIDITY PERIOD (years)
775426		1			
DSC Reference Doc . No.		VERSION No.			
	Use	Charge per Use	Amount Due	Amount Paid	Receipt Code & GL Code
Rural Areas - Water Only					
proposed	800	42.50	34,000.00		
	200	55.74	11,148.00		
	1	11,411.06	11,411.06		
existing	0	0.00	0.00		
Total			56,559.06		
Urban Areas - Water only					
proposed	0	0.00	0.00		
p. spassa	0	0.00	0.00		
existing	0	0.00	0.00		
Total			0.00		
Urban Areas - Water & Sewer					
proposed	0	0.00	0.00		
ргорозец	0	0.00	0.00		
	0	0.00	0.00		
existing	0	0.00	0.00		
Total			0.00		
		1 1		1 1	
		TOTAL	56,559.06		
Prepared by D	Lamond		25-May-16	Amount Paid	
Checked by	N Beck		25-May-16	Date Paid	
Date Payable] [
				Receipt No.	
Amendments			Date	ſ	
				Cashier	
				1	

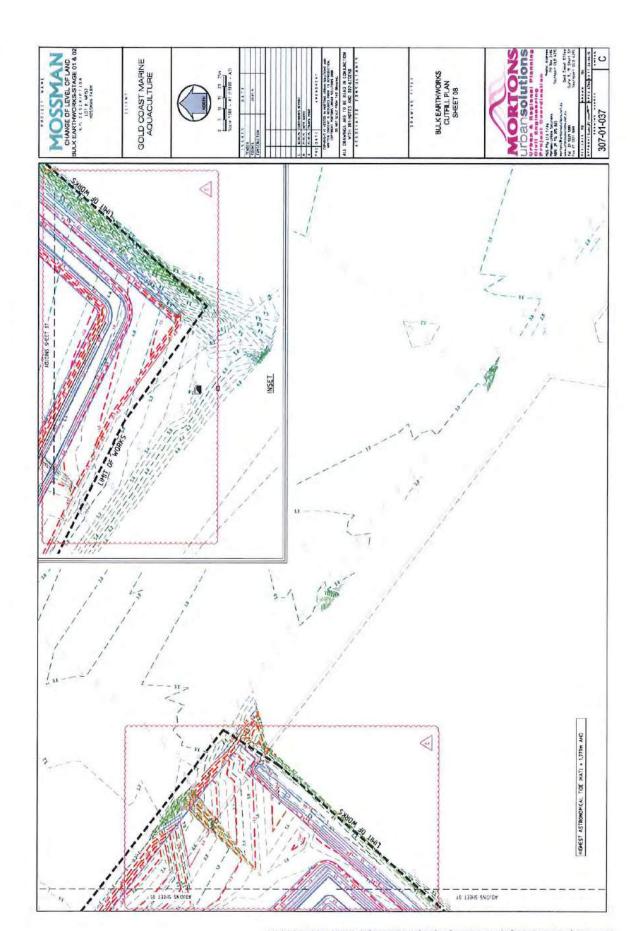Note:

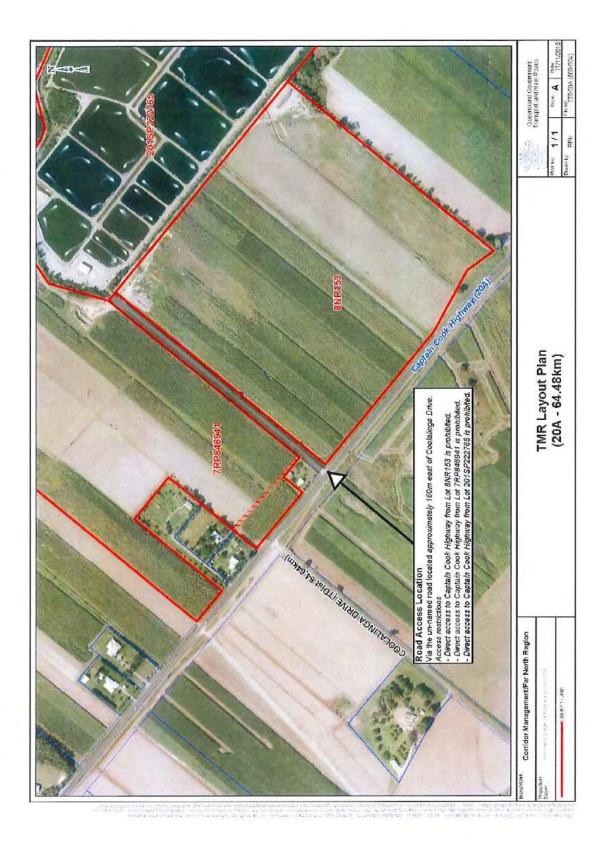The Infrastructure Charges in this Notice are payable in accordance with Part 2 Division 1 of the Sustainable Planning Act 2009 (SPA).

Charges are payable to: Douglas Shire Council. You can make payment at any of Council's Business Offices or by mail with your cheque or money order to Douglas Shire Council, PO Box 723, Mossman QLD 4873. Cheques must be made payable to Douglas Shire Council and marked 'Not Negotiable.' Acceptance of a cheque is subject to collection of the proceeds. Post dated cheques will not be accepted

Any enquiries regarding Infrastructure Charges can be directed to the Development & Environment, Douglas Shire Council on 07 4099 9444 or by email on enquiries@douglas.qld.gov.au