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02 24/4/2024




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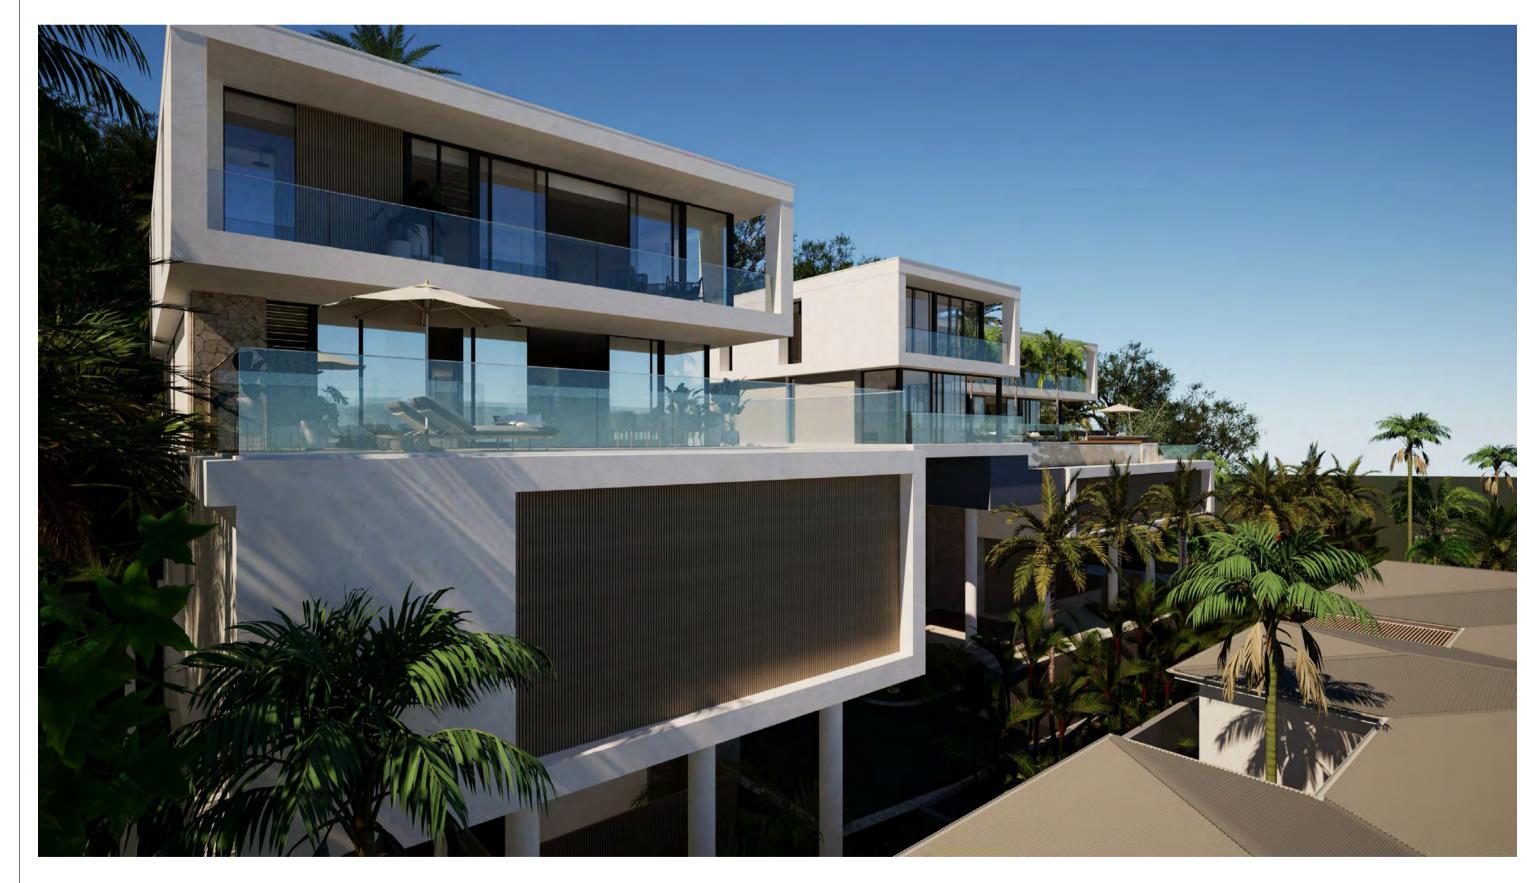
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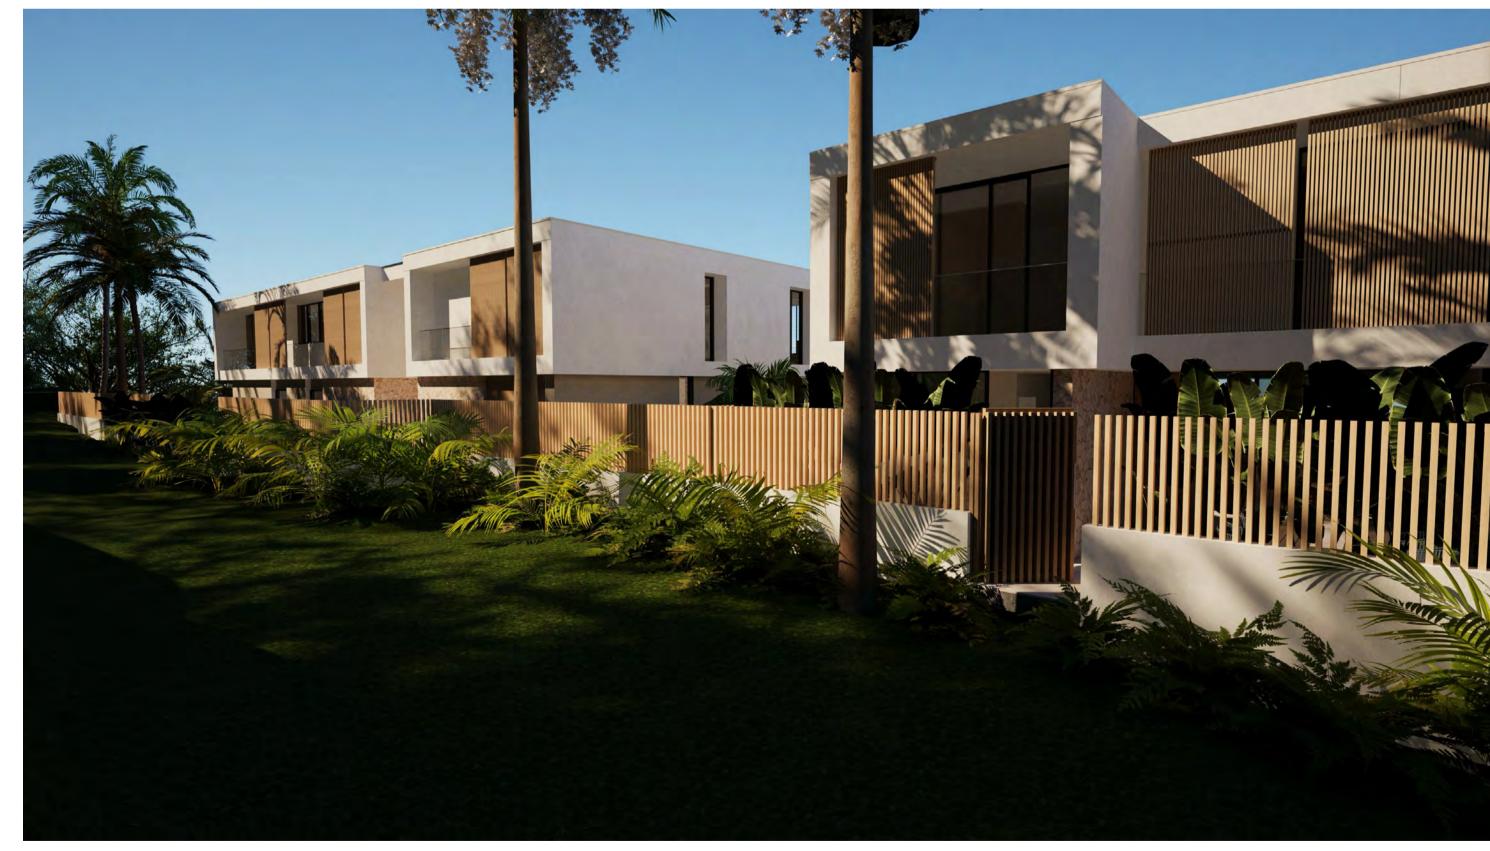
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| PROJECT | IER01 - GURNE | D DECIDEN | CE | SCALE 1:2.2 | 3, 1:3. | DRAWN | JR; KS | CHECKED | G.H. | |
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| 59-73 ML | JRPHY STREET PORP RP724386 | | | SHEET SIZE A1 | | | g status /ELOPMENT | APPLIC | CATION | |
| Gurner TM Nominees Pty Ltd | | | | SET - FINISHES VISUALISATION | | | | | | |
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| BUILDER BUILDER | SIGNATURE | | DATE | GUR_PI | GUR_PD1 | | | | 24/4/202 | |
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| 69-73 MU | JRPHY STREET PC RP724386 | | | SHEET SIZE A1 | | | g status /ELOPMENT | APPLIC | CATIO |
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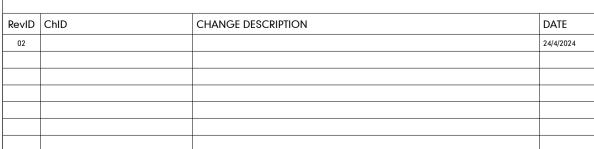
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AUSTRALIAN STANDARDS.

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DEVELOPMENT APPLICATION





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| PROJECT GURNER 01 - GURNER RESIDENCE 69-73 MURPHY STREET PORT DOUGLAS Lot 2 on RP724386 | | | SCALE | | DRAWN | IR; KS | CHECKED | G.H. | |
|---|-----------|------------|--|------------------|-------|--------|-------------|-------------|----------|
| | | | SHEET SIZE DRAWING STATUS A1 DEVELOPMENT AF | | | | APPLIC | APPLICATION | |
| Gurner TM Nominees Pty Ltd | | | SET - PARK PERSPECTIVE | | | | | | |
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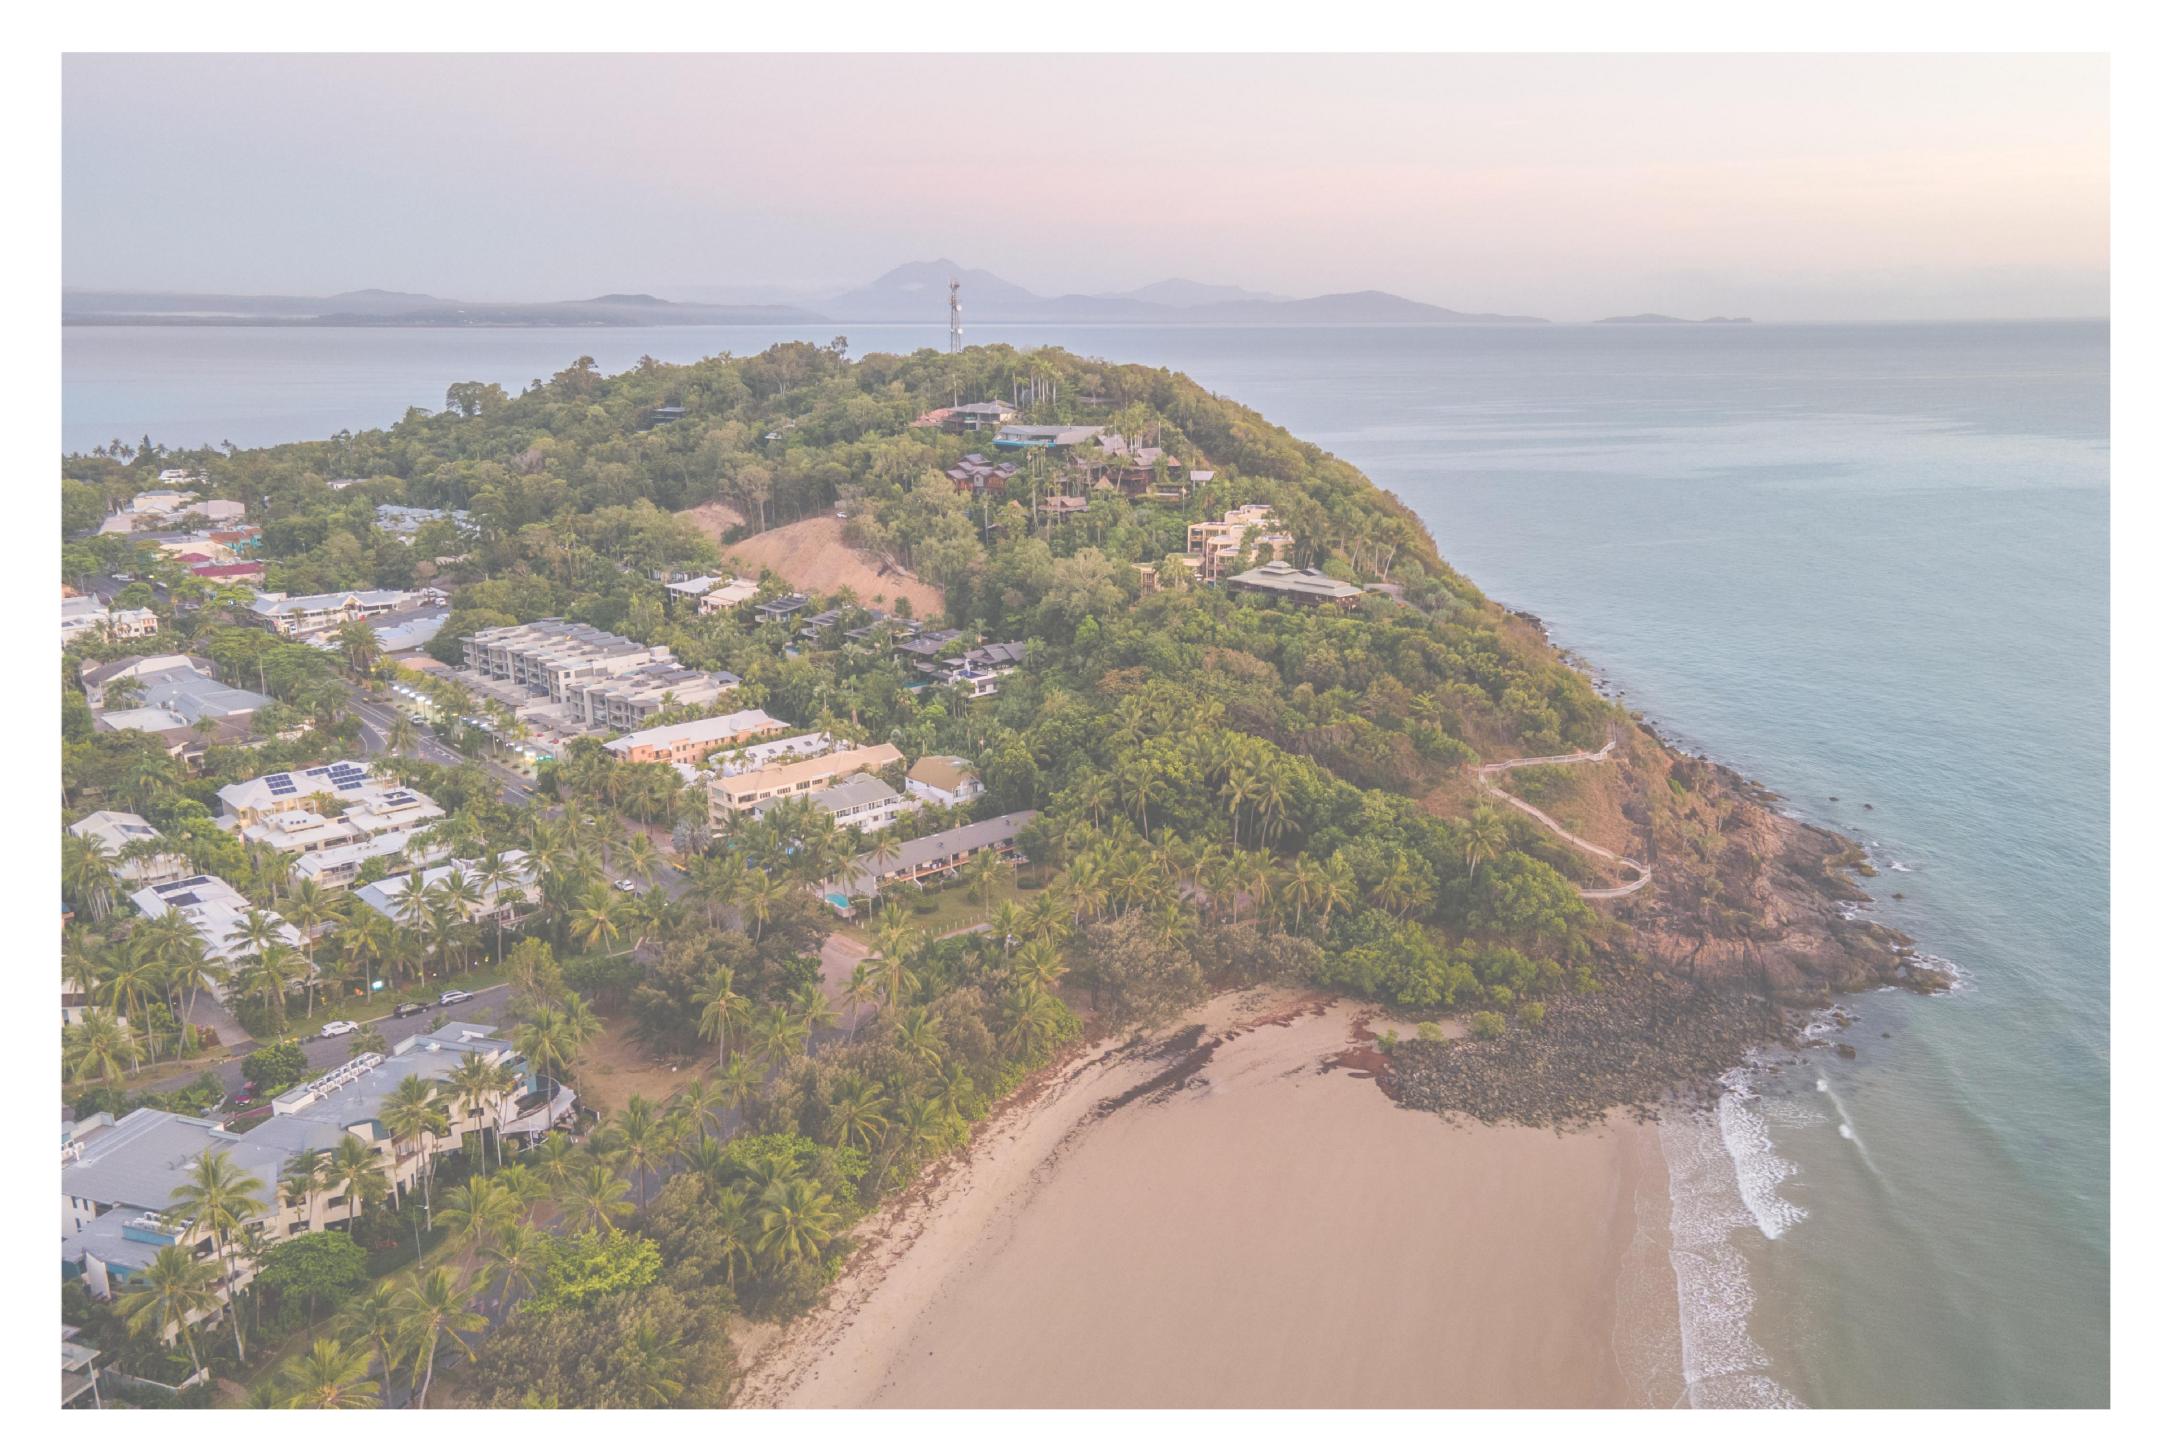
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| CLIENT SIGN OFF | SIGNATURE | | DATE | PROJECT NO. GUR PD1 | | | | 24/4/202 | |
| | r TM Nomi | nees Pt | y Ltd | SET - | PER | SPE | CTIVE | | |
| CLIENT | | | | TITLE | | | | | |
| 69-73 MU Lot 2 on R | RPHY STREET PC P724386 | RT DOUGL | AS | SHEET SIZE A1 | | | IG STATUS VELOPMENT | APPLIC | CATION |
| PROJECT GURNER01 - GURNER RESIDENCE | | | | SCALE | | | JR; KS | CHECKED | G.H. |

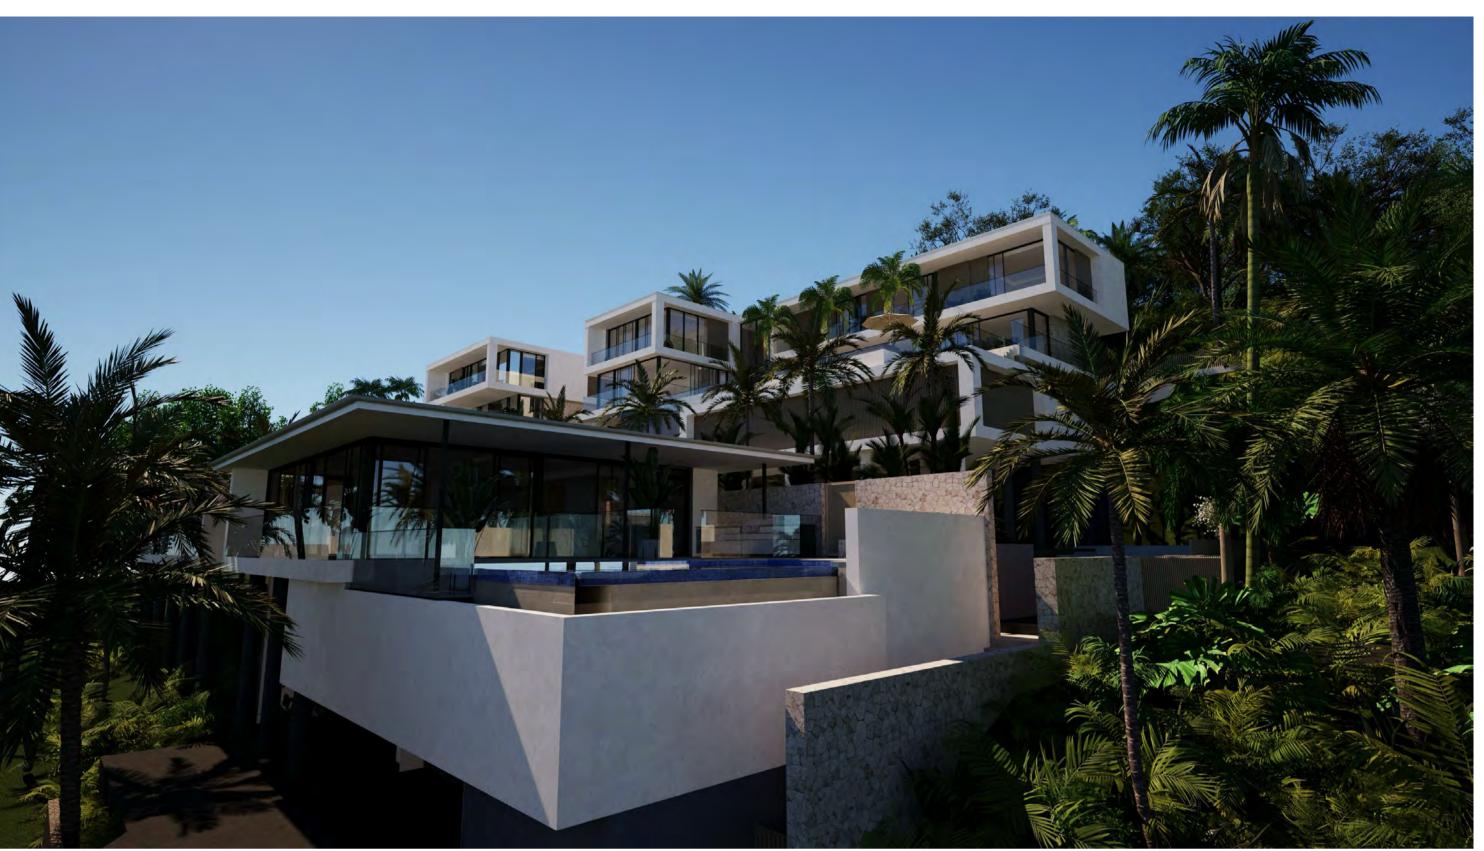Annexure 4: Revised Landscape Plans



69 - 73 MURPHY STREET PORT DOUGLAS

DRAWING SCHEDULE

511_DA_01 **COVER PAGE** PLANTING SCHEDULE 511_DA_02

PLANTING PALETTE 511_DA_03

TREE RETENTION & REMOVAL PLAN 511_DA_04

511_DA_10 LANDSCAPE PLAN - ENTRY ROAD & WESTERN BOUNDARY

511_DA_11 LANDSCAPE PLAN - GROUND LEVEL 1/2

511_DA_12 LANDSCAPE PLAN - GROUND LEVEL 2/2 511_DA_14 LANDSCAPE PLAN - LEVEL 2

511_DA_15 LANDSCAPE PLAN - LEVEL 3

511_DA_35 TYPICAL DETAILS

511_DA_36 BIN SHELTER DETAILS

511_DA_50 GENERAL SPECIFICATION

GENERAL NOTES

- · ALL LANDSCAPE DRAWINGS ARE TO BE READ IN CONJUNCTION WITH THE ARCHITECT'S AND ADDITIONAL CONSULTANT'S DRAWINGS, SPECIFICATIONS AND REPORTS
- · ALL PUBLIC UTILITY SERVICES ARE TO BE LOCATED ON SITE BY THE CONTRACTOR PRIOR TO THE COMMENCEMENT OF WORKS. THE LOCATION, PRESENCE AND EXTENT OF SERVICES SHOWN ARE NOT GUARANTEED COMPLETE OR
- PERFORM EXCAVATION IN THE VICINITY OF UNDERGROUND UTILITIES WITH CARE AND IF NECESSARY, BY HAND. THE CONTRACTOR BEARS FULL RESPONSIBILITY FOR THIS WORK AND DISRUPTION OR DAMAGE TO UTILITIES SHALL BE REPAIRED IMMEDIATELY AT NO EXPENSE TO THE OWNER
- NO TREES PROTECTED UNDER THE LOCAL COUNCIL'S TREE PRESERVATION ORDER ARE TO BE REMOVED UNLESS APPROVED BY DEVELOPMENT CONSENT OR PERMIT OBTAINED FROM COUNCIL
- · ALL PAVING IS INDICATIVE, TO BE TO FUTURE SPECIFICATION, AND SET OUT ON SITE
- · ALL WORK TO BE CARRIED OUT IN ACCORDANCE WITH THE LOCAL COUNCIL'S APPROVAL, STANDARDS AND
- THE CONTRACTOR IS TO ENSURE THAT ALL THE WORKS ARE CARRIED OUT IN ACCORDANCE WITH THE WORK HEALTH AND SAFETY ACT
- MBD TO REVIEW PLANT MATERIALS AT SOURCE OR BY PHOTOGRAPHS PRIOR TO PURCHASE AND DELIVERY EXACT LOCATIONS OF NEW PLANT MATERIAL TO BE SETOUT AND APPROVED BY THE MBD ONSITE PRIOR TO INSTALLATION. MBD RESERVES THE RIGHT TO ADJUST PLANTS TO EXACT LOCATION ONSITE

DRAINAGE AND IRRIGATION NOTES

- REQUIREMENTS FOR LANDSCAPE DRAINAGE TO BE CONFIRMED ONSITE UNLESS OTHERWISE SHOWN ON THE LANDSCAPE PLANS
- TREE PITS THAT HAVE BEEN EXCAVATED INTO HEAVY EARTH OR STONE TO CONTAIN A RING OF AG PIPE LAID AT THE INVERT OF THE PIT WITHIN A MINIMUM 200mm LAYER OF FREE DRAINING MATERIAL. AG PIPE TO BE CONNECTED TO A DRAINAGE OUTLET (REFER TO TYPICAL TREE PIT DRAINAGE SECTION)
- ALL POTS TO HAVE AN IRRIGATION ALLOWANCE (SHRUBBLERS OR DRIP)
- FOR POTS LOCATED ON PAVED SURFACES, TYPICAL PAVING IRRIGATION DETAIL TO BE USED AS SHOWN POTS ADJACENT TO GARDEN BEDS TO BE IRRIGATED VIA IN GARDEN IRRIGATION SYSTEM ALL LAWN AREAS TO HAVE POPUP ROTORS
- ALL GARDEN BEDS TO HAVE FIXED SOLID RISERS WITH SPRAYS

GURNER

DRAWING:





Bamboo Palm Chamaedorea seifrizii

























Weeping Lilly Pilly Waterhousea floribunda

SHRUBS, PERENNIALS & FERNS















































































Birdsnest Fern Asplenium antiquum





PLANT SCHEDULE

| TREES | | | | | | | | | | | |
|---------------|---|----------------------------|----------------|--|--|--|--------|--------------|-------------------------|--------------|--|
| CODE | BOTANIC NAME | COMMON NAME | ZONE 1 | ZONE 2 | ZONE 3 | ZONE 4 | TOTAL | POT SIZE | MATURE HEIGHT | <u>NOTES</u> | |
| AA CA | Archontophoenix alexandrae Cupaniopsis anacardioides | Alexandra Palm Tuckeroo | 5 3 | | | | 5 3 | 200L 200L | 8m 10m | | |
| CS | Chamaedorea seifrizii | Bamboo Palm | 22 | 11 | 5 | X///////////////////////////////////// | 38 | Mature | 3m | <u> </u> | X///////////////////////////////////// |
| CV | Calophyllum inophyllum | Beach Calophyllum | 8 | 6 | | | 14 | Mature | 10m | | |
| CN | Cocos nucifera | Coconut Palm | 30 | 15 | 5 | <u> </u> | 50 | Mature | 6-10m | <u> </u> | |
| СС | Cyathea cooperi | Tree Fern | | 3 | | | 3 | 200L | 5m | | |
| GF | Glochidon ferdinandi | Cheese Tree | 4 | | | | 4 | Mature | 8m | | |
| NF | Nypa fruticans | Nipa Palm | 9 | | | | 9 | 200L | 6m | | |
| PS | Pheonix sylvestris | Sylvester Palm | | | 6 | | 6 | Mature | 10m | | |
| РО | Plumeria obtusa | Frangipani | 3 | 1 | 8 | | 12 | 300L | 6m | | |
| RF | Randia fitzalanii | Native Gardinia | 5 | 3 | | | 8 | 300L | 3m | | |
| VM | Veitchia merrilli | Christmas Palm | 17 | 7 | 5 | | 29 | 200L | 6-8m | | |
| WF | Waterhousea floribunda | Weeping Lilly Pilly | 4 | | | | 4 | 200L | 3-5m | | |
| | | | | | | | | | | | |
| SHRUBS | S & PERENNIALS | | | | | | | | | | |
| CODE | BOTANIC NAME | COMMON NAME | ZONE 1 | ZONE 2 | 70NF 3 | ZONE 4 | TOTAL | POT SIZE | MATURE HEIGHT | NOTES | |
| Ab | Alocasia brisbanensis | Native Cunjevoi Lily | <u>20112 1</u> | 201122 | 201120 | | | 200mm | 1m | 110120 | |
| Ac | Alpinia caerulea | Native Ginger | X | | | | | 200mm | 2m | | |
| <u> </u> | | | <u> </u> | <u> </u> | <i>X////////////////////////////////////</i> | | | <u> </u> | <u> </u> | <u> </u> | <i>X////////////////////////////////////</i> |
| Am | Alocasia macrorrhiza | Giant Taro | | | Х | | | 400mm | 1.5-2.5m | | |
| Cl | Calathea lutea | Cigar Plant | X | X | | | | 200mm | 2-3m | | |
| Cm | Carissa macrocarpa 'Emerald star' | Natal Plum | | | | | | 300mm | 0.6m | | |
| Fm | Ficus microcarpa 'Green island' | Greenlisland Fig | X | X | | | | 300mm | 0.6m | | |
| Lg | Licuala grandis | Ruffled Fan Palm | | | | | | 300mm | 3m | | |
| Md | Monstera deliciosa | Swiss Cheese Plant | | | | | | 400mm | 3m | | |
| PS | Philodendron selloum | Hope Philodendron | X | X | Х | X | | 300mm | 2m | | |
| Re | Rhapis excelsa | Broadlead lady palm | X | X | | | | 300mm | 4m | | |
| \$a | Syzygium australe | Brush Cherry | X | | | | | 200mm | 5m | | |
| Zf | Zamia furfurfacia | Cardboard Plant | | | | X | | 200mm | 1m | | |
| ERNS | | | | | | | | | | | |
| CODE | BOTANIC NAME | COMMON NAME | ZONE 1 | ZONE 2 | ZONE 3 | ZONE 4 | TOTAL | POT SIZE | MATURE HEIGHT | NOTES | |
| Am | Asparagus densiflorus 'Myersii' | Foxtail Asparagus | ZOINE I | ZOTAL Z | ZOINE O | ZOINE 4 | IOIAL | 200mm | | INOTES | |
| Aa | Asplenium antiquum | Birdsnest Fern | | | X | | | 200mm | 1m | | |
| Agu | Asplenium australasicum | Bird's Nest Fern | X | | | | | 200mm | | | |
| Bn | Blechnum gibbum | Silver Lady Fern | <u> </u> | <i>X////////////////////////////////////</i> | X X | | | 200mm | lm | <u> </u> | |
| Md | Microsorum diversifolium | Kangaroo Fern | X | Х | X | | | 100mm | 0.4m | | |
| CROUL | IDCOVERS & CHARRERS | | | | | | | | | | |
| | NDCOVERS & CLIMBERS | | | | | | | | MATURE | | |
| CODE | BOTANIC NAME | COMMON NAME | ZONE 1 | ZONE 2 | ZONE 3 | ZONE 4 | TOTAL | POT SIZE | | NOTES | |
| <u>/Cp///</u> | Callipteris prolifera | Pauggipvillag | <u> </u> | | | | | 140mm | Groundcover | | |
| B | Bougainvillea sp. 'Pink' | Bougainvillea | | | | X | | 200mm | Climber | | |
| Hb/// | Hibbertia banksii | Creening fig | <u> </u> | <u> </u> | <i>\\\\\\\\\\\\\\\\\\\\\\\\\\\\\\\\\\\\\</i> | | | 140mm | Groundcover | | |
| Fp | Ficus pumila | Creeping fig | | <u> </u> | X | | | | Climber | | |
| /Pp/// | Pandorea pandorana Phanhidaphara arvetantha | Wonga Vine | <u> </u> | <u> </u> | <i>XIIIIIIIIIIII</i> | | | 140mm | <u> </u> | | |
| Rc | Rhaphidophora cryptantha | Shingle Plant | | | X | | | 100mm | | | |
| Vo | Viola odorata | Native violet | | | X | | | 100mm | Groundcover Cascading | | |
| Ve | Veronica elliptica | Curtain creeper | | | | | | 100mm | Groundcover Groundcover | | |
| | | | | | | | | | | | |

NOTES

- · IF SPECIFIED POT SIZES ARE NOT READILY AVAILABLE, PLEASE CONTACT MBD TO CLARIFY SUBSTITUTE SIZES AND CHANGES TO QUANTITIES
- · ALL MATURE TREES TO BE SOURCED AND SUPPLIED BY MYLES BALDWIN DESIGN
- THE PLANT SCHEDULE IS CALCULATED BASED OFF THE LANDSCAPE PLANS PROVIDED BY MBD. ADDITIONAL PLANTS OUTSIDE OF THIS SCHEDULE MAY BE REQUIRED TO REACH THE DESIRED PLANT DENSITIES ONSITE · ALL PLANT MATERIAL TO BE SETOUT ONSITE BY MYLES BALDWIN DESIGN PRIOR TO INSTALLATION


SPECIES TO DOUGLAS SHIRE COUNCIL PLANNING SCHEME POLICY SC6.7 LANDSCAPE


EXISTING TREE SCHEDULE

| EXISTING TREES TO BE RETAINED | | | | | | | | | | |
|-------------------------------|-------------------------|---------------|--------|--------|--|--|--|--|--|--|
| CODE | BOTANIC NAME | COMMON NAME | HEIGHT | SPREAD | | | | | | |
| T1 | Cocos nucifera | Coconut Palm | 15m | 5m | | | | | | |
| T2 | Cocos nucifera | Coconut Palm | 11m | 5m | | | | | | |
| Т3 | Cocos nucifera | Coconut Palm | 12m | 5m | | | | | | |
| T4 | Schefflera actinophylla | Umbrella Tree | 10m | 10m | | | | | | |
| T5 | Calophyllum inophyllum | Beauty Leaf | 9m | 11m | | | | | | |
| T6 | Calophyllum inophyllum | Beauty Leaf | 9m | 5m | | | | | | |
| T7 | Calophyllum inophyllum | Beauty Leaf | 18m | 18m | | | | | | |
| T8 | Calophyllum inophyllum | Beauty Leaf | 17m | 10m | | | | | | |
| T9 | Cocos nucifera | Coconut Palm | 15m | 5m | | | | | | |
| T10 | Cocos nucifera | Coconut Palm | 15m | 5m | | | | | | |
| T11 | Cocos nucifera | Coconut Palm | 14m | 5m | | | | | | |
| T12 | Cocos nucifera | Coconut Palm | 14m | 5m | | | | | | |
| T13 | Cocos nucifera | Coconut Palm | 14m | 5m | | | | | | |


NOTES

· REFER TO ARBORIST IMPACT ASSESSMENT PREPARED BY ADVANCED VEGETATION MANAGEMENT 02/08/2023

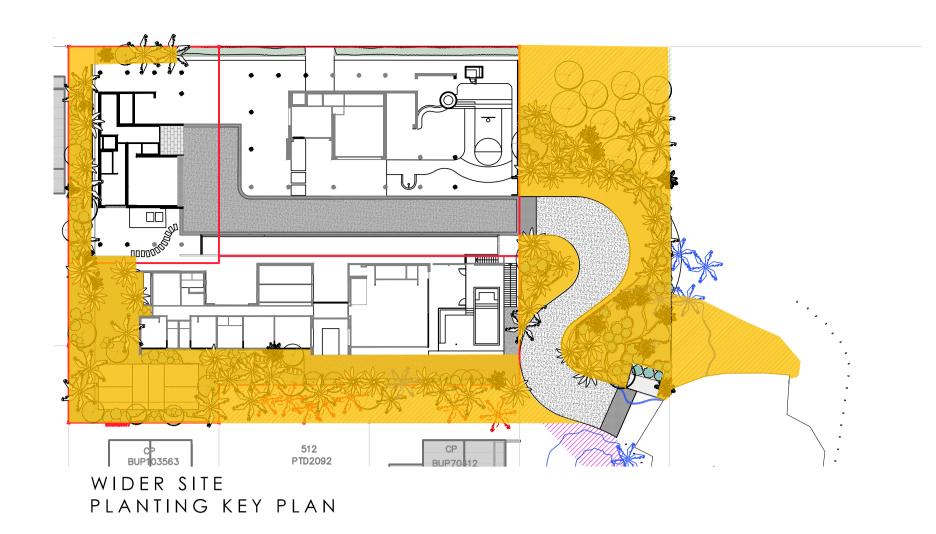


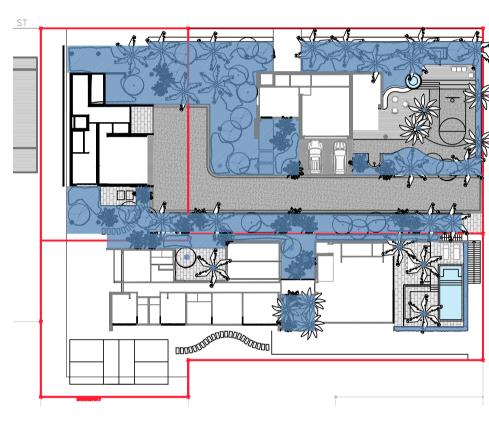

GROUND FLOOR PLANTING KEY PLAN

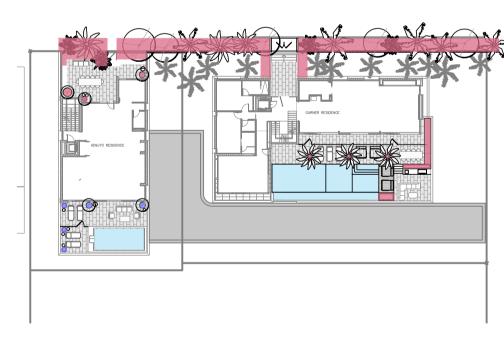

LVL 2 PLANTING KEY PLAN

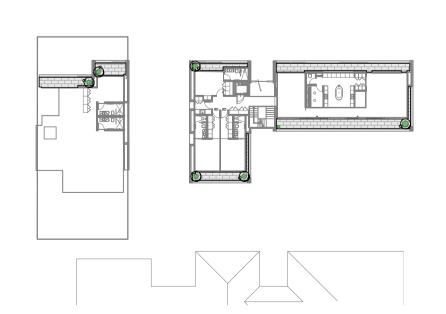

LVL 3 PLANTING KEY PLAN



LEGEND


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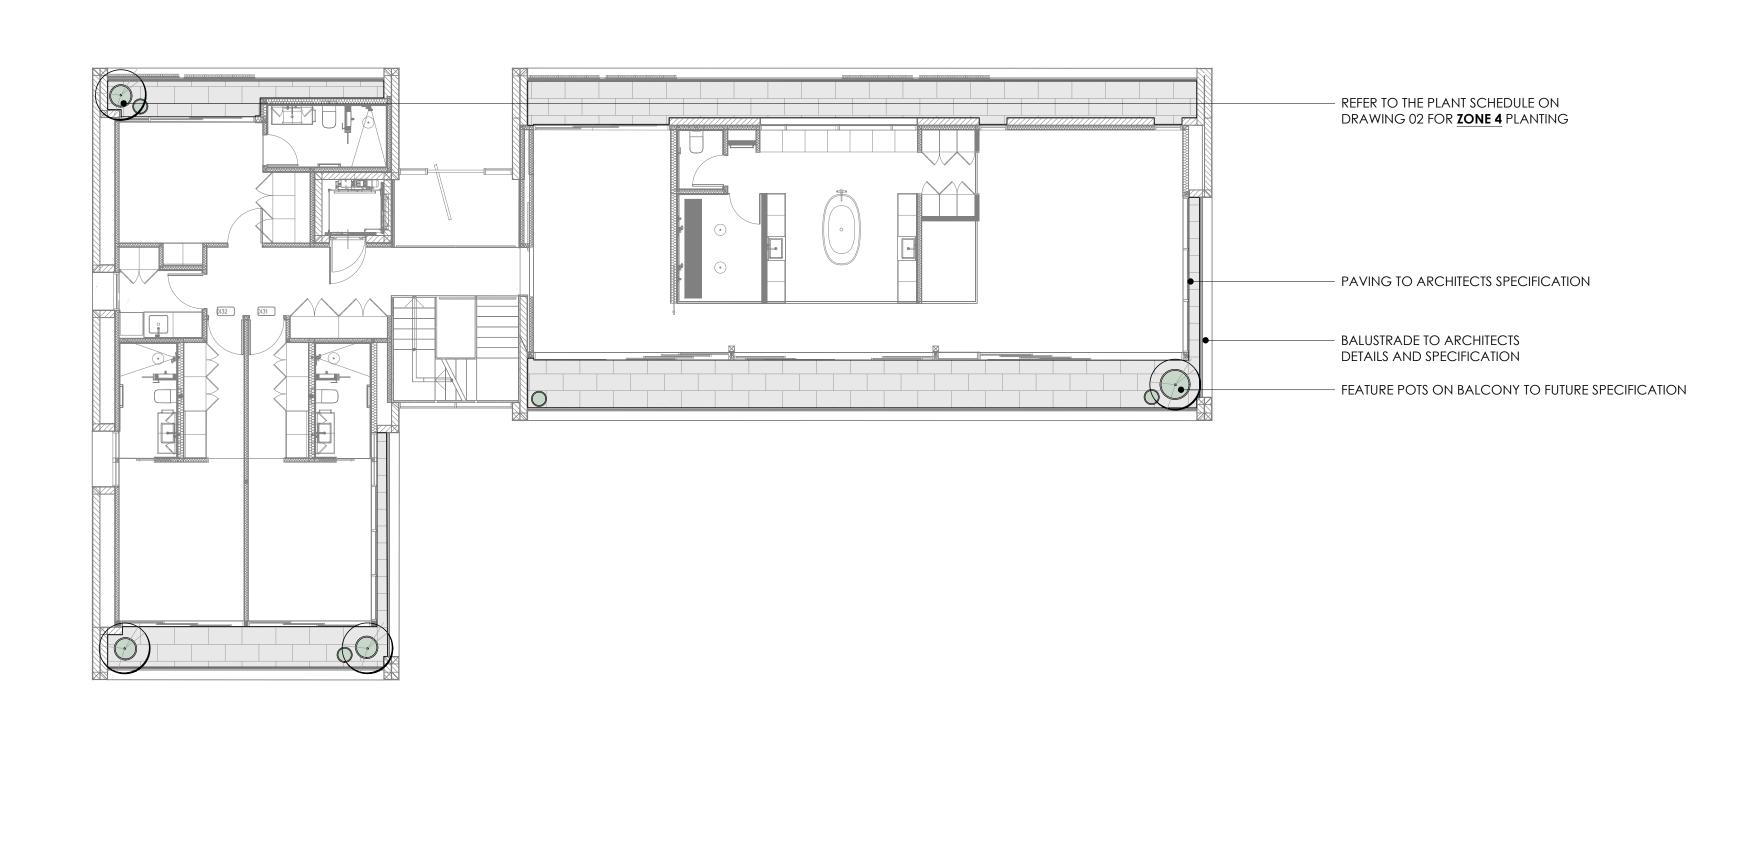
ZONE 2

ZONE 3


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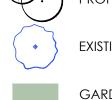






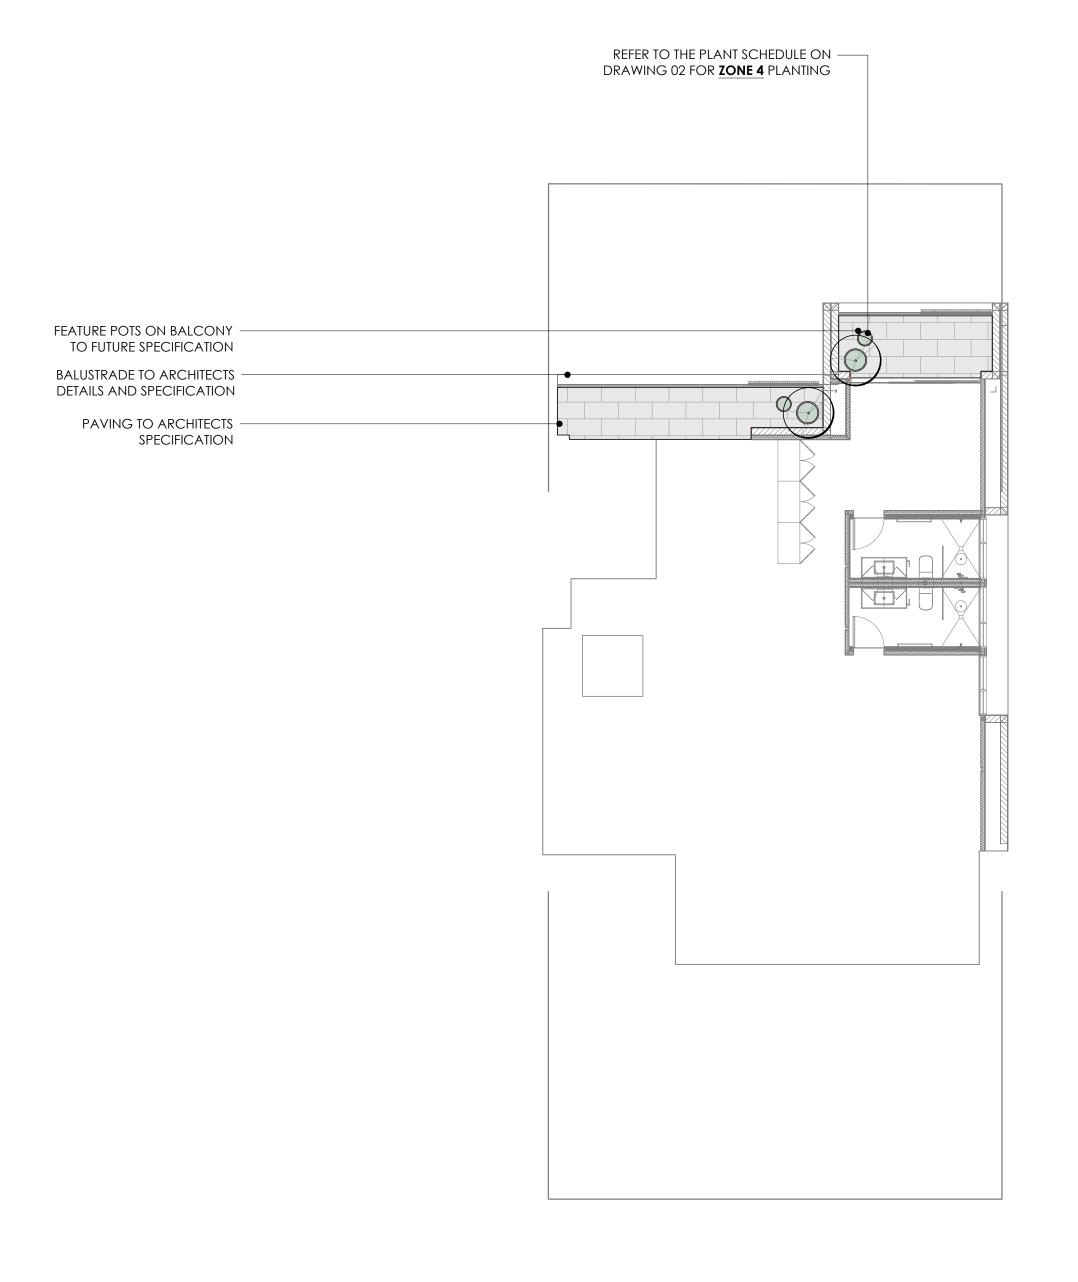





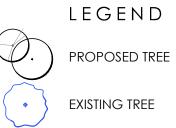








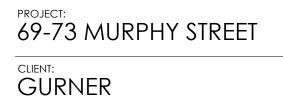


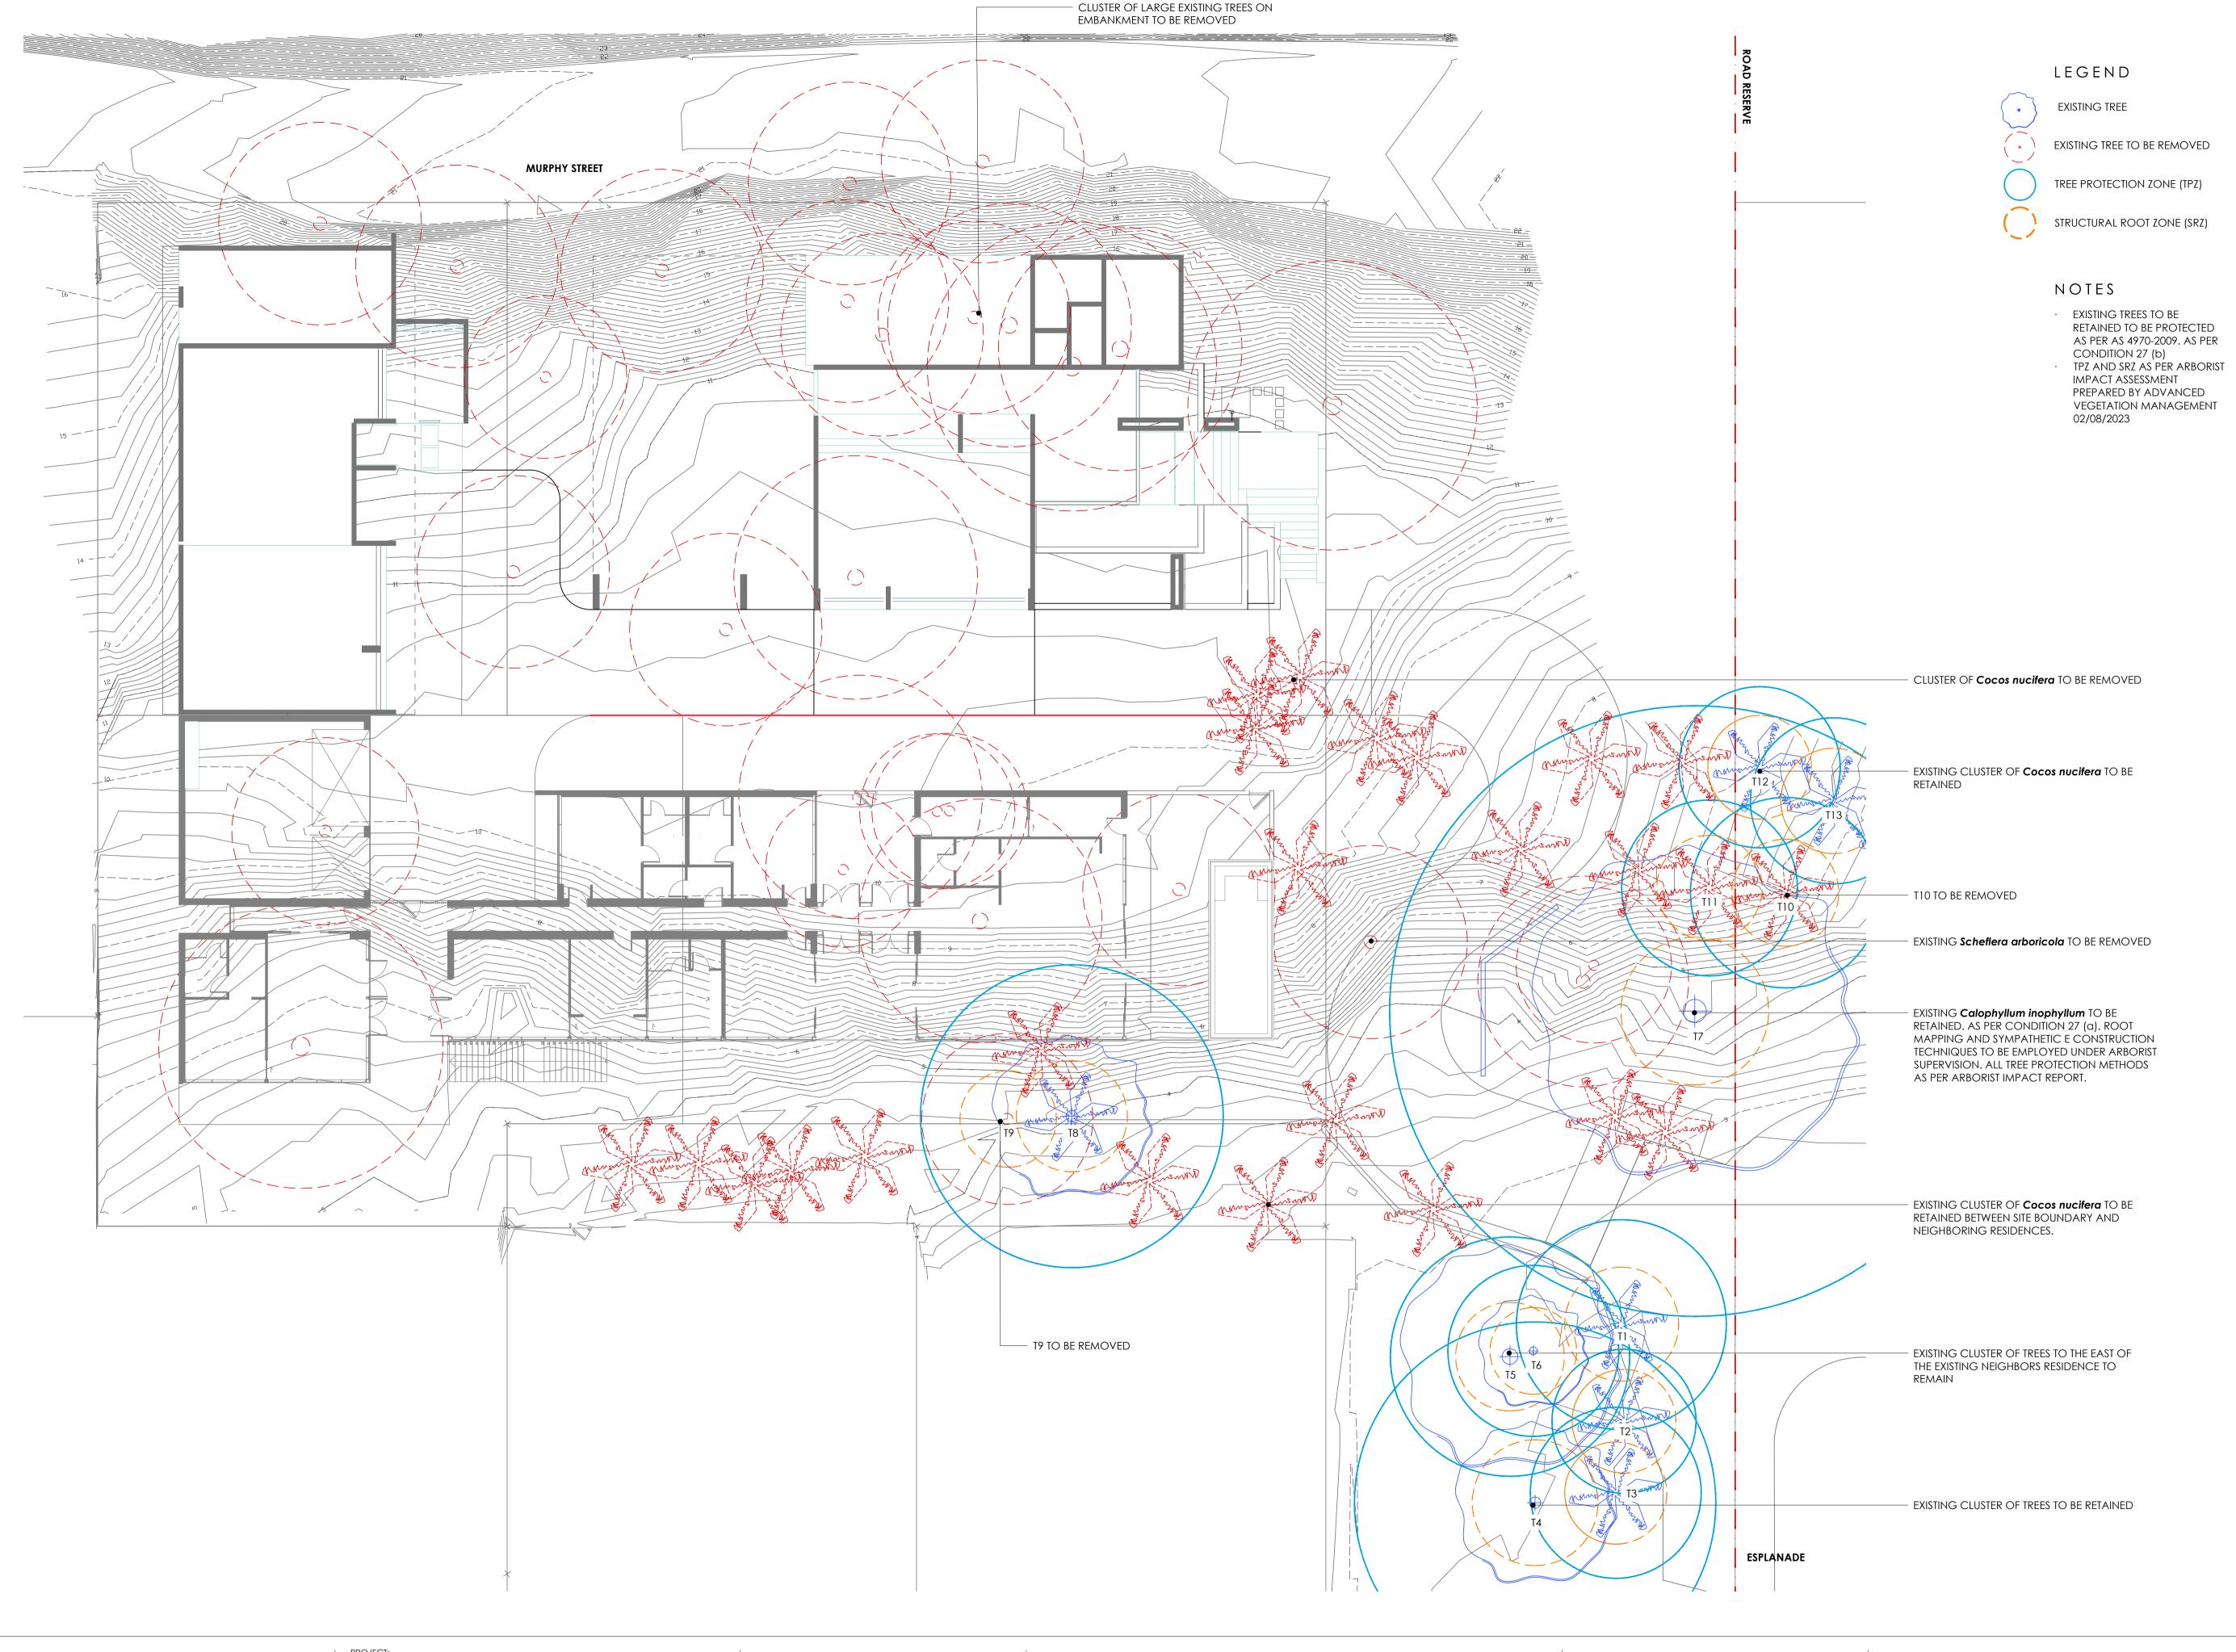


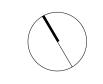

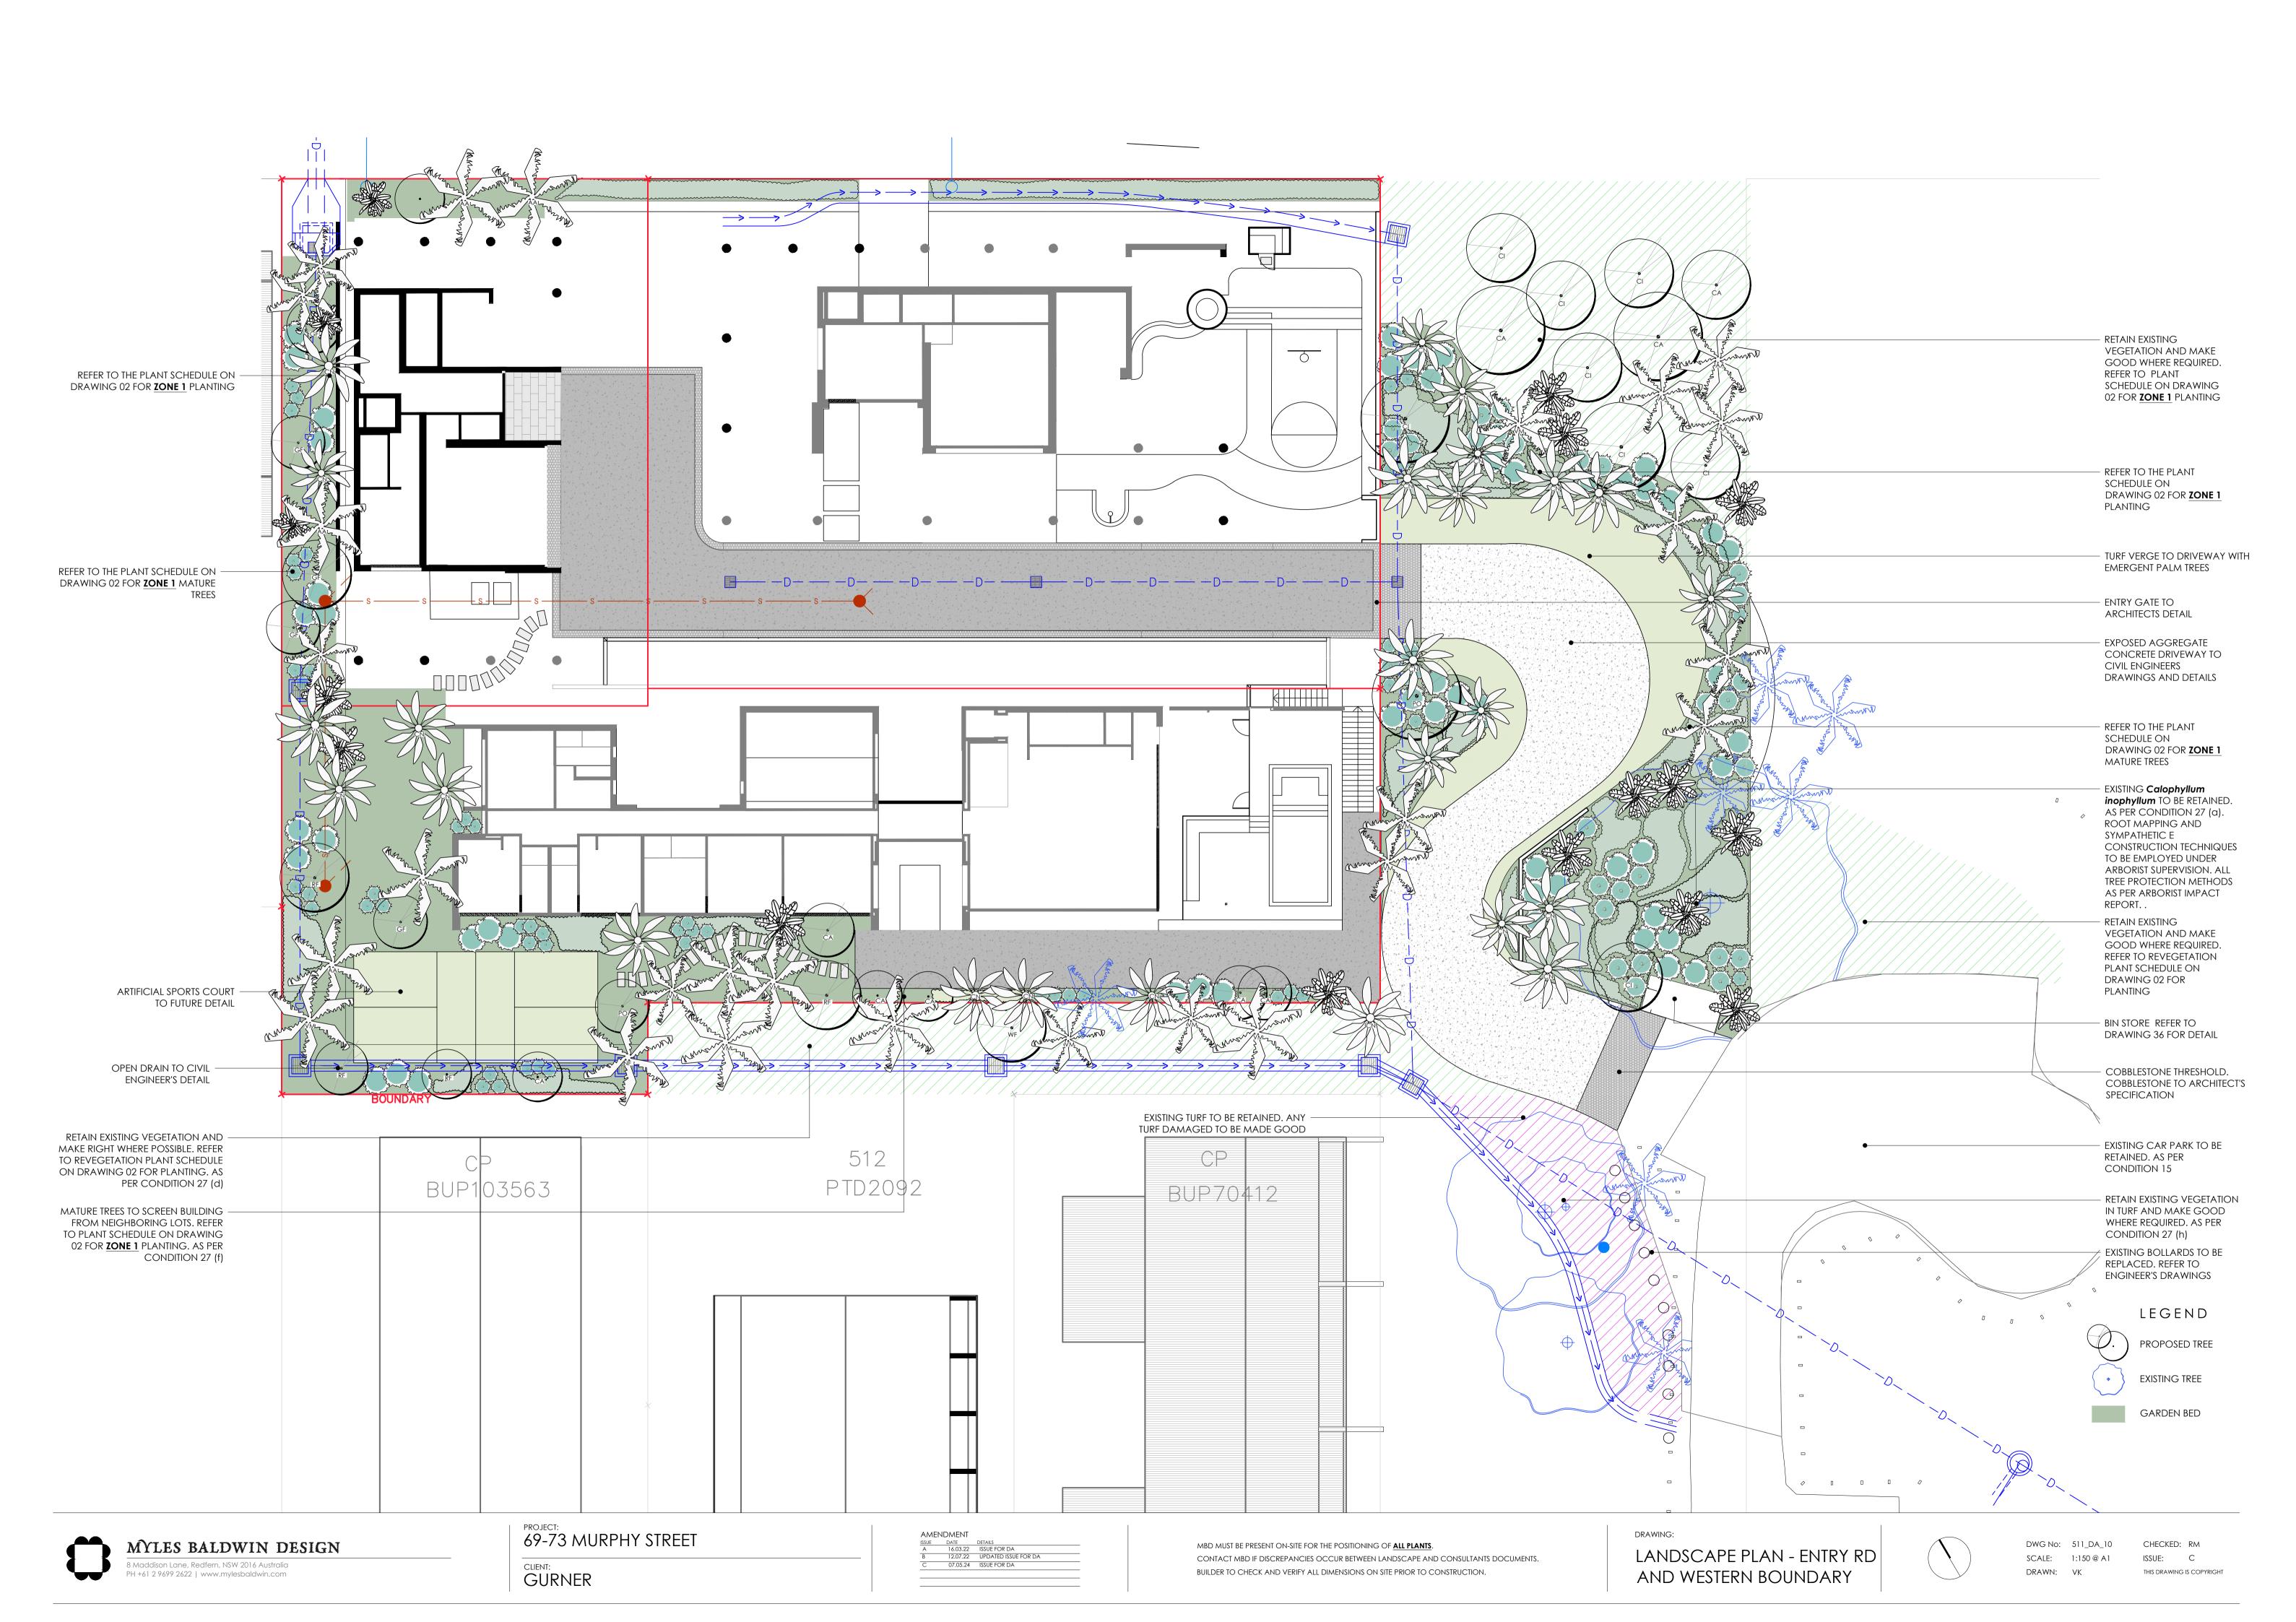

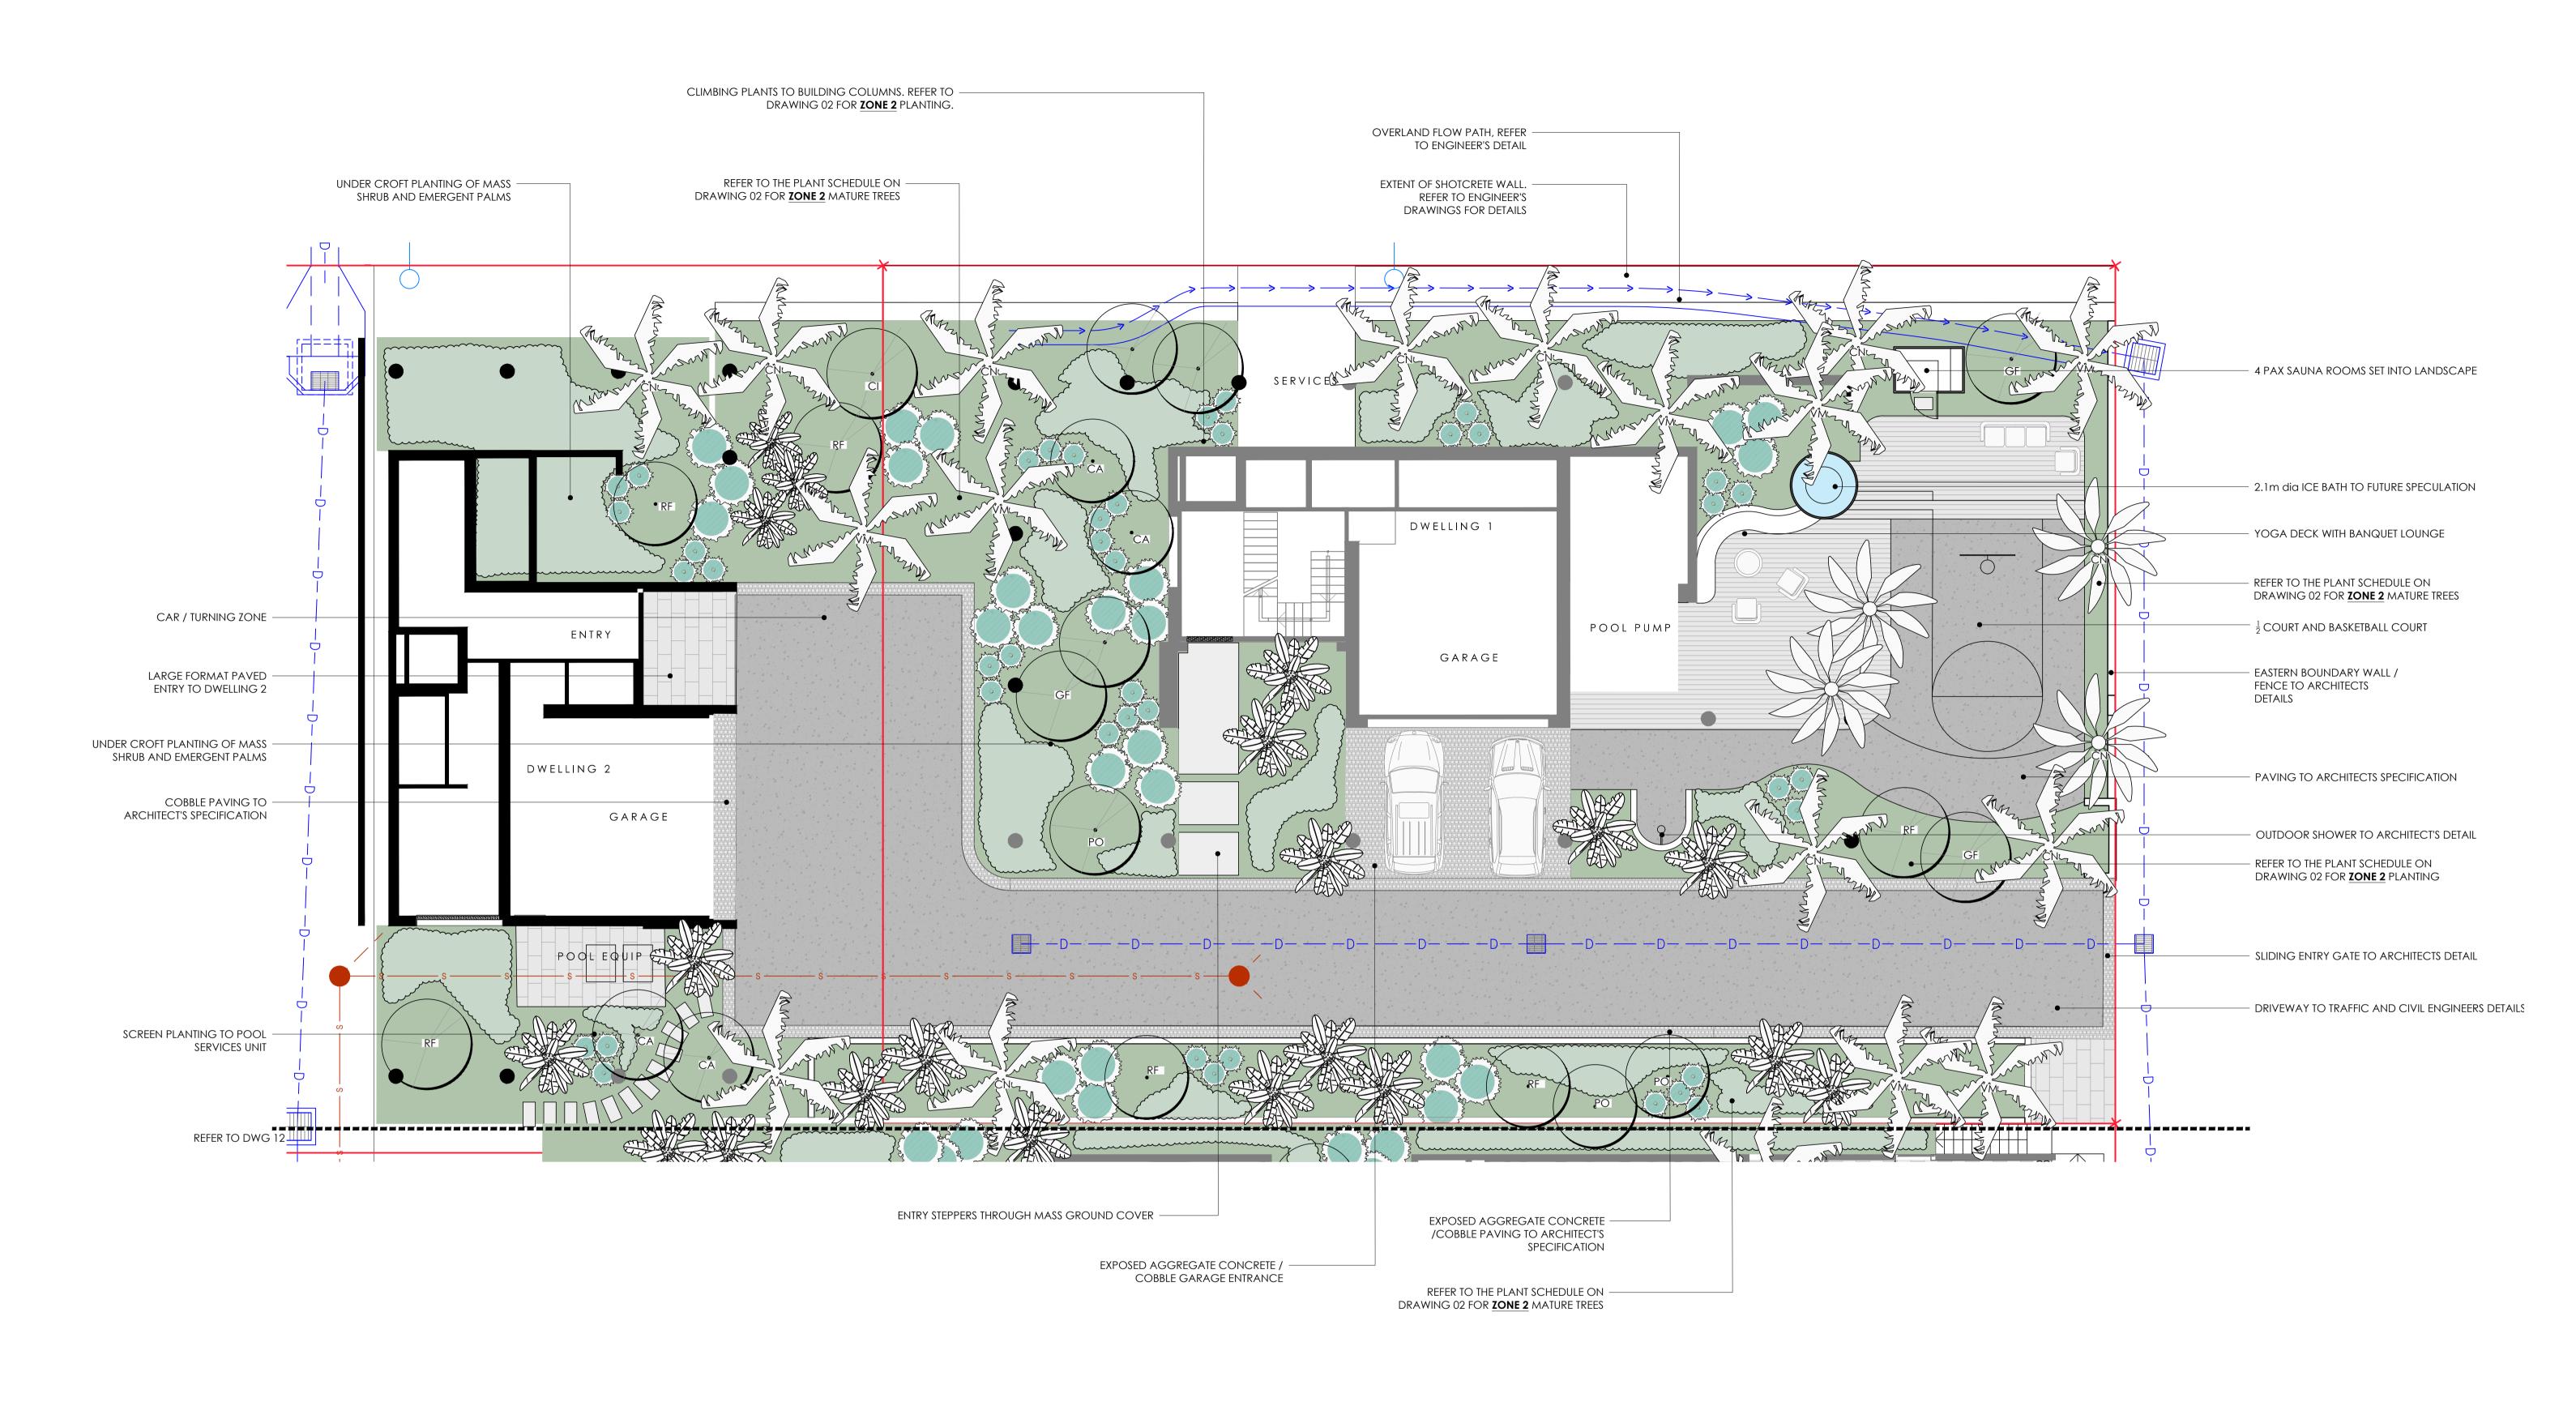

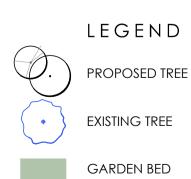

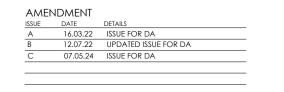

PRIVATE STAIR ACCESS FROM MURPHY -STREET TO RESIDENCES. TO ARCHITECTS SPECIFICATION AND DETAIL

REFER TO THE PLANT SCHEDULE ON -DRAWING 02 FOR **ZONE 3** PLANTING

FEATURE POTS ON POOL TERRACE TO

PAVING TO ARCHITECTS SPECIFICATION -

BBQ AND BAR JOINERY

FUTURE SPECIFICATION

LOUNGE COURTYARD

FUTURE SPECIFICATION

1.2m HIGH GLASS POOL FENCE AND GATE. -TO COMPLY WITH AS 1926.1

FEATURE POTS ON POOL TERRACE TO

VOID TO EMERGENT PALMS BELOW -

VENUTO RESIDENCE

DWELLING 2

2.8 x 6.6m POOL

MURPHY STREET PEDESTRIAN ENTRANCE

REFER TO THE PLANT SCHEDULE ON — DRAWING 02 FOR **ZONE 3** PLANTING

- PLANTER BOXES WITH 1M BALUSTRADE

- REFER TO THE PLANT SCHEDULE ON DRAWING 02 FOR **ZONE 3** PLANTING

MURPHY STREET


SET BEHIND THE PLANTING TO ARCHITECTS DETAIL


DWG No: 511_DA_14 SCALE: AS NOTED DRAWN: VK


- PLANTED EMBANKMENT WITH CASCADING PLANT MATERIAL TO VOID BELOW

VOID TO GROUND FLOOR BELOW

CHECKED: RM ISSUE: C THIS DRAWING IS COPYRIGHT

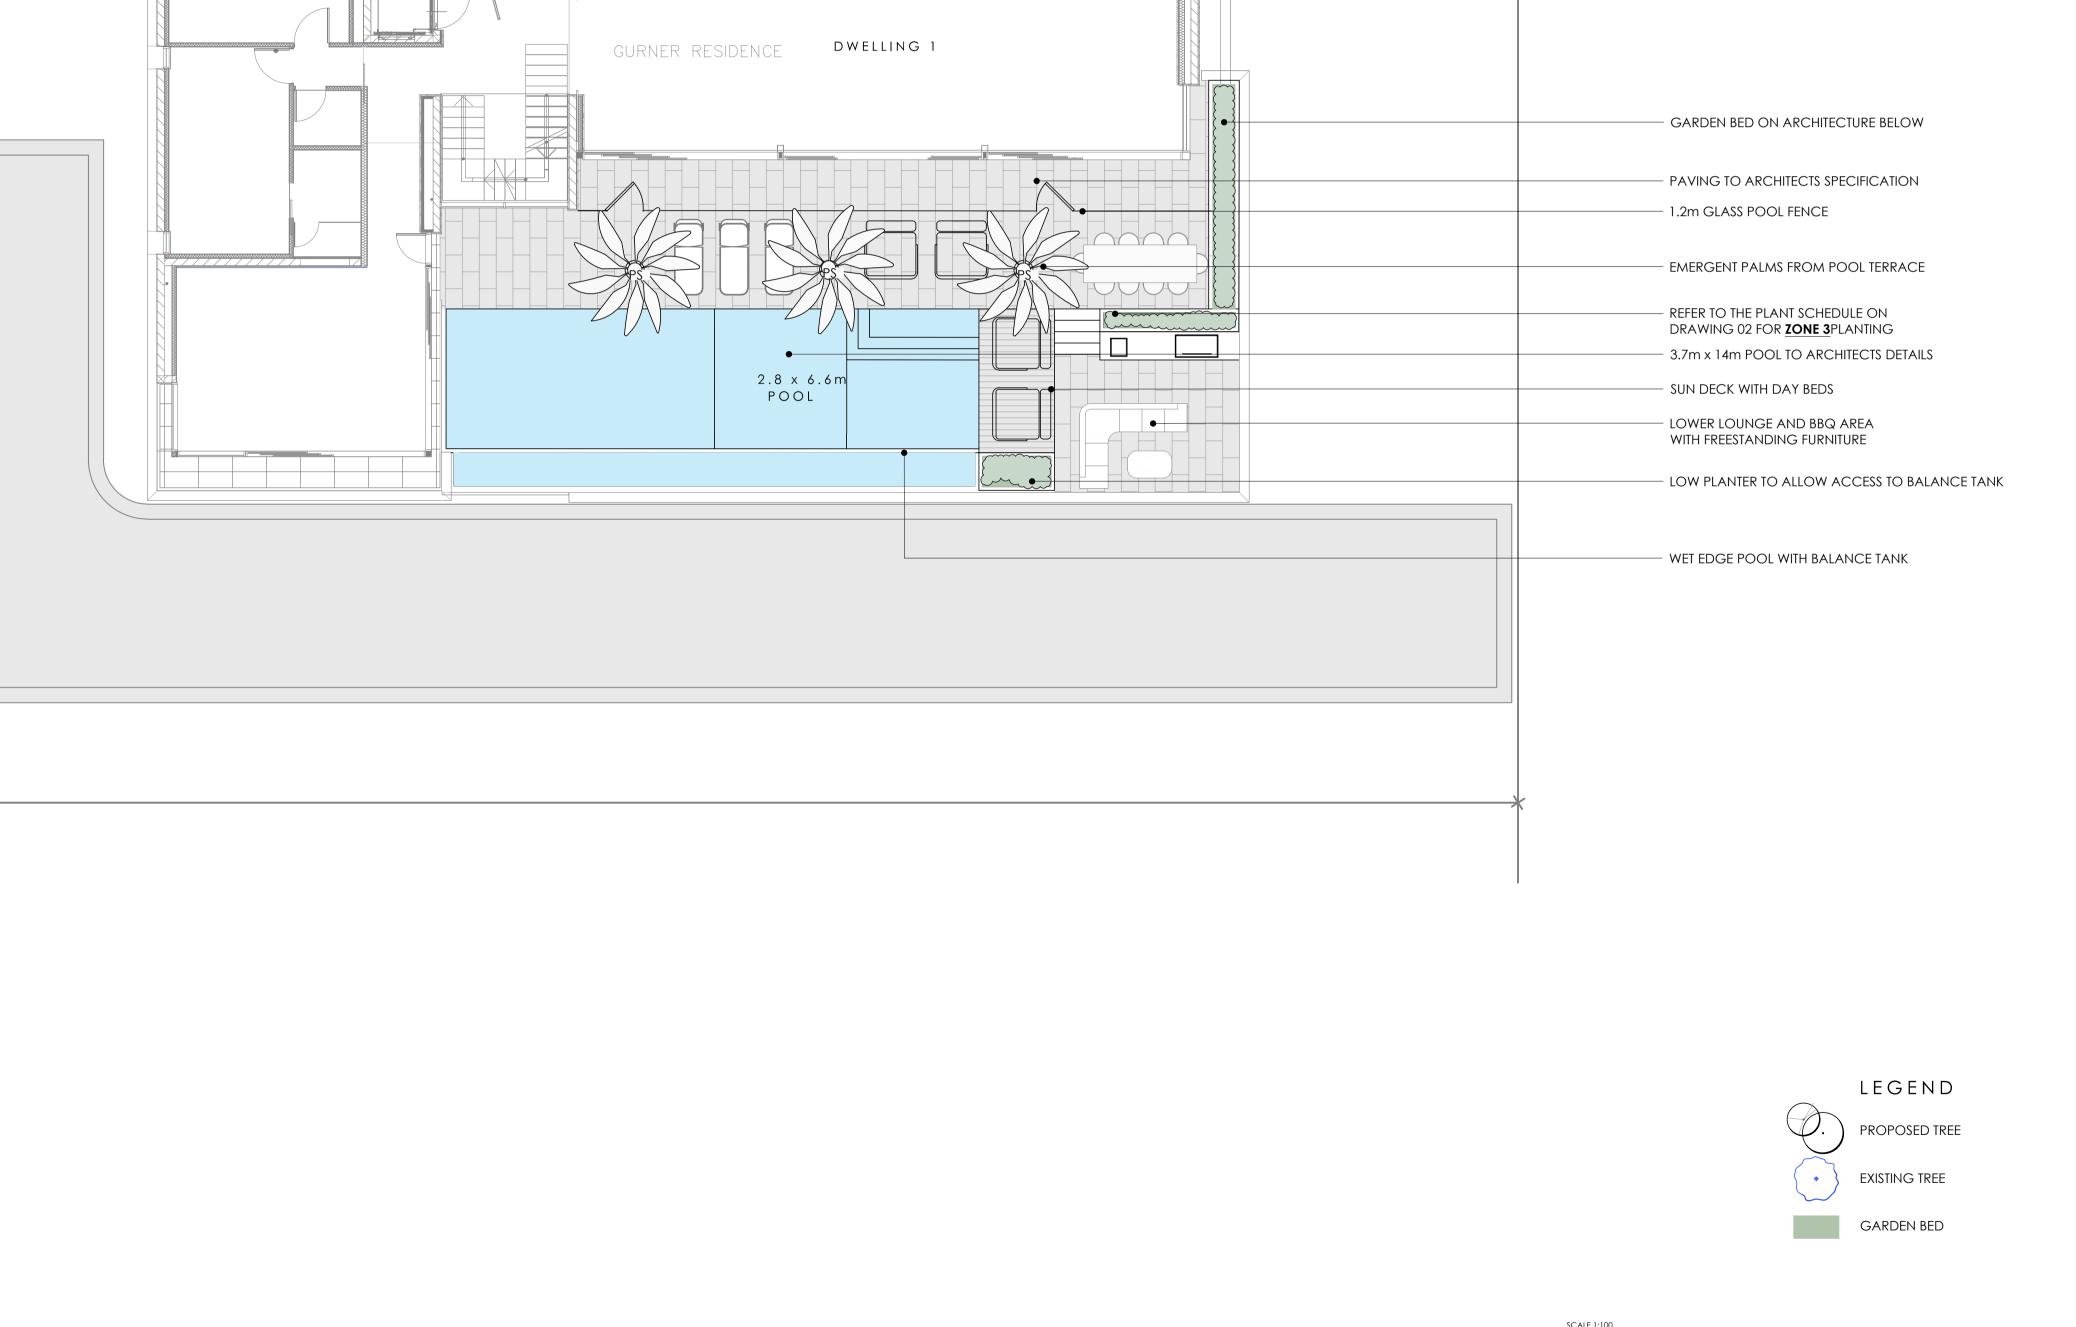

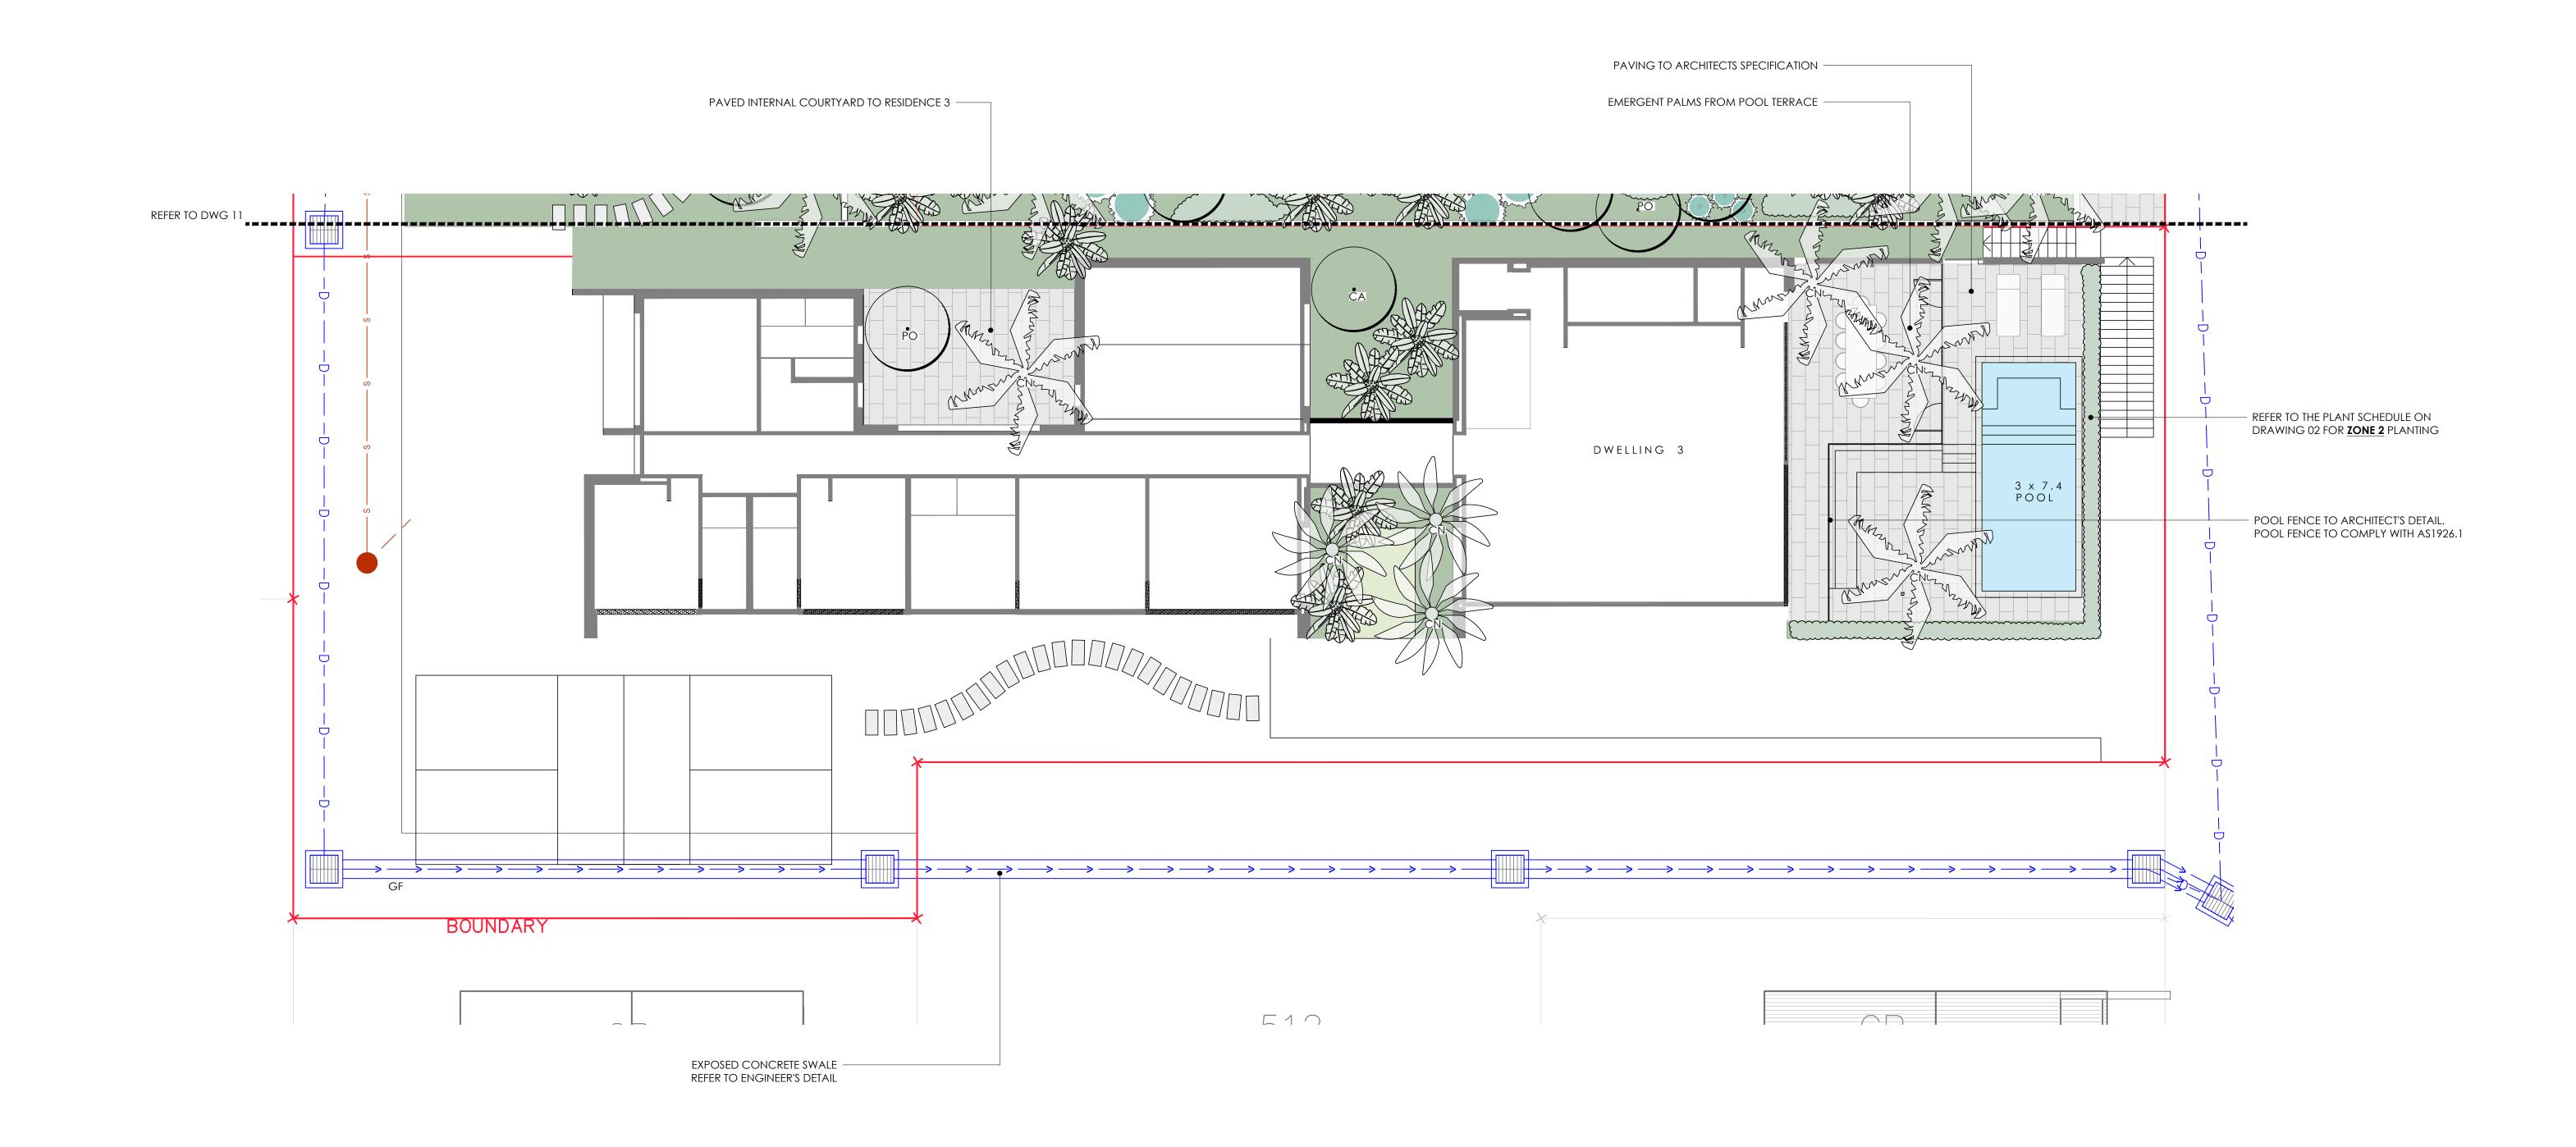


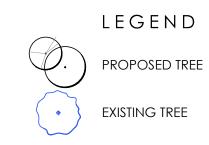



EXISTING TREE

GARDEN BED




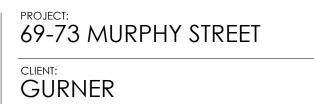

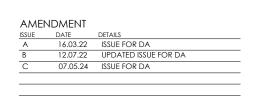


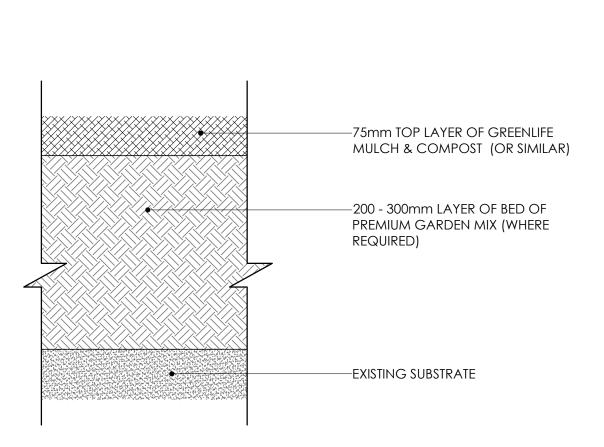


TYPICAL GARDEN SOIL PROFILE SCALE: 1:5 @ A1

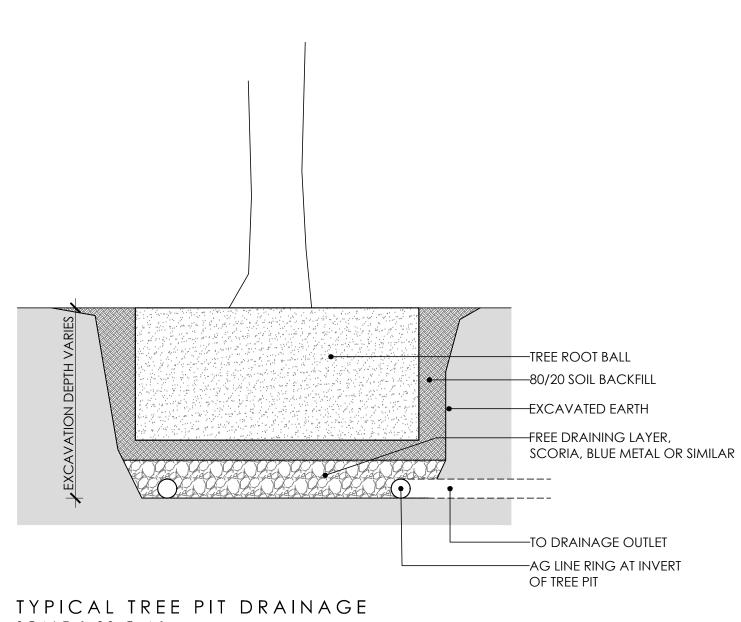


TYPICAL TREE PIT DRAINAGE SCALE 1:20 @ A1

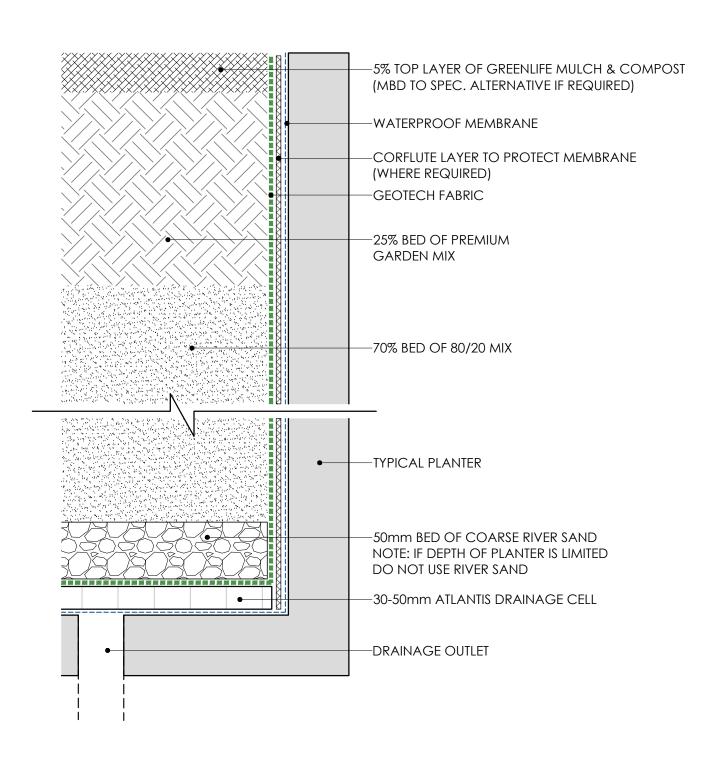


TYPICAL PLANTER SOIL PROFILE SCALE: 1:5 @ A1

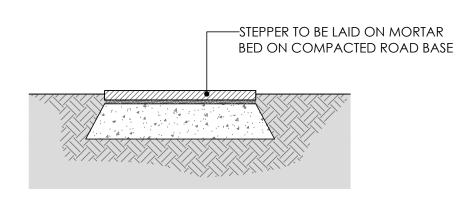


TYPICAL GARDEN STEPPER SCALE: 1:10 @ A1

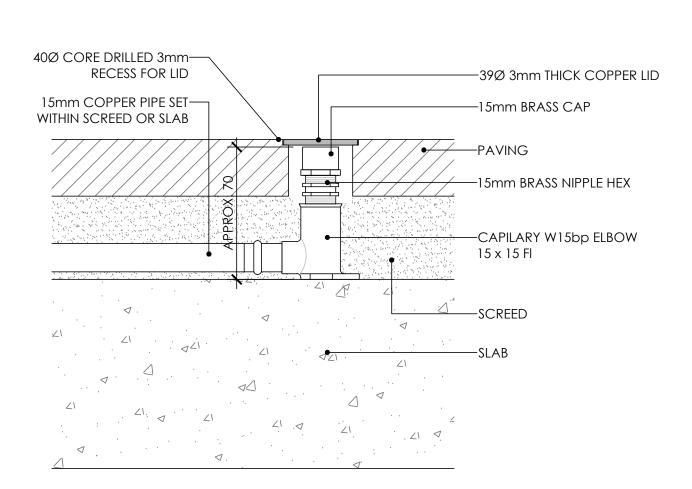


TYPICAL PAVING IRRIGATION CLOSED SCALE 1:2 @ A1

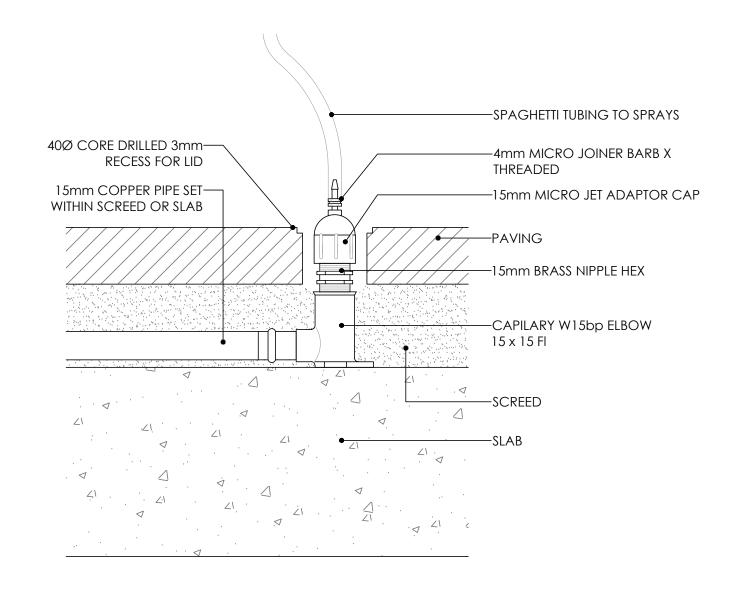

TYPICAL PAVING IRRIGATION OPEN SCALE 1:2 @ A1

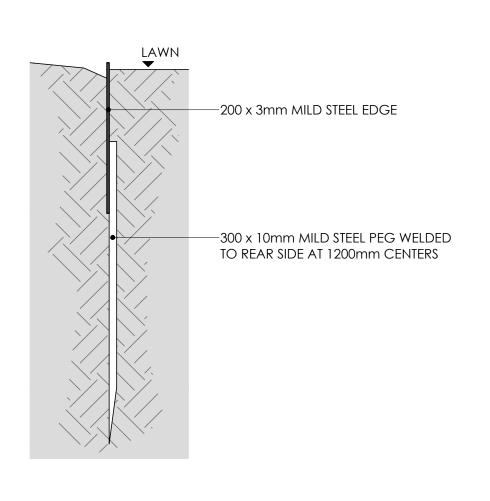

TYPICAL STEEL EDGE SCALE 1:5 @ A1

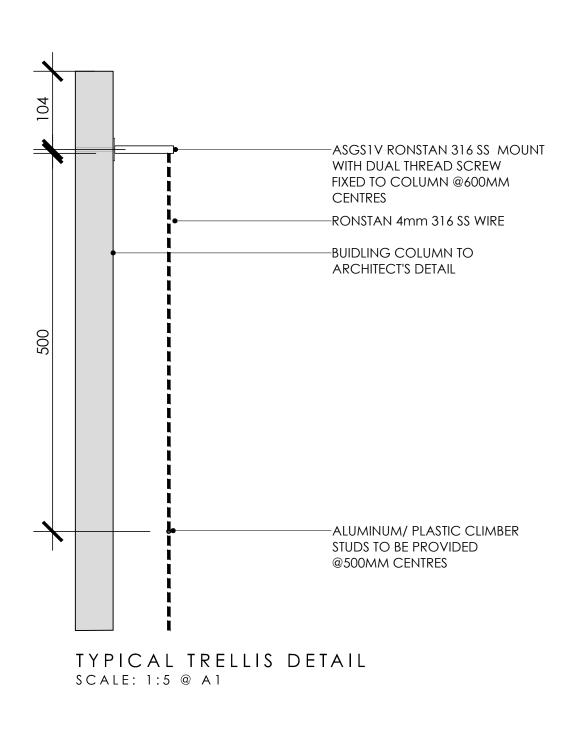

GENERAL SPECIFICATION NOTES

1.0 STANDARDS

1.1 SOILS

AS 4419: Soils for Landscaping and Garden Use

AS 3743: Potting Mixes

· AS 4454: Composts, Soil Conditioners and Mulches

- 1.2 Plants
- AS 2303: Tree Stock for Landscape Use
- AS 4970: Protection of Trees on Development Sites
- 2.0 PRODUCTS
- 2.1 MATERIAL

Topsoil

- · Source: Provide topsoil, which contains organic matter, is free from stones, contaminants and weeds
- · Site: If available, provide material recovered from the site

Turf

Supplier: Obtain turf from a specialist grower of cultivated turf

· Quality: Provide turf of even thickness, free from weeds and other foreign matter

Fertiliser

General: Provide proprietary fertilisers, delivered to the site in sealed bags marked to show manufacturer or vendor, weight, fertiliser type, N:P:K ratio, recommended uses and application rates

Plants

- · Health: Supply plants with foliage size, texture and colour at time of delivery consistent with the size, texture and colour shown in healthy specimens of the nominated species
- Vigour: Supply plants with extension growth consistent with that exhibited in vigorous specimens of the species nominated
- · Damage: Supply plants free from damage and from restricted habit due to growth in nursery rows
- · Pests and disease: Supply plants with foliage free from pest attack or disease
- Substitutes: Plant substitution (species or quantities) is not acceptable unless approved by Myles Baldwin Design.

3.0 EXECUTION

3.1 SITE PREPARATION

Weed eradication

- Herbicide: Eradicate weeds with a non-residual glyphosate herbicide in any of its registered formulae, at the recommended maximum rate
- Placing: Place clean filling in layers approximately 150 mm thick compacted to 85% of the dry density ratio of the surrounding soil as determined by AS 1289.5.4.1. Minimise slumping and further internal packing down

Edges

Construct changes in grade over a minimum width of 500 mm to smooth, gradual and rounded profiles with no distinct joint

Existing trees

- · Tree protection zones (TPZ) shall be established around all trees to be retained and in accordance of AS 4970. The area within the fence shall be mulched
- · No excavation, construction activity, grade changes, storage of materials, stock piling, siting of sheds, preparation of mixes or cleaning of tolls is permitted within the TPZ

Planting beds

- · Excavated: Excavate to bring the subsoil to at least 300 mm below finished design levels. Shape the subsoil to fall to subsoil drains where applicable.

 Break up the subs to a further depth of 100 mm
- · Unexcavated: Remove weeds, roots, building rubble and other debris. Bring the planting bed to 75 mm below finished design levels
- Services and roots: Do not disturb services or tree roots; if necessary, cultivate these areas by hand

Placing topsoil

Topsoil depths

- General: Spread the topsoil on the prepared subsoil and grade evenly, making the necessary allowances to permit the following:
- · Required finished levels and contours may be achieved after light compaction

· Grassed areas may be finished flush with adjacent hard surfaces such as kerbs, paths and mowing strips

- General: Spread topsoil to the following typical depths:
- Excavated planting areas: If using organic soil, 300 mm. Refer to typical soil profile detail
- · Irrigated grassed areas generally: 150 mm
- · Irrigated grassed areas, heavy use (e.g. playing fields, playgrounds, and public parks): 200 mm

Sediment and Erosion Control


MYLES BALDWIN DESIGN

- · Sediment and erosion control measures are required during the construction of all developments and building works. It shall be the contractor's responsibility that works are carried out in accordance with a sediment and erosion control plan and council/approving authority's requirements.
- 3.2 TURFING

General

- · Supply: Deliver the turf within 24 hours of cutting, and lay it within 36 hours of cutting. Prevent the turf from drying out between cutting and laying. If it is not laid within 36 hours of cutting, roll it out on a flat surface with the grass up, and water as necessary to maintain a good condition
- Laying: Lay the turf in the following manner:
- In stretcher pattern with the joints staggered and close butted
- Parallel with the long sides of level areas, and with contours on slopes
- To finish flush, after tamping, with adjacent finished surfaces of ground, paving edging, or grass seeded areas
- Tamping: Lightly tamp to an even surface immediately after laying. Do not use a roller
- Fertilising: Mix the fertiliser thoroughly into the topsoil before placing the turf. Apply lawn fertiliser at the completion of the first and last mowings, and at other times as required to maintain healthy grass cover
- Watering: Water immediately after laying until the topsoil is moistened to its full depth. Continue watering to maintain moisture to this depth
- · Levels: Where levels have deviated from the design levels after placing and watering, lift turf and re-grade topsoil to achieve design levels

69-73 MURPHY STREET CLIENT: GURNER

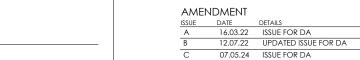

MBD MUST BE PRESENT ON-SITE FOR THE POSITIONING OF <u>ALL PLANTS</u>.

CONTACT MBD IF DISCREPANCIES OCCUR BETWEEN LANDSCAPE AND CONSULTANTS DOCUMENTS.

BUILDER TO CHECK AND VERIFY ALL DIMENSIONS ON SITE PRIOR TO CONSTRUCTION.

AWING:

GENERAL SPECIFICATION

DWG No: 511_DA_50

SCALE: AS NOTED

DRAWN: VK

CHECKED: RM

ISSUE: C

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Individual plantings in grassed areas: Excavate a hole twice the diameter of the root ball and at least 100 mm deeper than the root ball. Break up the base of the hole to a further depth of 100 mm, and loosen compacted sides of the hole to prevent confinement of root growth

Watering: Thoroughly water the plants before planting, immediately after planting, and as required to maintain growth rates free of stress

Placing: Remove the plant from the container with minimum disturbance to the root ball, ensure that the root ball is moist and place it in its final position, in the center of the hole and plumb, and with the top soil level of the plant root ball level with the finished surface of the surrounding soil

· Fertilising plants: In planting beds and individual plantings, place fertiliser pellets around the plants at the time of planting

- Backfilling: Backfill with topsoil mixture. Lightly tamp and water to eliminate air pockets
- 3.4 TREES

3.3 PLANTING

General

General

· All trees must be planted by an AQF Level 3 Qualified Arborist, Landscape Gardener or Horticulturalist

Clay Soils

· The base of each tree pit within clay soils shall be laid with 100mm deep scoria. A 90mm ag line ring shall sit within the scoria and drain directly to a suitable location. Lay geo-textile fabric evenly above the scoria, prior to tree placement and backfilling with 80/20 mineral soil

3.5 MULCHING

Placing mulch

- · General: Place mulch to the required depth, clear of plant stems, and rake to an even surface flush with the surrounding finished levels. Spread and roll mulch so that after settling, or after rolling, it is smooth and evenly graded between design surface levels sloped towards the base of plant stems in plantation beds, and not closer to the stem than 50 mm in the case of gravel mulches.
- · Garden beds: Greenlife Mulch and Compost
- · Tree mulch ring: Mushroom compost
- Depths: Spread organic mulch to a depth of 75 mm, and gravel mulch to a depth of 50 mm

3.6 STAKES AND TIES

Stakes

- Material: Hardwood, straight, free from knots or twists, pointed at one end
- Installation: Drive stakes into the ground at least one third of their length, avoiding damage to the root system

Ties

· General: Provide 50 mm hessian webbing ties fixed securely to the stakes, one tie at half the height of the main stem, others as necessary to stabilise the

3.7 WATERING

Establishment

- Extent: Available soil moisture content of grass areas and garden beds to be monitored on a weekly basis using an approved moisture probe and water applied on a demand basis. Readings should be taken at a depth of 250mm
- · All grass areas and garden beds should be maintained within a range of 50-80% available soil moisture. Under no circumstance should areas under irrigation fall below a level of 30% available soil moisture
- No visible signs of wilting of leaves or stems, with all plants fully turgid at all times.
- No sign of over-watering such as constantly wet soil, brown leaf margins, stem rot or brown spots on foliage

3.8 LANDSCAPE SUBSOIL DRAINAGE

General

· Include subsoil drainage behind retaining walls, along path edges and in mass planting beds, including lawn areas. Maintenance access points shall be every 1.5m

Material

- Geotextile fabric: shall consist of a woven or a non-woven type to be manufactured from synthetic materials other than polyamide
- Aggregate: shall be a single size with a nominal dimension of 10-40mm
- · Subsoil pipe: shall be 90 mm diameter corrugated flexible slotted PVC pipe in a geofabric sock, or 100mm µPVC if under pavement. All pipes to requirements of AS 1254. Where vehicle loads are encountered, reinforced concrete pipe shall be used only

Construction

- · Trenches to be minimum 300mm wide and extend 500mm below the subgrade level or 150mm if into bed rock
- Trenches to be lined with geotextile fabric and backfilled with aggregate. Pipe to be laid 50mm above trench floor.
- Prior to backfilling the trench, drainage and connection to stormwater is to be approved by the site manager
- 3.9 COMPLETION

Cleaning

- Stakes and ties: Remove those no longer required at the end of the planting establishment period
- Temporary fences: Remove temporary protective fences at the end of the planting establishment period

4.0 ESTABLISHMENT & DEFECTS LIABILITY

4.1 ESTABLISHMENT

General

- · All landscaping works will have an establishment period of 26 weeks in which the subcontractor will be responsible for the maintenance and upkeep of the contracted scope, unless otherwise noted in the project documentation. If applicable refer to the project manager / builder for confirmation
- 4.2 DEFECTS LIABILITY PERIOD


General

All landscaping works will be subject to a defects liability period of 52 weeks, commencing from the date of Practical Completion, unless otherwise noted in the project documentation. If applicable refer to the project manager / builder for confirmation


4.3 FAILED PLANTINGS

General


· Photographic images of plants shall be approved by Myles Baldwin Design prior to procurement of replacement plant and tree stock

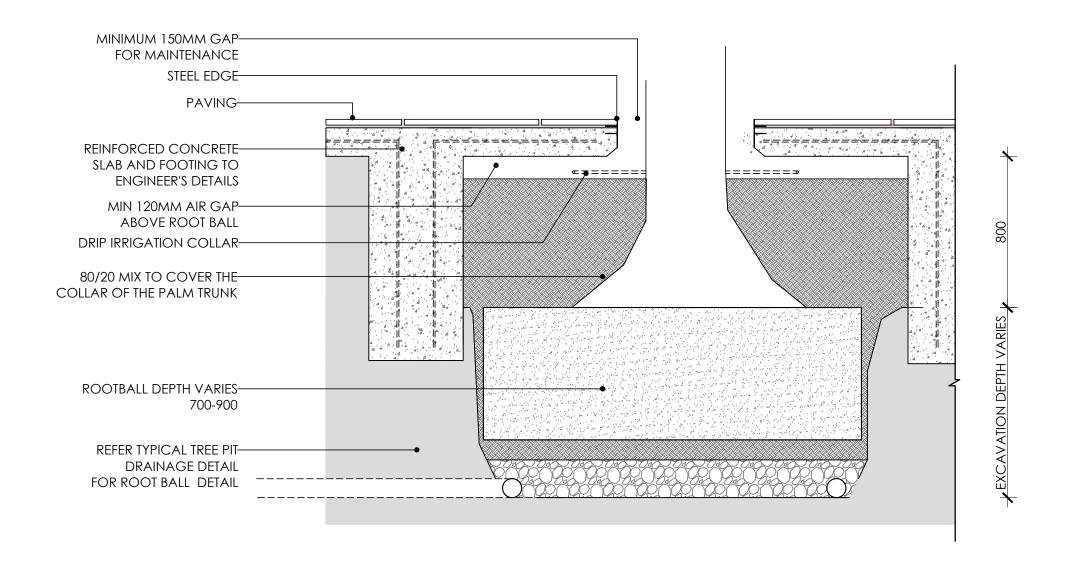


TYPICAL TREE IN PAVING
SCALE 1:20 @ A1

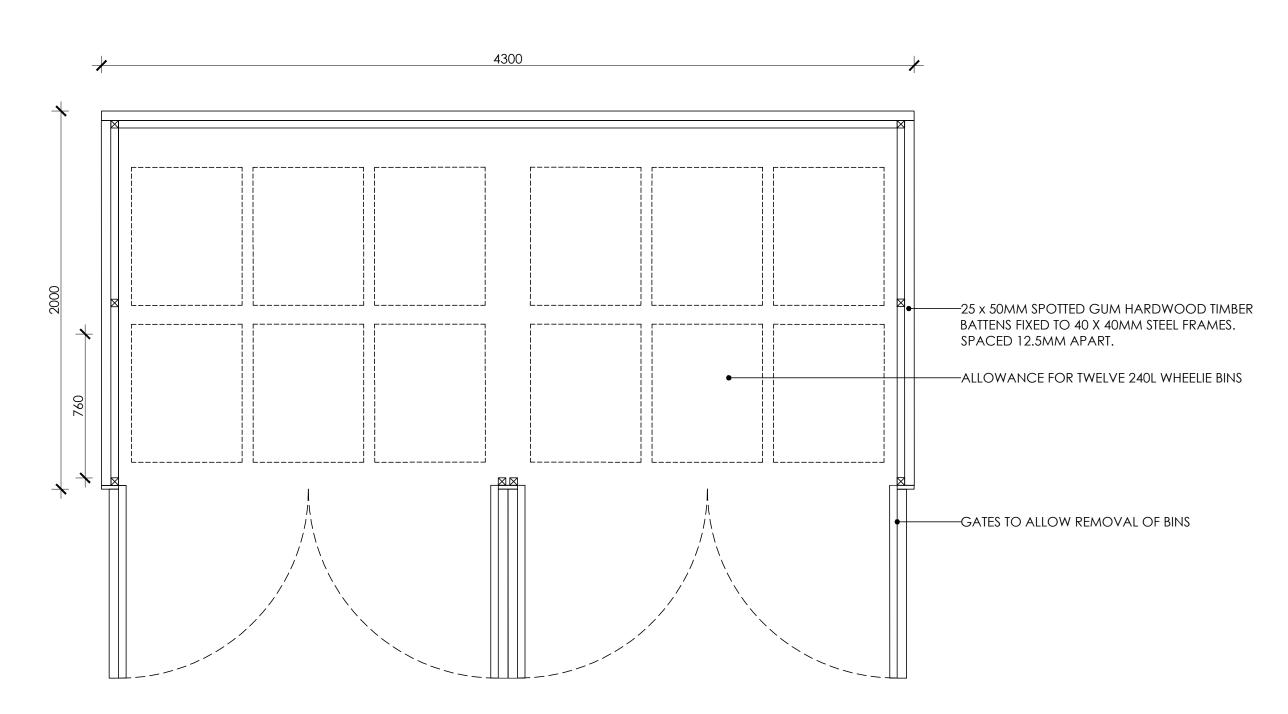

WHEELIE BIN SHELTER - INTERIOR PLAN SCALE 1:20 @ A1

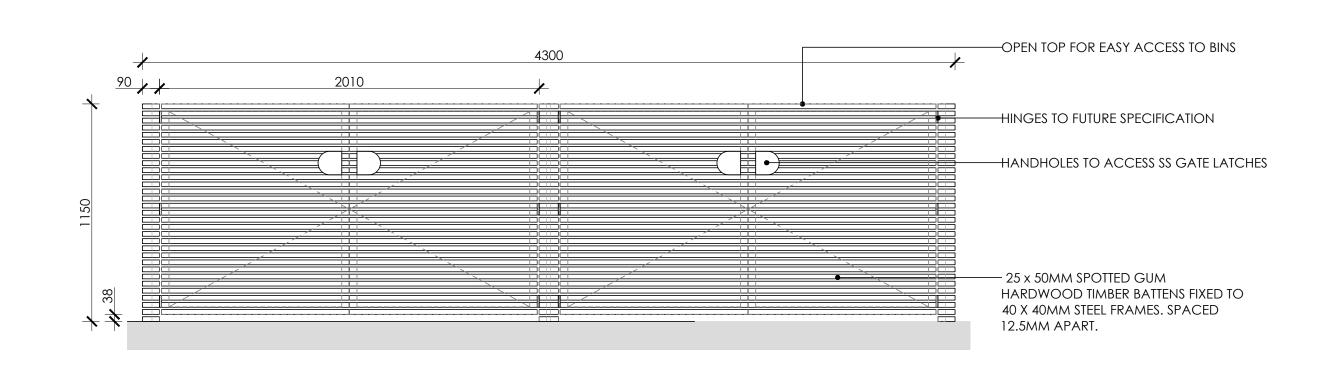

WHEELIE BIN SHELTER - FRONT ELEVATION SCALE 1:20 @ A1

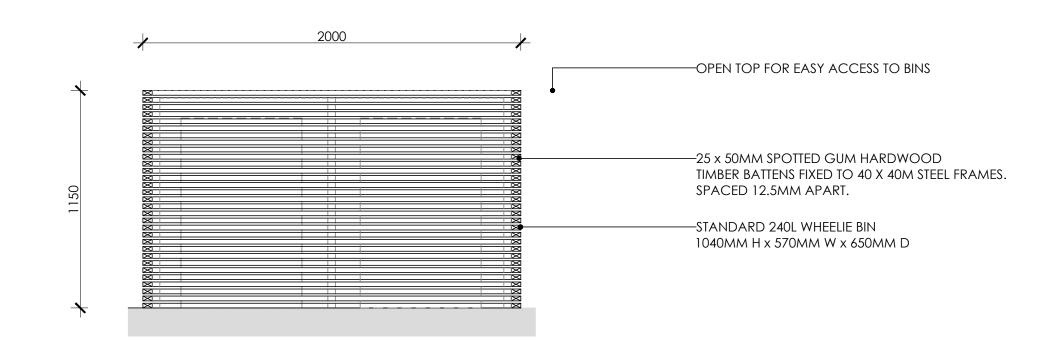

WHEELIE BIN SHELTER - SIDE ELEVATION SCALE 1:20 @ A1

DRAWING:

Annexure 5: Revised Civil Earthworks Plan

