Elizabeth Taylor Town Planner 23 Vallely Street FRESHWATER QLD 4870

**DSC Ref:** CA 1685/2016 **My Ref:** ET15-027

07 December, 2016

Chief Executive Officer Douglas Shire Council PO Box 723 MOSSMAN QLD 4873

Attention: Mr Simon Clarke

Dear Madam,

# RESPONSE TO COUNCIL INFORMATION REQUEST IN RELATION TO THE REEF MARINA REDEVELOPMENT – COMBINED APPLICATION

The following response is provided to Council's Information Request (IR) issued by correspondence dated 30 November, 2016.

For ease of reference each item is reproduced below, followed by a response.

# COMPLIANCE WITH PRELIMINARY APPROVAL DATED 18 MAY 2016:

1. On 18 May 2016, Council issued a preliminary approval under Section 241 of the Sustainable Planning Act 2009 for Staging Self-Assessable Development and Code Assessable Development in accordance with a Precinct Plan, a Staging Plan and other Supporting Plans, subject to conditions, over this land and other land at this location.

Please address the Combined Applications' compliance with the approved plans and conditions that attach to the preliminary approval.

#### **Response**

The Combined Application seeks approval for development which complies with the list of approved land uses by Precinct and stage, listed in the Preliminary Approval (PA) as follows:

 Precinct 1- Stages 1a and 1b - Holiday Accommodation/Multi-unit Housing (and including public waterfront access and part of the arbour park/rainforest walk);

- Precinct 2 Stages 2a, 2b and 2c Holiday Accommodation/Multi-unit Housing, Restaurants, Shopping and Business Facilities, possible Tavern, Marina (Duck Pond) (and short/medium term retention of existing lawful uses, being the Slipway and allied Marine Industries and including public waterfront access, the public plaza, and balance of the arbour park/rainforest walk and upgraded marine facilities in the Duck Pond and along the Dickson Inlet frontage);
- Precinct 3 Stage 3a- Holiday Accommodation/Multi-Unit Housing (and integration with the adjacent arbour park/rainforest walk and retention and upgrading of the existing public car park);
- Precinct 4 retained/upgraded for existing commercial purposes and including The Green;
- Precinct 5 retained/upgraded for existing service purpose.

All proposed land uses listed above in each Precinct/Stage are land uses approved and listed in the PA.

The proposed form of development complies with all Conditions of approval in the PA dated 18 May, 2016:

CONDITION	COMMENT
1: Compliance with Precinct Plan	Complies
V1.11- dated February 2016 and	
Precinct Table	
2: Compliance with Staging Plan	Complies
V1.11 dated 11 February, 2016	
3: Compliance with Access Plans-	Complies
Vehicular and Pedestrian V1.11 dated	
11 February, 2016	
4: Compliance with Design controls in	Generally Complies
Planning Scheme	
5: Submit to Council an Urban Design	Yes
Theme Report	
6: Provide linkages between	Yes
redeveloped stages and longer term	
stages and upgrade longer term stage	
7:Maintain sight-line through public	Complies
plaza across the Duck Pond to	
Dickson Inlet.	
8: Retain Bally Hooley	Yes

# **IDAS FORM DETAILS:**

2. IDAS Form 7. 06. Table A indicates that the Boardwalk and The Rainforest are to be contributed for community purposes. Please clarify the intent of this statement and indicate the physical extent of this contribution in plan form.

# **Response**

The Boardwalk, the Rainforest Walk and the Public Plaza are public spaces that will be maintained at no cost to Council and integrated throughout the site through a Body Corporate arrangement.

These public space elements will not be "handed over' to Council as public land, but will be protected in perpetuity as public open space by Access Easements. The public benefit of this is that the maintenance of these spaces is not the responsibility of the public purse/rate payers.

A Plan showing the general extent of these public open space elements is attached at Appendix 1.

The Plan shows the integration of both the public and private landscape/recreation spaces throughout the site, which collectively creates a dominant, lush and verdant tropical landscape setting for the surrounding building elements; in line with one of the primary objectives of TRM Master Plan and Council's various planning documents.

The principles outlined in *The Luxuriant City: Key Principles for Landscape Responsive Medium-Rise Residential Design in the Subtropics* (Loneragan, Subtropical Cities Conference 2011) referred to below in Item 9 of this correspondence, informed the landscape/public space design process.

# MODIFICATIONS TO THE EXISTING COMMERCIAL BUILDING:

3. The application involves the demolition of a significant portion of existing commercial floor space at the Marina. Please provide elevations and floor plan details of the proposed modifications to the existing commercial building associated with this demolition.

# **Response**

The western wing of the existing Shopping Centre will be demolished up to the south west entry point and a new entry created linking with the Rainforest Walk, as indicated on drawings DA-IR-103, DA-IR-104 and DA-IR105- SHOPPING CENTRE MODIFICATIONS, refer Appendix 2.

It is intended to reuse the existing steel mall columns and arches as a trellis structure for the Rainforest Walk with the addition of batten screens and the retention of some roofing sections to provide shade.

An Artist's impression showing the arched trellised Rainforest Walk, is also attached at Appendix 2.

# LOT RECONFIGURATION PLAN:

4. Please provide a Lot Reconfiguration Plan that clearly identifies individual lots and proposed easements. Preliminary Approval has not been addressed with respect to the provision of general public access easements (or similar) across the site to provide public waterfront access. Furthermore, please supply the revised Lot Reconfiguration Plan distinctly overlain on top of the overall Master Plan for clarity.

# <u>Response</u>

The Lot Reconfiguration Plan, drawing DA-S-108 Revision 3 and Reconfiguration Plan/Master Plan Overlay, drawing DA-IR-109, Revision 3 are attached at Appendix 3.

# LOT 103:

5. Clarify the transition between public and private domain adjacent to the Plaza, particularly adjacent to the Duck Pond.

# <u>Response</u>

A chain mesh fence will be built behind the commercial plaza containers and the vehicle access way to the commercial pontoon and slipway, to ensure separation of industrial areas from the public. The fence will be hung with printed screen banners to provide visual interest, shield the industrial uses from public view and create a backdrop for the commercial containers.

The fence at the western end of the plaza will pivot so that the fence can be moved to allow public access to the pontoon for fresh seafood sales or positioned to maintain public/commercial separation when required for pontoon/slipway operations (for example, when masts are removed from vessels for re-rigging, etc.).



http://www.color-x.com/large-format-printing/construction-barricades/

6. Amended detailing is to be provided, nominally by Landscape Architect, to address how the temporary plaza may look as an urban space (i.e. provide similar images to those provided previously for 'The Green').

# <u>Response</u>

It is no longer proposed to construct a "temporary" Public Plaza and then a final Public Plaza in association with the redevelopment of Stage 2b, down the track. The Public Plaza will be constructed in association with Stage 2a.

A Perspective showing how the Public Plaza may look as an urban space, is attached at Appendix 4.

# LAND TENURE FOR WATER-BASED ELEMENTS:

7. Clarify the proposed future tenure of the 'over-water structures' that appear to be outside proposed Lot 1; including the floating pontoon structure, boardwalk and the over- water dining covered area.

In your response, it is important that you address responsibilities assigned for the on-going future maintenance of these facilities.

# **Response**

The over-water structures, specifically the floating pontoon structures, Boardwalk and the over- water dining area will be within the area of the new marine lease to be issued by DNRM contemporaneously with the freeholding. As such, these structures will be owned and maintained by The Reef Marina Pty Ltd.

# ACCESS TO THE FLOATING PONTOON WALKWAY/SAFETY:

8. Will access to the floating pontoon be restricted? What safety measures will be installed to ensure safety of users given the presence of crocodiles in the Inlet?

#### **Response**

The Floating Pontoon Walkway is private infrastructure and will include controlled gate access. When the Cruise Ship Transfer component is in use, unrestricted public access will be available to the designated areas. The gates will be locked at night. A User Management Plan will be developed and provided to all vessels using the Dickson Inlet pontoon, outlining procedures to minimize conflict between marine users and wildlife. This will include protocols to follow when crocodiles are sighted; pontoon use at night; visual inspections prior to general openings in the morning. The Department of Environment and Heritage Protection (DEHP) provides useful general advice for marine activities at boat ramps where crocodiles have been sighted and this advice will be reviewed and developed, as appropriate, for the Dickson Inlet pontoon.

# REPORTS: APPENDIX 3: URBAN DESIGN GUIDE & PERSPECTIVES – STUDIO TEKTON PTY LTD:

9. Page 7 of the Urban Design Guide & Perspectives report states:

The "informal relaxed character and charm are still evident in parts of Macrossan Street and is uniquely Port Douglas. Recent commercial developments lack consideration of the Port Douglas character and could be located/found anywhere."

and further :

"Recent Master Plans refer to a "Character defined by its tropical latitude, waterfront location, and mix of tourism and marine activity."

and:

"Green elements should be a defining element."

and:

"Green infrastructure as a foil to the urban fabric to the town centre."

These statements are acknowledged and reinforced in the report. However, the examples of other guiding waterfront developments, both being from South Western Australia, are neither tropical locations, nor are they defined by a character where "green" infrastructure dominates over built form.

Therefore, it is not clear how the architecture and urban design elements of the proposed development responds to this critical issue. Please, specifically clarify in what way the proposed built form responds to this issue, and is not a development that *'could be located/found anywhere'*.

# **Response**

The two waterfront developments used in the Urban Design report were selected as examples familiar to a number of Councillors. Fremantle was seen as a better example than the intensely development Mandurah example.

The review allowed an analysis of the development parameters to understand the Planning Controls leading to each outcome. The analysis showed that a plot ratio of 2:1, site cover of 85% and limited setbacks leads to an intensely building dominated development outcome as demonstrated by the Mandurah Ocean Marina. The Fremantle example allowed space for large Norfolk Island pine trees which helps significantly to connect with the character of older Fremantle while still achieving a plot ratio of 1:1 and a 75% site cover.

The Reef Marina proposal has a plot ratio below 1:1 and more significantly, a site cover 48% or less which means that there is significantly more site area available to accommodate "green infrastructure," allowing buildings to recede and the Port Douglas character to permeate this waterfront development, in contrast with most other waterfront developments where buildings dominate. In addition, there are no extensive basement parking areas, maximising the landscape area available for deep planting and significant trees.

The principles outlined in *The Luxuriant City: Key Principles for Landscape Responsive Medium-Rise Residential Design in the Subtropics* (Loneragan, Subtropical Cities Conference 2011) are equally valid for Port Douglas. This paper included the following findings:

- Allow space for the landscape. Significant vegetation and luxuriant trees require significant area. This can be accommodated within the site (including within the front setback) or appropriating the adjoining public domain (either streets or parks) where there are mutually beneficial outcomes.
- Carefully consider basement design at the building/public space interface to achieve connectivity rather than creating barriers. Partially raised basements are particularly problematic.
- Minimal building setbacks do not necessarily result in poor landscape opportunities at ground level. The public domain becomes critical in achieving high quality landscape which can be enhanced by visual permeability (rather than visual barriers to achieve dwelling privacy) and strategies to reduce building verticality.

- Using building setback areas for significant planting. This can make a positive contribution to public space without compromising issues associated with security or resorting to solid walls along the property lines.
- Incorporating the public domain as part of the overall design rather than residual space outside project parameters. This suggests that it is necessary to rethink the nature of the street and consider it as an integrated landscape element rather than purely an access and service corridor.

These principles were used to inform the design approach to the Reef Marina, particularly ensuring that building car parking is limited in extent and there is plenty of external area available for deep landscape planting with no basement or semibasement parking. This contrasts with many recent developments in Cairns and elsewhere where site area is taken up with vehicular circulation or basement and semi-basement parking leaving little area on the site for significant planting to help reinforce the sense of place. This approach will ensure that the Port Douglas character as exemplified in Macrossan Street will be continued within The Reef Marina redevelopment as a key design response.

10 The Images appended to the report are not consistent with statements that reflect the 'green' tropical character of Port Douglas. They also appear to conflict with the landscaping proposals contained within the Landscape Concept Report. Please reconsider the use of these images or alternatively provide images that integrate the ideas promoted in the Landscape Concept report with the architectural images.

# <u>Response</u>

The images appended to the Urban Design report were intended to convey how the built -form responds to the Port Douglas tradition and were to be read in conjunction with the Scott Carver Landscape Approach with the landscaping simplified to help convey the architectural intent. Images- DA -IR –112, DA -IR – 113, DA -IR –114 and DA -IR –116, conveying both the architectural intent and landscape response have been produced and are included in Appendix 5.

The development approach is a direct response to the generally smaller incremental Port Douglas tradition with:

- The development is broken down into a series of smaller discrete elements with different programs (townhouses, apartment building, short term accommodation, mixed use).
- Buildings use a variety of roof profiles, including gables and hips to provide visual interest.
- Buildings are stepped and angled to provide a series of different relationships to the public realm adding to the visual experience and avoiding a single building plane.

# REPORTS: APPENDIX 12: LANDSCAPE CONCEPT REPORT REV 1-SCOTT CARVER PTY LTD:

11. The Staging shown on Drawing Ref 20160045 is confusing and needs

clarification. For example:

• Is it proposed to combine Stage 1A, 1B and 2A into a single development stage?

# Response

Stage 1 Site Plan including walkable waterfront will be staged as shown and completed with Stage 2A

• The walkable waterfront is to be delivered in which nominated stage?

# **Response**

The walkable waterfront will be staged. Refer to drawing DA-IR-101 SITE PLAN STAGE 1 at Appendix 6, to see the extent and connections of the first stage of the Boardwalk.

 In which stage will Coral Close be constructed as a complete piece of infrastructure? Currently, it is shown to be partially completed in Stage 2A, with the balance completed in Stage 2B.

# <u>Response</u>

Coral Close will be constructed as part of 2A.

• How will future interim stages be left in an interim state pending future development?

# <u>Response</u>

Any vacant areas relating to future stages will be landscaped as required in the Preliminary Approval to provide "attractive interim spaces that provide logical connections across precinct boundaries until such time that future stages are developed."

 'The Green' is proposed as part of which stage (Note – The preliminary approval issued for the land provides no clarity with respect to the staging of 'The Green')?

# <u>Response</u>

The Green largely exists already and will be improved independently of the development stages.

 'The Green' has preliminary approval for a range of varying uses associated with Precinct 4: noting that 'Park & Open Space' is exempt development. As per item 3 herein, please clarify the intent of 'The Green' in terms of the preliminary approved set of land uses and the statements made on the IDAS forms in terms of 'The Green' being 'contributed for community purposes'.

# **Response**

The Green will remain part of the marina and will not be contributed for community purposes. The Green will act as an informal open space, which may be used as a venue for outdoor recreational activities, such as buskers, street performers, local community group activities etc. Any future long term plans for The Green have yet to be determined.

12. From a landscape planting perspective, please comment on the likely success of the proposed planting species (e.g. for the Rainforest Walk) in terms of the soil conditions likely to be found on site (i.e. planting in compacted, marine fill, possibly subject to acid sulphate materials).

# **Response**

Scott Carver acknowledges the intent of the DSC Policy No.7 (August 2006) – Minimum Design Requirements for Development and the section relating to landscape soil conditions.

The depth of potential acid sulfate soil ground conditions has not been qualified and is often variable subject to the underlying ground profile and fill overlay. Once this is fully understood a specific site design response can be formulated. In general, the planting depth of advanced tree / palm materials will be @1.0m allowing for 200L containerised stock 500diam x 550mm deep container. The nominal 1.0m planting depth allows for a separation drainage layer to be installed between existing ground conditions and new profile levels.

The recommended planting approach is to use a 50:50 soil mix of organic imported and site soil to avoid soil stratification. This method allows for soil to be tested and soil additives to be included to achieve a compliant Australian Standard mix appropriate to a tropic environment. Irrigation and water management are equally important to management of the soil profile and chemical exchange.

The final species selection and management regime will be further confirmed once the ground conditions are fully investigated.

13. What exactly is the 'Rainforest Walk' as the key linking feature through the site? Does it include an arbour or other structural elements that promote the sense of linkage? Please, clarify further and/or provide details.

#### <u>Response</u>

The existing west wing mall column and arch structure will be retained where possible including sections of roof and the addition of battens to create a trellis frame for vines and plantings.

An Artist's impression showing the arched trellised Rainforest Walk, is attached at Appendix 2.

# PLANS: STAGE 1A:

14. Provide details of fencing.

#### <u>Response</u>

Fencing extent added to Plan DA-1A-102 Revision 0, refer Appendix 7. Fencing will be 1200 high to waterfront and 1800 high to east, powder coated tubular aluminium fencing. The fencing will be largely hidden by planting.

15. Air conditioning units often detract significantly from the external appearance of buildings in Far North Queensland. Provide details of the location and appearance of any external air conditioning units (if proposed).

# **Response**

Air conditioning equipment will be placed on the roof decks, as indicated on drawing DA-1A-105 Revision 02 (previously provided) and screened from public view.

16. Provide a specific colour pallet for the proposed buildings (a range of colours are noted in the Studio Tekton Report).

#### **Response**

Refer Appendix 8 for Colour palette.

# PLANS: STAGE 1B:

17. Provide details of fencing.

#### **Response**

Fencing extent added to Plan DA-1B-101 Revision 03, refer Appendix 9. Fencing will be 1200 high to waterfront and 1800 high to east powder coated tubular aluminium fencing.

18. Air conditioning units often detract significantly from the external appearance of buildings in Far North Queensland. Provide details of the location and appearance of any external air conditioning units (if proposed).

#### <u>Response</u>

All air conditioning equipment will be screened from public view.

19. Provide a specific colour pallet for the proposed buildings (a range of colours are noted in the Studio Tekton Report).

# **Response**

Refer Appendix 8 for Colour palette.

#### PLANS: STAGE 2A:

20. Identify the servicing delivery arrangements for the commercial component.

#### <u>Response</u>

A loading/unloading bay has been located on Coral Close to service the commercial area. Refer to PDR letter dated 30 November 2016 and attached Sweep Paths, attached at Appendix 10.

21. Confirm that the proposed gym is for the exclusive use of residents/short-term residents of the Reef Marina, and not for the use of the general public.

#### **Response**

The gym is for exclusive use of residents/guests of the Marina and The Marina Residences only.

22. Air conditioning units often detract significantly from the external appearance of buildings in Far North Queensland. Provide details of the location and appearance of any external air conditioning units (if proposed).

#### **Response**

All air conditioning equipment will be screened from public view.

23. Provide a specific colour pallet for the proposed buildings (a range of colours are noted in the Studio Tekton Report).

#### <u>Response</u>

Refer Appendix 8 for Colour palette.

# DETAILED PLANS: STAGE 2A (PART 1):

24. Ascending steps appear to commence within car parking space 14 providing access to the internal breeze-way corridor in Level 1. Please amend or clarify this detail.

#### <u>Response</u>

There are no stairs commencing in the car park – revised drawing DA-2A-102 revision 3, amended to provide clarity, refer Appendix 11.

25. Ascending steps appear to provide access directly from the lobby to

inside Unit 19. Please clarify or amend this detail.

#### **Response**

The stairs are restricted access and allow direct access/communication for the Manager from Unit 19 (managers unit) to the Reception. This is not a publicly accessible stair.

26. Clarify the solid lines on Level 1 in the breezeway corridor. Are these walls to screen living areas adjacent to the common corridor, or screens or void spaces to the car parking below?

# <u>Response</u>

These lines are screens to separate the patio from the common area and are not voids to the car park below - revised drawing DA-2A-104 Revision 3, amended to provide clarity, refer Appendix 11.

# DETAILED PLANS: STAGE 2A (PART 2):

27. Ascending steps appear to commence within car parking space 11 providing access to the internal breeze-way corridor in Level 1. Please amend or clarify this detail.

# <u>Response</u>

There are no stairs commencing in the car park – revised drawing DA-2A-103 Revision 3, amended to provide clarity, refer Appendix 11.

28. Clarify the solid lines on Level 1 in the breezeway corridor. Are these walls to screen living areas adjacent to the common corridor, or screens or void spaces to the car parking below?

#### **Response**

These lines are screens to separate the courtyard from the common area and are not voids to the car park below - revised drawing DA-2A-105 Revision 3, amended to provide clarity, refer Appendix 11.

#### PLANS: STAGE 2C:

29. Identify the Goods Receiving Area (REC) and the service delivery arrangements for the Commercial component.

#### **Response**

A loading/unloading bay has been located on Coral Close to service the Stage 2C commercial area. Refer to PDR letter dated 30 November 2016 and attached Sweep Paths attached at Appendix 10.

30. Provide details of any fencing (if proposed).

# **Response**

No additional fencing proposed.

31. Air conditioning units often detract significantly from the external appearance of buildings in Far North Queensland. Provide details of the location and appearance of any external air conditioning units (if proposed).

# **Response**

All air conditioning equipment will be screened from public view.

32. Provide a specific colour pallet for the proposed buildings (a range of colours are noted in the Studio Tekton Report).

# **Response**

Refer Appendix 8 for Colour palette.

# PLANS: STAGE 3A:

33. Amend the Stage 3A Site Plan and Stage 3 Plans to reflect driveway access to Unit 1's garage.

# **Response**

Drawing DA – 3A – 102 Revision 03 amended and attached at Appendix 12.

34. Provide details of any fencing (if proposed).

#### **Response**

Fencing extent added to DA-3A-101 Revision 03, refer Appendix 12. Fencing will be 1800 high to east powder coated tubular aluminium fencing.

35. Air conditioning units often detract significantly from the external appearance of buildings in Far North Queensland. Provide details of the location and appearance of any external air conditioning units (if proposed).

#### **Response**

All air conditioning equipment will be screened from public view.

36. Provide a specific colour pallet for the proposed buildings (a range of colours are noted in the Studio Tekton Report).

# **Response**

Refer Appendix 8 for Colour palette.

#### **GENERAL ITEMS:**

37. The location of the Central Refuse Area and Transformer at the entrance to proposed Coral Close needs review. It is noted that it is shown partially on plans that accompany Stage 2C as part of an entry statement. Either provide more detail on how the Central Refuse Area and Transformer are integrated into the entry statement so as to be unobtrusive or select a more discrete location within the site for these facilities that can be appropriately disguised/hidden from view.

# <u>Response</u>

Refer to drawing DA-IR-106 MARINA ENTRY STRUCTURE at Appendix 13, for details.

The colour scheme for the entry structure will be:

Roof:	Colorbond Surfmist.
Walls:	Reef Marina White.
Window/door/Louvers:	Duratec Zeus White.
Screen Enclosure:	Duratec Eternity Charcoal Pearl or Paint to
match.	

38. Provide details of the maintenance shed close to the units in Stage 3A.

#### **Response**

Refer to drawing DA-IR-107 MAINTENANCE SHED at Appendix 14, for details.

The colour scheme for the building will be:

Roof:Colorbond Surfmist.Walls:Reef Marina White.Window/door/Louvers:Duratec Zeus White.

39. Provide details of the proposed over- water dining covered area adjacent to Stage 2A.

#### <u>Response</u>

Refer to drawing DA-IR-108 OVER- WATER PAVILION at Appendix 15, for details.

The colour scheme for the structure will be:

Roof:	Colorbond Basalt (under "living' green roof).
Roof:	Danpalon polycarbonate roof system –

Bronze. "Living" Green Roof: metal roof. Structure:

Elmich metal roof to "living" green roof on

**Dulux Vivid White** 


This concludes TRM's response to the DSC IR. My client looks forward to Council's favourable consideration of the Combined Application in due course.

Yours faithfully,


Kaylor.

Elizabeth Taylor Town Planner



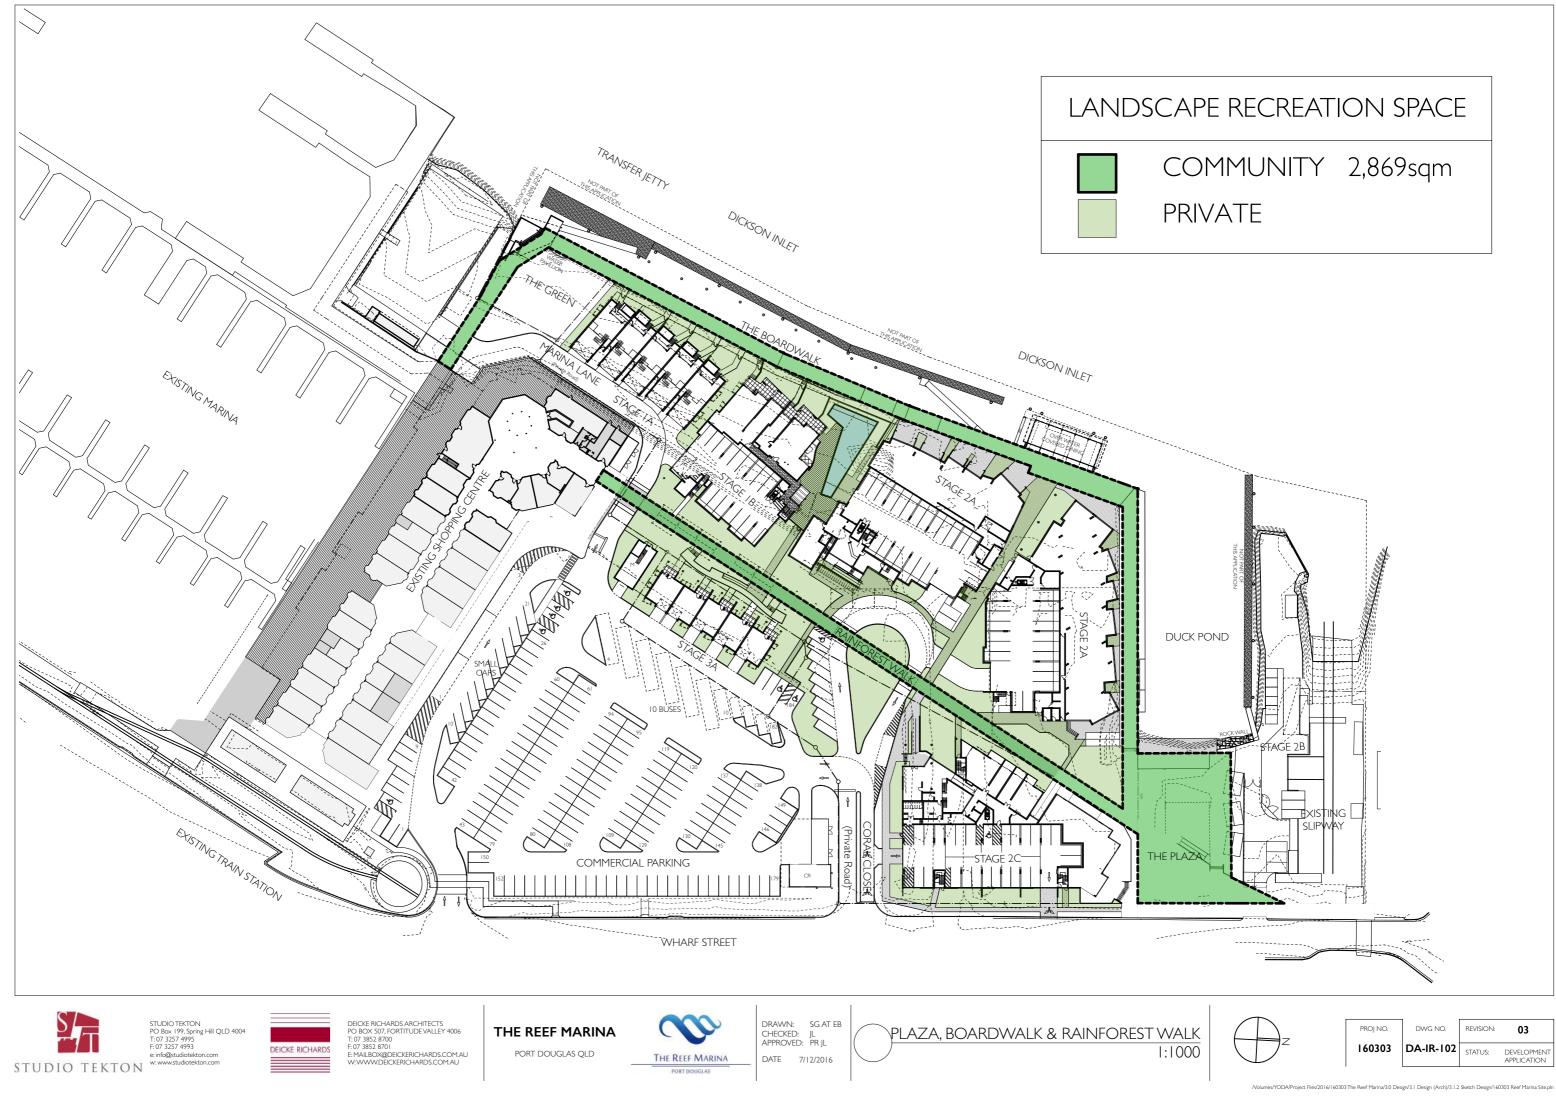



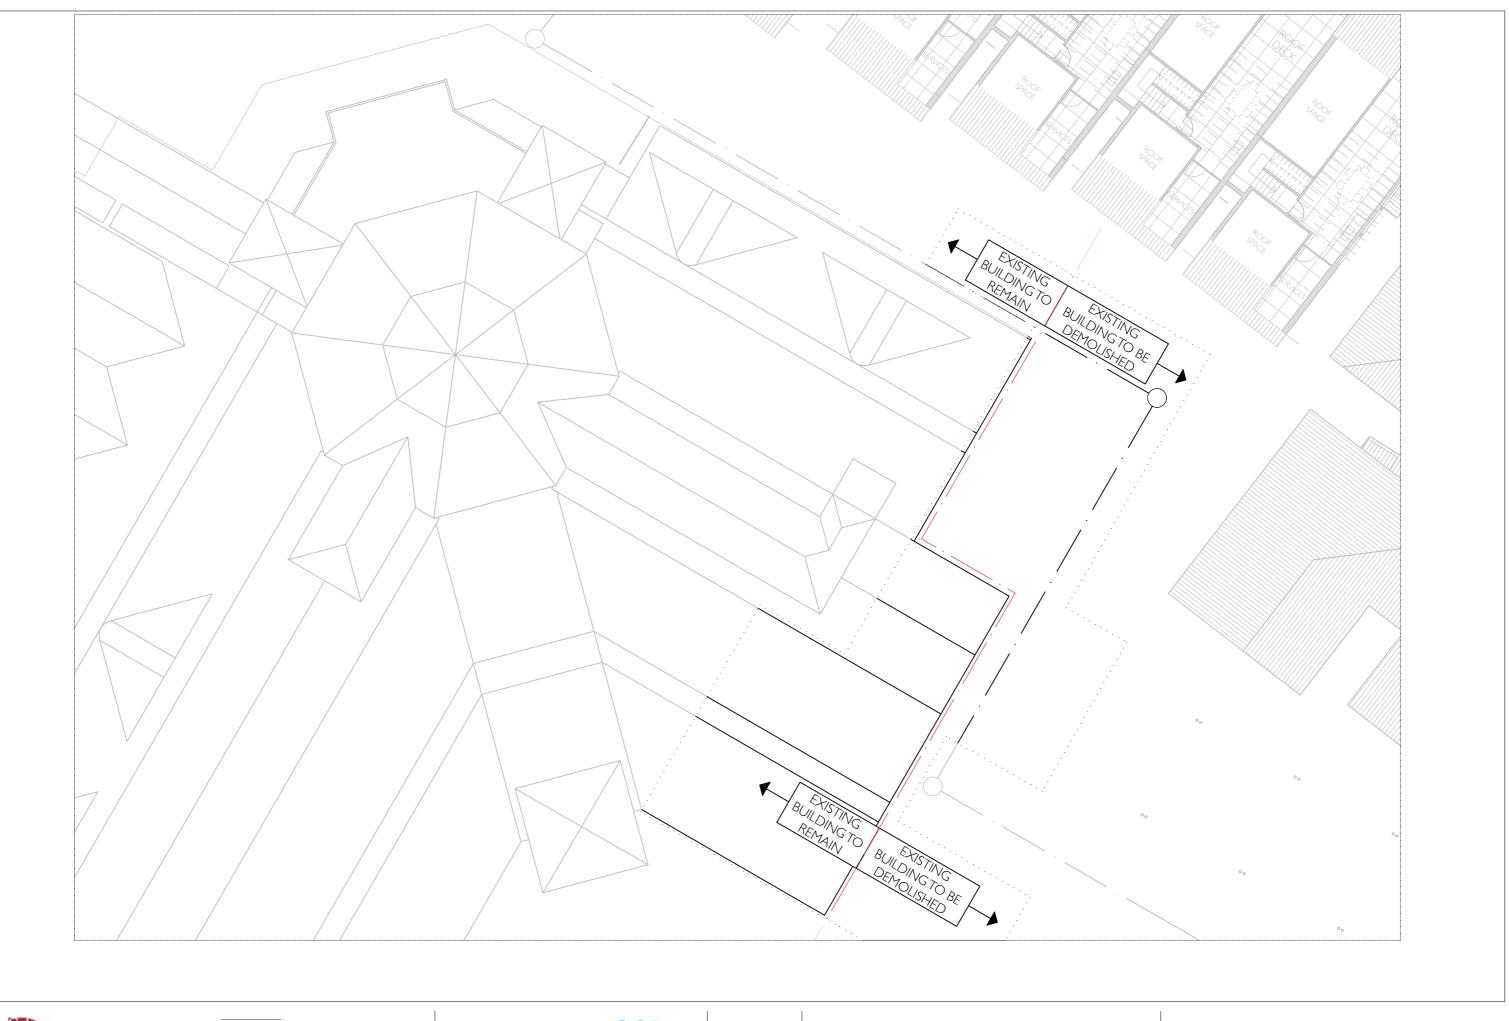





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DRAWN: EB CHECKED: JL APPROVED: PR JL DATE 30/11/2016

SHOPPING CENTRE MODIFICATIONS

1:200

/Volumes/YODA/Project Files/2016/160303 The Reef Marina/3.0 Design/3.1 Design (Arch)/3.1.2 Sketch Design/160303 Reef Marina Site.plr


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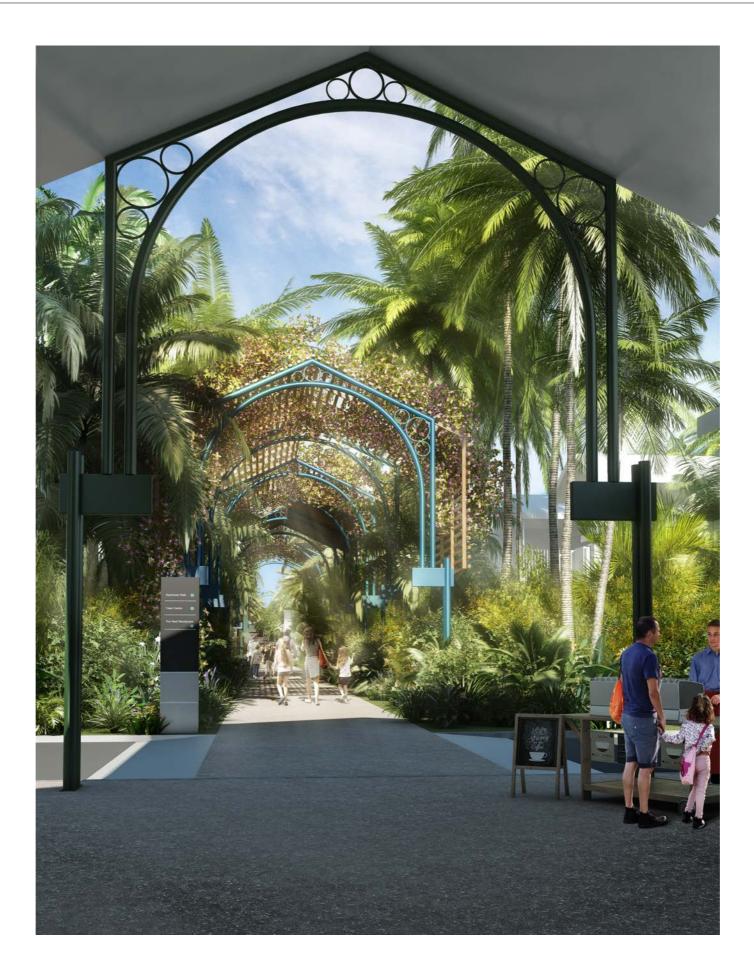
160303

DWG NO. REVISION:

DA-IR-104 STATUS: DEVELOPMENT APPLICATION

03



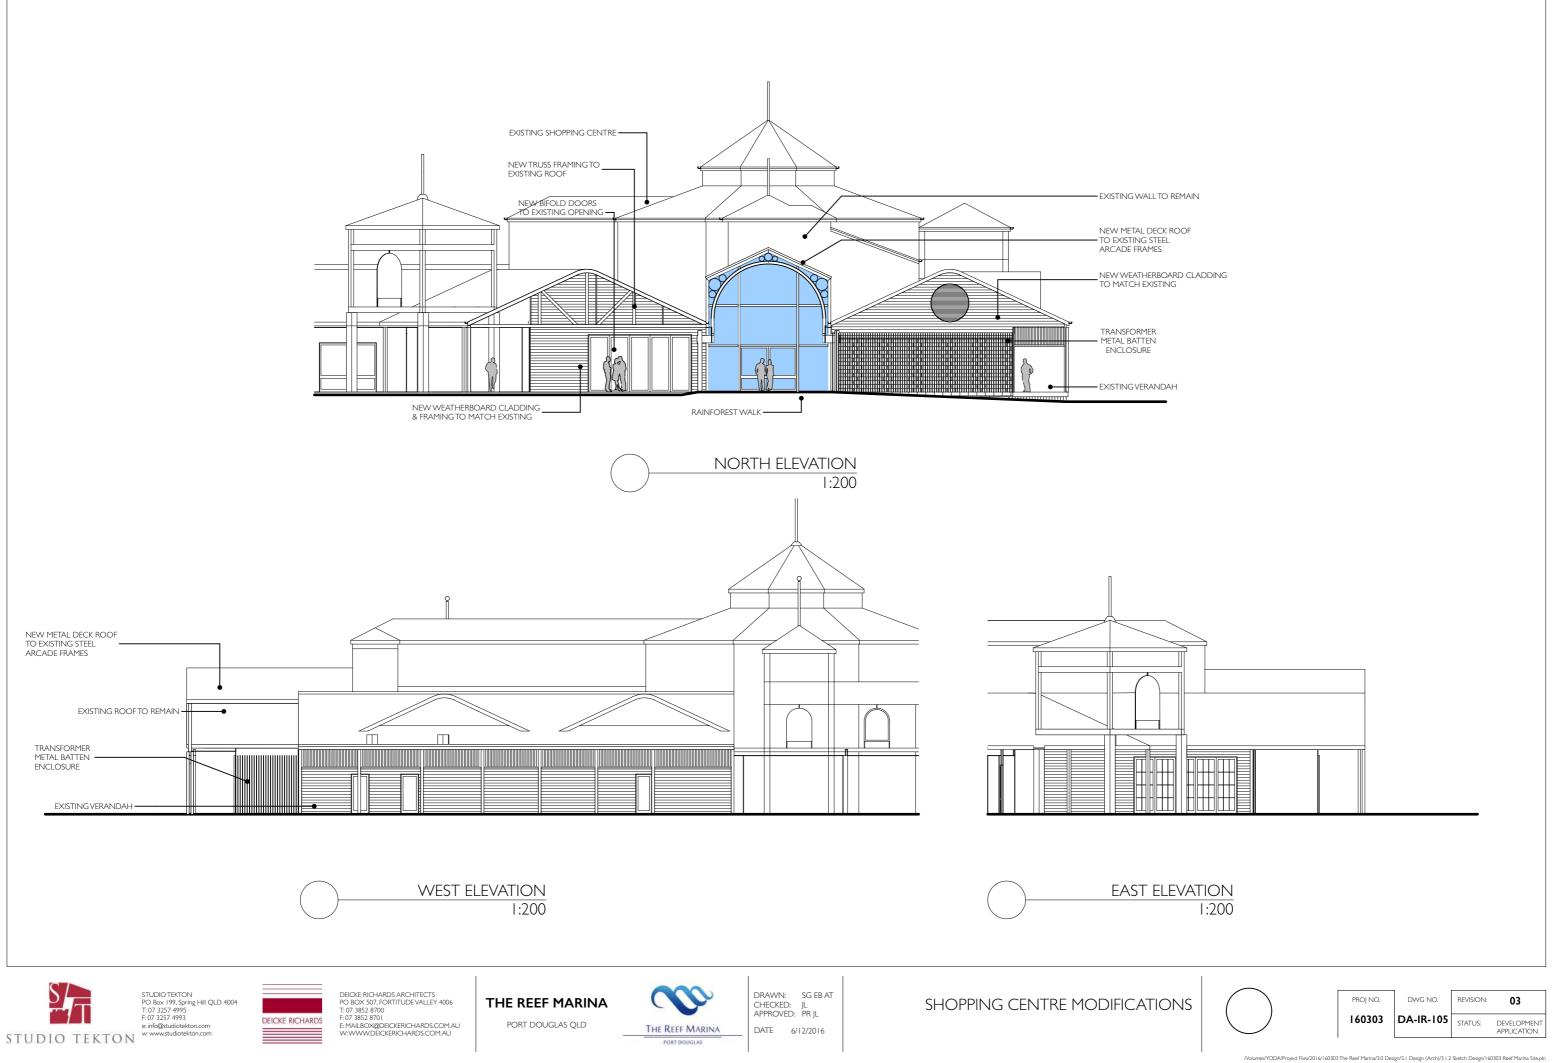





DEICKE RICHARDS ARCHITECTS PO BOX 507, FORTITUDE VALLEY 4006 T: 07 3852 8700 E: MALBOX@DEICKERICHARDS.COMAU W:WWWDEICKERICHARDS.COMAU THE REEF MARINA PORT DOUGLAS QLD



DRAWN: **OTC** CHECKED: JL APPROVED: PR JL DATE 30/11/2016

SITE PERSPECTIVE - RAINFOREST







DEICKE RICHARDS ARCHITECTS PO BOX 507, FORTITUDE VALLEY 4006 T: 07 3852 8700 F: 07 3852 8701 E: MALEDX@DEICKERICHARDS.COMAU W:WWW.DEICKERICHARDS.COMAU THE REEF MARINA PORT DOUGLAS QLD



DRAWN: EB CHECKED: JL APPROVED: PR JL DATE 30/11/2016

SHOPPING CENTRE MODIFICATIONS

1:200



PROJ NO.

160303

roject Files/2016/160303 The Reef Marina/3.0 Design/3.1 Design (Arch)/3.1.2 Sketch Design/160303 Reef Marina Site.p


DWG NO.

REVISION:

DA-IR-103 STATUS: DEVELOPMENT APPLICATION

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e: info@studiotekton.com w: www.studiotekton.com STUDIO TEKTON

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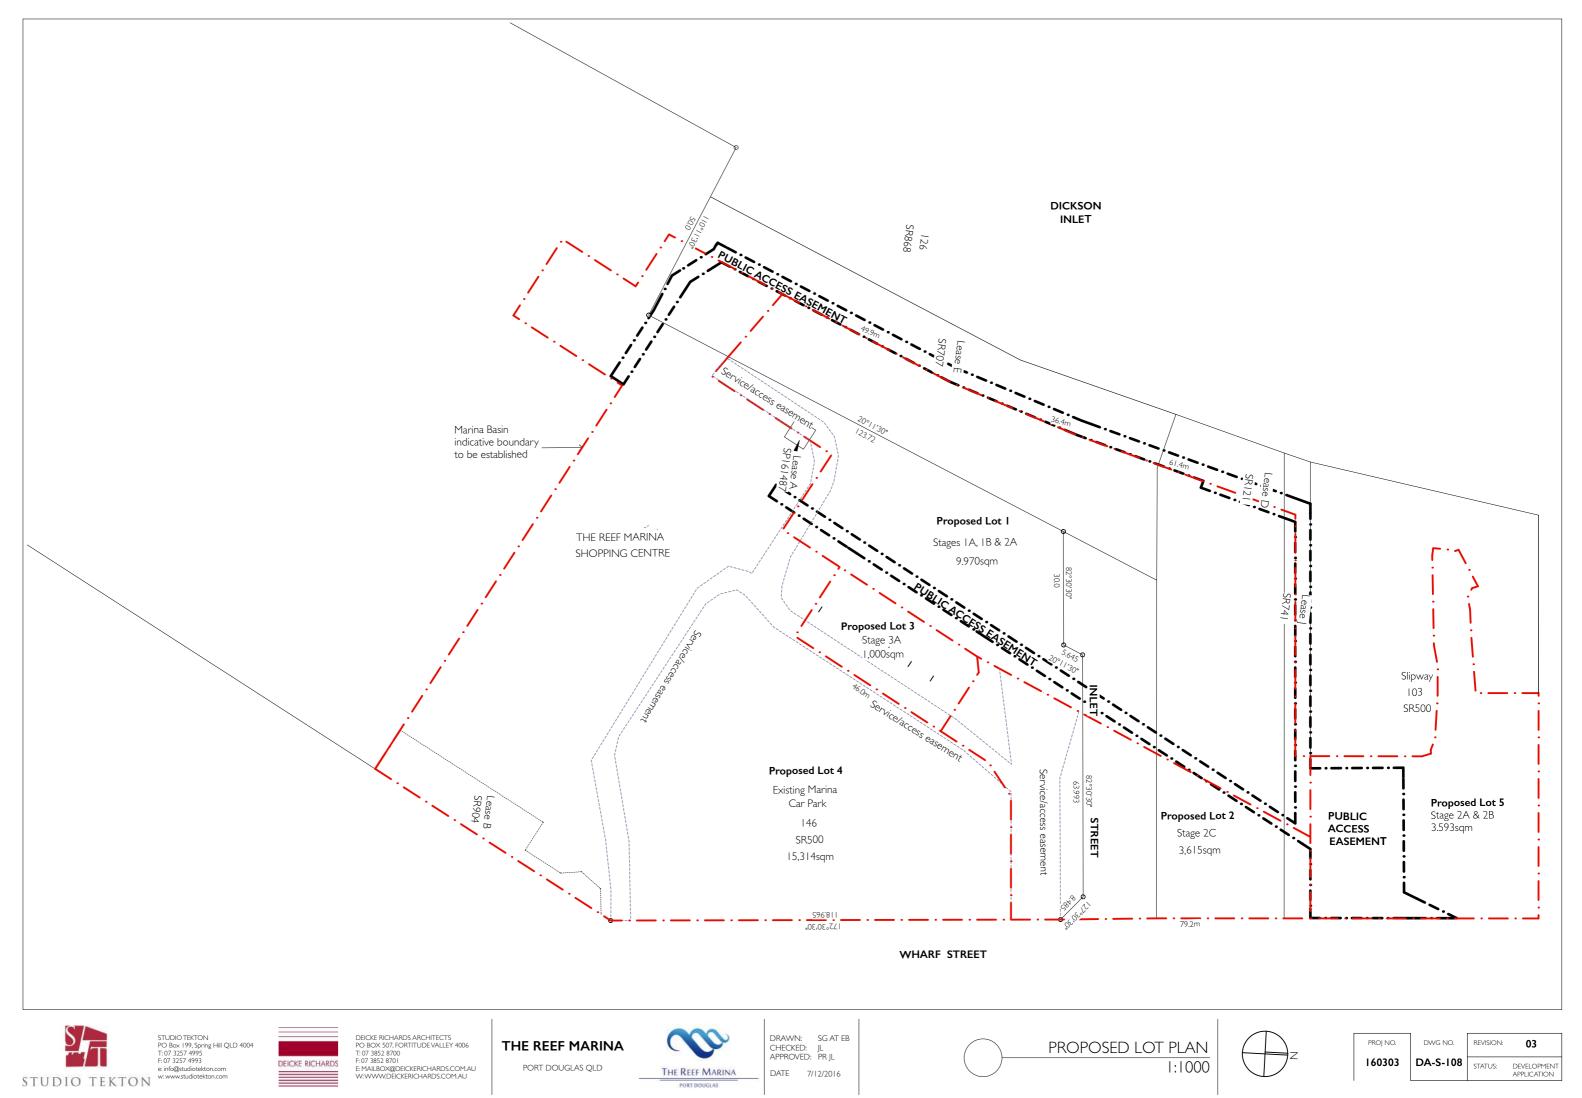
PORT DOUGLAS QLD

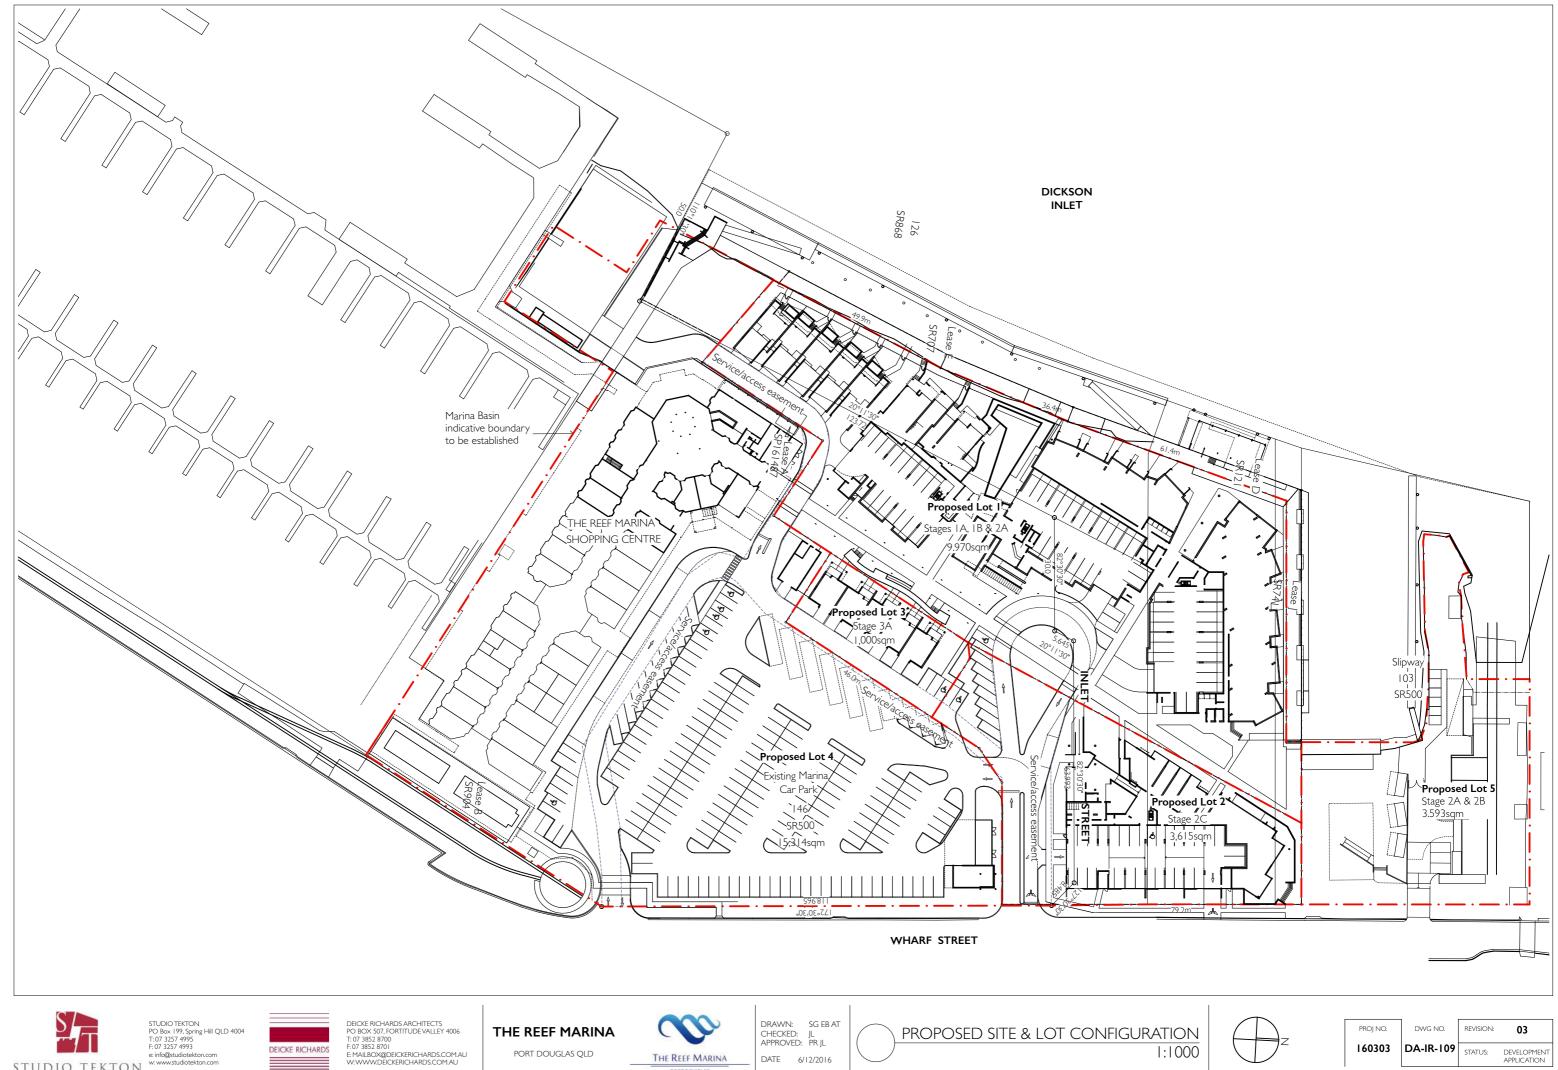

DATE 6/12/2016


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3 The Reef Marina/3.0 Design/3.1 Design (Arch)/3.1.2 Sketch Design/160303 Reef Mar



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THE REEF MARINA PORT DOUGLAS QLD



DRAWN: OTC CHECKED: JL APPROVED: PR JL DATE 30/11/2016

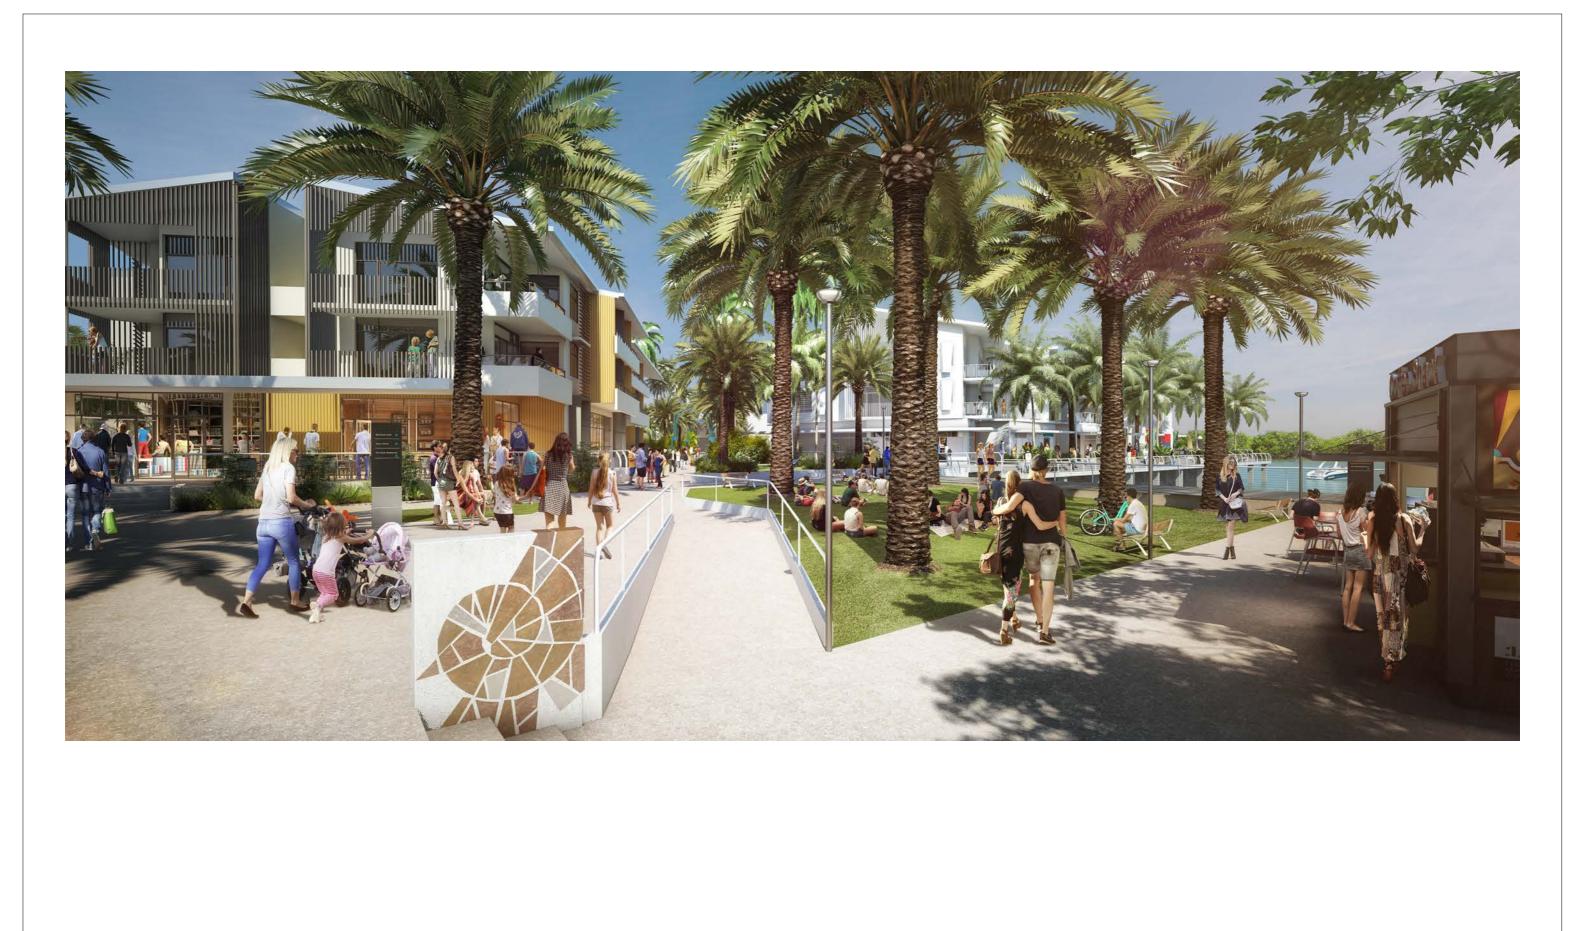SITE PERSPECTIVE - PLAZA

PROJ NO. DWG NO. REVISION: 01 160303 DA-IR-115 STATUS: DEVELOPMENT APPLICATION

Design (Arch)/3.1.2 Sketch Design









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DRAWN: OTC CHECKED: JL APPROVED: PR JL DATE 30/11/2016

SITE PERSPECTIVE - NORTH WEST

PROJ NO. 160303

DWG NO.

REVISION: 01 DA-S-112 STATUS: DEVELOPMENT APPLICATION







DEICKE RICHARDS ARCHITECTS PO BOX 507, FORTITUDE VALLEY 4006 T: 07 3852 8700 F: 07 3852 8701 E: MALEDX@DEICKERICHARDS.COMAU W:WWW.DEICKERICHARDS.COMAU THE REEF MARINA PORT DOUGLAS QLD



DRAWN: OTC CHECKED: JL APPROVED: PR JL DATE 30/11/2016

SITE PERSPECTIVE - SOUTH WEST

PROJ NO. 160303

DWG NO.

01 REVISION: DA-IR-113 STATUS: DEVELOPMENT APPLICATION







DEICKE RICHARDS ARCHITECTS PO BOX 507, FORTITUDE VALLEY 4006 T: 07 3852 8700 F: 07 3852 8701 E: MALEDX@DEICKERICHARDS.COMAU W:WWW.DEICKERICHARDS.COMAU THE REEF MARINA



DRAWN: OTC CHECKED: JL APPROVED: PR JL DATE 30/11/2016

SITE PERSPECTIVE - AERIAL FROM EAST

PORT DOUGLAS QLD










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SITE PERSPECTIVE - STAGE 1 FROM NORTH WEST



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REVISION: 01 DA-IR-116 STATUS: DEVELOPMENT APPLICATION



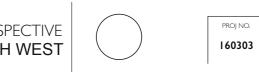



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A THE REEF MARINA

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STAGE IA SITE PLAN












DEICKE RICHARDS ARCHITECTS PO BOX 507, FORTITUDE VALLEY 4006 T: 07 3852 8700 F: 07 3852 8701 E: MALEDX@DEICKERICHARDS.COMAU W:WWW.DEICKERICHARDS.COMAU THE REEF MARINA PORT DOUGLAS QLD



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STAGE I A GROUND LEVEL PLAN

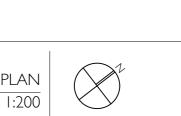

PROJ NO. 160303

DWG NO.



Ref:1401REEF/COUNCIL/MCU/IR/COLOUR PALLETE 2016 12 05



## COLOUR PALLET STAGE 1a

WALL COLOURS	M1	Dulux Vivid White	
	M2	Dulux Paving Stone	
	C1 CFC Weatherboard	Dulux Waza Bear	
ROOF, GUTTERING/FASCIA		Colorbond Surfmist	
BALUSTRADES, WINDOWS/DOORS, LOUVRES		Dulux Duratec Eternity Bronze Pearl	
WINDOW TINT		Viridian CoolTone Green	$\langle \rangle$
WINDOW AWNING		Colorbond Surfmist (supports to match Dulux Duratec Eternity Bronze Pearl)	

### STAGE 1b

WALL COLOURS	M1	Dulux Vivid White	
	M2, CFC Weatherboard	Dulux Coalition	
ROOF, GUTTERING/FASCIA		Colorbond Surfmist	
BALUSTRADES, WINDOWS/DOORS, LOUVRES		Dulux Duratec Eternity Pewter Pearl	
WINDOW TINT		Viridian CoolTone Green	
WINDOW AWNING		Colorbond Surfmist (supports to match Dulux Duratec Eternity Pewter Pearl)	

## STAGE 2a

WALL COLOURS	M1	Dulux Vivid White	,
	C1/C2 on L1/L2	Dulux Jodhpurs Quarter	
	C1-Ground	Dulux Blue Smart	
	C2-Ground	Dulux Orange Keeper	
	C3-Ground	Dulux Midas Touch	
ROOF, GUTTERING/FASCIA		Colorbond Surfmist	
BALUSTRADES, WINDOWS/DOORS, LOUVRES		Dulux Duratec Appliance White	
WINDOW TINT		Viridian CoolTone Green	$\langle \rangle$
WINDOW AWNING		Colorbond Surfmist (supports to match Dulux Duratec Zeus Timberland)	

## STAGE 2c


WALL M1 COLOURS		Dulux Vivid White	
	C2	Dulux Bracken Green	
	C3, CFC Weatherboard	Dulux Hawker's Gold	
ROOF, GUTTERING/FASCIA		Colorbond Surfmist	
BALUSTRADES, WINDOWS/DOORS, LOUVRES		Dulux Duratec Eternity Nickel Pearl	
WINDOW TINT		Viridian CoolTone Green	
WINDOW AWNING		Colorbond Surfmist (supports to match Dulux Duratec Eternity Nickel Pearl)	

## STAGE 3

WALL M1 COLOURS		Dulux Vivid White	
	C1, CFC Weatherboard	Dulux Sea Note	
ROOF, GUTTERING/FASCIA		Colorbond Surfmist	
BALUSTRADES, WINDOWS/DOORS		Dulux Duratec Intensity Reef	
LOUVRES		Sea Note	
WINDOW TINT		Viridian CoolTone Green	$\langle \rangle$
WINDOW AWNING		Colorbond Surfmist (supports to match Dulux Duratec Intensity Reef)	



DEVELOPMENT SUMMARY						
STAGE 1b						
Multi-Resid	ential			Number		Land Rec
2 x 4 Bedrm	n, 3 Bath.			2		150
2 x 3 Bedrm	n, 3 Bath			2		120
4 x 3 Bedrm	n, 2 Bath			4		240
2 x 1 Bedrm	n, 2 Bath			2		90
4 x 1 Bedrm	n, 1 bath			4		120
Total				14		720
Site Area &	Site Cover					
Refer Site Pla	n					
Gross Floor Area		•				
Refer Site Plan						
Landscaped Rec Areas		Land Rec		Soft Lan	Bal/Tce	
Unit 1			118.9	106	93.9	
Unit 2			114.1	98	82.9	
Common			711	377		
Total			944	581	177	
Parking		Req.		Prov.		
Cars			14	16		
Bikes - Units			4.7	5		
Bikes - Visitor	s		1.2	2		

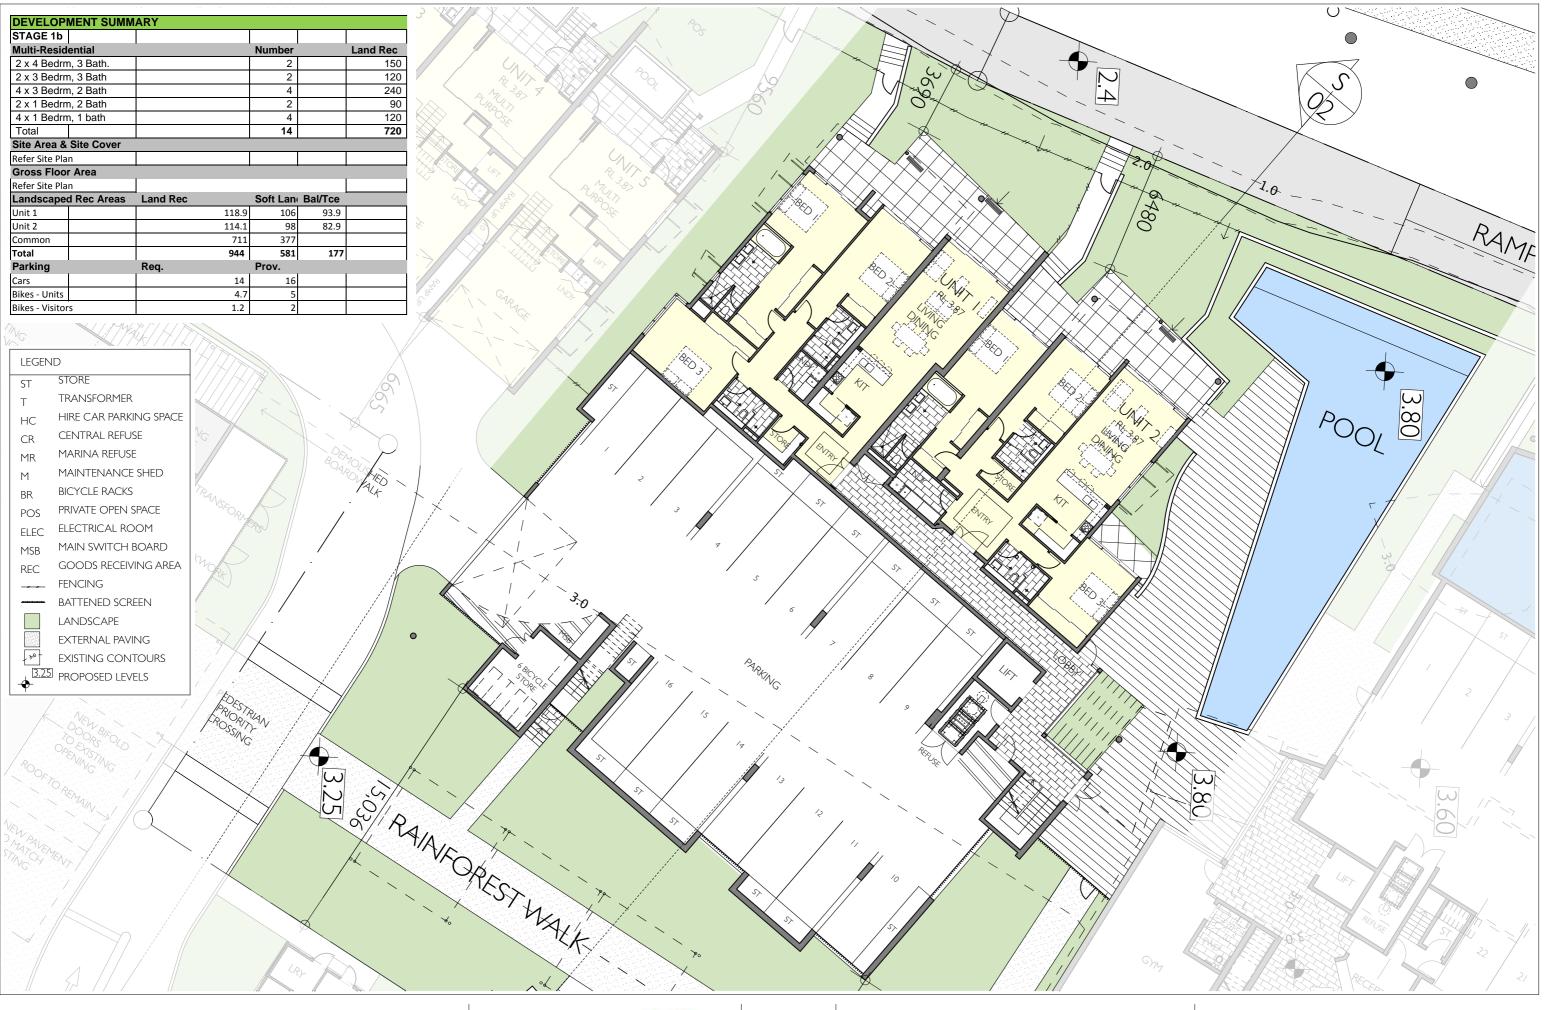





THE REEF MARINA PORT DOUGLAS QLD

C THE REEF MARINA PORT DOLICIA

DRAWN: SG AT EB CHECKED: JL APPROVED: PR JL DATE 30/11/2016





DWG NO.

**REVISION:** 

DA-IB-101 STATUS: DEVELOPMENT APPLICATION

03

PROJ NO.

160303



30 November 2016

PDR 16470

### Studio Tekton Pty Ltd

PO Box 199 Spring Hill Qld 4004

### Attention: John Loneragan

Dear John,

## RE: Planning application for the redevelopment of the Reef Marina at Wharf St Port Douglas – Council RFI regarding delivery arrangements to Stage 2A and 2C.

We have reviewed Douglas Shire Council's information request for the above project in respect of arrangements for the delivery of goods to any business located in stage 2A and 2C.

We advise that it was always the intent that goods for these areas would be unloaded at the loading/unloading bay provided on the internal private service road. The location of this bay is shown on our attached drawing 16470 SK-TP02. Goods can be unloaded at this point and taken by trolley (or carried) to any of the business locations.

The bay caters for a medium rigid vehicle (MRV) and the attached plan shows the vehicle path and demonstrates that it can enter and leave the bay without disrupting other traffic. The swept paths also demonstrate that an MRV can easily negotiate the loop road. It is anticipated, given the type of operations considered, that this would be the maximum delivery vehicle size. Chevrons have been provided to prevent other vehicles parking in the vicinity of this bay and preventing access.

Should the need arise, the swept path diagram also demonstrates that an MRV could reverse into the stage 2A carpark and leave in a forward gear. This movement would be the exception and only carried out early in the day or if the parking bays were available for a short term.

The use of the proposed loading/unloading bay in this fashion is an acceptable approach.


Yours faithfully PDR Engineers

Alada an Al

Alan McPherson Senior Civil Engineer






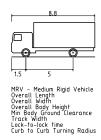




		Drawing Status	SCALE 1:500	Orig. Sheet A1	Disclaimer & Copyright THIS DRAWING AND DESIGN		Level 1, 258 Mulgrave Road PO Box 2551 CAIRNS QLD 4870	Client	Project
			DO NOT SCALE DRAWI	NGS	REMAINS THE PROPERTY OF PDR ENGINEERS AND MAY NOT BE COPIED IN WHOLE OR IN		Ph: (07) 4051 5599 Fax: (07) 4051 5455	STUDIO TEKTON	PROPOSED REEF MARI
E	REVISED CARPARK LAYOUT 12/09/16   FOR PRELIMINARY REVIEW 01/09/16	PRELIMINARY	Scales Before Reduction		PART WITHOUT PRIOR WRITTEN APPROVAL FROM THIS COMPANY.	<b>DOLE</b> er	ngineers	PTY LTD	DEVELOPMENT
liss	E DESCRIPTION DATE		5 0 5 10 15 20	25 m	© PDR Engineers Copyright		A.B.N. 88 126 211 461 A.C.N. 126 211 461		

#### <u>LEGEND</u> VEHICLE OUTLINE FORWARD MOVEMENTS - WHEEL TRACKING VEHICLE SWEPT PATH REVERSE MOVEMENTS ------ WHEEL TRACKING Drawing Title Drawn NP Designed Verified TURN PATH PLANS Date NOV. '16 RINA Approved Sheet 2 Drawing Number 16470-SK-TP02 Revision A

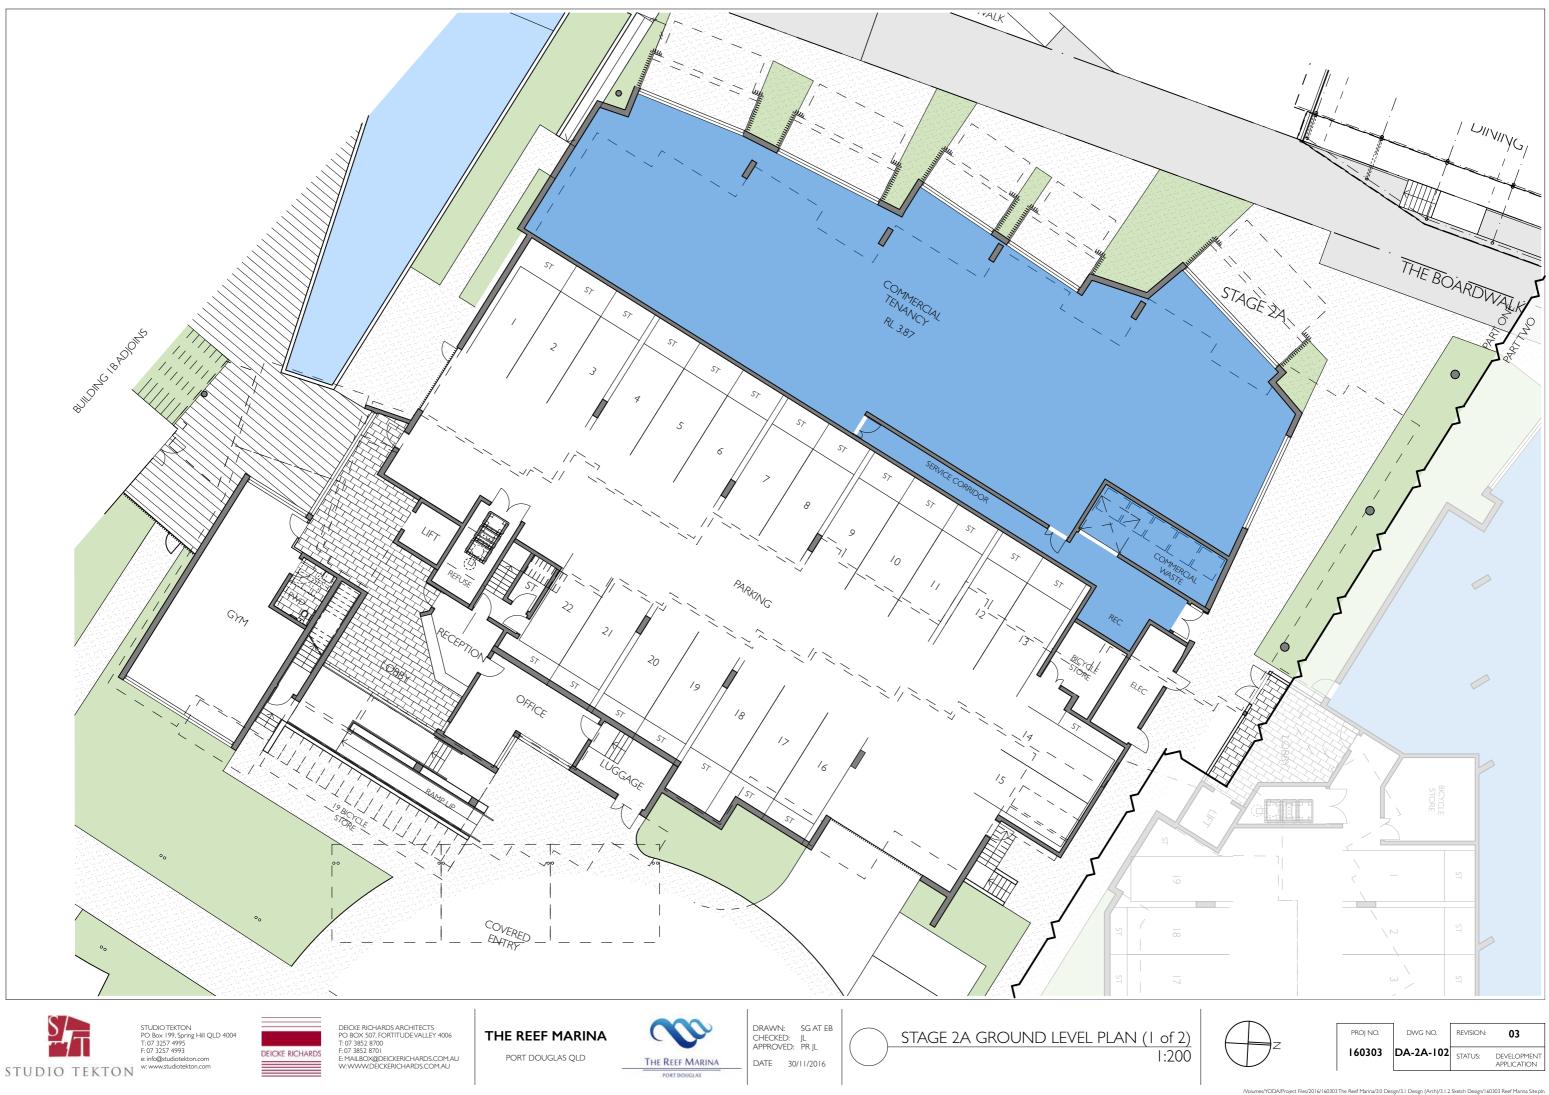





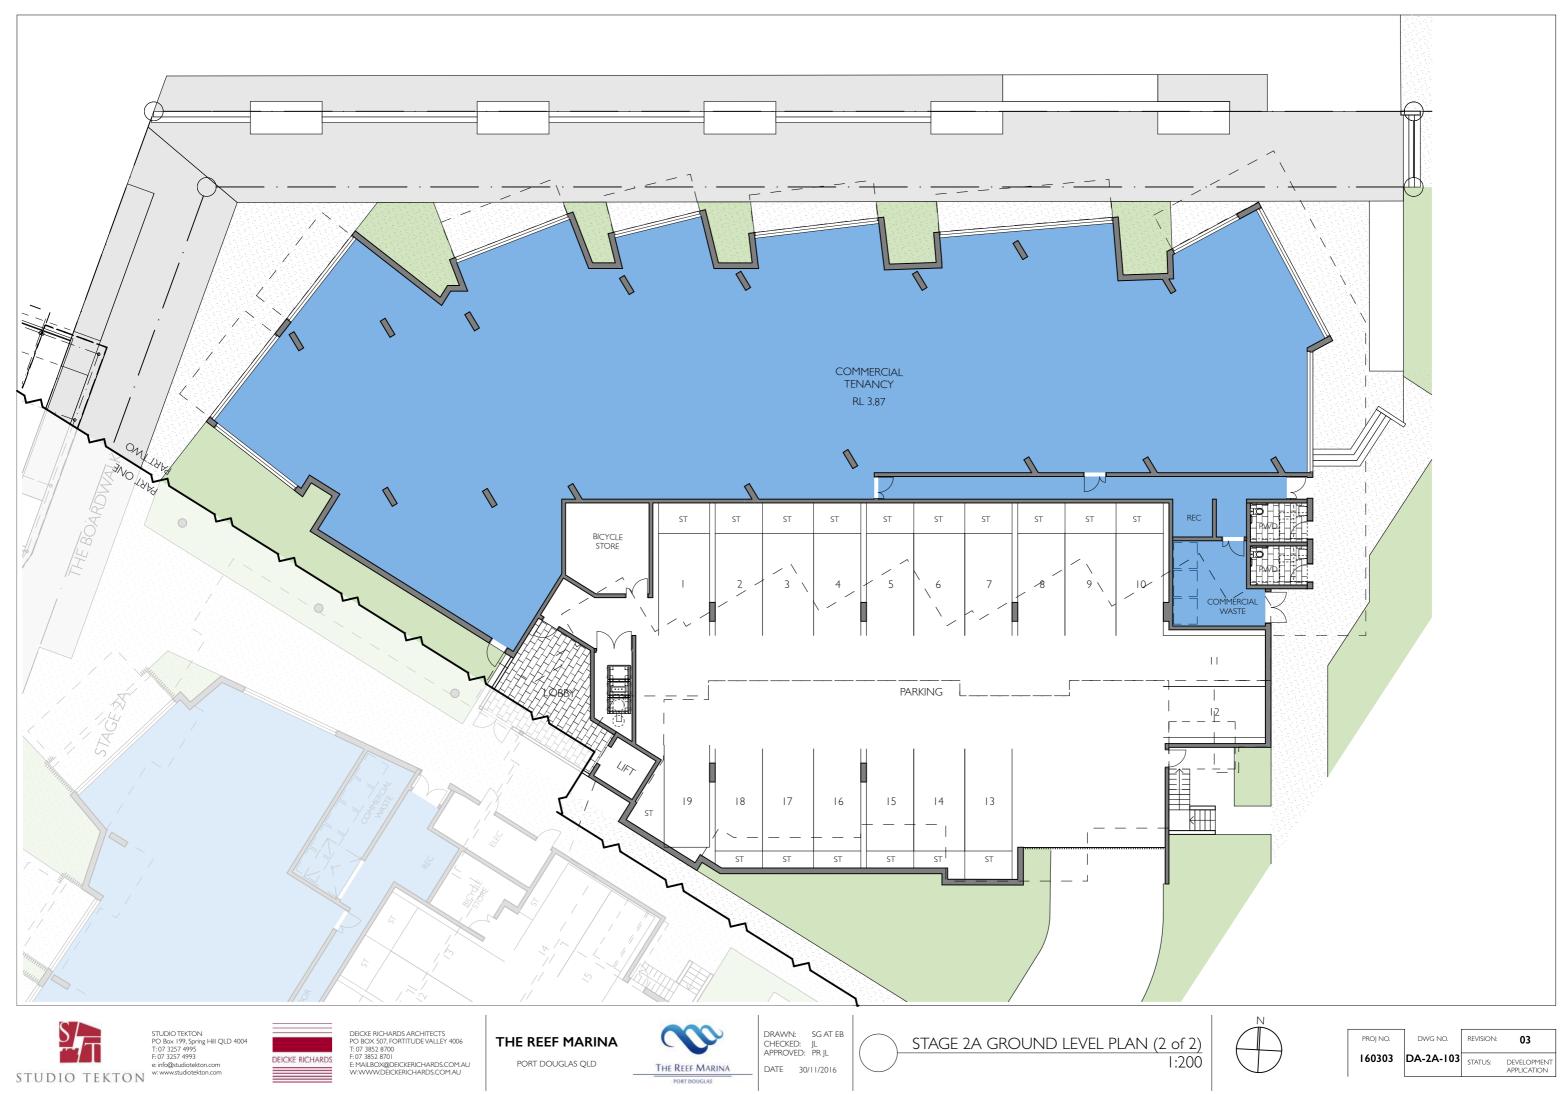


/Volumes/YODA/Project Files/2016/160303 The Reef Marina/3.0 Design/3.1 Design (Arch)/3.1.2 Sketch Design/160303 Reef Marina Site.plr









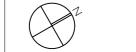



PROJ NO.

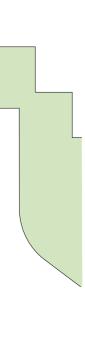

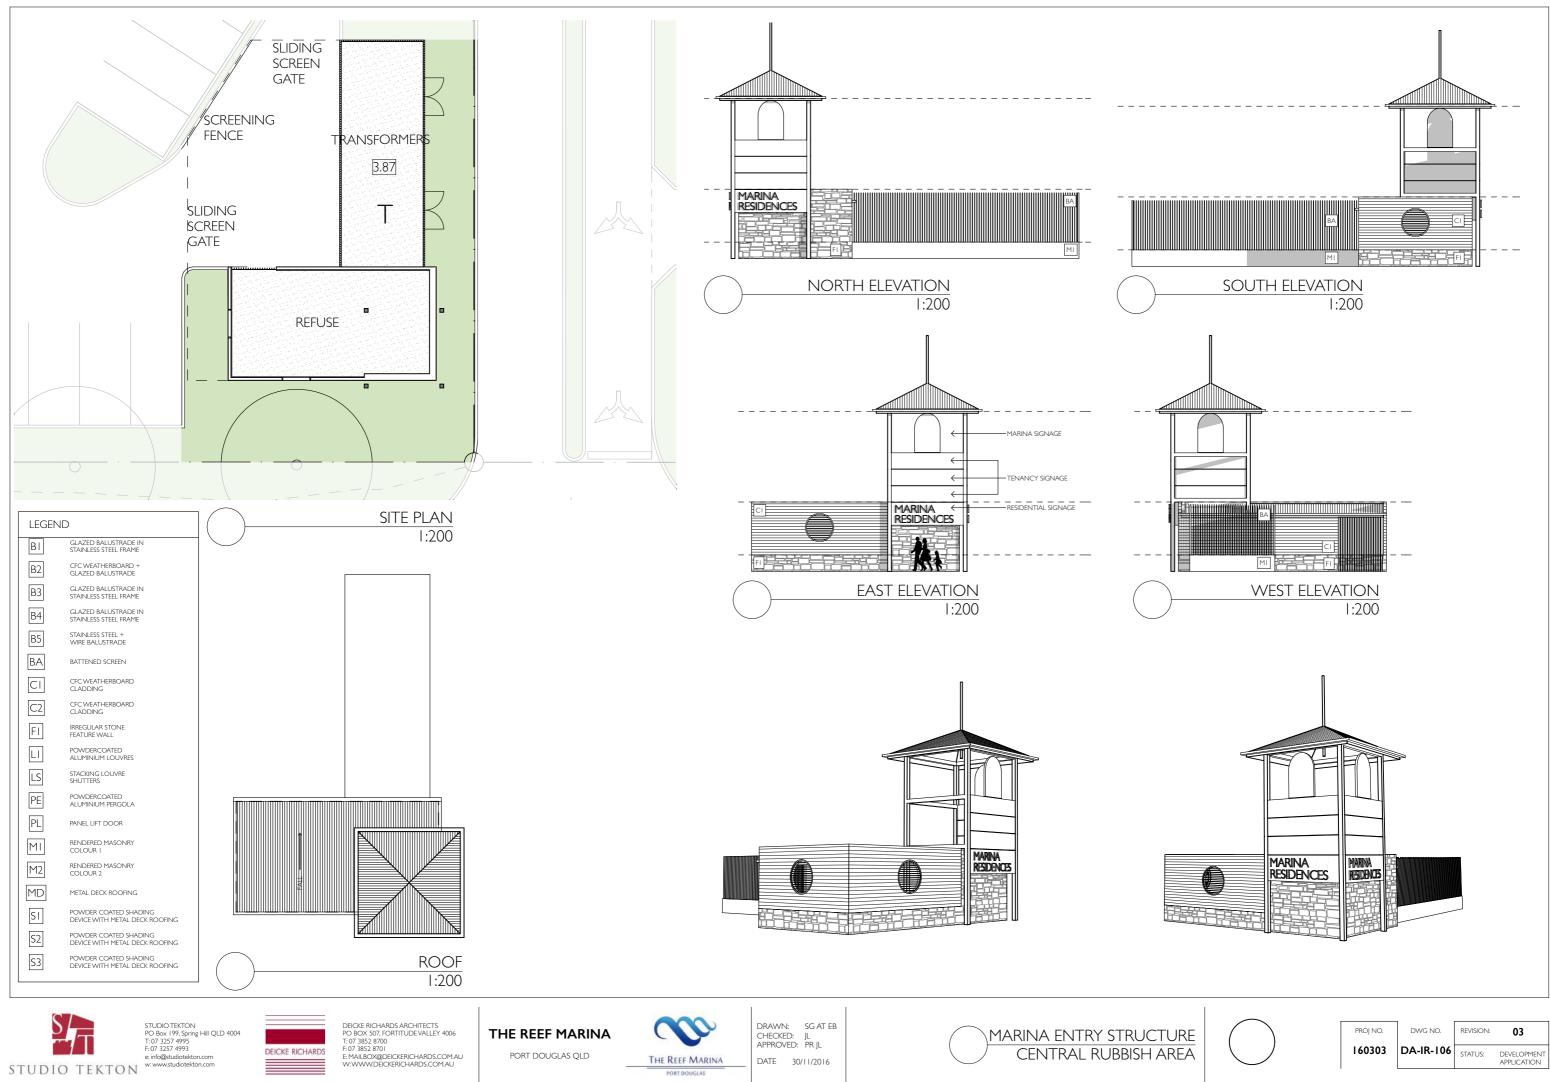

Nolumes/YODA/Project Files/2016/160303 The Reef Marina/3.0 Design/3.1 Design (Arch)/3.1.2 Sketch Design/160303 Reef Marina Site.pln

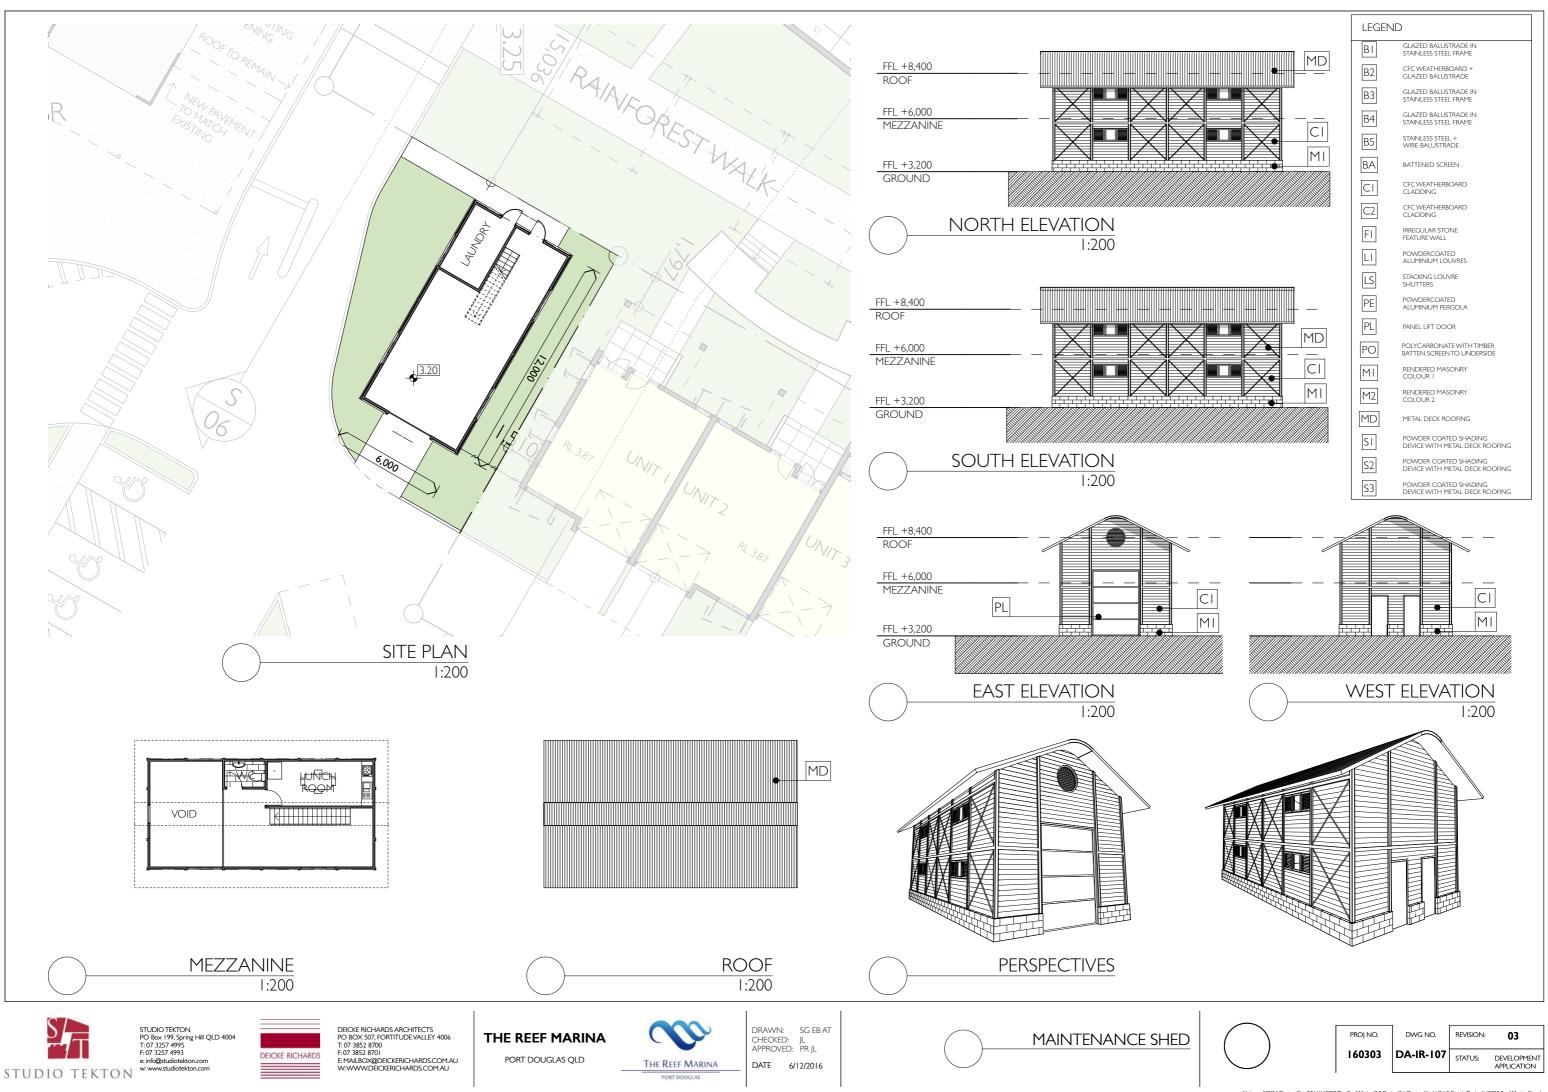

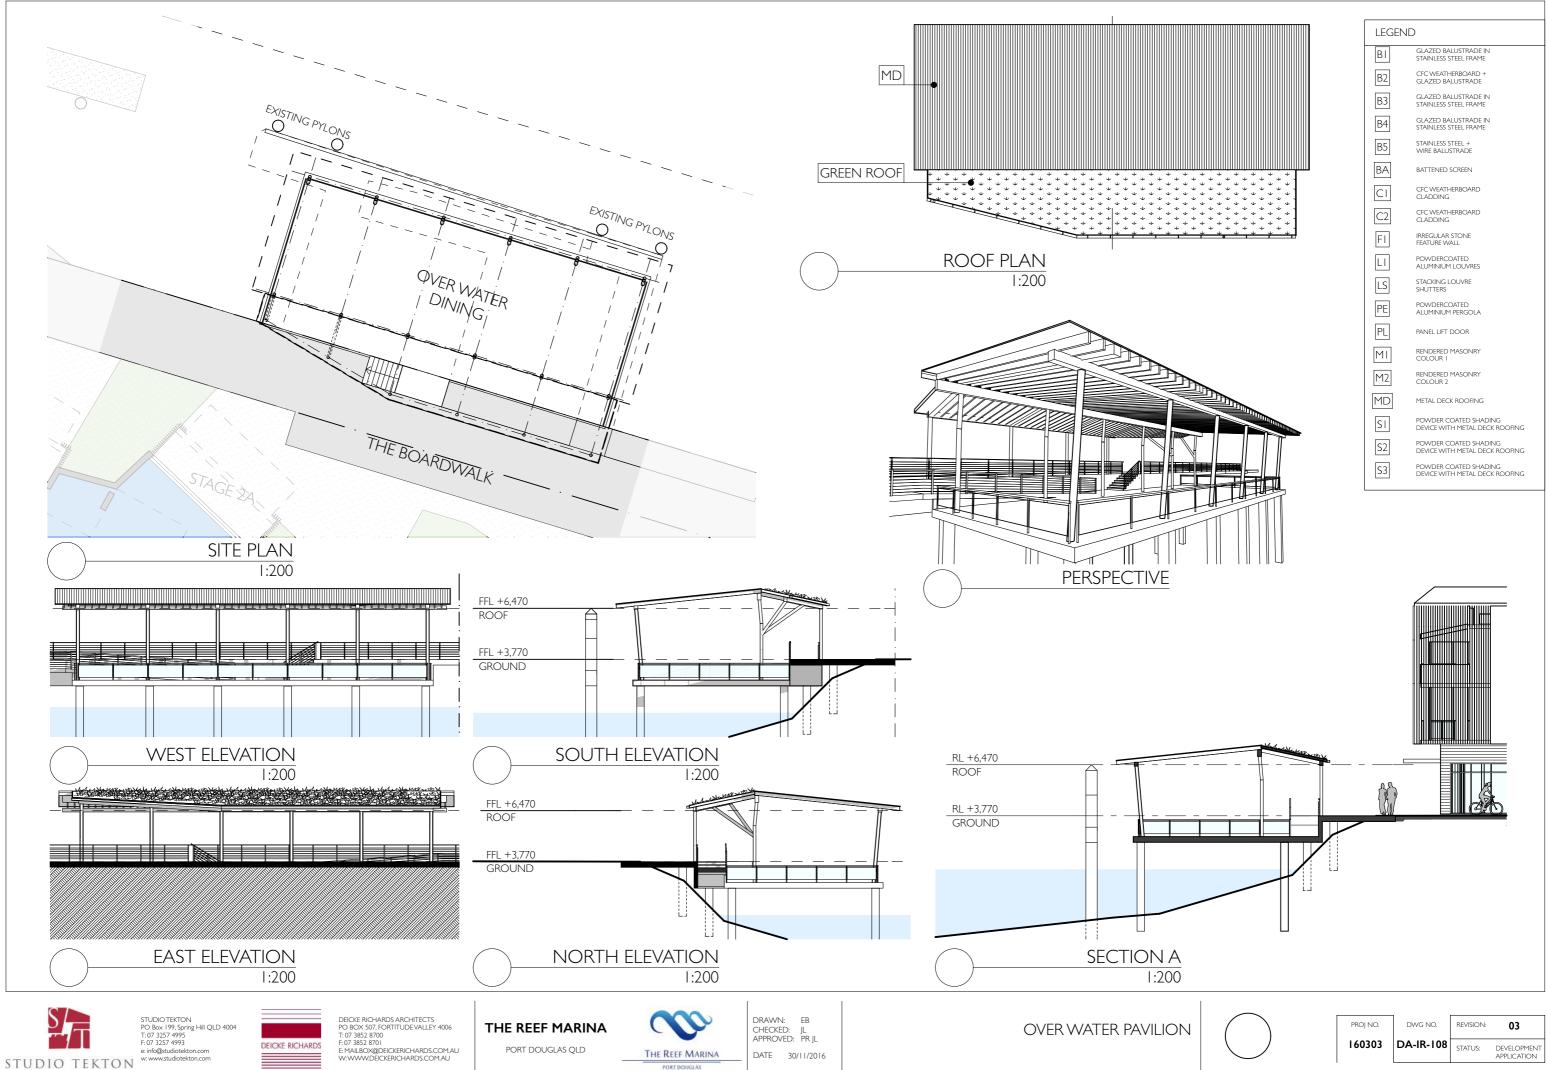

LEGEND					
BI	GLAZED BALUSTRADE IN STAINLESS STEEL FRAME				
B2	CFC WEATHERBOARD + GLAZED BALUSTRADE				
B3	GLAZED BALUSTRADE IN STAINLESS STEEL FRAME				
B4	GLAZED BALUSTRADE IN STAINLESS STEEL FRAME				
B5	STAINLESS STEEL + WIRE BALUSTRADE				
BA	BATTENED SCREEN				
СІ	CFC WEATHERBOARD CLADDING				
C2	CFC WEATHERBOARD CLADDING				
FI	IRREGULAR STONE FEATURE WALL				
LI	POWDERCOATED ALUMINIUM LOUVRES				
LS	STACKING LOUVRE SHUTTERS				
PE	POWDERCOATED ALUMINIUM PERGOLA				
PL	PANEL LIFT DOOR				
MI	RENDERED MASONRY COLOUR I				
M2	RENDERED MASONRY COLOUR 2				
MD	METAL DECK ROOFING				
SI	POWDER COATED SHADING DEVICE WITH METAL DECK ROOFING				
S2	POWDER COATED SHADING DEVICE WITH METAL DECK ROOFING				
S3	POWDER COATED SHADING DEVICE WITH METAL DECK ROOFING				

# metal roof to green roof

Elmich (Far East) Pte Ltd has developed a system that allows the low cost conversion of metal sheet roofs to environmentally friendly green roofs.

The Aramsa Garden Spa, a garden sanctuary set in the heartland of Bishan Park in Singapore, had an unattractive exposed metal roof which detracted from the aesthetically pleasing spa environment. The metal roof created excessive noise during periods of rainfall and did not provide insulation against high ambient tropical temperatures and humidity.

The components included VersiCell®, interlocking drainage and air insulation cells, VersiDrain® 25P, a drainage and water retention tray, filter fabric, lightweight 'soil-less' growing media and selected plant species specifically adapted to Singapore's tropical environment.

Aluminium battens, to prevent soll media movement, were anchored onto the metal sloping roof. VersiCell<sup>®</sup> drainage cells were placed between the metal ribs to provide an insulation barrier and a level surface for subsequent Installation of VersiDrain<sup>®</sup> 25P drainage and water retention trays. A lightweight filter

- Steel C-section
- 2 Steel purlin
- (3) Metal roof
- (4) VersiCell® drainage/air insulation cell
- (5) VersiDrain® 25P water retention tray
- 6 Geotextile
- 7 Metal restraining strip
- 8 Plant species





fabric was positioned on the drainage and retention trays and a 100 mm layer of a lightweight pH stabilized soil-less mix then installed on the filter fabric. Key factors in the selection of the proprietary growing media included readily available components, water retention properties, low weight (80 kg/m<sup>2</sup> wet weight) and low heat absorbency.

Locally sourced plant species selected for hardiness, colour, height, the ability to tolerate high tropical rainfall conditions followed by hot and dry periods and low maintenance were planted into the growing media. Plant species included: Furcraea Foetida, Zephyranthes, Tradescantia Pallida, Sedum Mexicanum, Pedillanthes and Rhoeo.

The Aramsa Garden Spa is now reaping the benefits of converting an unattractive metal roof that was not in keeping with the aesthetics associated with the and spa environment. The planted roof, with its range of coloured flowering plants, provides an aesthetically pleasing view and an attractive environment for butterflies and birds. The reduced energy consumption as a consequence of minimized heat absorption due to increased thermal insulation saves cost and creates improved comfort inside the building as well as noise elimination from impact of heavy rainfall.

Elmich is an ISO 9001 certified company that ensures the most appropriate and cost effective system is installed





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Elmich Australia Pty Ltd 52/8 Avenue of Americas, Newington NSW 2127 Australia Ph: + 61 2 9648 2073 Fax: + 61 2 9648 4731 Email: australia@elmich.com Website: www.elmich.com.au