

P: (07) 40 393 409 M: 0402 073 082

E: Info@planningplusqld.com.au A: PO Box 399, Redlynch QLD 4870 W: www.planningplusqld.com.au

 Our Ref:
 20-12/001182

 CRC Ref:
 mcuc 2021_4490/1

 Date:
 18 March 2022

Attn: Mr Neil Beck Chief Executive Officer Douglas Shire Council PO Box 723 MOSSMAN QLD 4873

VIA EMAIL: N.beck@douglas.qld.gov.au

Dear Sir,

RE: RESPONSE TO INFORMATION REQUEST IN RELATION TO AN APPLICATION FOR MATERIAL CHANGE OF USE FOR 'MULTIPLE DWELLINGS' AND 'SHORT-TERM ACCOMMODATION' OVER LAND AT 69 – 73 MURPHY STREET, PORT DOUGLAS

Planning Plus acts on behalf of Gurner TM Nominee Pty Ltd (the 'applicant') in relation to the above-described matter.

We hereby provide the following information in response to Council's Information Request dated 22 December 2021.

The proposed mixed use development is understood to comprise of:


- 4 dwellings,
- 13 car parking spaces; and
- Site landscaping and open space.

The proposed development is 5 storeys with a height of 17.5 metres. It is noted the labelling and referencing of the various levels are not consistent throughout the set of plans whereby some plans nominate reference to 2 levels over lower ground, ground and upper ground while other plans nominate 3 levels over lower ground and ground levels. It is preferred that the plans reference ground level and then each level thereafter i.e Level 1, Level 2 etc.

Please see revised Architectural Plans included as **Annexure 1**. Requested changes to labelling have been made.

Building Height

1. Concern is raised with the proposed building height, in particular of Dwelling No1 and the extensive use of pylons. It is considered that the building will be overbearing and will have an adverse impact on the visual amenity of the immediate area, particularly when viewed from Jalun Park. It is suggested that the height of the building be reduced by reducing the height of the pylons and removing the area referred to as upper ground level or garden level.

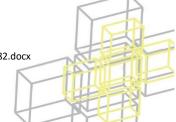

Further detail is requested in relation to the visual impact of the proposed development having regard to:-

- The construction of the access;
- Detailing all existing vegetation and that vegetation that will be removed as a consequence of the construction of the access and/or will be compromised by undertaking building work and the provision of services to the site;
- The response to this information request item is required to be undertaken by an appropriately qualified professional and supported by a series of plans showing accurate visual representations of the development.

Please see revised Architectural Plans included as **Annexure 1**. Overall building height and the length of the columns of Dwelling 1 have been reduced by 1m.

Further details are provided below regarding the access driveway and associated vegetation clearing and landscaping, however 3D Views are provided from Julan Park and the driveway entrance based on this information and are included as **Annexure 2**.

2. The application does not include an updated engineering report, therefore proposals for sewerage, water supply, stormwater drainage etc relevant to the revised development concept are required to be prepared for review.

It is unclear whether the water supply will require on site booster systems given the FFL's proposed for the highest levels of the development.

The existing sewer will need to be decommissioned as it is under the Dwelling 3 footprint.

Provide an engineering report detailing how the site will be serviced and adequately cater for stormwater.

Please see updated Engineering Services Report included as Annexure 3.

3. Drawing DA010.01 (Lower Floor plan) appears to show columns for the subsequent levels of the development being located within the internal driveway and in front of garages. The applicant is to review the location of columns and confirm that all garages are able to be accessed in accordance with the requirements of AS2890.1 – Off Street Parking Code and AS2890.6 – Parking Facilities – Off-Street Parking for people with disabilities. Swept path diagrams are also required. Supporting information is also to show how the development is serviced by refuse vehicles.

Please see Traffic Engineering Assessment included as **Annexure 4**. The report confirms that the parking layout complies with AS2890.

4. The application does not include plans and details of the access into the site. Detail of the access driveway east from the extent shown on drawing DA010.01 is required. It is noted that the access will be in road reserve and the previous approval issued over the site required this road to be constructed to an access street standard. Particular design details is required from the Applicant regarding the design of the access, departure from FNQROC Development Manual if proposed, and ongoing maintenance obligations post construction and ability for the access to accommodate refuse vehicles. Details on all existing vegetation to be removed and / or compromised is also required.

Please see revised Architectural Plans included as **Annexure 1**, Engineering Services Report included as **Annexure 3**, Traffic Engineering Assessment included as **Annexure 4** and Landscape Plans included as **Annexure 5**.

Architectural Drawings DA03-001 & 002 illustrate the proposed general arrangement;

Murphy

- Civil Drawings are included within the Engineering Services Report;
- Commentary is provided in the Traffic Engineering Assessment; and
- Details of trees to be removed/retained and additional landscaping works are provided within the Landscaping Plans.

Generally, the proposed access has been designed to minimise site disturbance and significant engineering works by achieving an at-grade solution which allows for retention of vegetation and significant landscape embellishment to ensure an appropriate visual amenity outcome.

Specifically in relation to refuse collection, we note that the low-impact design of the driveway means that refuse collection would need to occur at the bottom of the driveway where it ties in with the existing carpark. The plans show a proposed bin collection enclosure location, and it is proposed that this enclosure would be built to a high standard, commensurate with the location. The proposed development includes onsite bin storage (see Drawings DA03.002 & DA010.01) and will include a management arrangement for the transportation of the bins to and from the external collection point as required.

5. With reference to drawing DA010.01, the application does not demonstrate how it will provide for disabled access to the site and the buildings as required for this development classification. Visitor parking and compliant accessible path of travel from the parking will need to be demonstrated in the proposed layout.

In relation to providing pedestrian access to the site, the applicant is to provide advice on how the development ensures that it will not be in conflict with the requirements of the:

- a) The Disability Discrimination Act (1992);
- b) The Disability (Access to Premises Buildings) Standard (2010); and
- c) The Disability Standards for Accessible Public Transport (2002).

The applicant hereby seeks to amend the application to no longer include the Short-Term Accommodation component. Moving forward, the application seeks approval for Multiple Dwellings only. We understand that as this change is in response to an Information Request, it will not impact on the current development assessment process.

6. Drawing DA010.03 (Ground floor plan) and Sections 1 and 2 on Drawing DA30.001 indicate that the boundary wall adjacent Murphy Street is very close to the property boundary.

Section 1 on Drawing DA30.001 "Typical Sections" shows cut required in the existing batter potentially undermining the road reserve.

Section 2 on Drawing DA30.001 "Typical Sections" shows fill required within the site and extending into the Murphy Street road reserve.

The applicant is to confirm how the walls adjacent Murphy Street are proposed to be constructed and if any disturbance or reliance of Murphy Street is proposed to achieve the development outcome.

We refer to the Geotechnical Advice provided by GeoDesign which was included in the Development Application and refer you in particular to the "Stability" section. We note that the existing batter to Murphy Street exhibits stability issues and that the proposed development will rectify these issues in accordance with the geotechnical advice. Structural engineering details for the wall will be sought following approval of final plans and Council may condition the provision of this information prior to obtaining Building Works approval. The proposed construction of these elements are noted on the Architectural plans prepared by Warren & Mahony Architects included as **Annexure 1**



7. The applicant is requested to clarify the line-type/hatching used on Sections 1 and 2 on Drawing DA30.001 "Typical Sections" and on the East Elevation drawing DA20.002. Council Officers interpret that the diagonal hatching represents earthworks fill, the applicant is requested to clarify this interpretation.

The vertical hatching used on the East Elevation drawing DA20.002 for the lower southern portion of the site appears to be timber fencing, however the height scales as up to 3.6m with another fence type on top of this for a total height appearing to scale at approximately 4.7m at the intermediate step down. (Fence at the southern boundary scales at 2.9m timber and 3.9m overall). The applicant is requested to clarify the heights, finished ground levels and construction material for this eastern fence and detail what filling if being retained by the fence which extends to the property boundary.

Additional sections through the proposed pools for each dwelling are requested to confirm the founding levels and whether the pools are founded on existing ground, founded in new filling, or suspended above the ground.

Please see revised drawing set included as **Annexure 1** and note:

- Legend has been added to sections hatched pattern is indicative fill.
- Eastern boundary fence shown on Drawing DA20.002 is to follow the ground line and is nominally 1.8m high.
- Pool sections have been added (Drawing DA30.003) these are a combination of suspended slabs and being cut into existing ground.
- 8. The applicant is requested to clarify the proposed volume to be filled/removed and to confirm the expected truck movements to achieve required earthworks. The confirmation should include the existing surface contours overlaid with design site levels.

Proposed excavation areas are shown on DA50.002 within **Annexure 1** and are relatively minor. Fill figures are not available at this stage. In any case, this is considered to be a construction management issue which would be regulated by a future Operational Works approval.

9. There are significant existing drainage issues on Murphy Street and the development must ensure that the overland flows are able to be conveyed through the site in the existing easement and flow path. Details of site finished levels, landscaping etc in the southern easement, through Council land and across the easement are to be provided;


Please see updated Engineering Services Report included as **Annexure 3**.

10. The applicant is to confirm legal point of discharge of the site and advise if the existing underground stormwater pipe along southern boundary of the site will be utilised for discharges from the development site.

Please see updated Engineering Services Report included as **Annexure 3**.

11. The capacity and condition of the existing stormwater pipe through the site is not addressed in the supporting material submitted with the application. Council requires an assessment of the required capacity to convey upstream flows through the site for the 100-year ARI, (1% AEP) rainfall event. However, if provision for overland flow is not provided (or is compromised) then a severe impact statement will be required, and additional capacity may need to be provided. Advice on the proposed pipe design is required.

Please see updated Engineering Services Report included as **Annexure 3**.

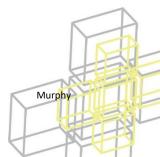

12. Capacity limitations are known to exist in the stormwater system downstream from the site and these are expected to be further compromised if the access filling constrains the overland flow paths from the site.

Stormwater calculations must consider the receiving environment and make appropriate allowance for actual operating conditions. Council's preliminary assessment indicates increased pipe sizes will be required. Advice on the proposed pipe size and design is required.

Please see updated Engineering Services Report included as Annexure 3.

13. An opportunity to address stormwater flows from Murphy Street may exist along the western boundary of the site, through provision of additional underground capacity in the 4m landscaped setback. Council seeks advice on the applicant's willingness to consider acceptance of an easement for this purpose noting that effective capture and conveyance of stormwater assists the development along the southern boundary and across the esplanade.

Alternative options may include stormwater pipes along Murphy Street. These options will need to be considered in relation to the development proximity to the road, proposed geotechnical treatments and depth of structures adjacent current or future stormwater works. Council seeks further information from the Applicant is this regard to adequately address the issue of stormwater for the site and for the existing drainage regime in Murphy Street. It is important to Council that an ability to address stormwater issues in Murphy Street is preserved in the event they are not overcome by the proposed development. It is also noted that effective stormwater control when considering the geotechnical elements proposed with cutting and filling within the Murphy Street road reserve.

Please see updated Engineering Services Report included as Annexure 3.

14. Water reticulation flow and pressure near the site is to be confirmed in addition to establishing the existing operating pressure at the boundary of the site. Council is not responsible for providing water capacity and pressure for the development demands and in particular, the height of the development. Further information detailing adequate water pressure and capacity is required.

Please see flow and pressure test certificate included as **Annexure 6**.

15. Power demand and the location of this demand at the edge of the power supply network may require that additional electrical infrastructure being required which may have implications for the layout and access arrangements. Advice from Ergon Energy regarding the local network capacity is requested.

We request that this matter be addressed by way of a condition of approval.

This letter and attachments constitute the applicant's full response to the information requested.

We trust this information is sufficient for your purposes; however should you require any further details or clarification, please do not hesitate to contact the undersigned.

Yours Faithfully

Evan Yelavich
Director / Planner
Planning Plus QLD Pty Ltd

enc. Annexure 1: Architectural Plans

Murphy

Annexure 2: 3d Views

Annexure 3: **Engineering Services Report Traffic Engineering Assessment** Annexure 4:

Annexure 5: **Landscape Plans**


Pressure and Flow Test Certificate Annexure 6:




Gurner

Annexure 1

Architectural Plans

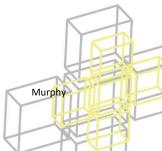

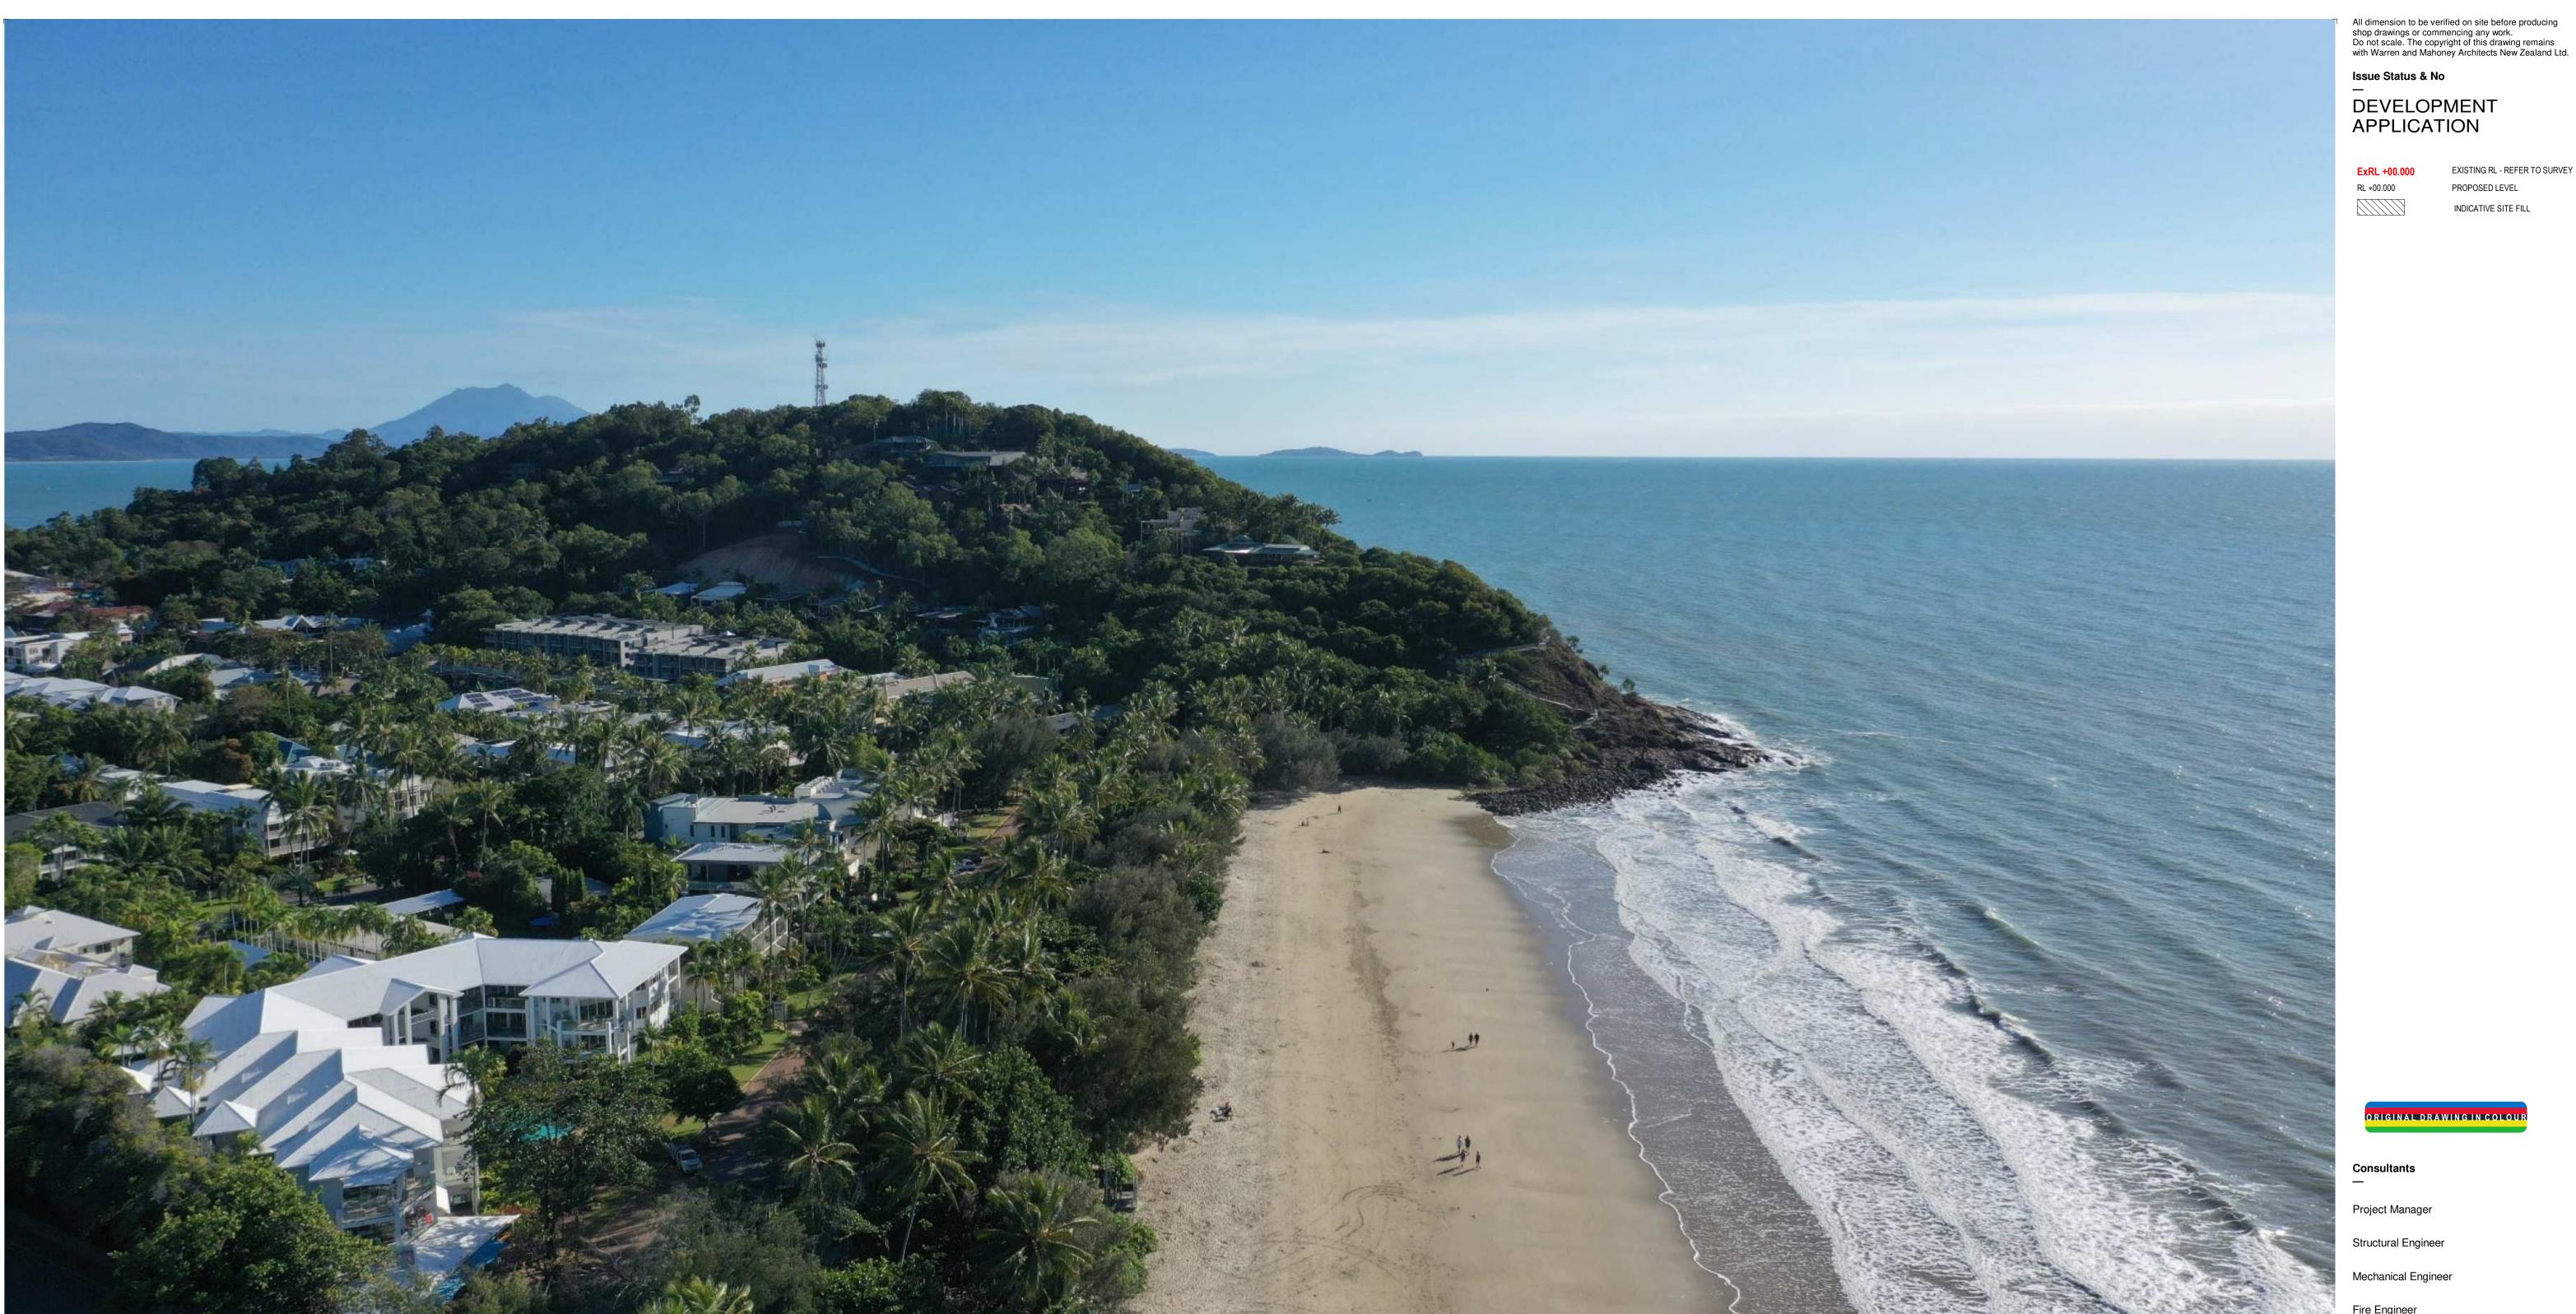

69-73 MURPHY STREET | PORT DOUGLAS

DEVELOPMENT APPLICATION MARCH 2022

DA DRAV	VING LIST			
DA00.001	COVER SHEET	Е	DA30.001	TYPICAL SECTIONS
			DA30.002	TYPICAL SECTIONS
DA01.001	SITE CONTEXT	D	DA30.003	POOL SECTIONS
DA01.002	SITE IMAGERY	D		
DA01.003	SITE IMAGERY	D	DA50.001	DEVELOPMENT SUMMARY - GFA
DA01.004	SITE ANALYSIS	D	DA50.002	DEVELOPMENT SUMMARY - SITE COVER
DA01.005	SITE SURVEY	D	DA50.003	DEVELOPMENT SUMMARY - LANDSCAPE
DA01.006	SITE SURVEY	D		
DA01.007	INTERPOLATED SURVEY	Е	DA80.001	SOLAR ANALYSIS - JUNE 21
			DA80.002	SOLAR ANALYSIS - DECEMBER 21
DA03.001	PROPOSED SITE PLAN	F		
DA03.002	SITE ACCESS PLAN	В	DA90.001	MATERIALS
			DA90.011	PERSPECTIVES - STREET VIEW 01
DA010.01	GROUND FLOOR PLAN	J	DA90.012	PERSPECTIVES - STREET VIEW 02
DA010.02	L01 FLOOR PLAN	J	DA90.013	PERSPECTIVES - STREET VIEW 03
DA010.03	L02 FLOOR PLAN	J	DA90.014	PERSPECTIVES - STREET VIEW 04
DA010.04	L03 FLOOR PLAN	J	DA90.020	PERSPECTIVES - EX. TREE CANOPY
DA010.05	ROOF PLAN	Н	33	
DA20.001	NORTH ELEVATION	G		
DA20.002	EAST ELEVATION	G		
DA20.003	SOUTH ELEVATION	G		
DA20.004	WEST ELEVATION	F		

ORIGINAL DRAWING IN COLOUR

EXISTING RL - REFER TO SURVEY

PROPOSED LEVEL INDICATIVE SITE FILL

Project Manager

Structural Engineer

Mechanical Engineer

Fire Engineer

Electrical Engineer

GURNER TM

GURNERTM

Warren and Mahoney Architects Australia Pty Ltd

Level 4, 141 Flinders Lane Melbourne VIC 3000 Phone + 61 3 8547 6977


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69-73 MURPHY STREET

PORT DOUGLAS

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A 09/09/21 FOR CONSULTANT COORDINATION

B 15/09/21 FOR INFORMATION C22/09/21 DRAFT DA D 04/10/21 ISSUE FOR DA

Consultants

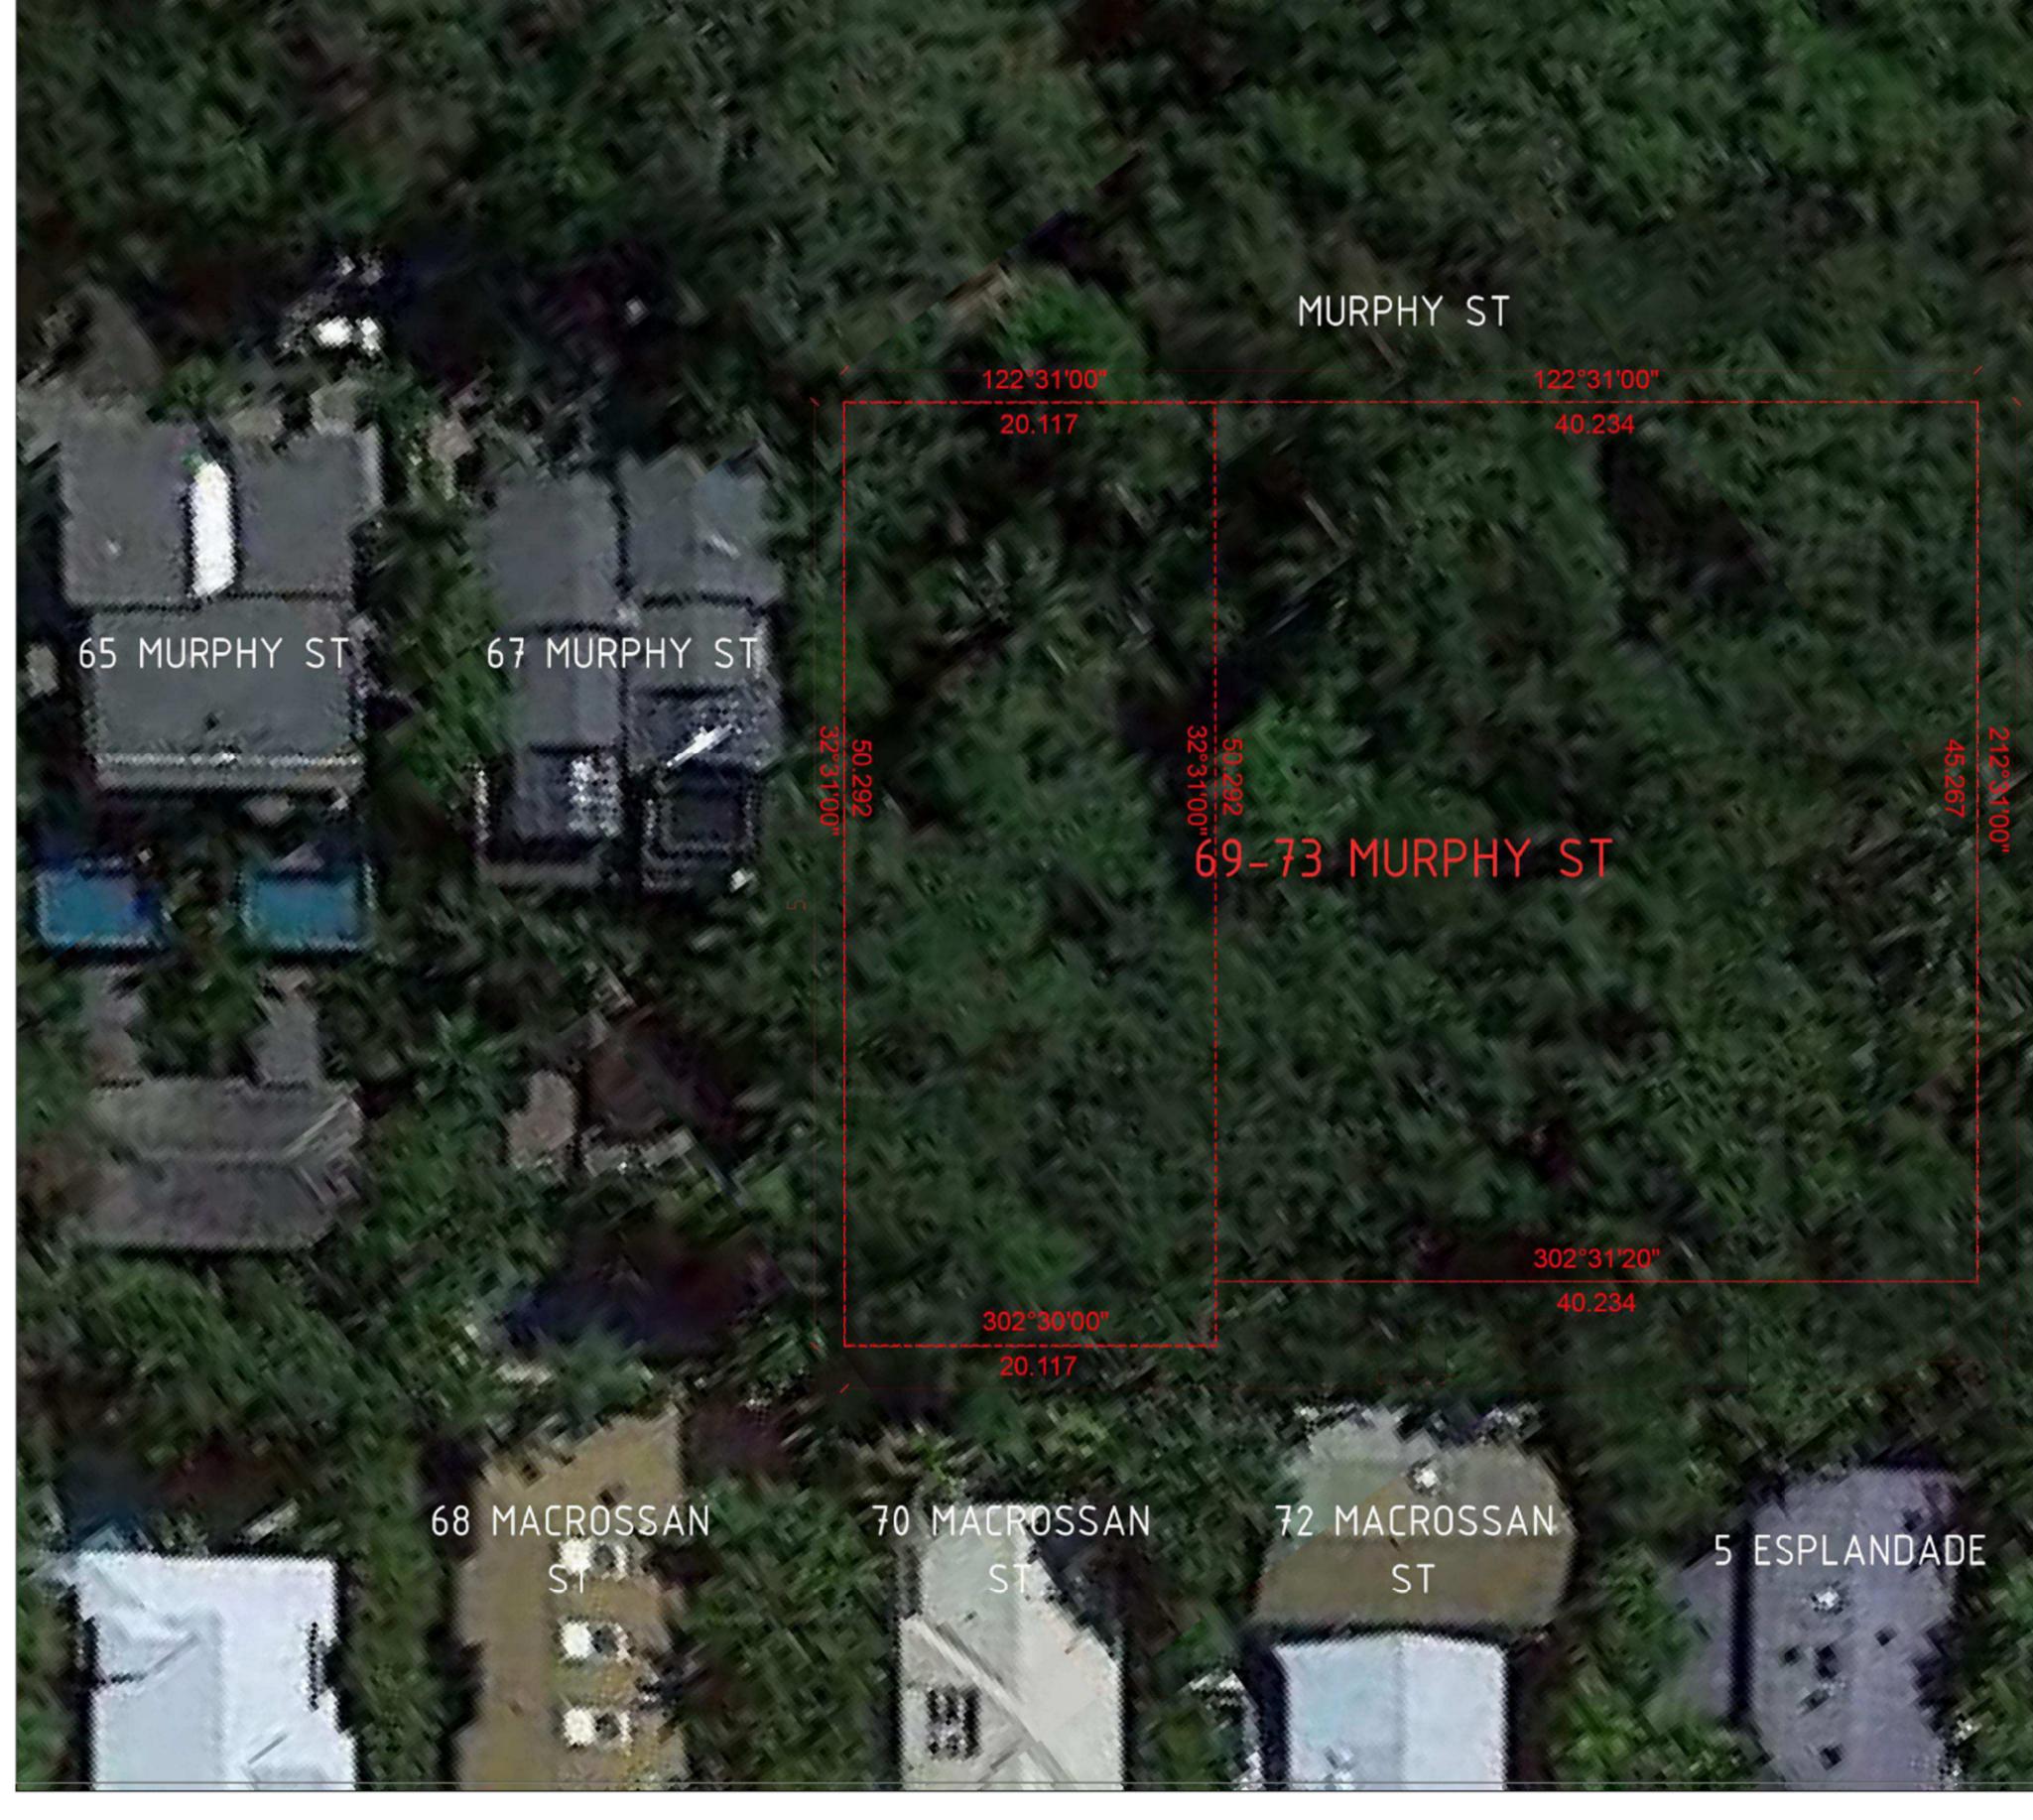Project Manager Structural Engineer

Fire Engineer

Mechanical Engineer

Electrical Engineer

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Client —

GURNER TM

Project Title

69-73 MURPHY STREET

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PORT DOUGLAS

Drawing Title

SITE CONTEXT

Scale Job No Drawn

Drawing Status DEVELOPMENT APPLICATION

Checked **Drawing No** Revision \bigcirc


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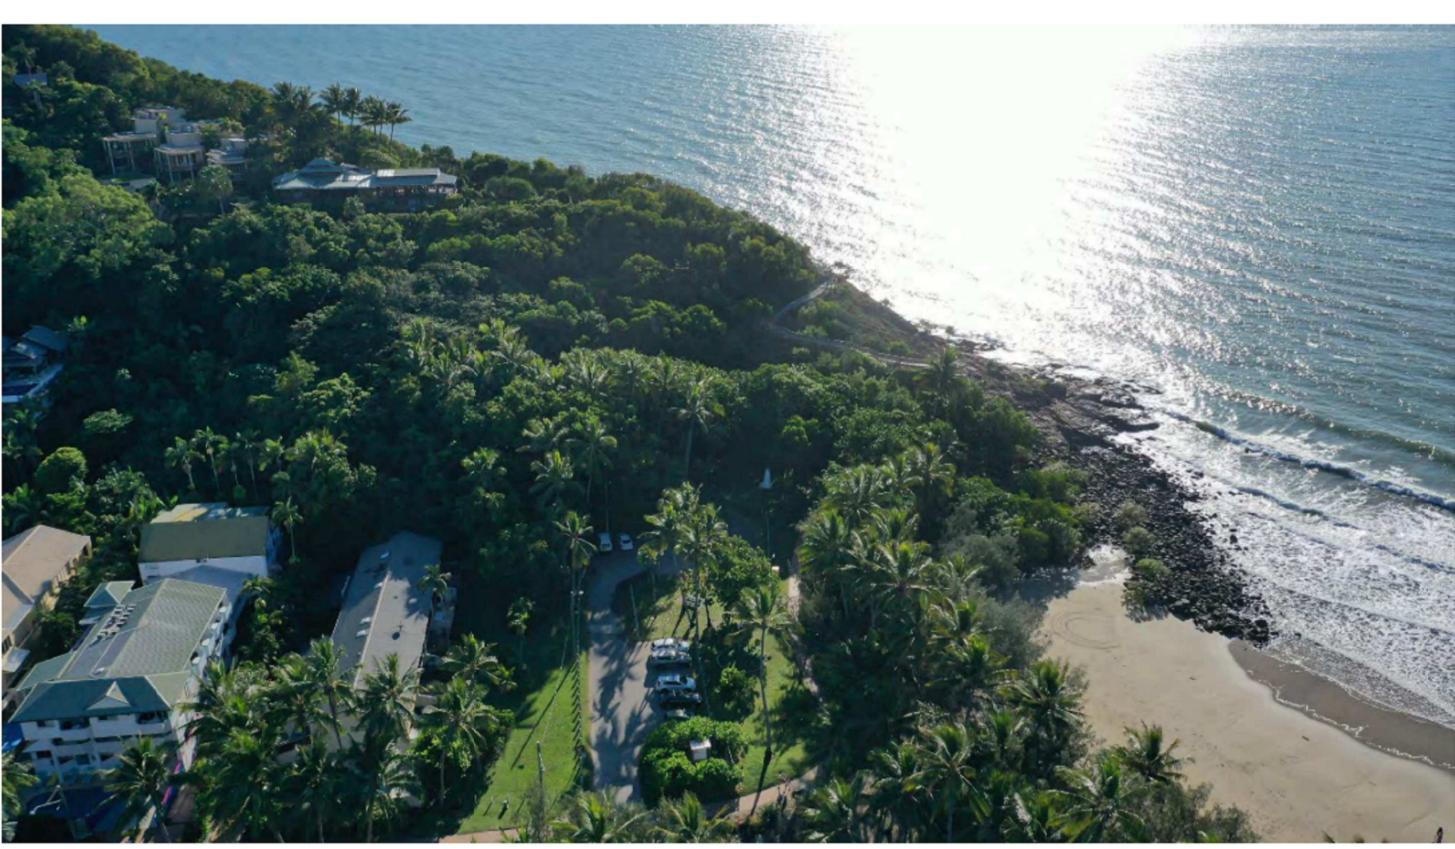
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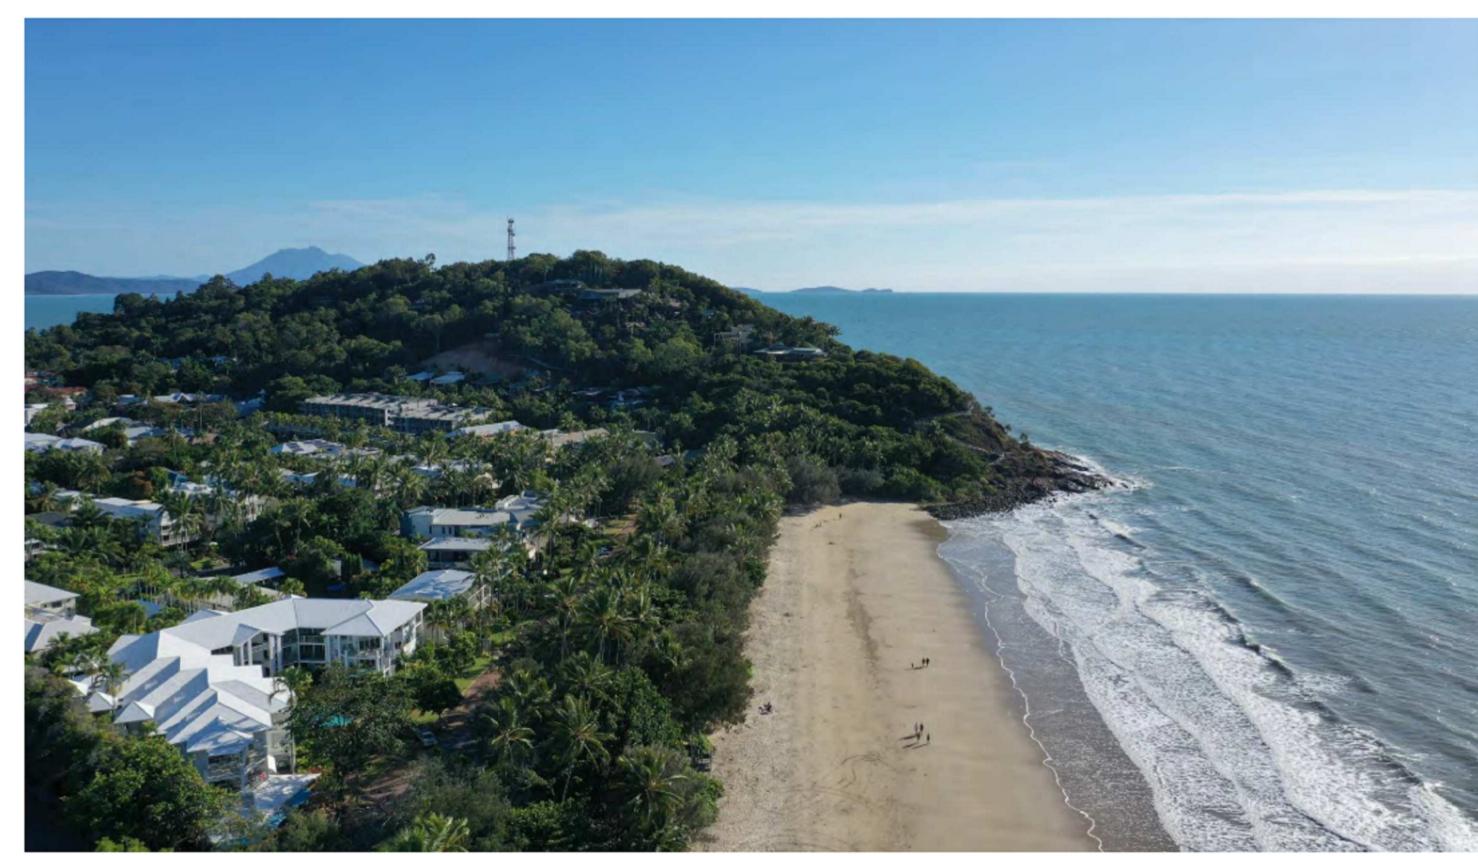
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UAV DRONE POSITION 2 Lat 16.29.1991 Long 145.28.0479

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Project Manager

Structural Engineer

Mechanical Engineer

Fire Engineer

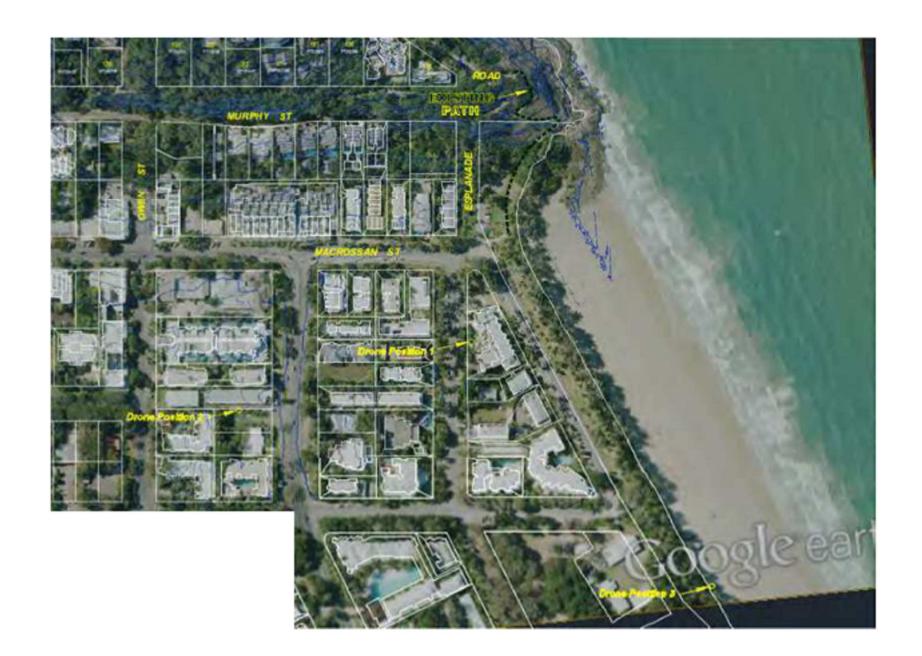Electrical Engineer

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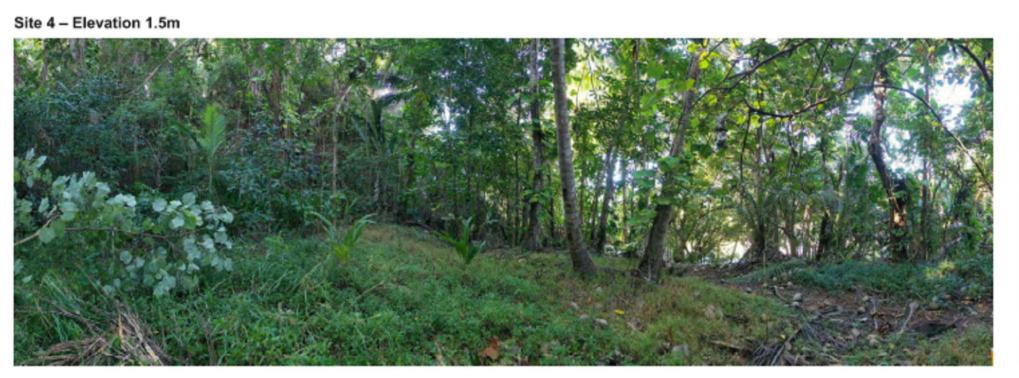
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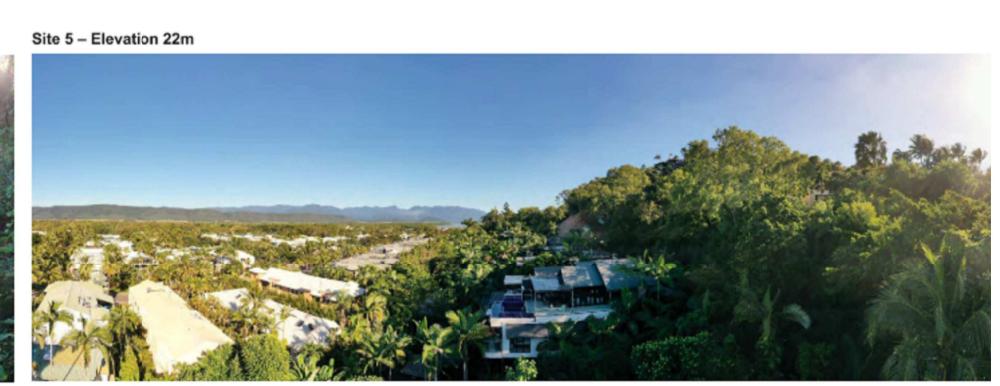












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Notes

Consultants
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Project Manager

Structural Engineer

Mechanical Engineer

Fire Engineer

Electrical Engineer

Client —

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Project Title
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69-73 MURPHY STREET PORT DOUGLAS

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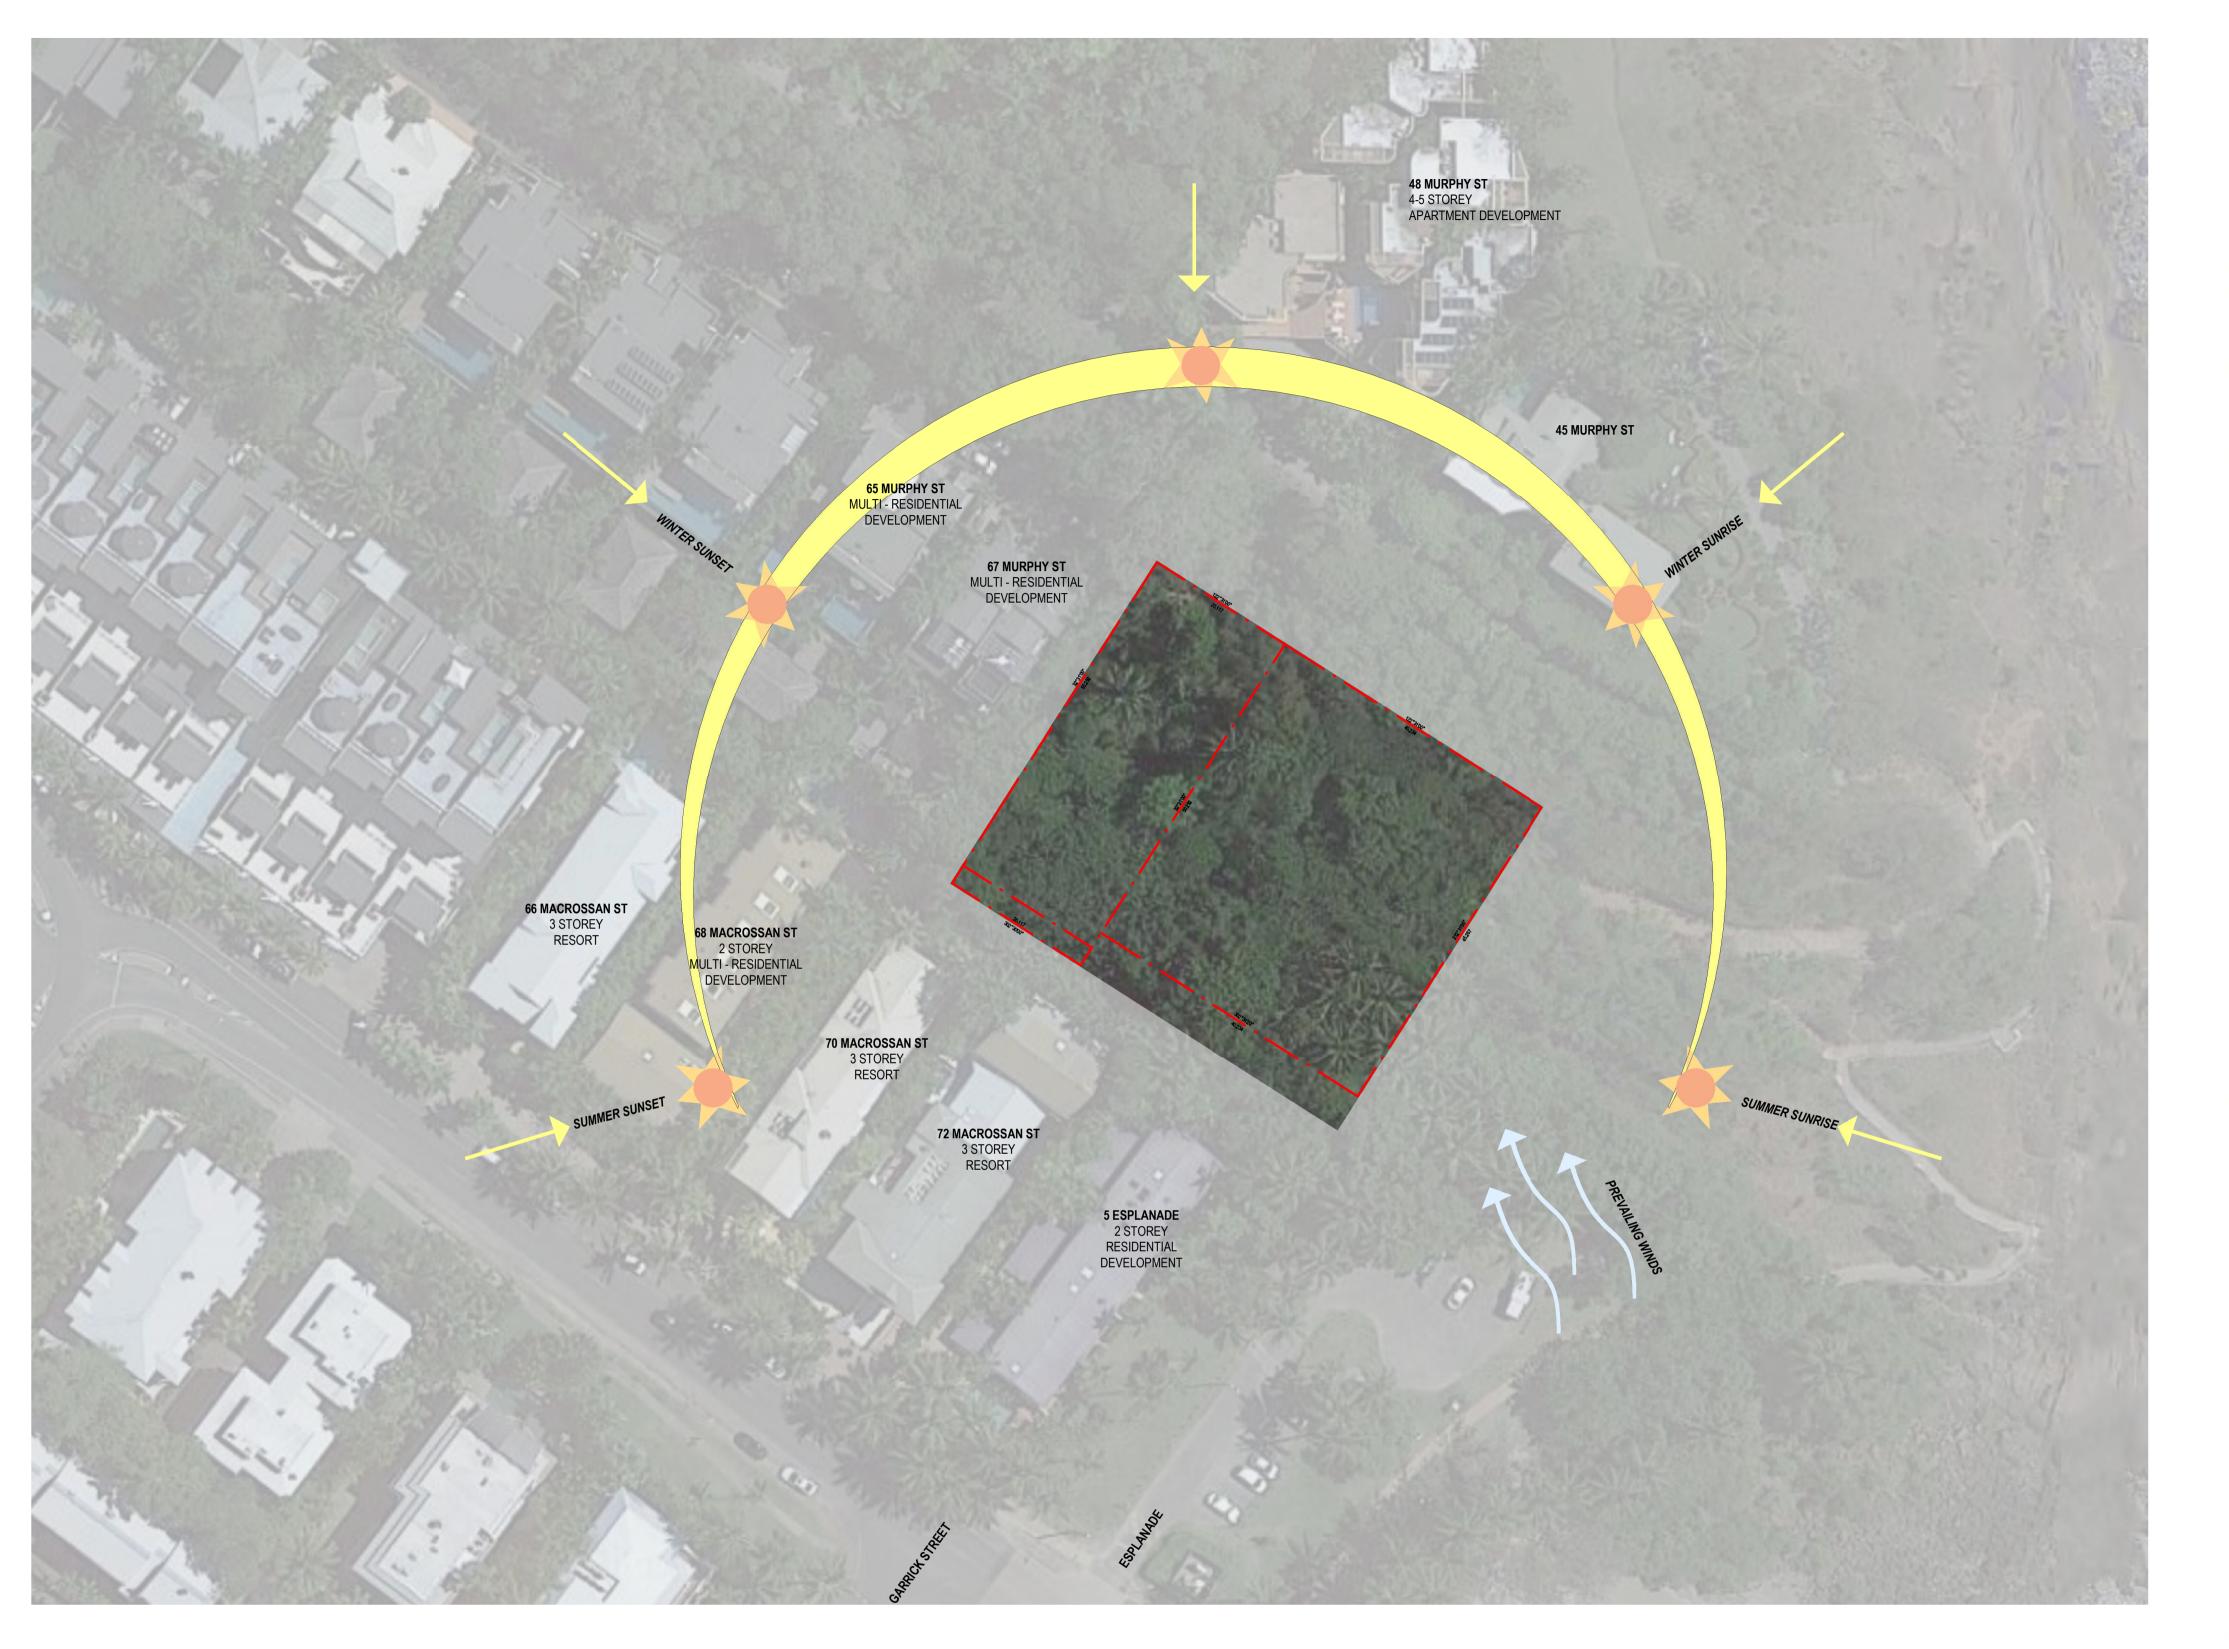
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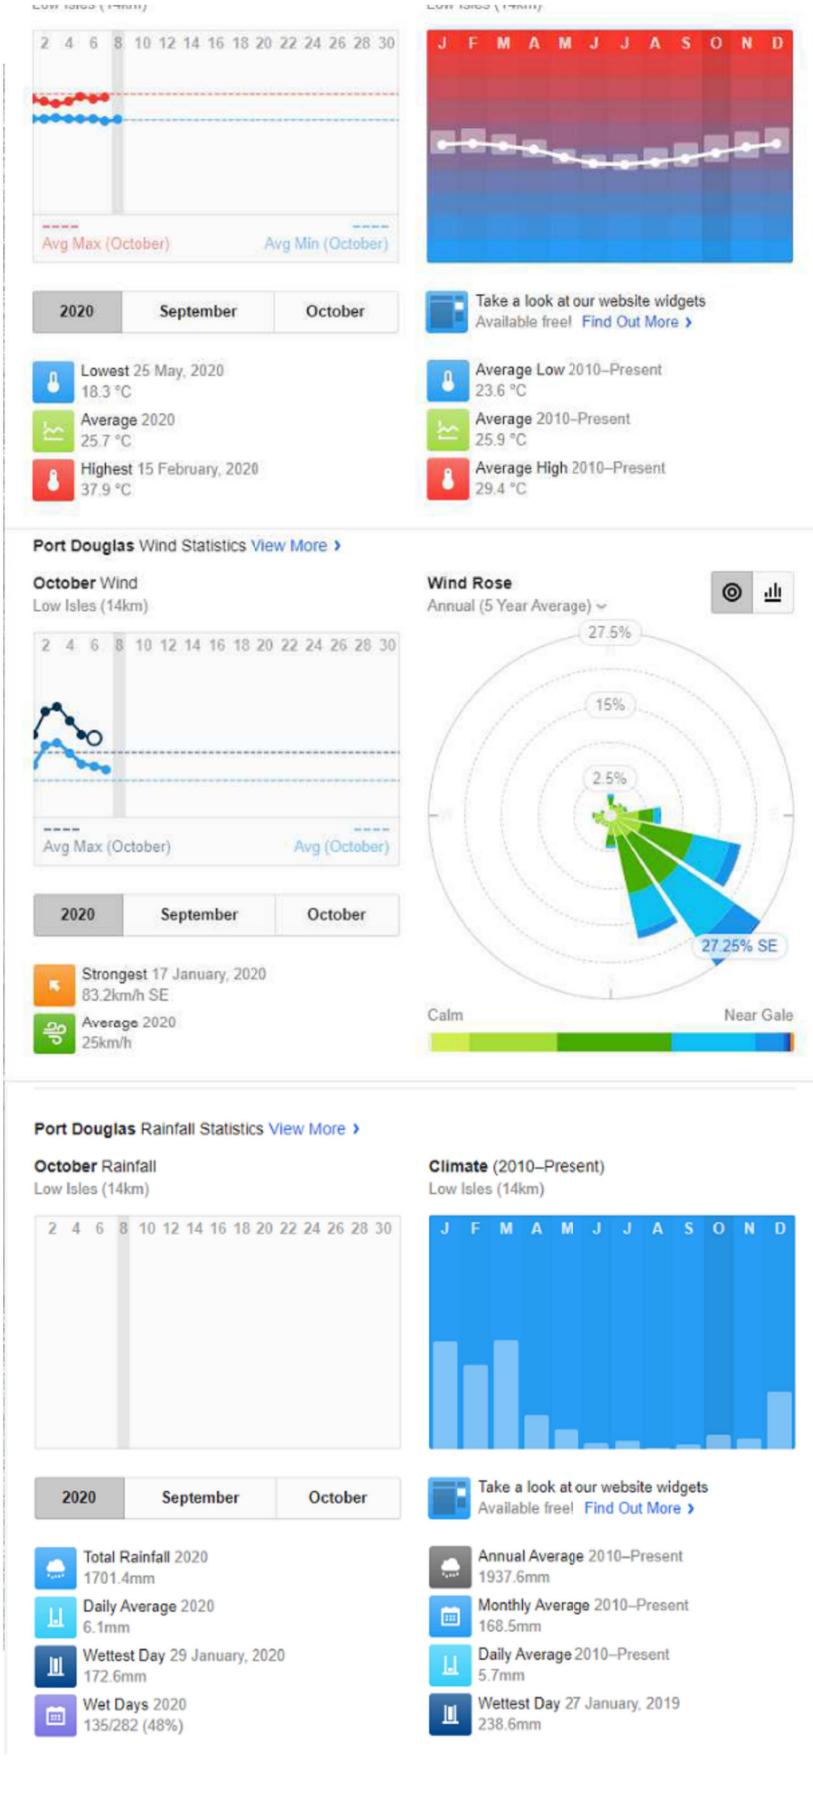
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Project Manager Structural Engineer Mechanical Engineer

Fire Engineer

Electrical Engineer

Consultants

Client **GURNER TM**

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Project Title

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> **Drawing Status** DEVELOPMENT APPLICATION

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Consultants Project Manager

Structural Engineer Mechanical Engineer

Fire Engineer

Electrical Engineer

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Project Title 69-73 MURPHY

STREET PORT DOUGLAS

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Consultants Project Manager

Structural Engineer Mechanical Engineer Fire Engineer

Electrical Engineer

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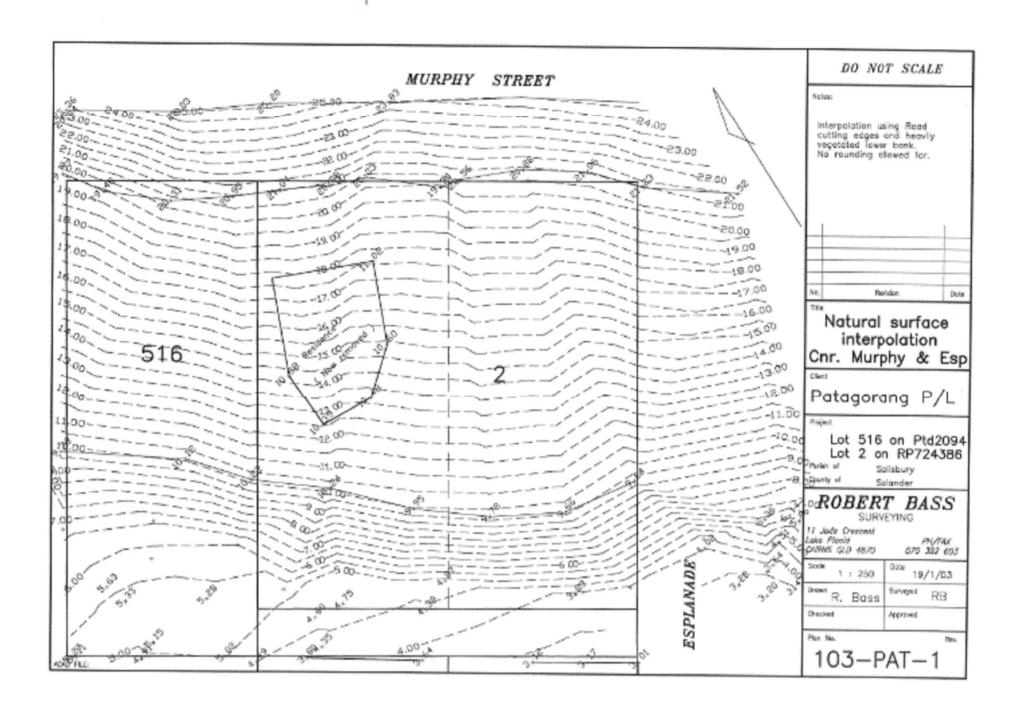
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SITE SURVEY

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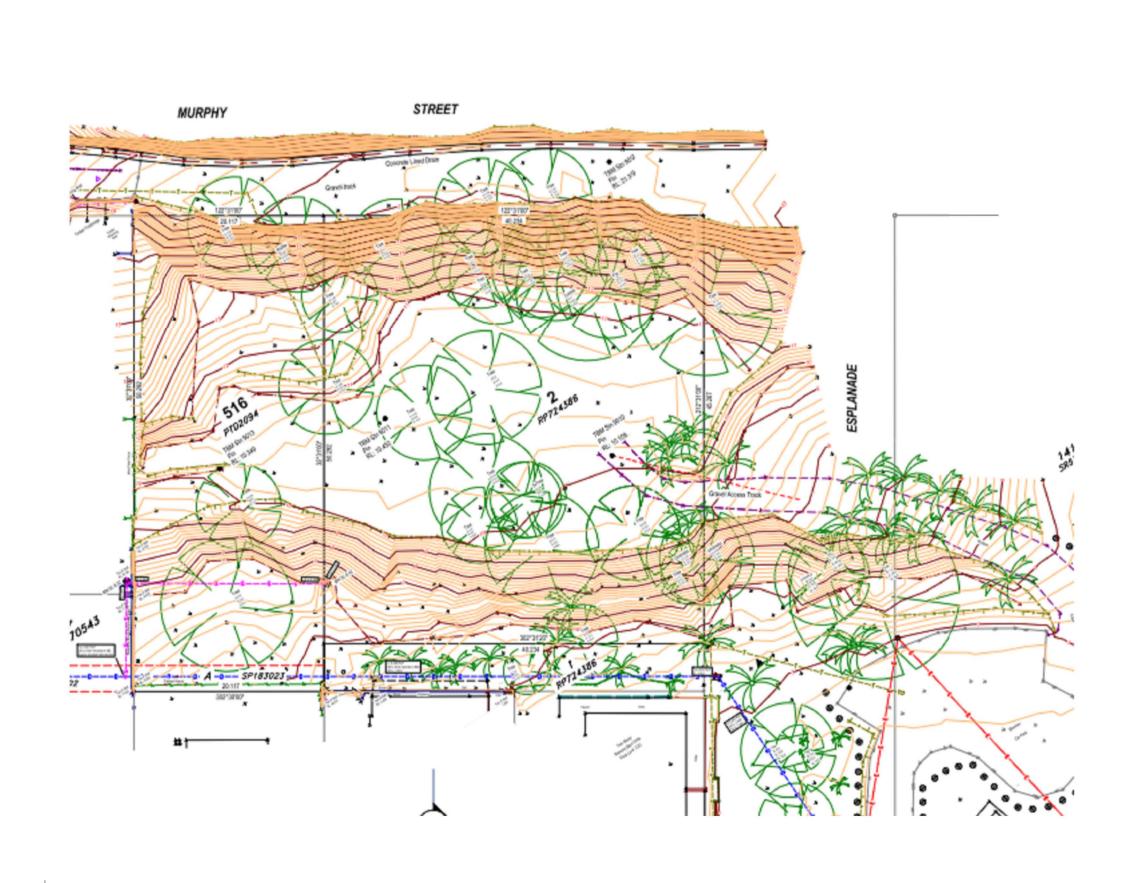
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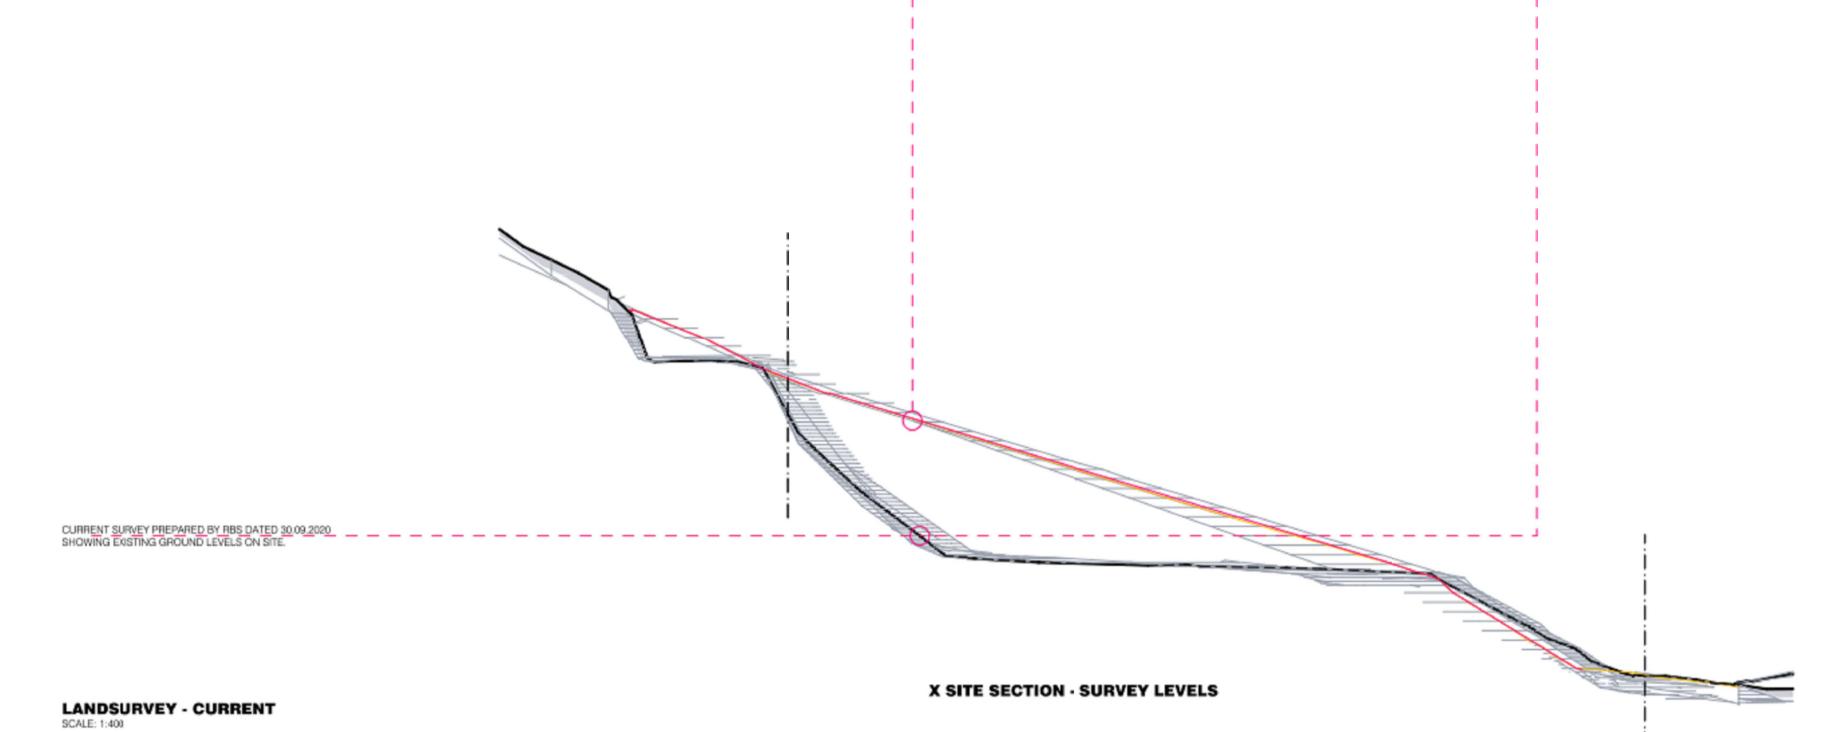












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Consultants

Project Manager

Structural Engineer Mechanical Engineer

Electrical Engineer

Fire Engineer

GURNER TM

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Project Title

INTERPOLATED SURVEY (YELLOW) & CURRENT SURVEY (GREEN)

69-73 MURPHY STREET PORT DOUGLAS

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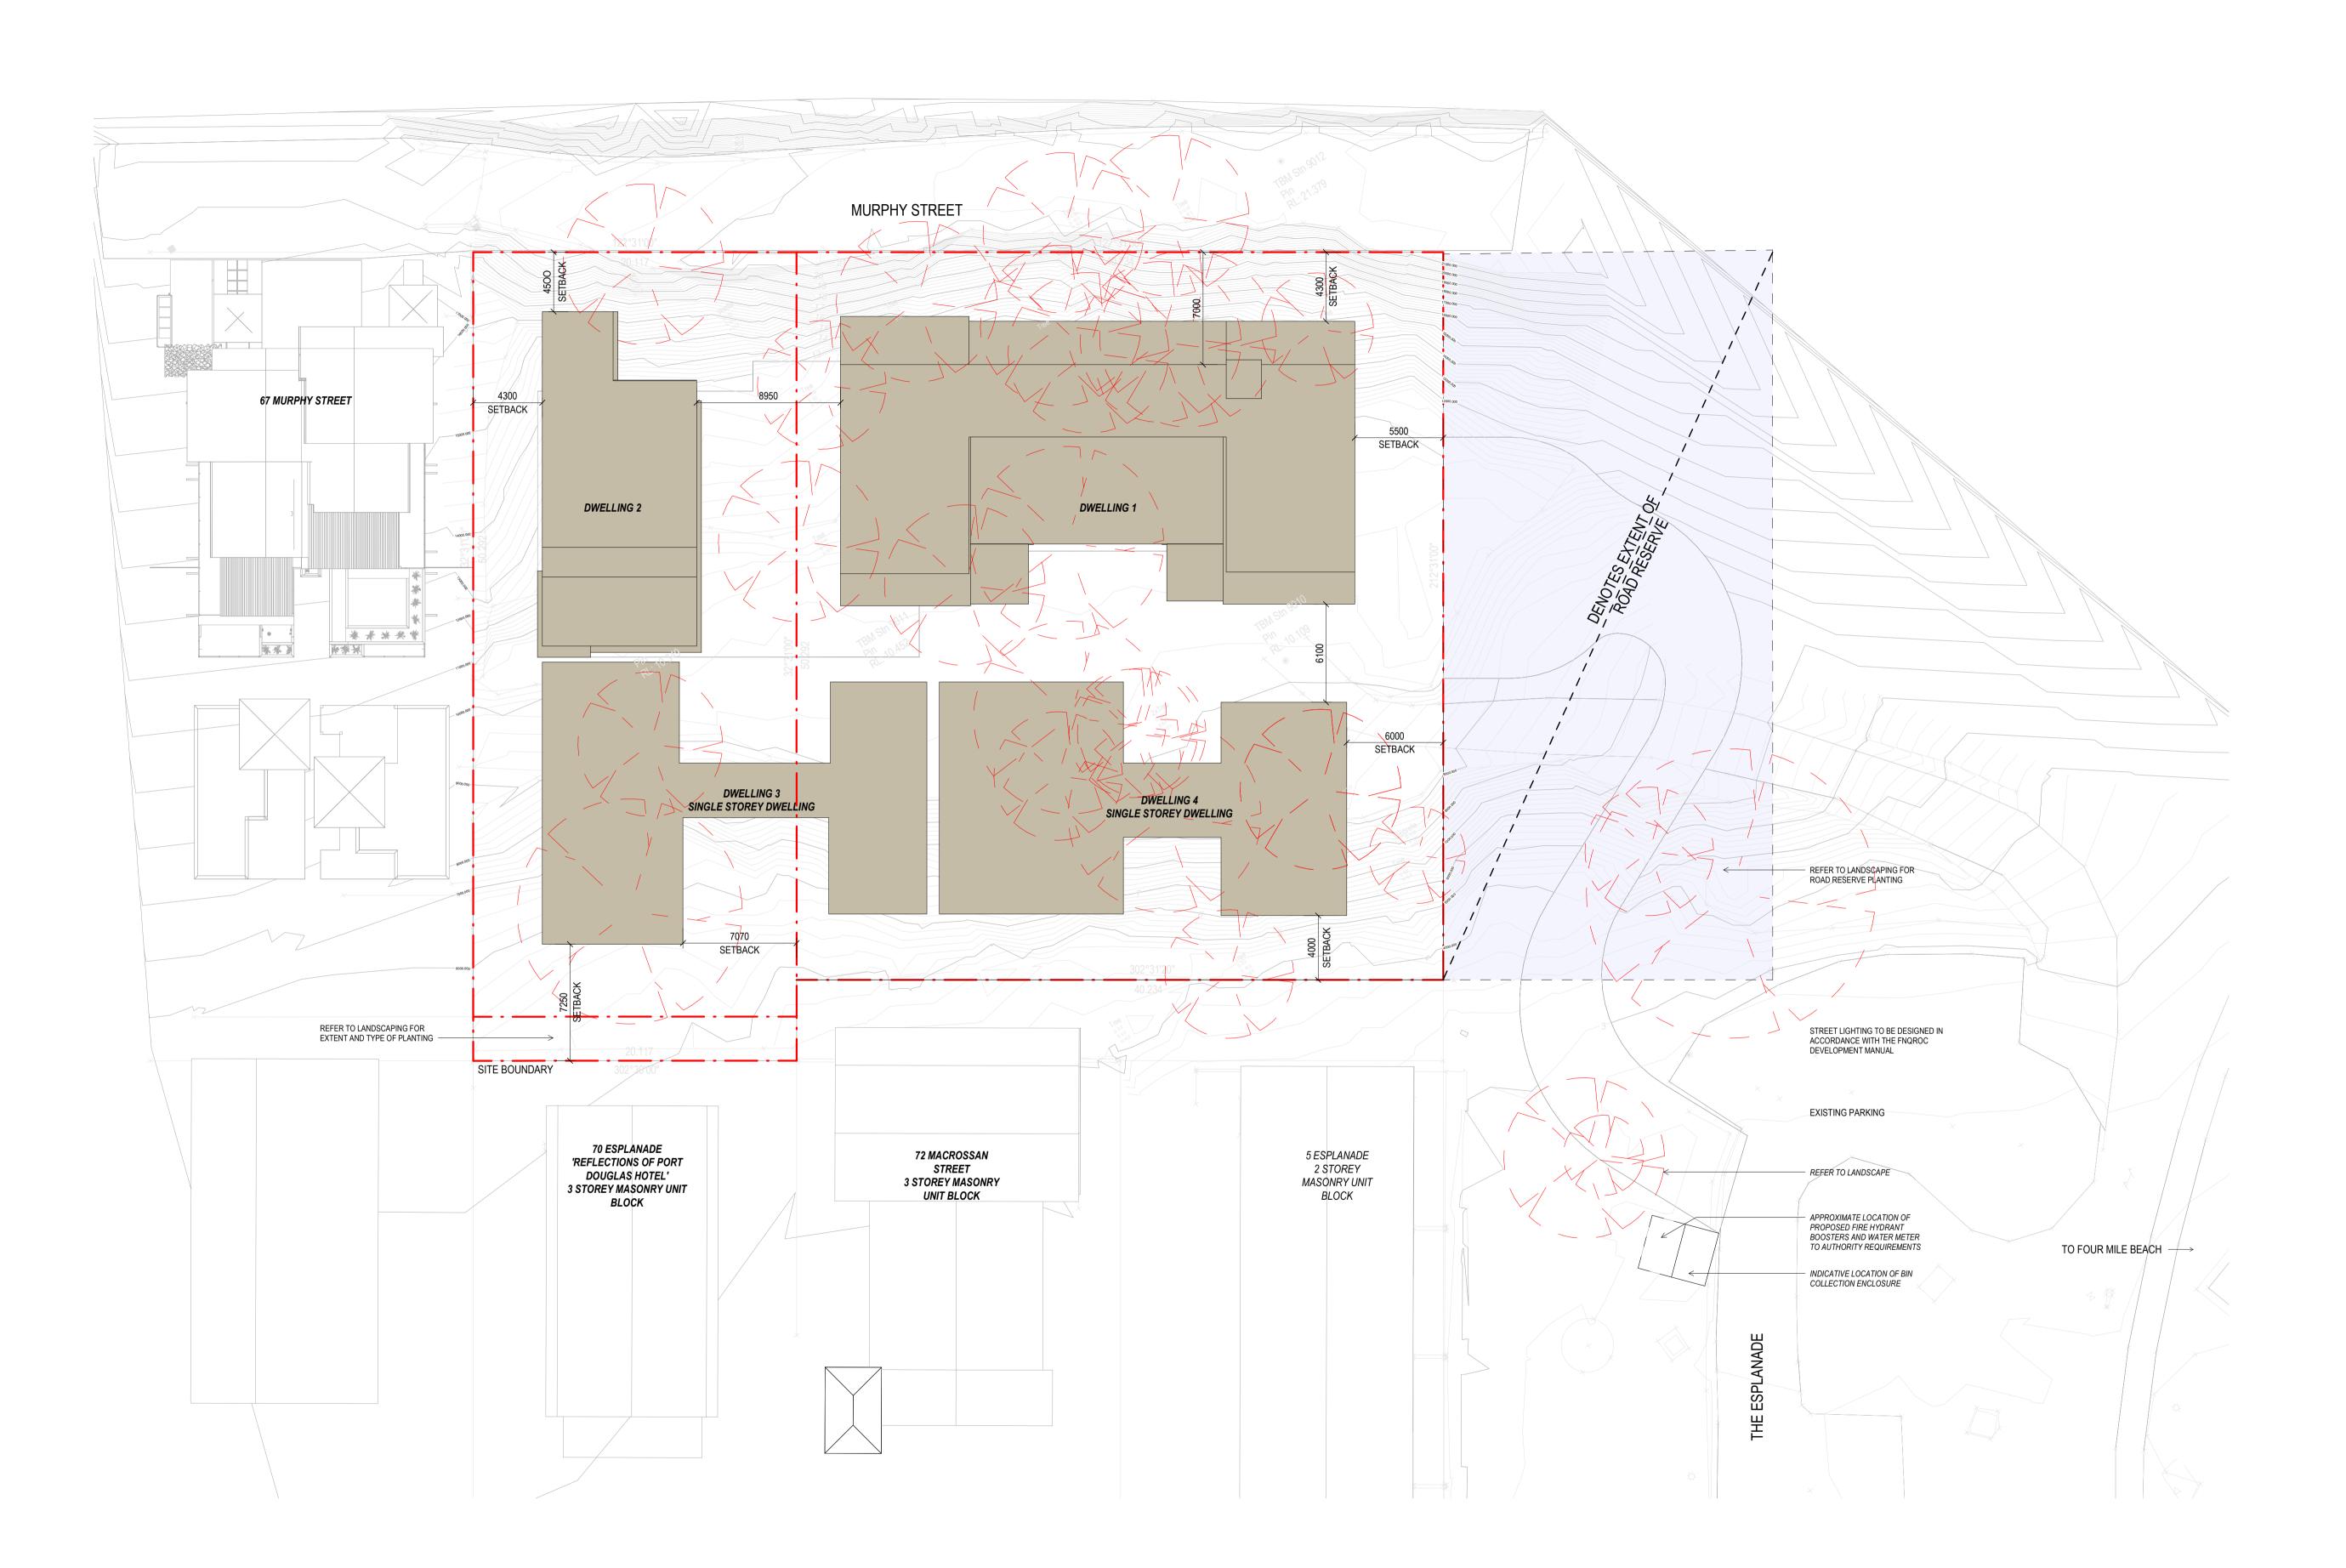
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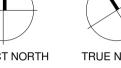
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B 09/09/21 FOR CONSULTANT COORDINATION
C 15/09/21 FOR INFORMATION
D 22/09/21 DRAFT DA
E 04/10/21 ISSUE FOR DA
F 10/03/22 ISSUE RFI 01

Notes







Consultants
—

Project Manager

Structural Engineer

Mechanical Engineer

Fire Engineer

Electrical Engineer

Client

— GURNER TM

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69-73 MURPHY STREET PORT DOUGLAS

Drawing Title —

PROPOSED SITE PLAN

Drawing Status
DEVELOPMENT
APPLICATION
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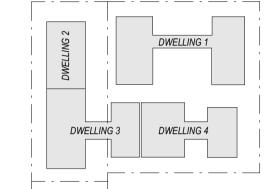
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A 18/02/22 FOR INFORMATION B 10/03/22 ISSUE RFI 01

CODE	DESCRIPTION
BAL-1	FRAMELESS GLAZED BALUSTRADE 1200mm
CON-1	IN-SITU CONCRETE
FEN-1	TIMBER FENCING
GLZ-1/PC-3	CLEAR GLAZING / LIGHT GREY OR SIMILAR
PAV-1	TILED PAVING
PAV-2	COBBLED STONE PAVING OR STAMPED CONCRETE OR SIMILAR
PAV-3	CRUSHED ROCK
REN-1	TEXTURED RENDER FINISH
ST-1	STACKED STONE WALL

TIMBER CLADDING OR FC SHEET, OR







Consultants

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69-73 MURPHY STREET PORT DOUGLAS

Drawing Title
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SITE ACCESS PLAN


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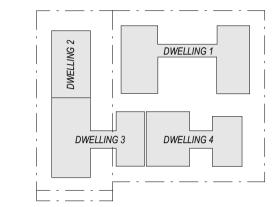
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D 17/09/21 FOR INFORMATION
E 21/09/21 FOR COORDINATION
F 22/09/21 DRAFT DA
G 04/10/21 ISSUE FOR DA
H 18/02/22 FOR INFORMATION

J 10/03/22 ISSUE RFI 01

Notes

CODE	DESCRIPTION
BAL-1	FRAMELESS GLAZED BALUSTRADE
CON-1	IN-SITU CONCRETE
FEN-1	TIMBER FENCING
GLZ-1/PC-3	CLEAR GLAZING / LIGHT GREY OR SIMILAR
PAV-1	TILED PAVING
PAV-2	COBBLED STONE PAVING OR STAMPED CONCRETE OR SIMILAR
PAV-3	CRUSHED ROCK
REN-1	TEXTURED RENDER FINISH
ST-1	STACKED STONE WALL
TC-1	TIMBER CLADDING OR FC SHEET, OR



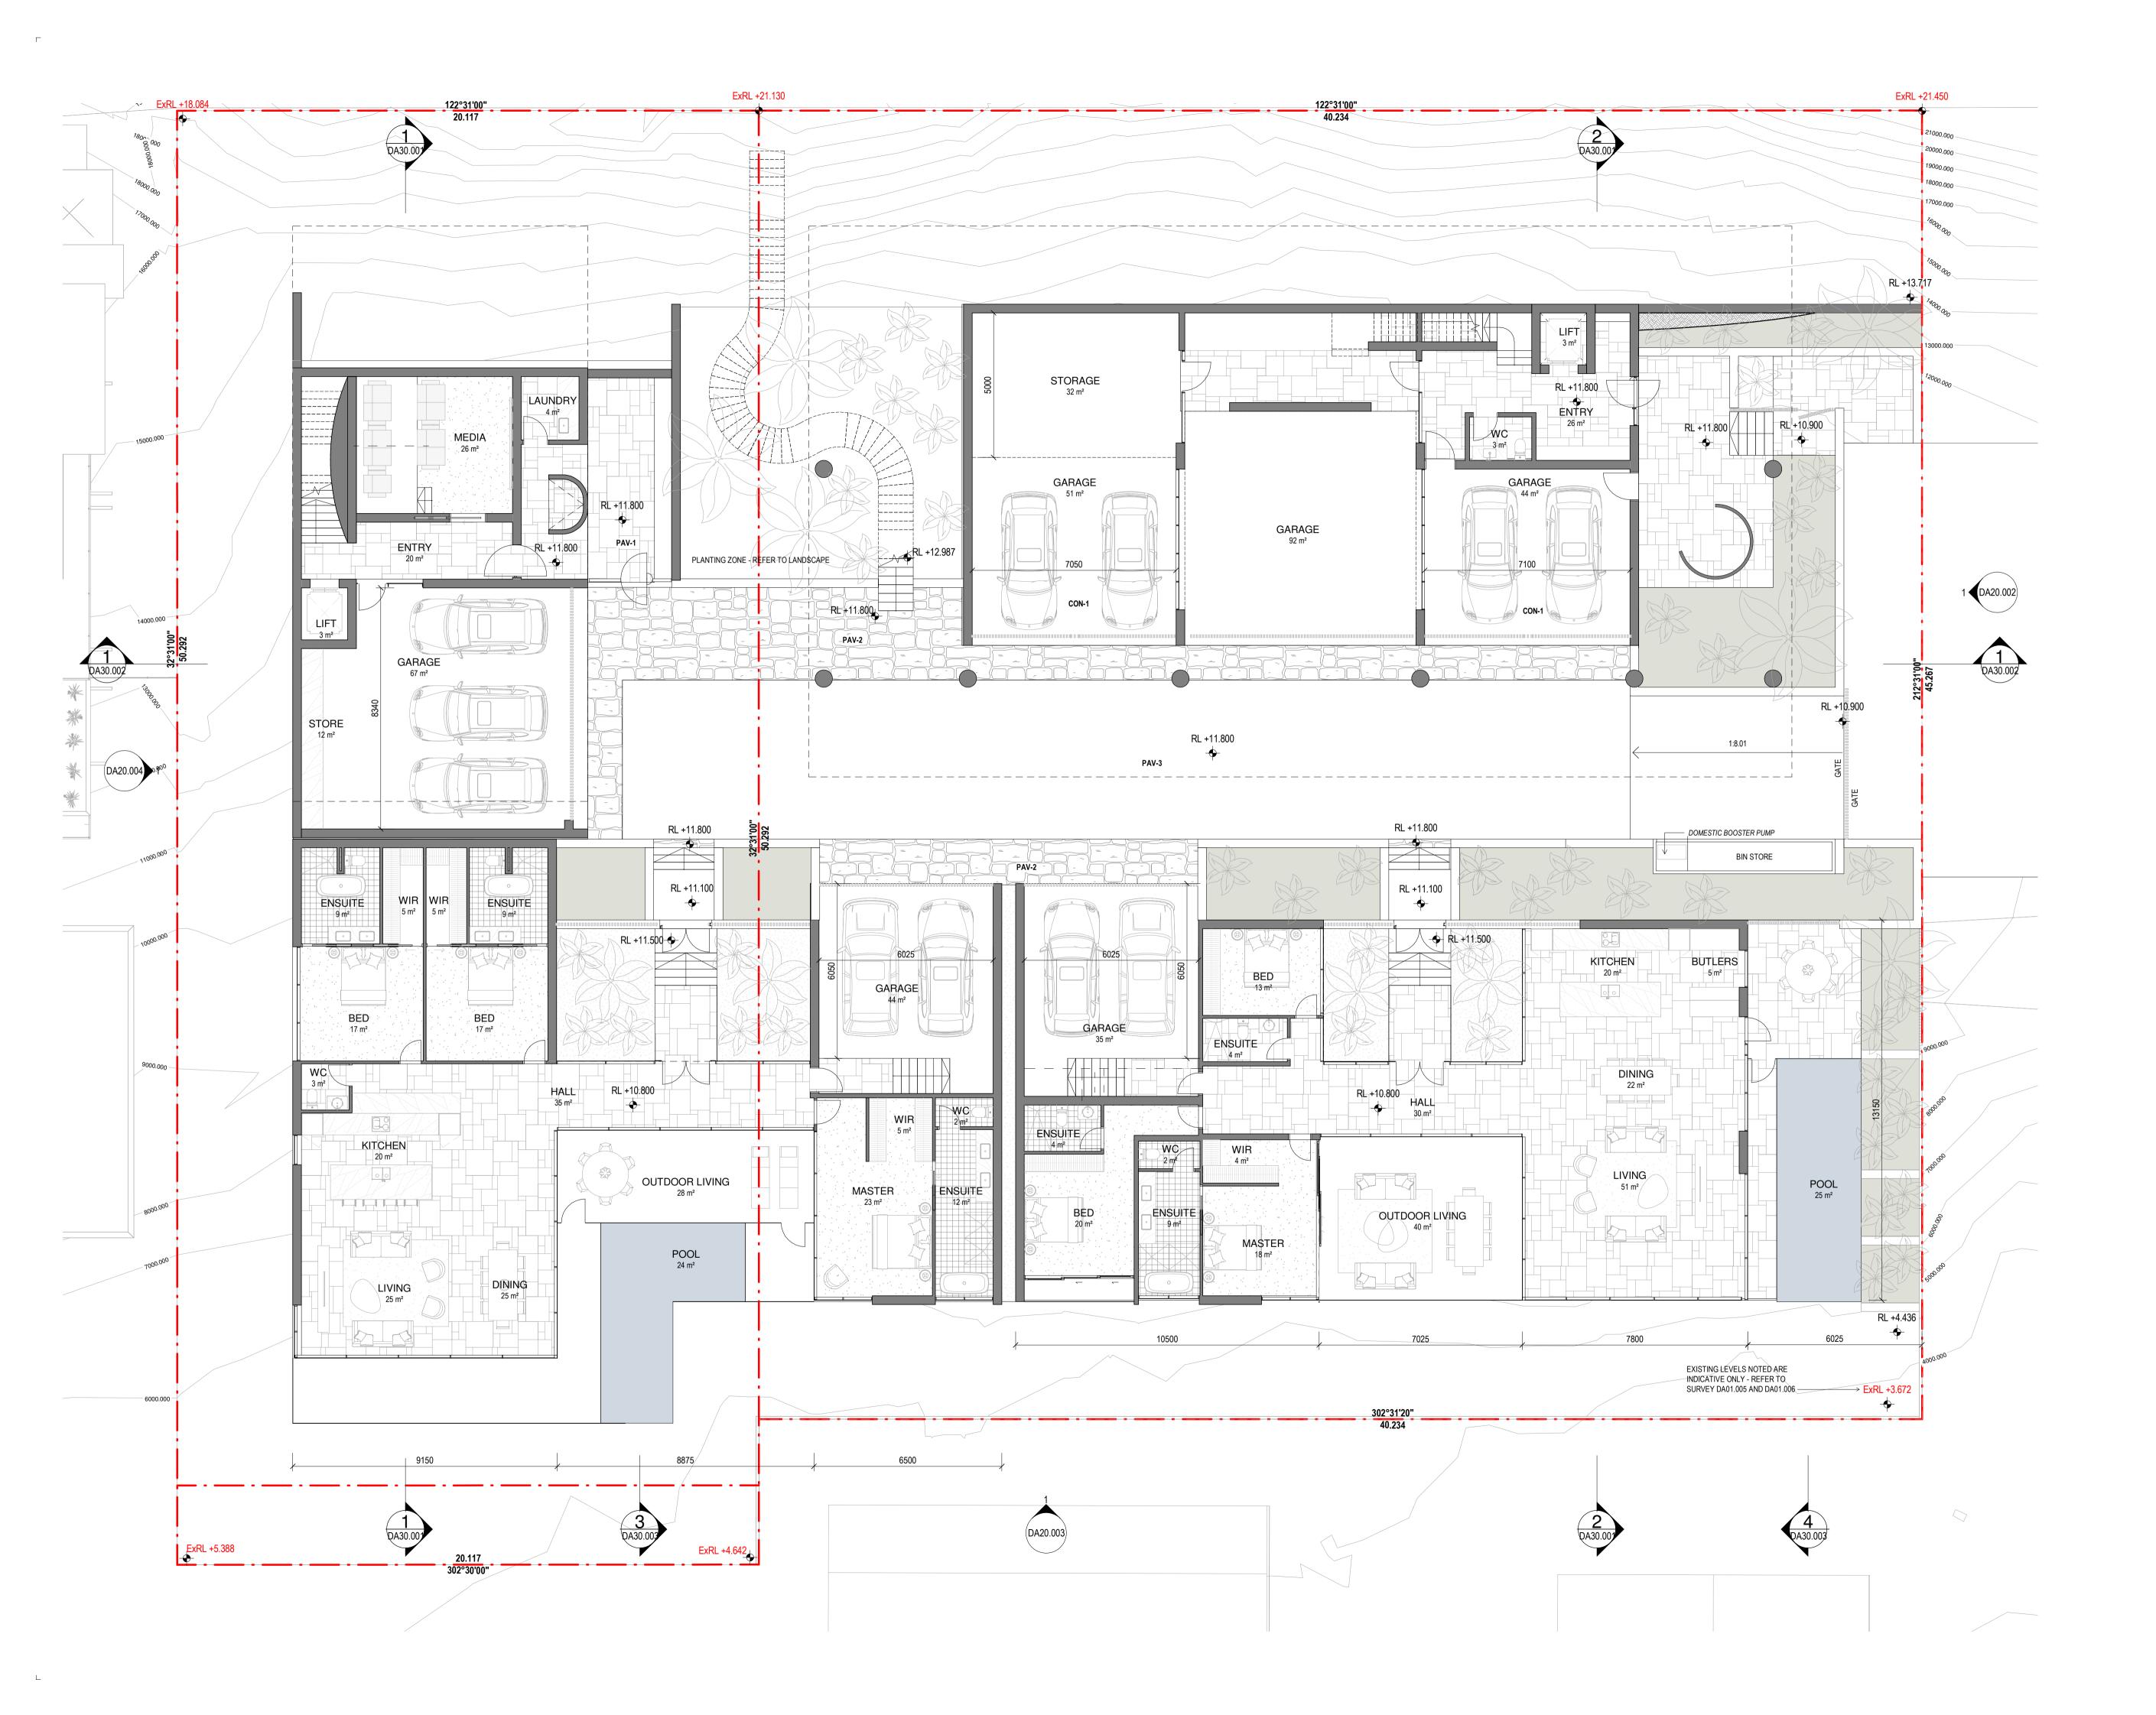

Consultants

Project Manager

Mechanical Engineer

Structural Engineer

Fire Engineer

Electrical Engineer

Client

— GURNER TM

GURNER™

Warren and Mahoney Architects Australia Pty Ltd

Level 4, 141 Flinders Lane Melbourne VIC 3000 Australia Phone + 61 3 8547 6977

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Project Title

69-73 MURPHY STREET PORT DOUGLAS

Drawing Title —

GROUND FLOOR PLAN


Drawing Status DEVELOPMENT APPLICATION Drawing Details

Scale	As indicated@ A1
Date	10/03/22
Job No	9663
Drawn	SG
Checked	ND

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Drawing No



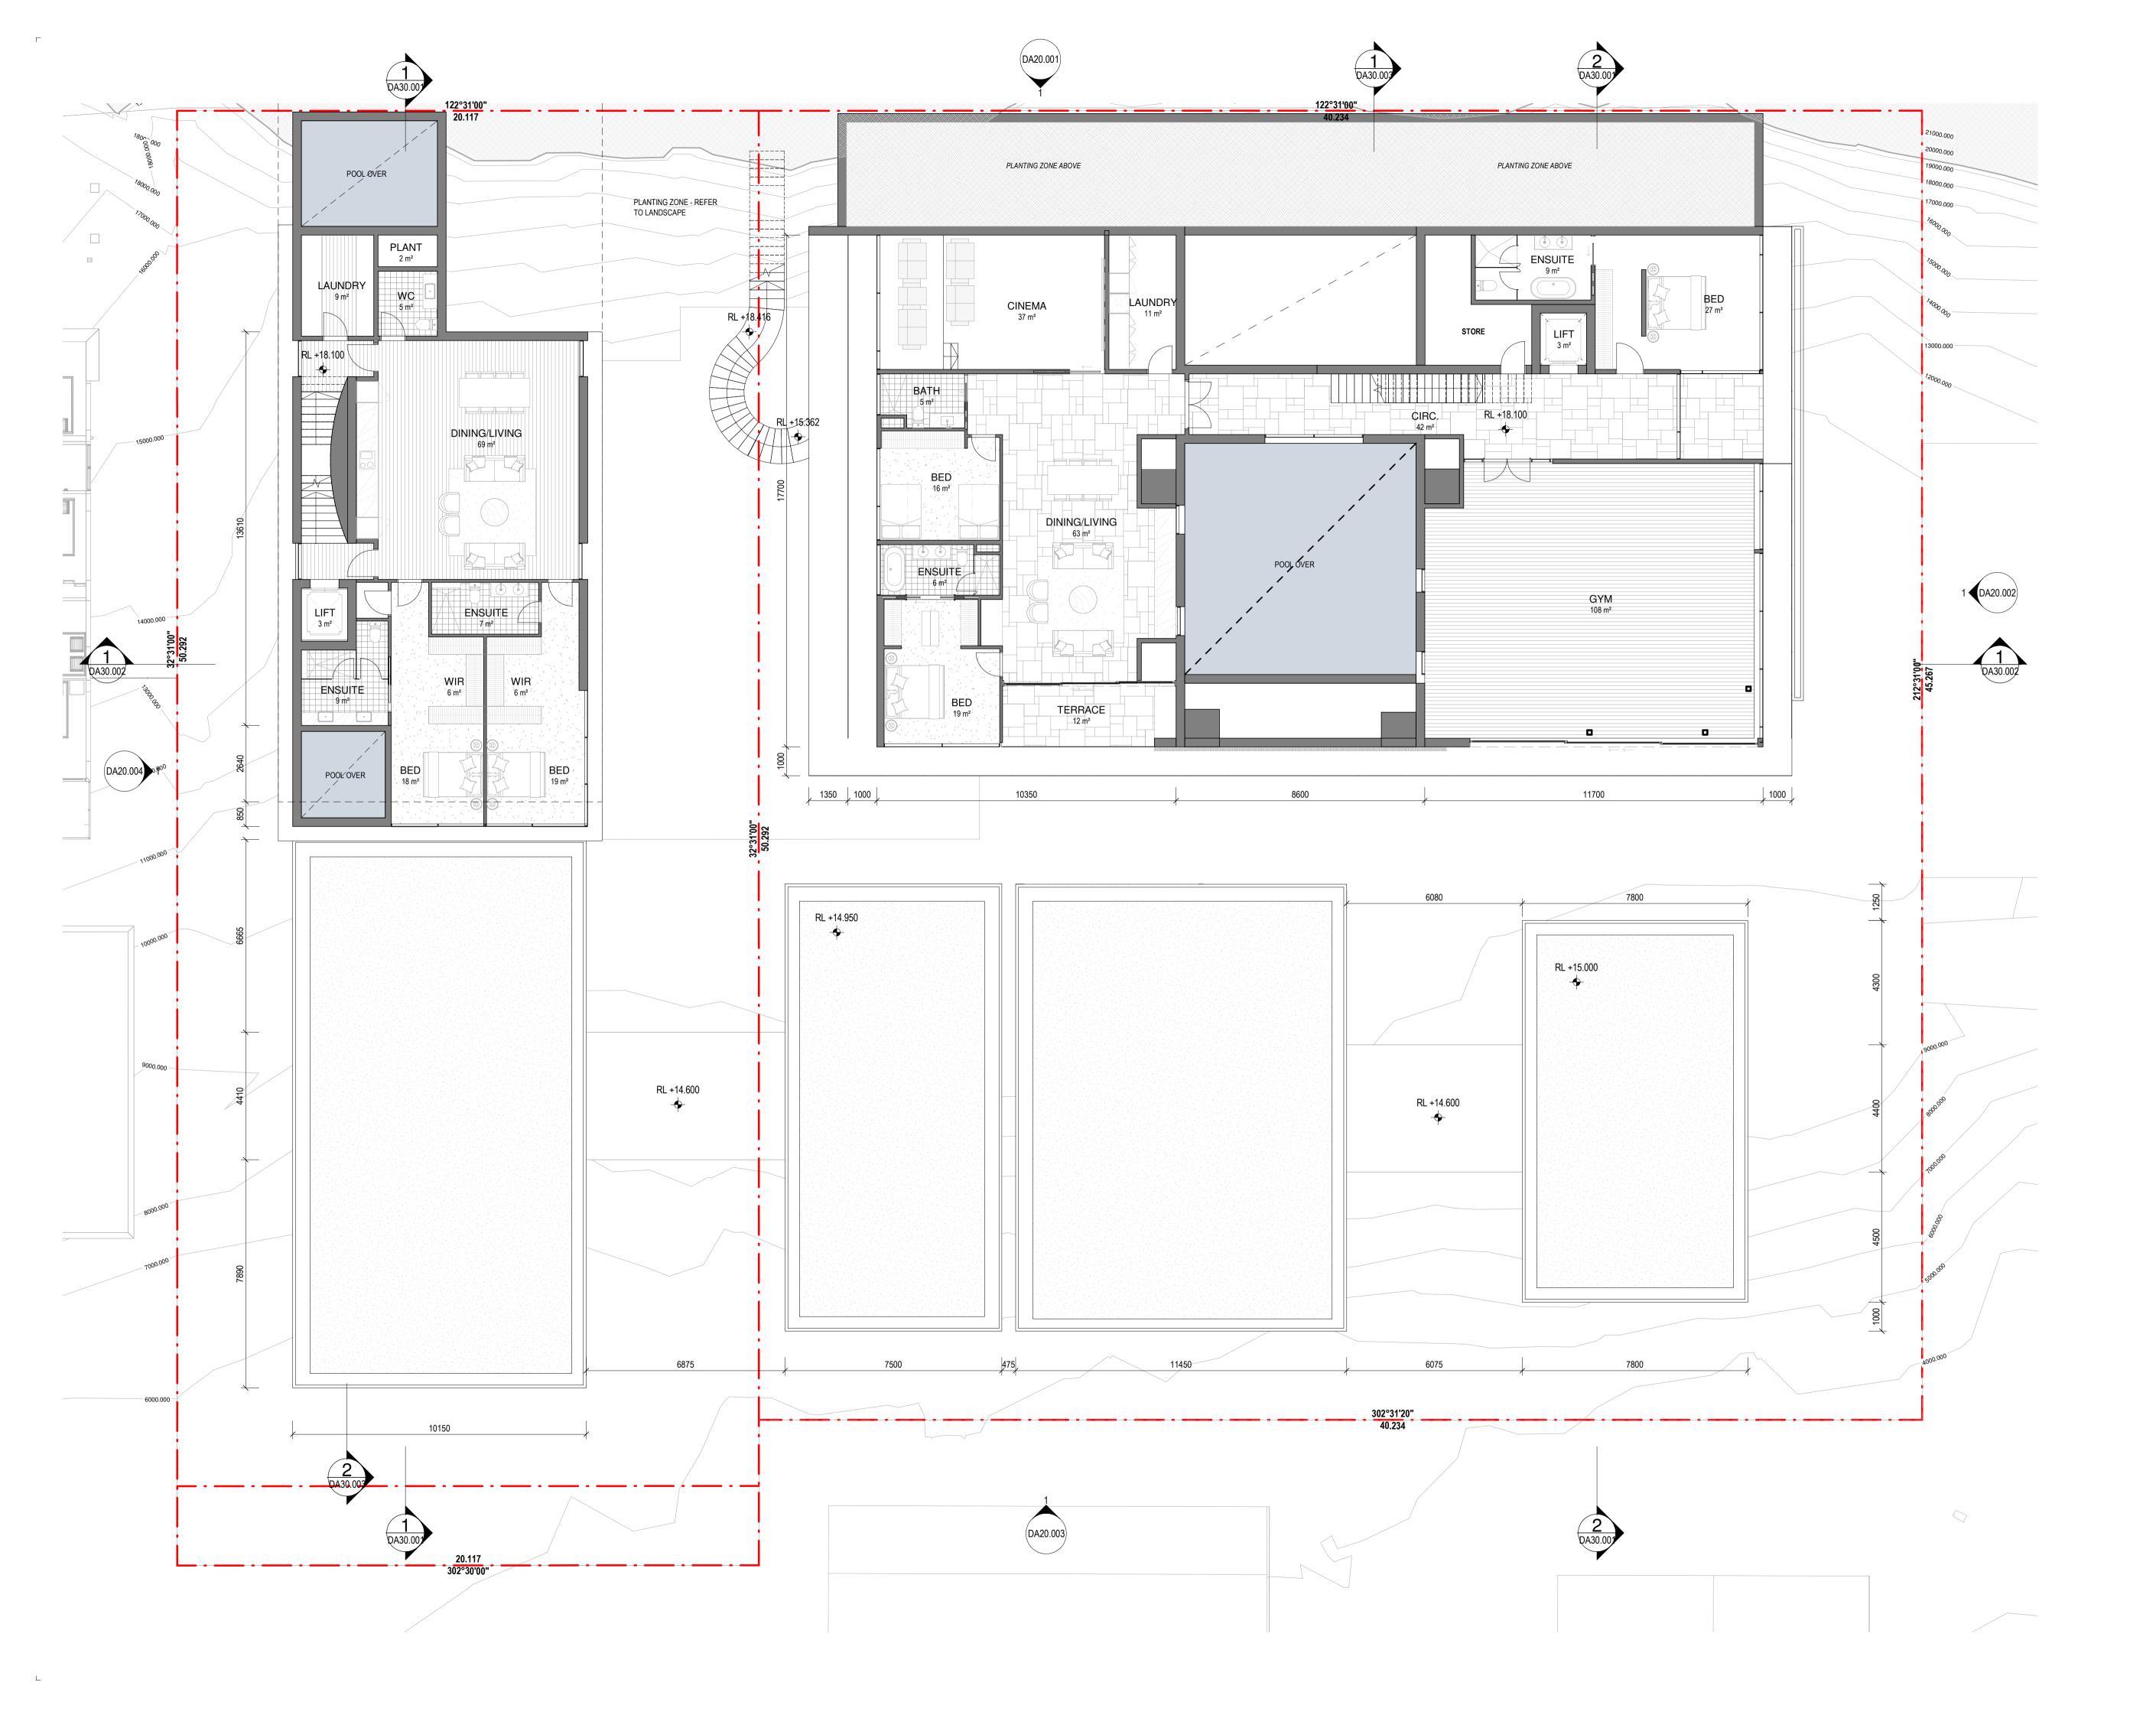


Revisions

B 09/09/21 FOR CONSULTANT COORDINATION
C 15/09/21 FOR INFORMATION
D 17/09/21 FOR INFORMATION
E 21/09/21 FOR COORDINATION
F 22/09/21 DRAFT DA
G 04/10/21 ISSUE FOR DA
H 18/02/22 FOR INFORMATION
J 10/03/22 ISSUE RFI 01

Notes

BAL-1	FRAMELESS GLAZED BALUSTRADE
	1200mm
CON-1	IN-SITU CONCRETE
FEN-1	TIMBER FENCING
GLZ-1/PC-3	CLEAR GLAZING / LIGHT GREY OR SIMILAR
PAV-1	TILED PAVING
PAV-2	COBBLED STONE PAVING OR STAMPED
	CONCRETE OR SIMILAR
PAV-3	CRUSHED ROCK
REN-1	TEXTURED RENDER FINISH
ST-1	STACKED STONE WALL
TC-1	TIMBER CLADDING OR FC SHEET, OR
	SIMILAR

DESCRIPTION

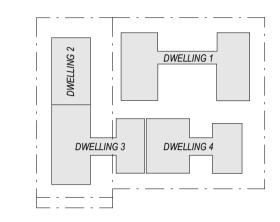





_

Consultants

Project Manager

Structural Engineer

Mechanical Engineer

Fire Engineer

_

Electrical Engineer

Client

— GURNER TM

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Project Title

69-73 MURPHY STREET PORT DOUGLAS

Drawing Title —


L01 FLOOR PLAN

Drawing Status DEVELOPMENT APPLICATION Drawing Details —

Scale	As indicated@ A1
Date	10/03/22
Job No	9663
Drawn	SG
Checked	ND
-	

Drawing No



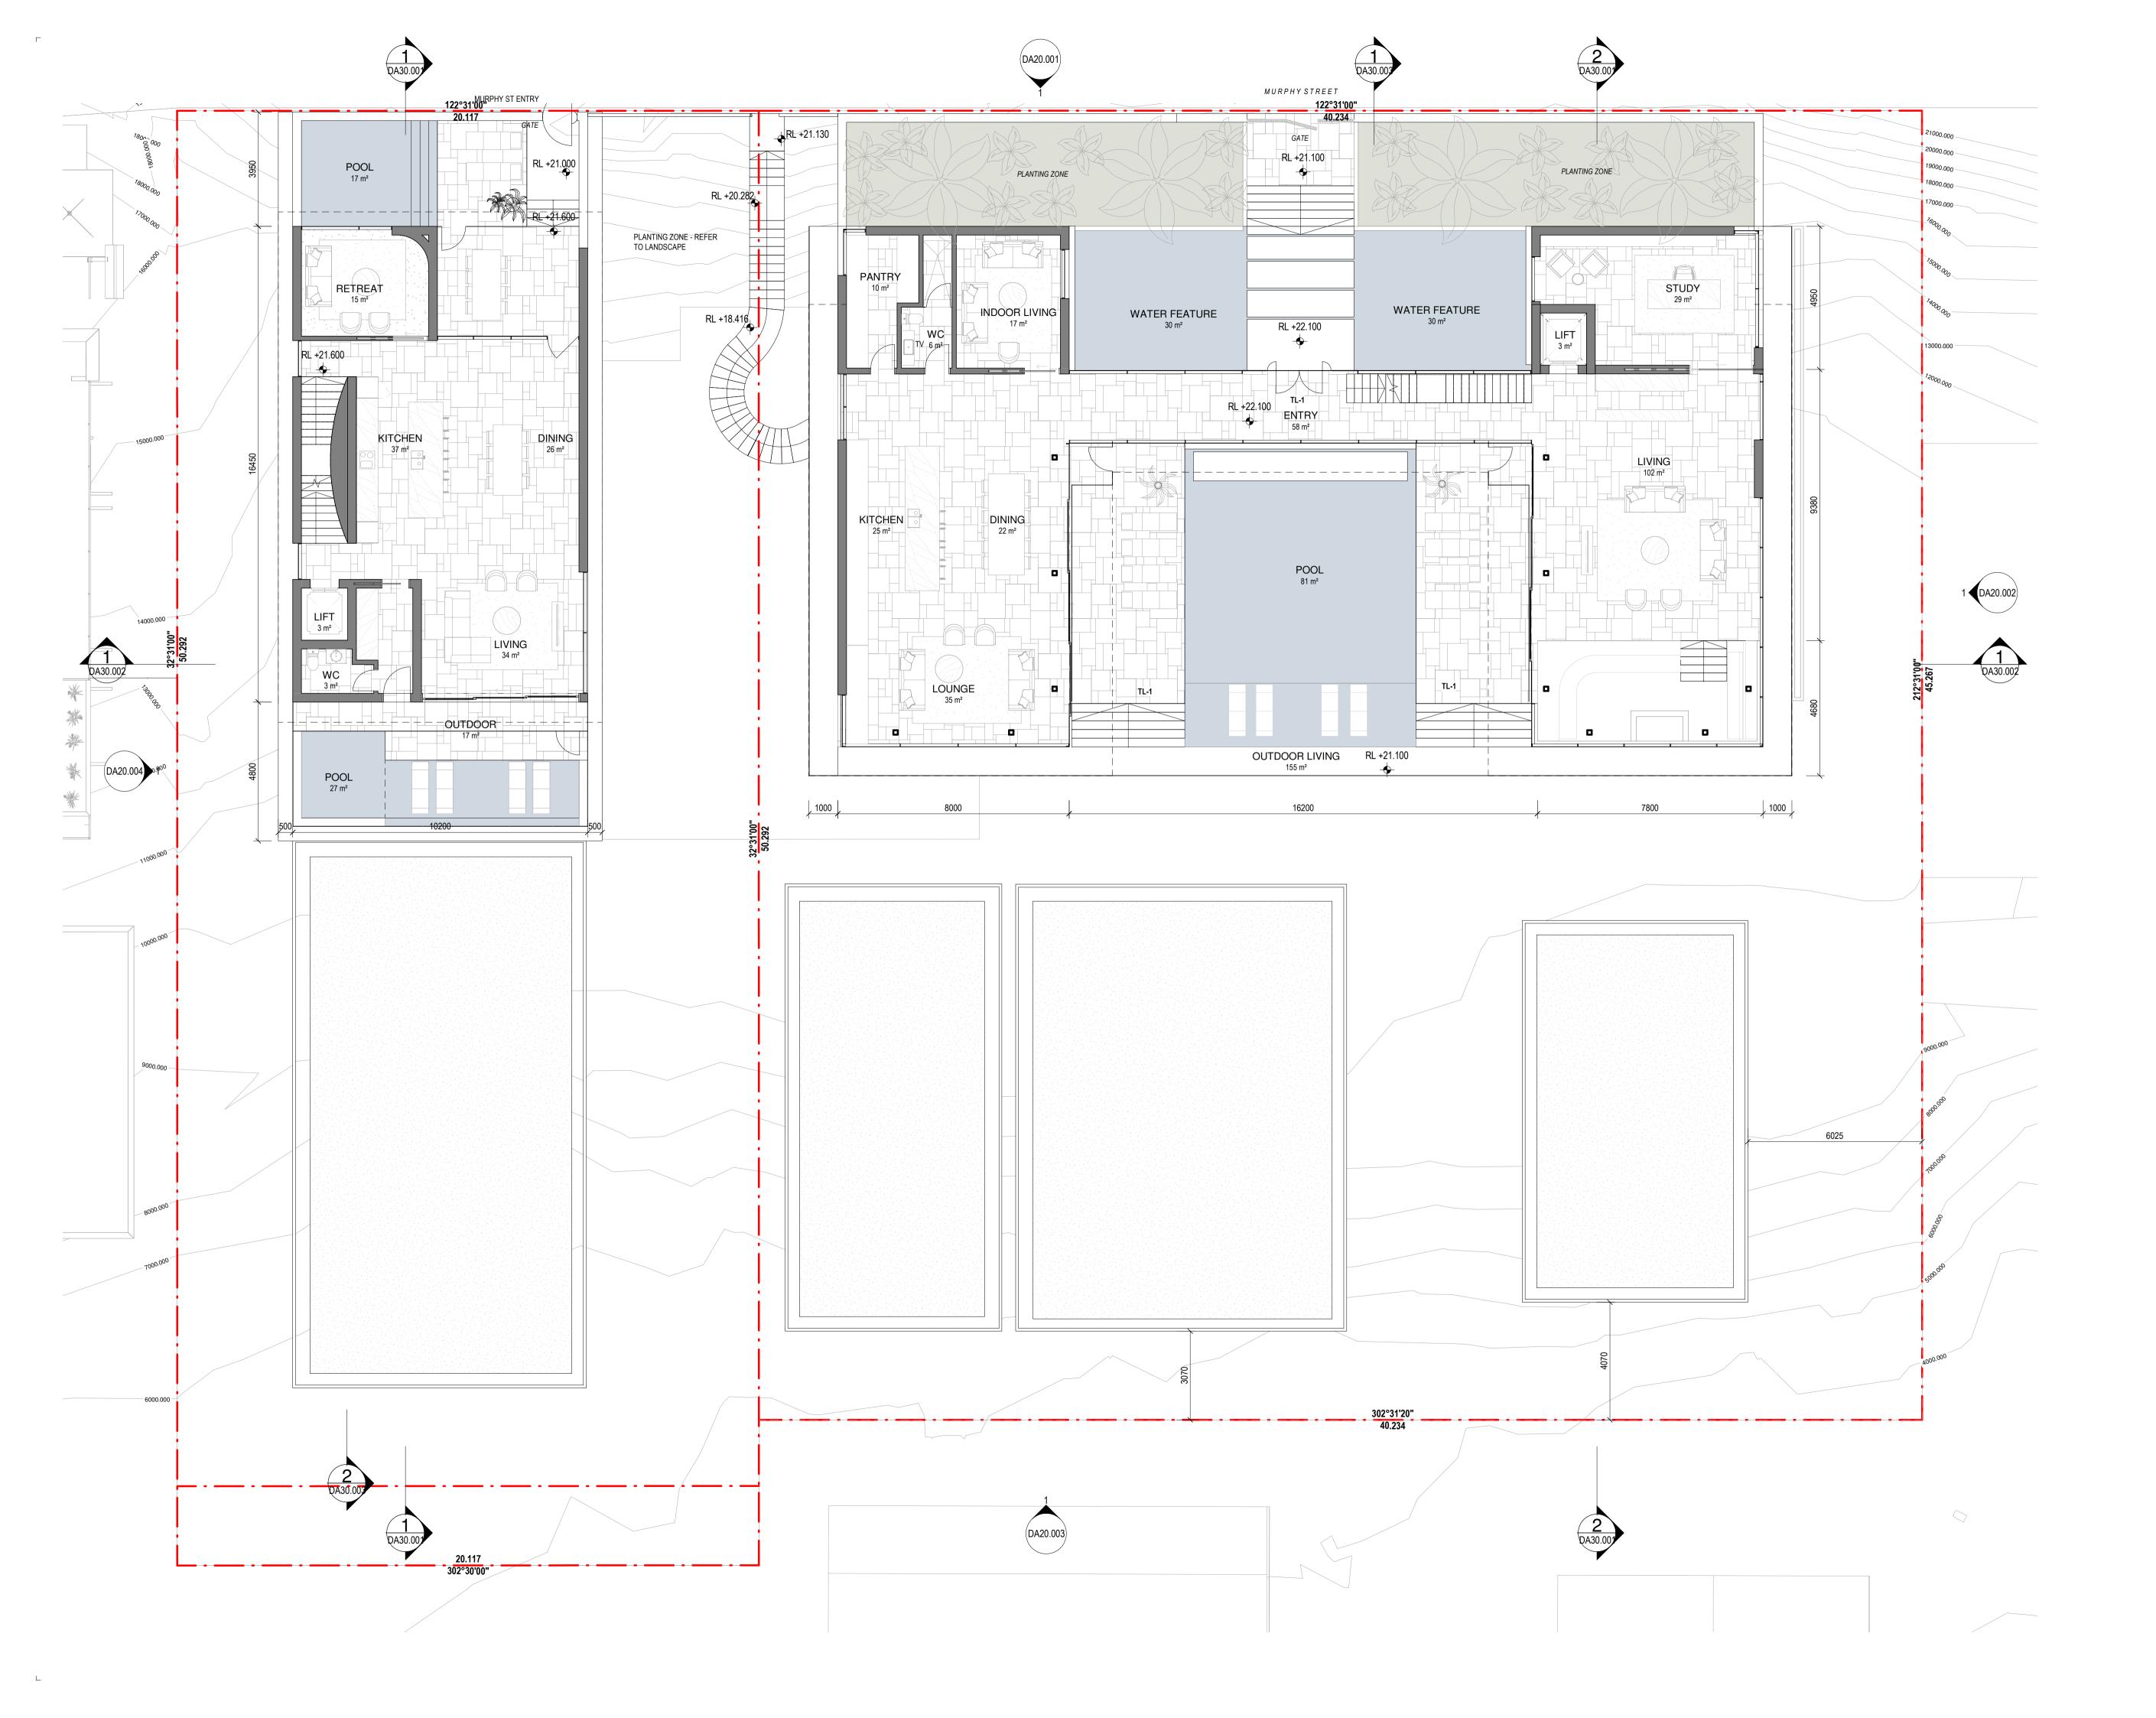


Revisi

B 09/09/21 FOR CONSULTANT COORDINATION
C 15/09/21 FOR INFORMATION
D 17/09/21 FOR INFORMATION
E 21/09/21 FOR COORDINATION
F 22/09/21 DRAFT DA
G 04/10/21 ISSUE FOR DA
H 18/02/22 FOR INFORMATION
J 10/03/22 ISSUE RFI 01

Notes

FRAMELESS GLAZED BALUSTRADE 1200mm	
IN-SITU CONCRETE	
TIMBER FENCING	
CLEAR GLAZING / LIGHT GREY OR SIMILAR	
TILED PAVING	
COBBLED STONE PAVING OR STAMPED CONCRETE OR SIMILAR	
CRUSHED ROCK	
TEXTURED RENDER FINISH	
STACKED STONE WALL	
TIMBER CLADDING OR FC SHEET, OR SIMILAR	
	1200mm IN-SITU CONCRETE TIMBER FENCING CLEAR GLAZING / LIGHT GREY OR SIMILAR TILED PAVING COBBLED STONE PAVING OR STAMPED CONCRETE OR SIMILAR CRUSHED ROCK TEXTURED RENDER FINISH STACKED STONE WALL TIMBER CLADDING OR FC SHEET, OR

DESCRIPTION

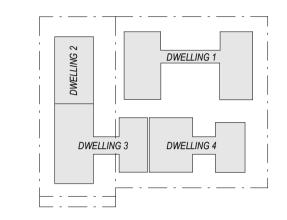





Project Manager

Structural Engineer

Mechanical Engineer

Fire Engineer

Electrical Engineer

Client

—

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GURNER TM

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69-73 MURPHY STREET PORT DOUGLAS

Drawing Title
—

Project Title


L02 FLOOR PLAN

Drawing Status DEVELOPMENT APPLICATION Drawing Details —

Scale	As indicated@ A1
Date	10/03/22
Job No	9663
Drawn	SG
Checked	ND

Drawing No



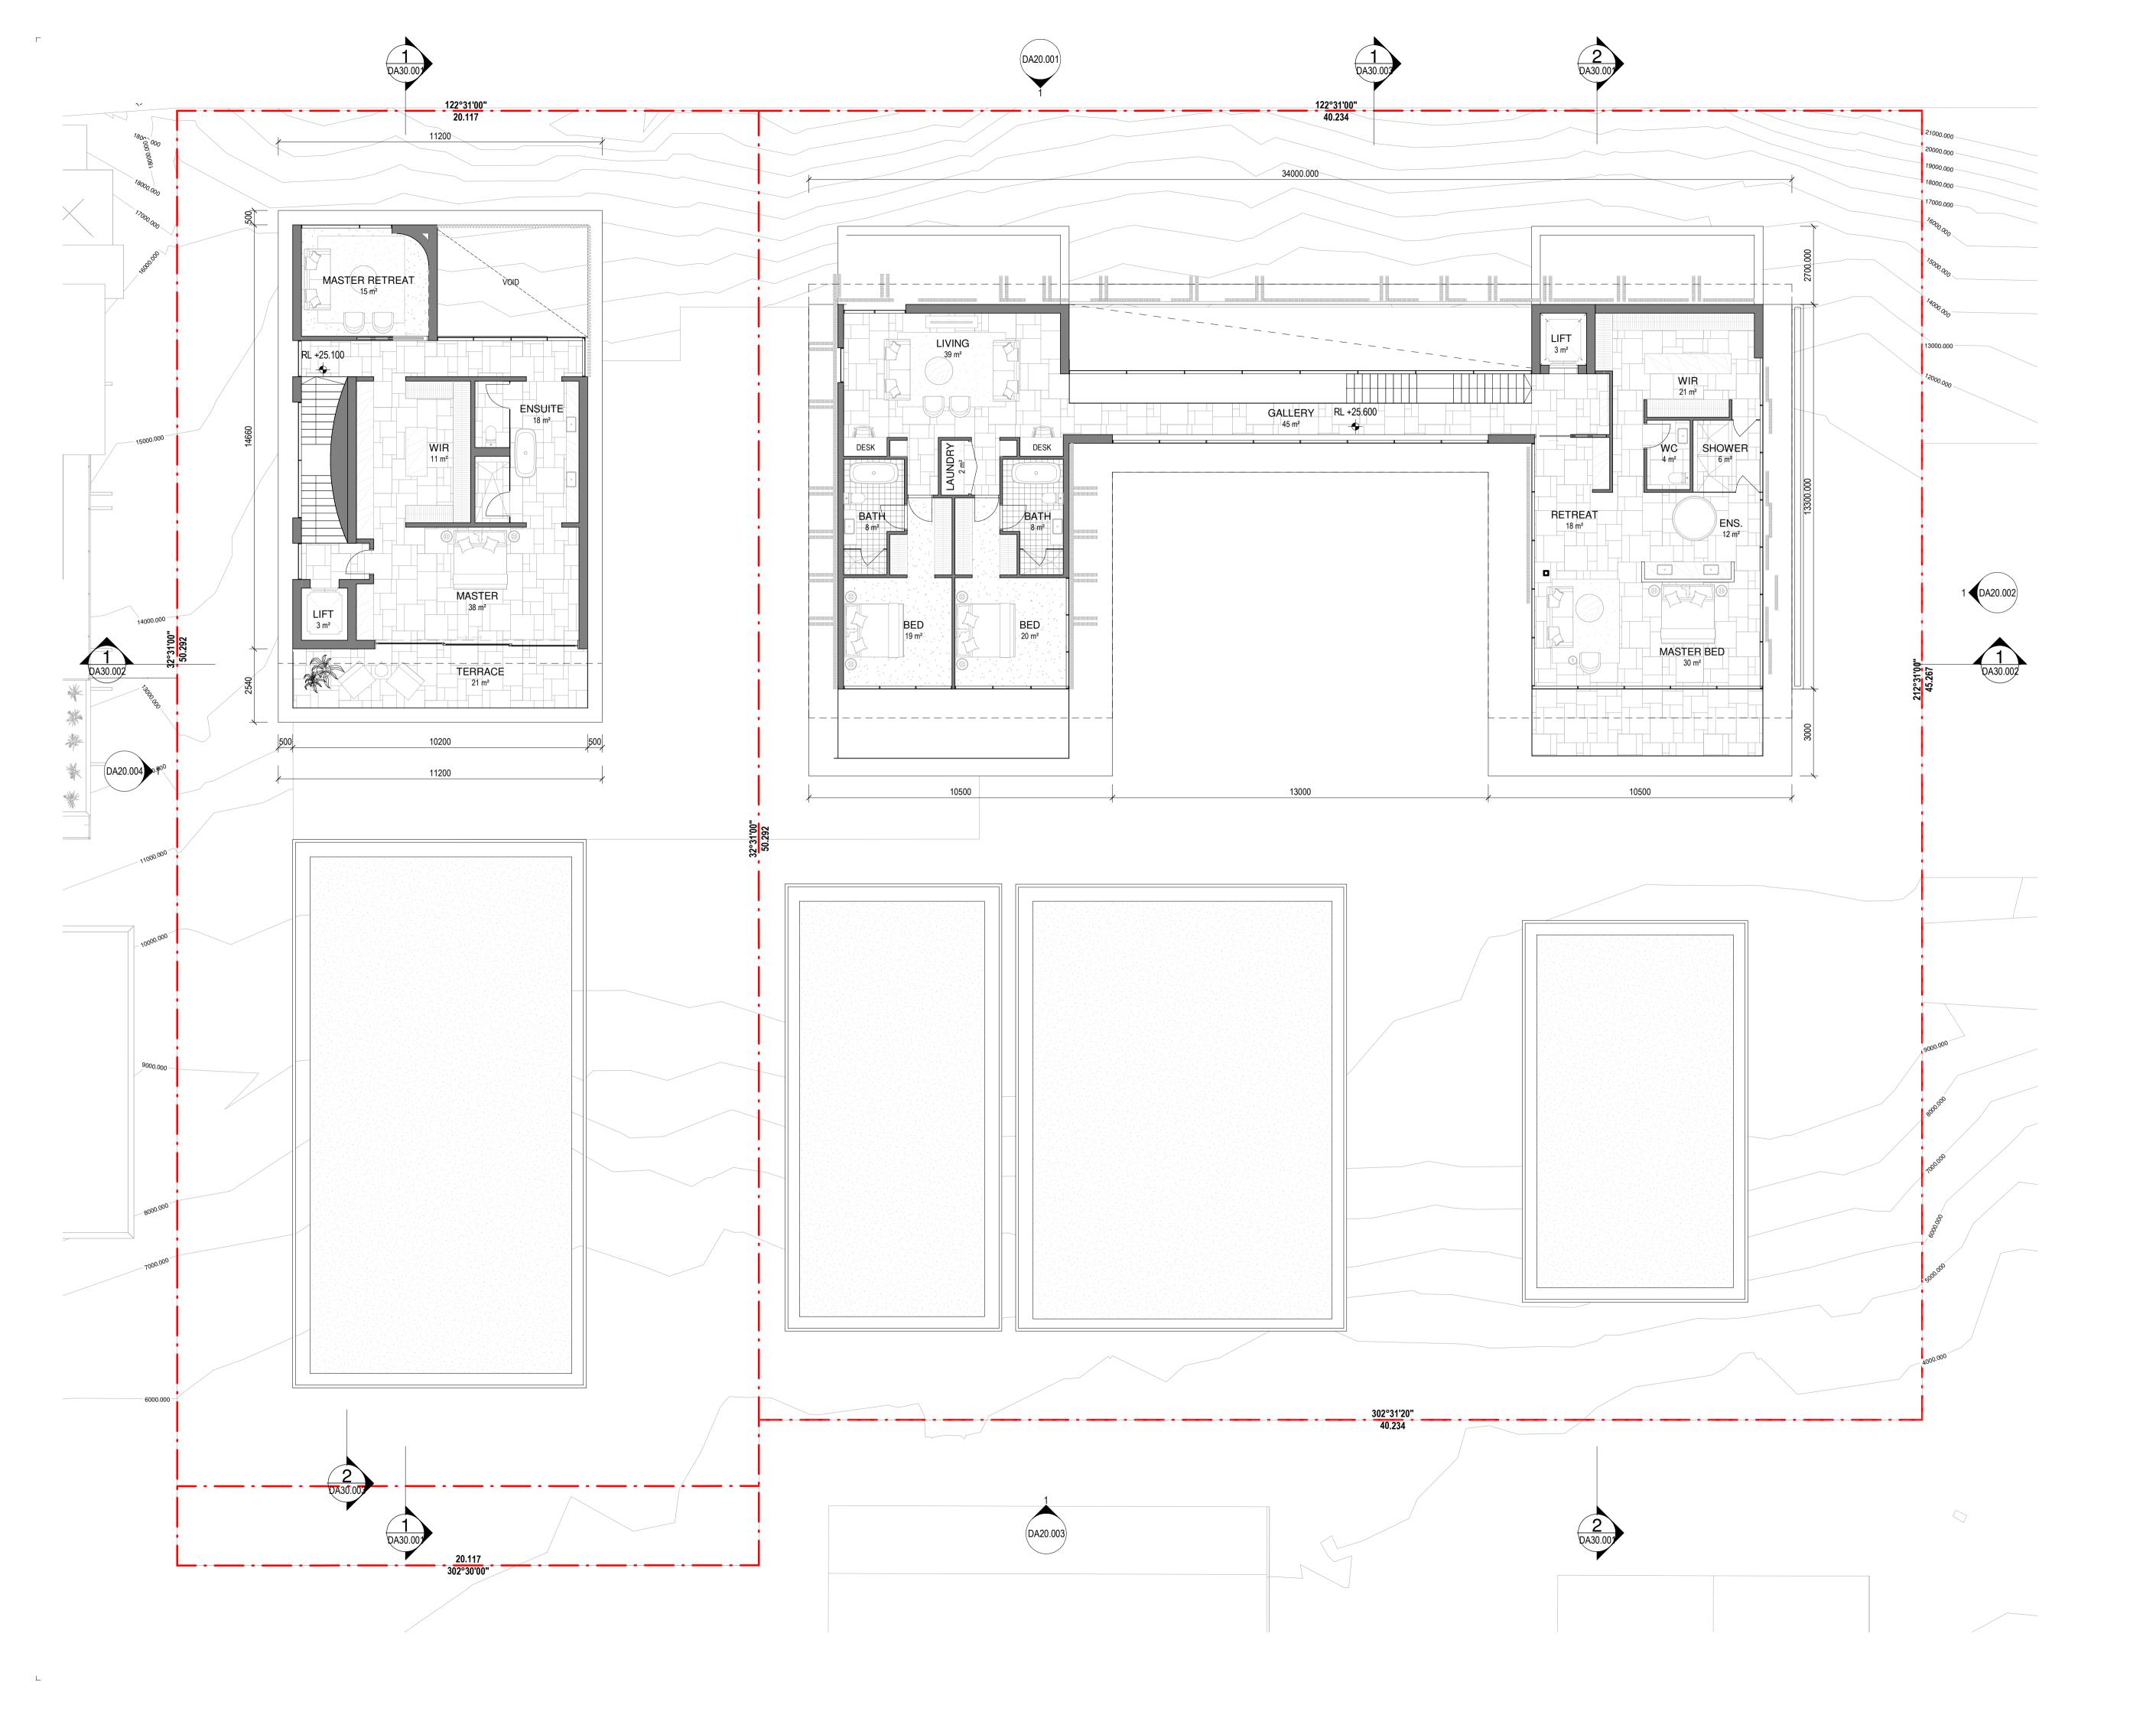


Revision

B 09/09/21 FOR CONSULTANT COORDINATION
C 15/09/21 FOR INFORMATION
D 17/09/21 FOR INFORMATION
E 21/09/21 FOR COORDINATION
F 22/09/21 DRAFT DA
G 04/10/21 ISSUE FOR DA
H 18/02/22 FOR INFORMATION
J 10/03/22 ISSUE RFI 01

Notes

BAL-1	FRAMELESS GLAZED BALUSTRADE	
	1200mm	
CON-1	IN-SITU CONCRETE	
FEN-1	TIMBER FENCING	
GLZ-1/PC-3	CLEAR GLAZING / LIGHT GREY OR SIMILAR	
PAV-1	TILED PAVING	
PAV-2	COBBLED STONE PAVING OR STAMPED CONCRETE OR SIMILAR	
PAV-3	CRUSHED ROCK	
REN-1	TEXTURED RENDER FINISH	
ST-1	STACKED STONE WALL	
TC-1	TIMBER CLADDING OR FC SHEET, OR	

DESCRIPTION

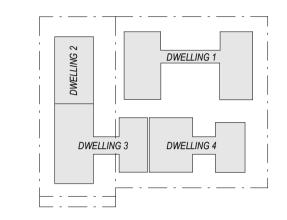





Project Manager

Structural Engineer

Mechanical Engineer

Fire Engineer

_. . . . _ .

Electrical Engineer

Client

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Registered Architects and Designers www.warrenandmahoney.com
 Project Title

69-73 MURPHY STREET PORT DOUGLAS

Drawing Title —


L03 FLOOR PLAN

Drawing Status
DEVELOPMENT
APPLICATION
Drawing Details
—

Scale	As indicated@ A1
Date	10/03/22
Job No	9663
Drawn	SG
Checked	ND

Drawing No




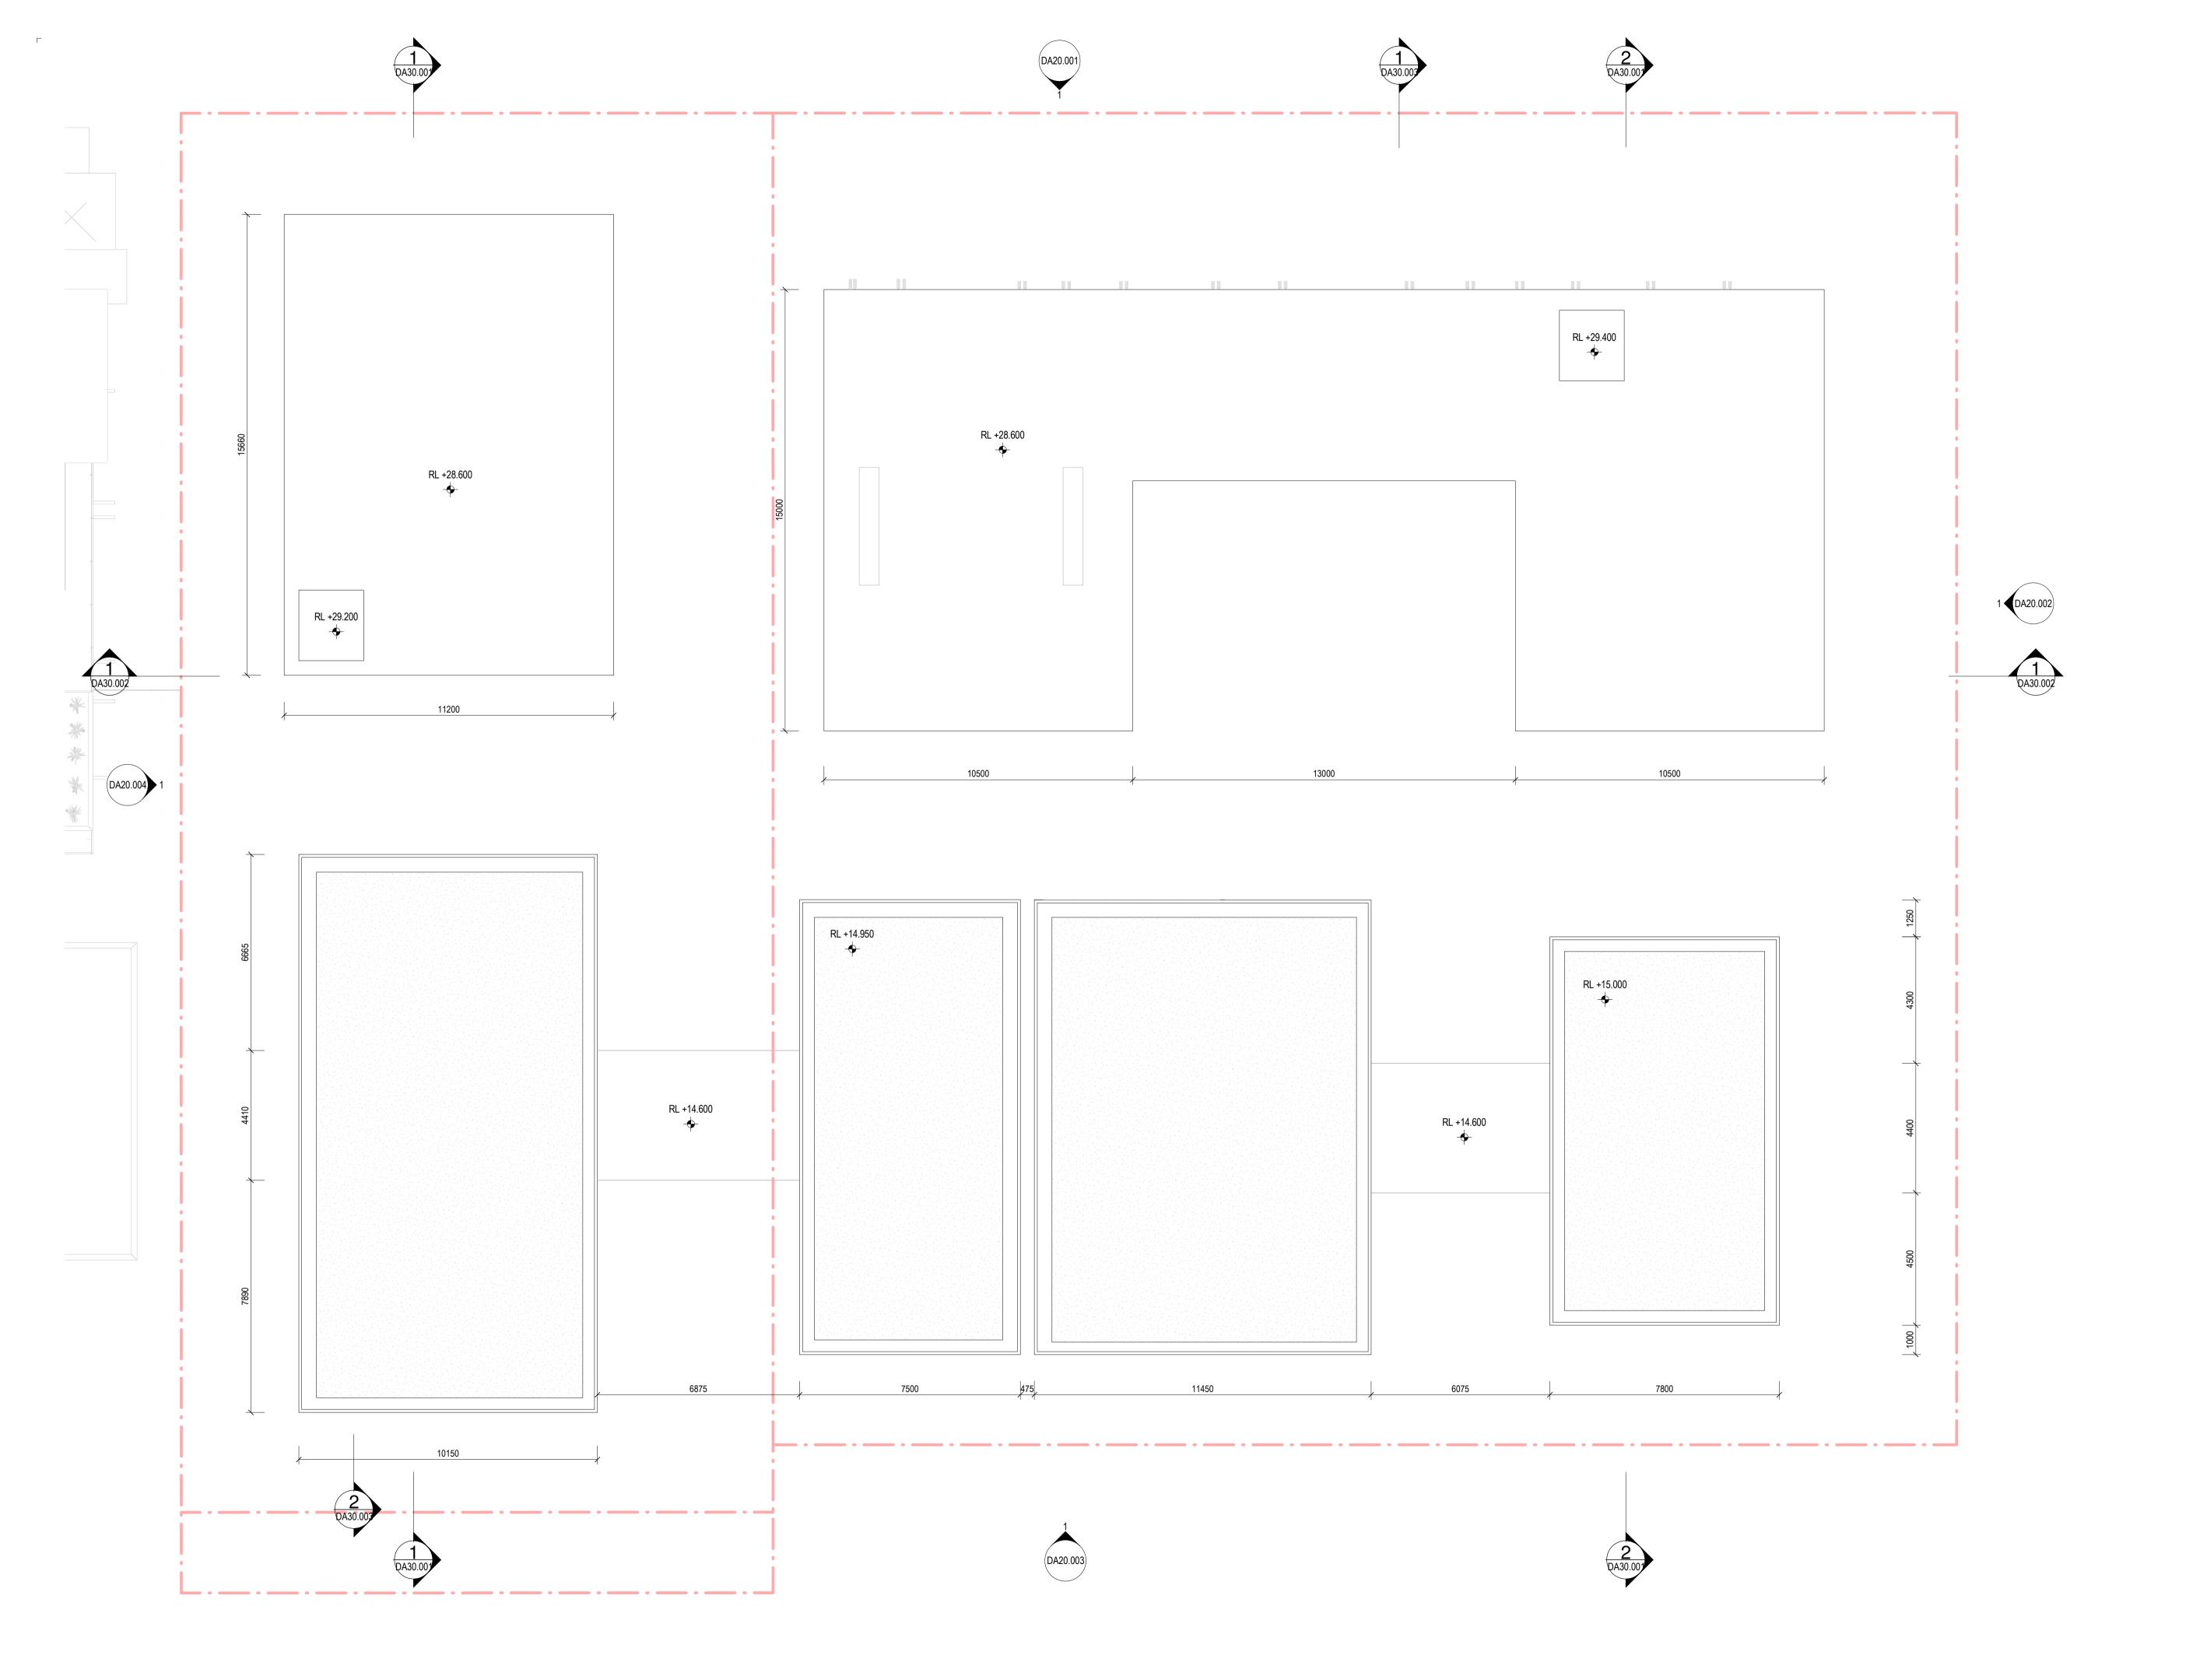


A 03/09/21 FOR CLIENT COMMENT B 15/09/21 FOR INFORMATION C 17/09/21 FOR INFORMATION D 21/09/21 FOR COORDINATION E 22/09/21 DRAFT DA

F 04/10/21 ISSUE FOR DA G 18/02/22 FOR INFORMATION H 10/03/22 ISSUE RFI 01

CODE	DESCRIPTION
BAL-1	FRAMELESS GLAZED BALUSTRADE 1200mm
CON-1	IN-SITU CONCRETE
FEN-1	TIMBER FENCING
GLZ-1/PC-3	CLEAR GLAZING / LIGHT GREY OR SIMILAR
PAV-1	TILED PAVING
PAV-2	COBBLED STONE PAVING OR STAMPED CONCRETE OR SIMILAR
PAV-3	CRUSHED ROCK
REN-1	TEXTURED RENDER FINISH
ST-1	STACKED STONE WALL
TC-1	TIMBER CLADDING OR FC SHEET, OR SIMILAR

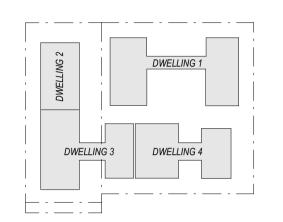

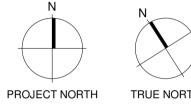

Consultants

Project Manager

Structural Engineer

Mechanical Engineer

Fire Engineer

Electrical Engineer

Client

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Registered Architects and Designers www.warrenandmahoney.com Project Title

69-73 MURPHY STREET PORT DOUGLAS

Drawing Title


ROOF PLAN

Drawing Status DEVELOPMENT **APPLICATION Drawing Details**

Scale	As indicated@ A1
Date	10/03/22
Job No	9663
Drawn	SG
Checked	ND

Drawing No



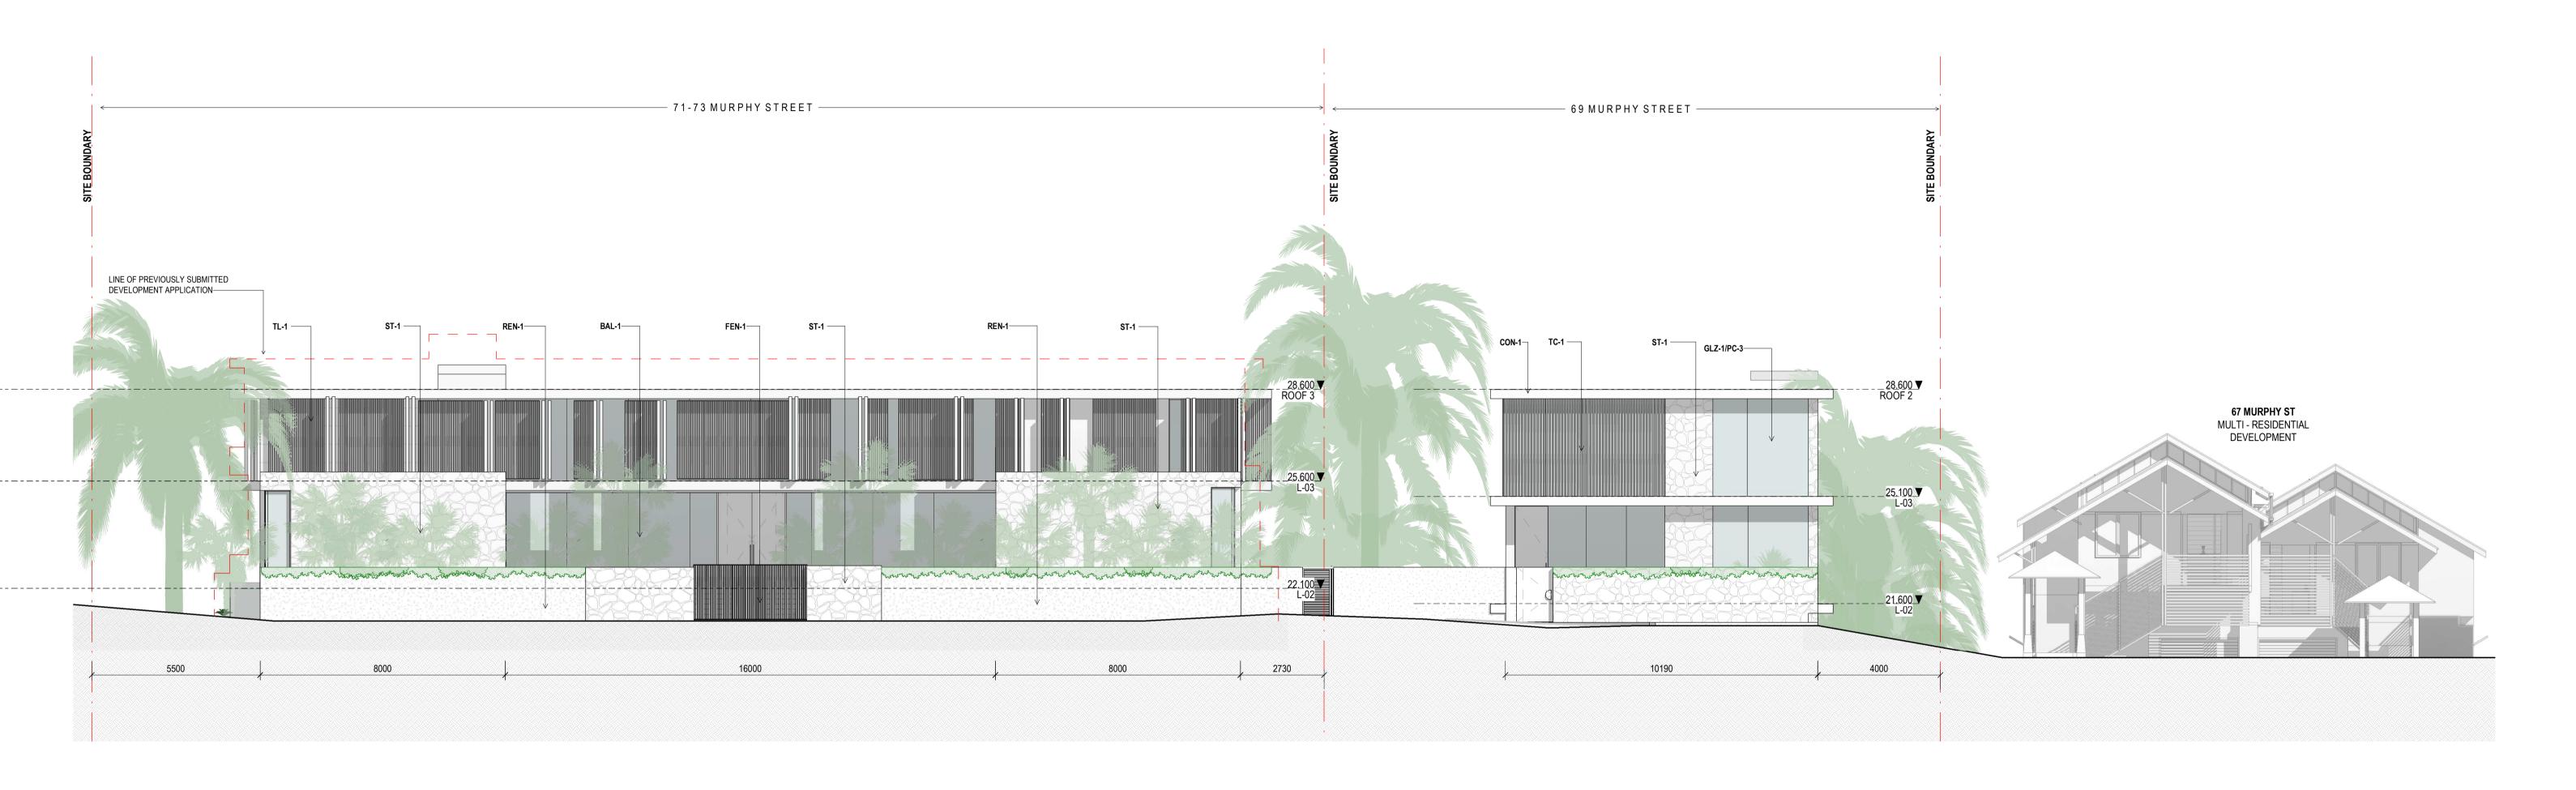



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F 18/02/22 FOR INFORMATION

G10/03/22 ISSUE RFI 01

Revisions

TC-1


FRAMELESS GLAZED BALUSTRADE 1200mm BAL-1 CON-1 IN-SITU CONCRETE FEN-1 TIMBER FENCING TILED PAVING

SIMILAR

GLZ-1/PC-3 CLEAR GLAZING / LIGHT GREY OR SIMILAR COBBLED STONE PAVING OR STAMPED CONCRETE OR SIMILAR PAV-3 REN-1 ST-1 CRUSHED ROCK TEXTURED RENDER FINISH STACKED STONE WALL TIMES CLADDING OR FC SHEET, OR

Notes — ExRL +00.000 RL +00.000

EXISTING RL - REFER TO SURVEY PROPOSED LEVEL INDICATIVE SITE FILL

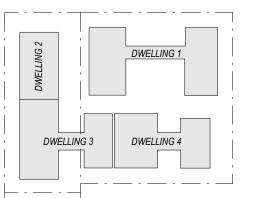

Consultants

Fire Engineer

Electrical Engineer

Project Manager Structural Engineer Mechanical Engineer

Client — **GURNER TM**

Project Title

GURNER™

69-73 MURPHY STREET PORT DOUGLAS

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Drawing Title

NORTH ELEVATION

Drawing Status


DEVELOPMENT

APPLICATION

Drawing Details

As indicated@ A1 10/03/22 Job No 9663 SG Drawn ND Checked

Drawing No DA20.001 Revision **G**

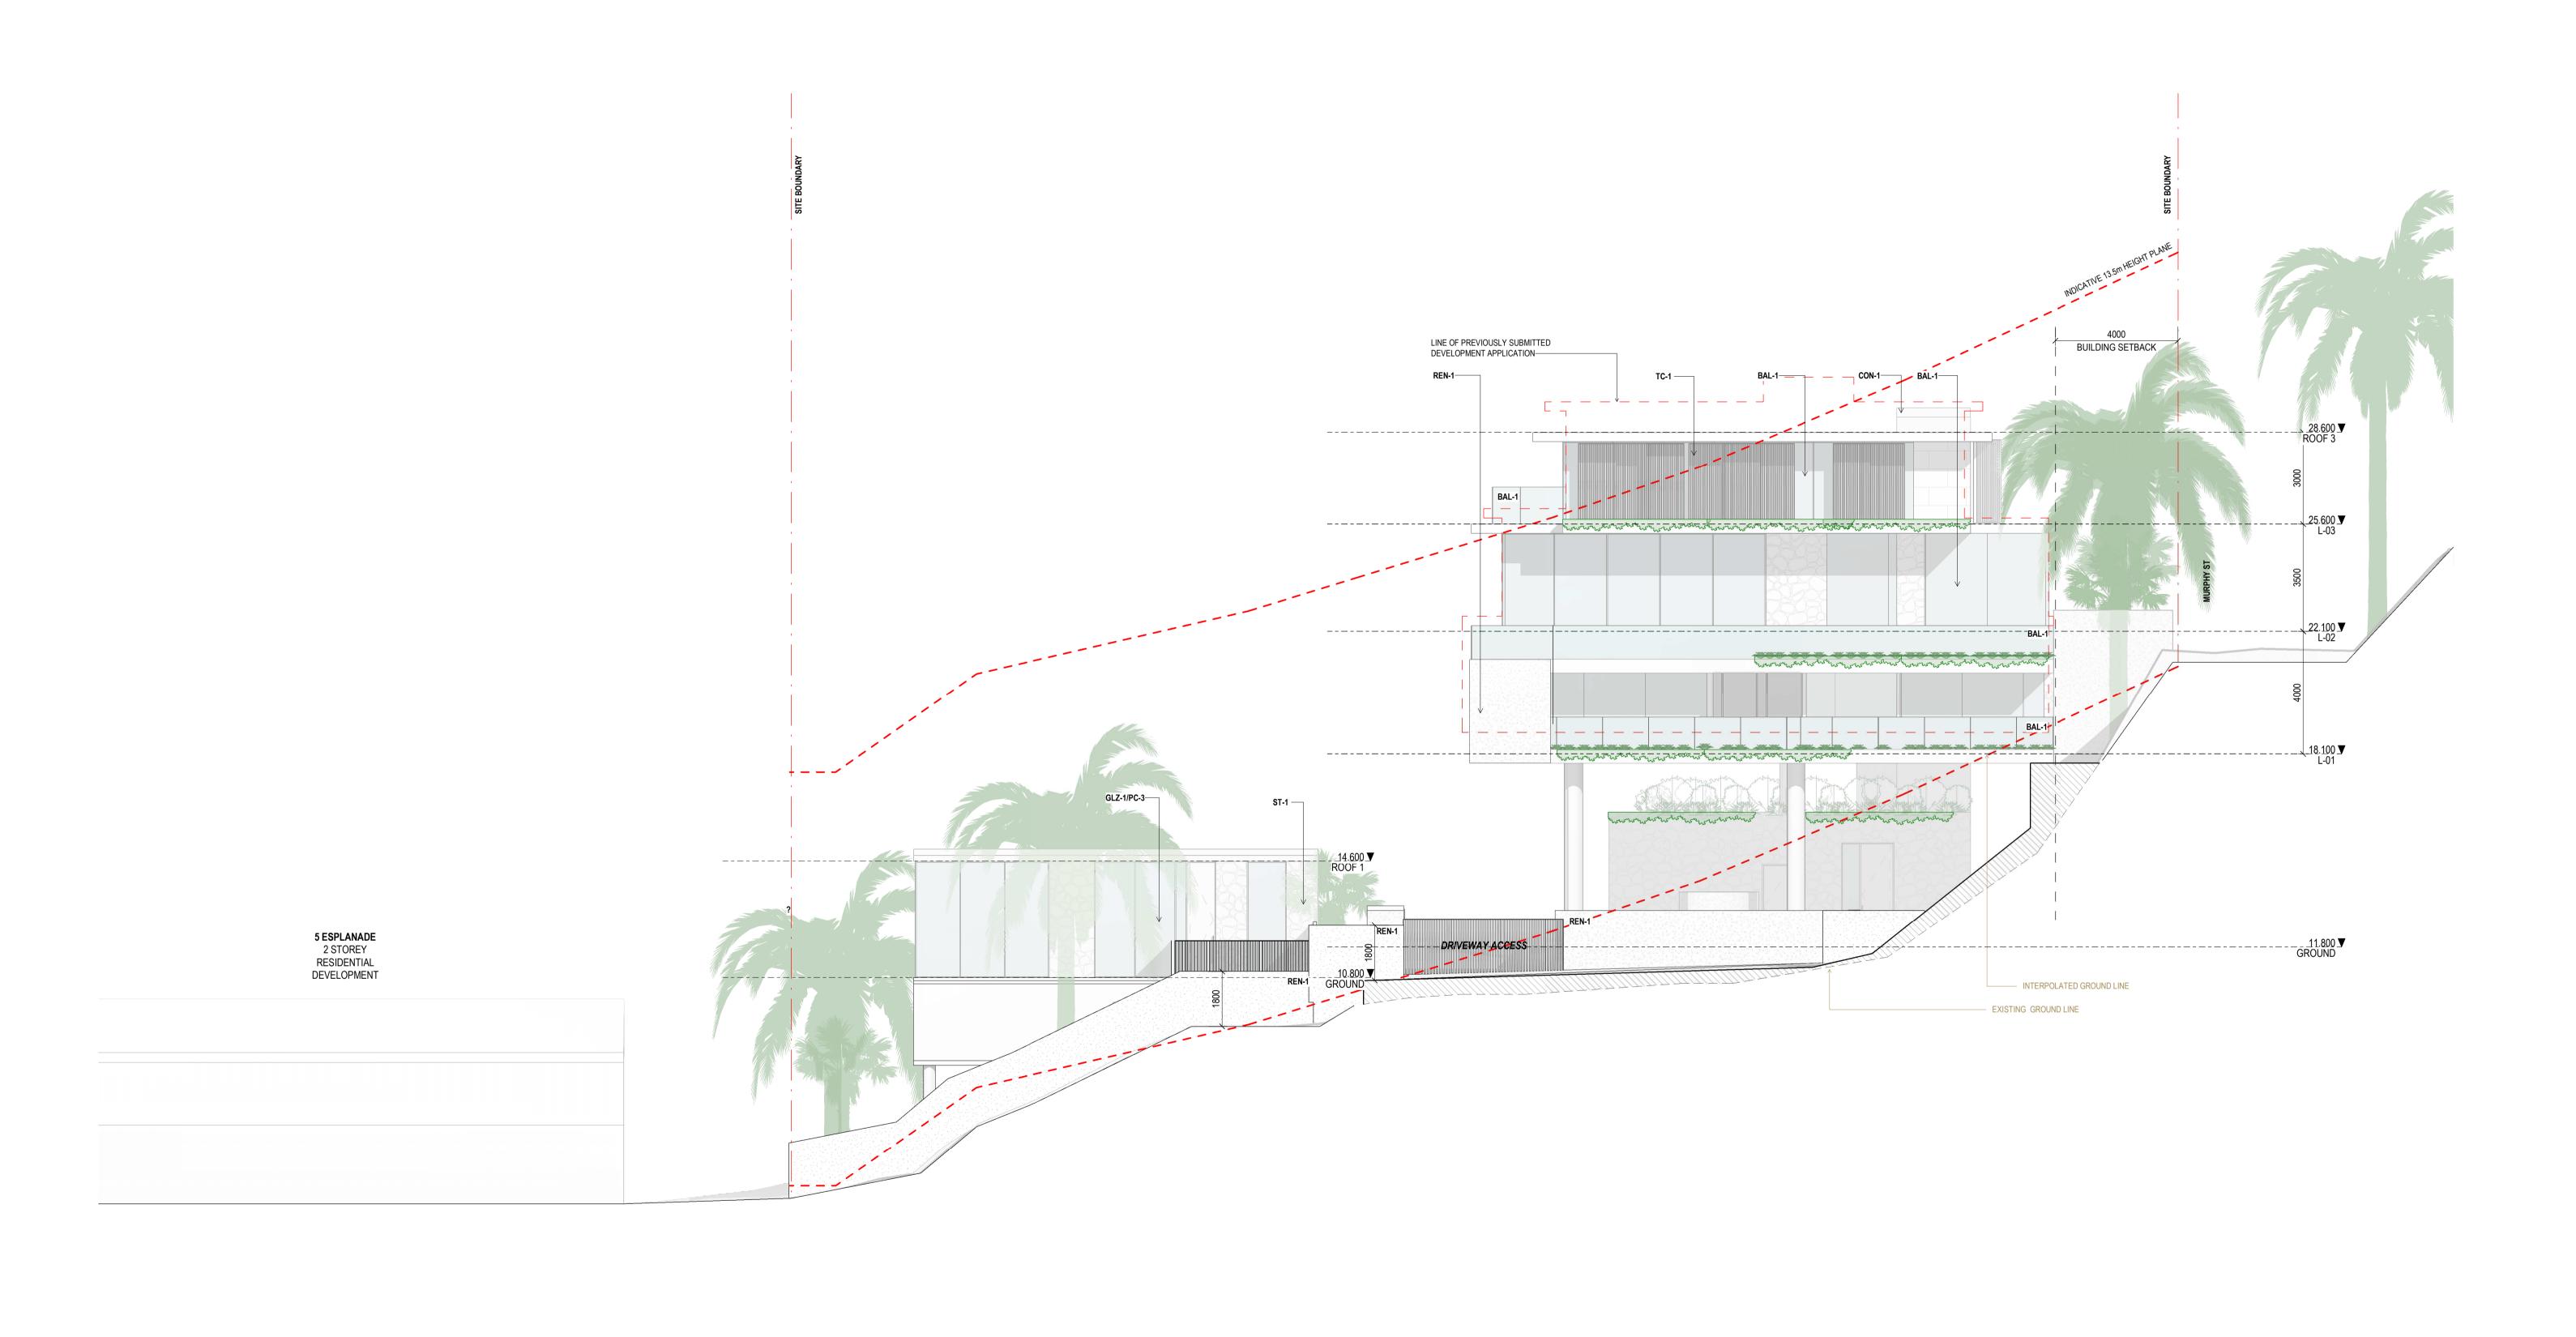

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A 03/09/21 FOR CLIENT COMMENT D22/09/21 DRAFT DA


B 15/09/21 FOR INFORMATION C17/09/21 FOR INFORMATION E 04/10/21 ISSUE FOR DA F 18/02/22 FOR INFORMATION G10/03/22 ISSUE RFI 01

FRAMELESS GLAZED BALUSTRADE 1200mm CON-1 IN-SITU CONCRETE

TIMBER FENCING GLZ-1/PC-3 CLEAR GLAZING / LIGHT GREY OR SIMILAR TILED PAVING COBBLED STONE PAVING OR STAMPED CONCRETE OR SIMILAR CRUSHED ROCK PAV-3 REN-1 ST-1 TEXTURED RENDER FINISH STACKED STONE WALL
TIMBER CLADDING OR FC SHEET, OR
SIMILAR

TC-1

Notes — EXISTING RL - REFER TO SURVEY ExRL +00.000 PROPOSED LEVEL RL +00.000 INDICATIVE SITE FILL

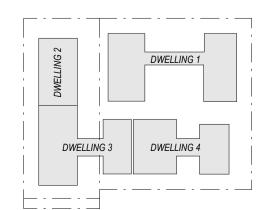

Consultants Project Manager

Structural Engineer Mechanical Engineer Fire Engineer

Electrical Engineer

Client — **GURNER TM GURNER™**

Project Title 69-73 MURPHY STREET PORT DOUGLAS

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Drawing Title EAST ELEVATION

> **Drawing Status** DEVELOPMENT APPLICATION


Drawing Details As indicated@ A1 10/03/22 Job No 9663 Drawn Checked

> **Drawing No** DA20.002

Revision

SG

ND

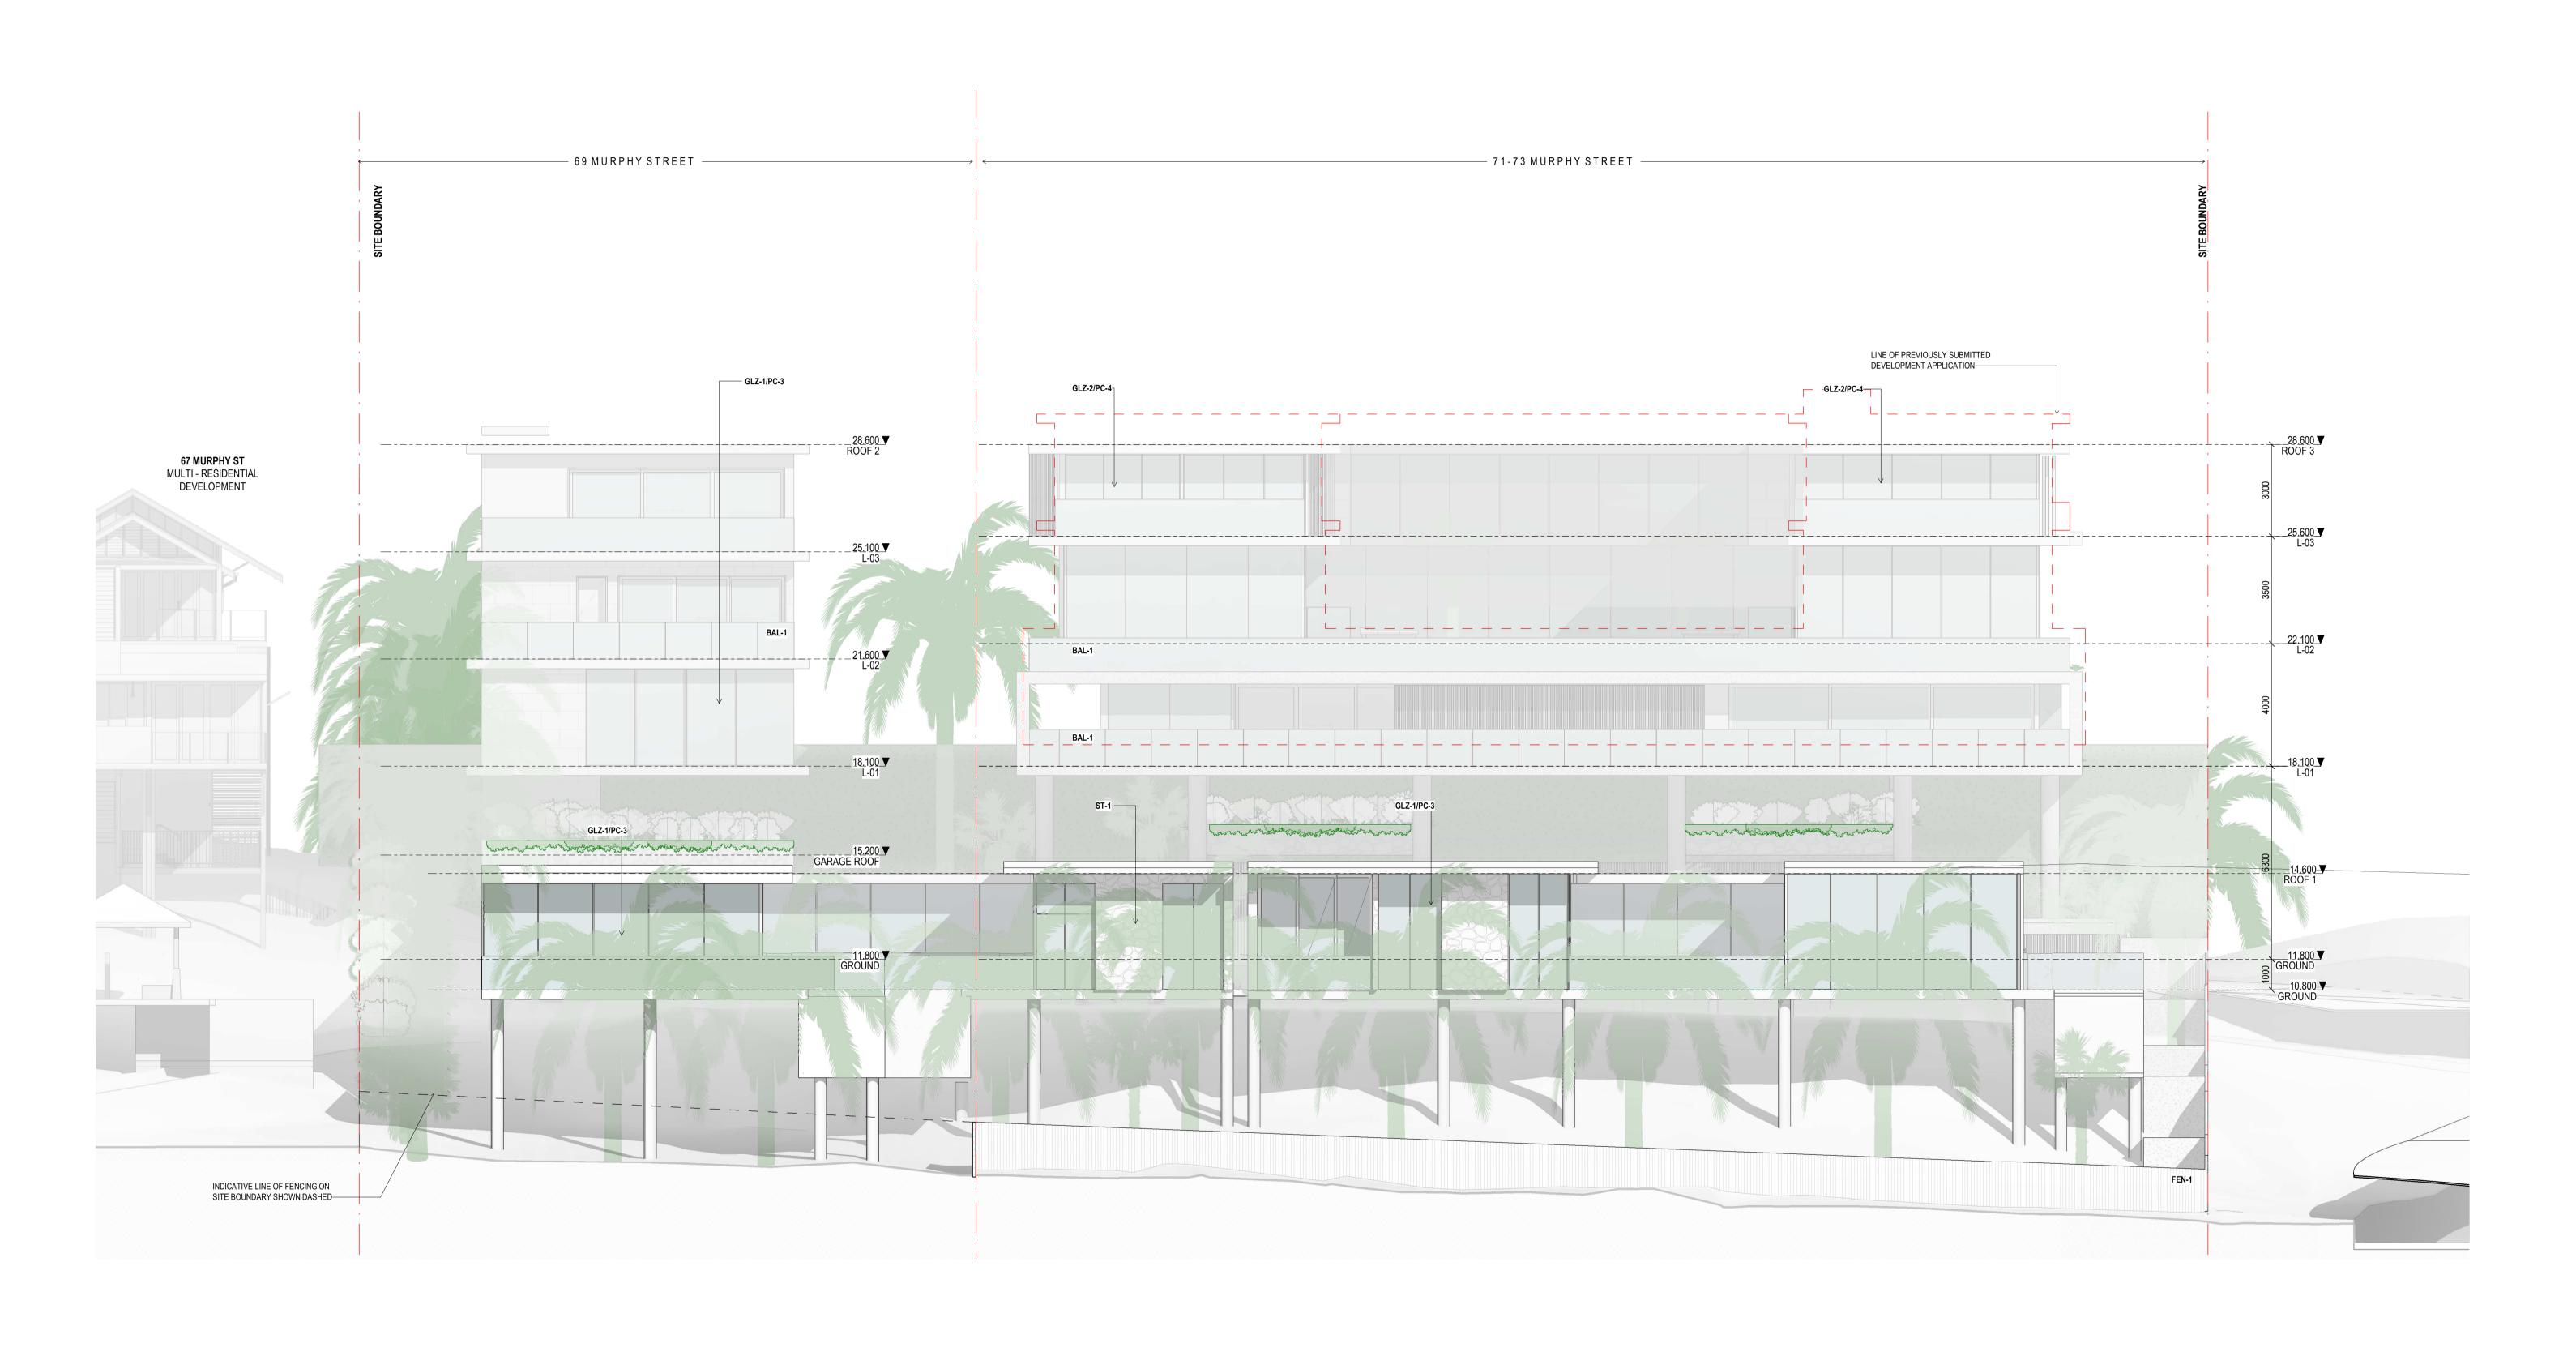



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B 15/09/21 FOR INFORMATION C17/09/21 FOR INFORMATION D22/09/21 DRAFT DA E 04/10/21 ISSUE FOR DA F 18/02/22 FOR INFORMATION G10/03/22 ISSUE RFI 01

FRAMELESS GLAZED BALUSTRADE 1200mm


CON-1 FEN-1 IN-SITU CONCRETE TIMBER FENCING GLZ-1/PC-3 CLEAR GLAZING / LIGHT GREY OR SIMILAR TILED PAVING COBBLED STONE PAVING OR STAMPED CONCRETE OR SIMILAR CRUSHED ROCK PAV-3 REN-1 ST-1 TEXTURED RENDER FINISH

TC-1

STACKED STONE WALL

SIMILAR

TIMBER CLADDING OR FC SHEET, OR

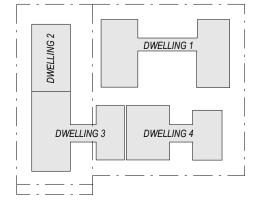

Consultants Project Manager

Structural Engineer Mechanical Engineer Fire Engineer

Electrical Engineer

Client **GURNER TM**

GURNER™

Project Title 69-73 MURPHY STREET

PORT DOUGLAS All dimension to be verified on site before producing shop drawings or commencing any work.

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DEVELOPMENT


APPLICATION

Drawing Title

Drawing Status

Drawing Details As indicated@ A1 10/03/22 Job No 9663 SG Drawn Checked

ND Revision **Drawing No** \bigcirc DA20.003

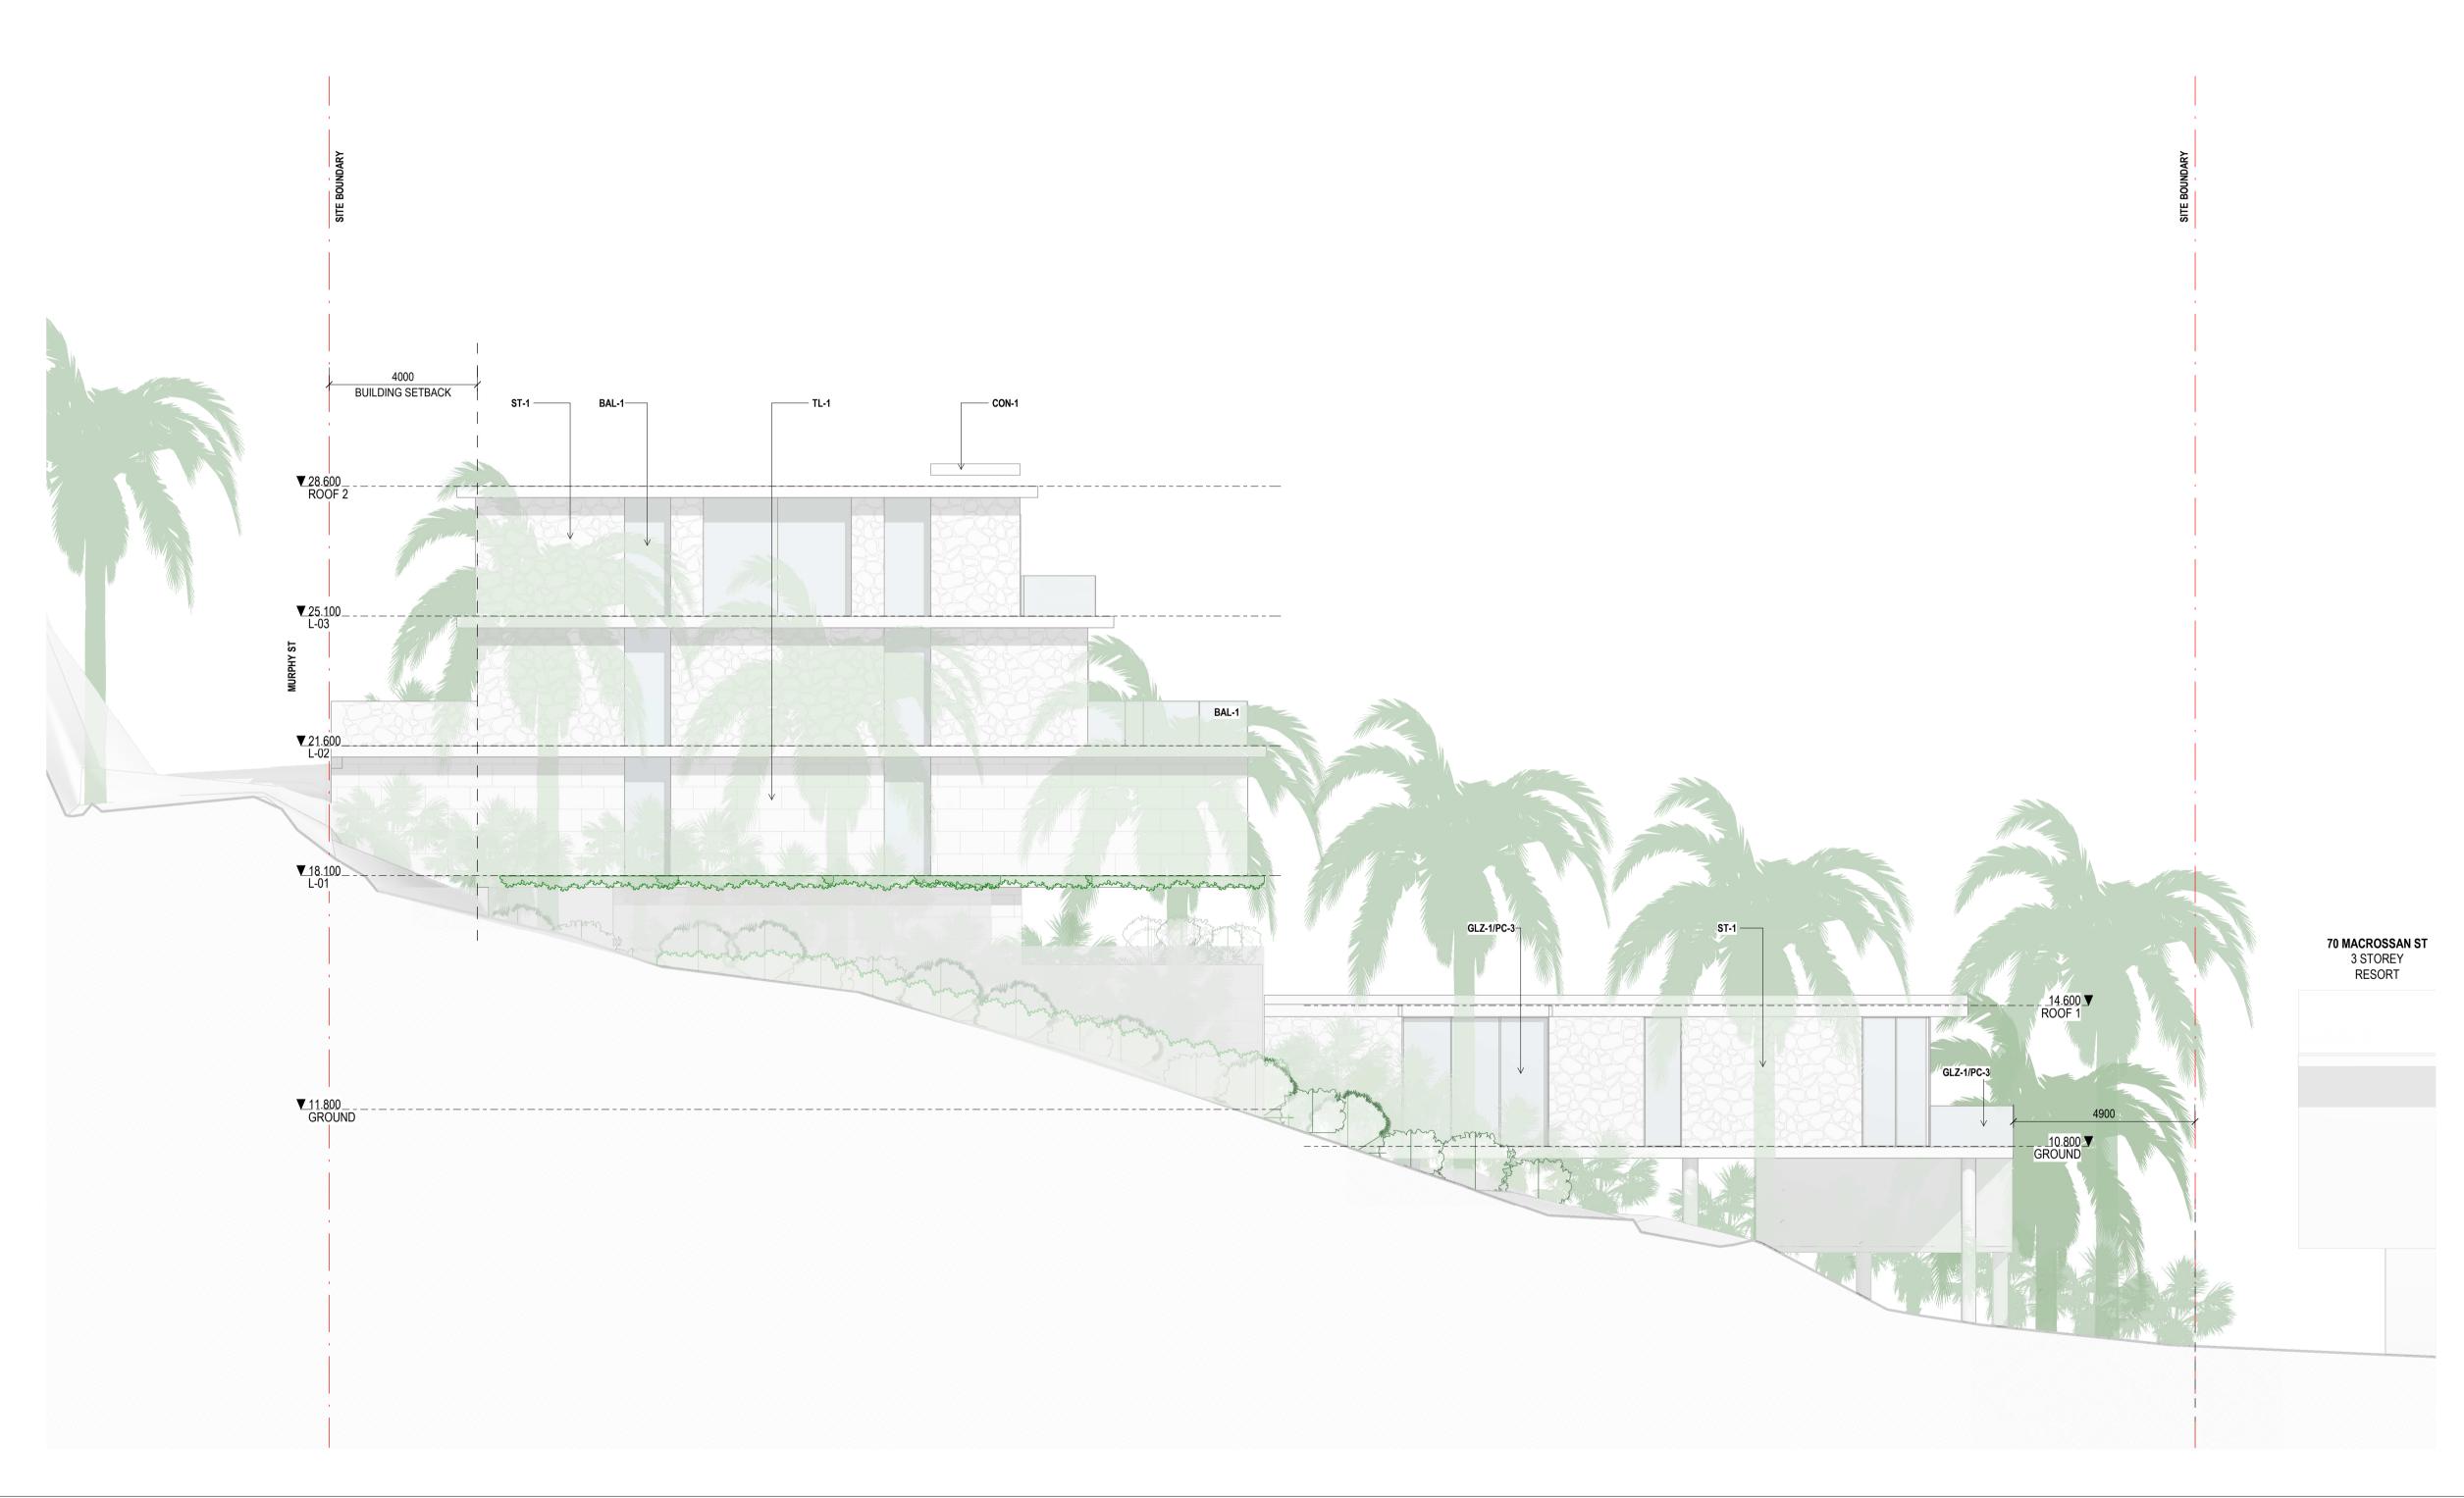

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Registered Architects and Designers www.warrenandmahoney.com **M WARREN AND MAHONEY®** Revisions

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E 04/10/21 ISSUE FOR DA F 10/03/22 ISSUE RFI 01


FRAMELESS GLAZED BALUSTRADE 1200mm

CON-1 IN-SITU CONCRETE FEN-1 TIMBER FENCING GLZ-1/PC-3 CLEAR GLAZING / LIGHT GREY OR SIMILAR TILED PAVING

COBBLED STONE PAVING OR STAMPED CONCRETE OR SIMILAR CRUSHED ROCK PAV-3 REN-1 ST-1 TC-1 TEXTURED RENDER FINISH STACKED STONE WALL

TIMBER CLADDING OR FC SHEET, OR SIMILAR



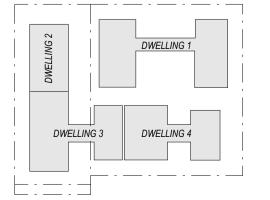

Consultants

Project Manager Structural Engineer Mechanical Engineer

Fire Engineer

Electrical Engineer

Client —

GURNER TM GURNER™

Project Title

69-73 MURPHY STREET PORT DOUGLAS

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Drawing Title

WEST ELEVATION

Drawing Status

DEVELOPMENT


APPLICATION

Drawing Details

10/03/22 Job No 9663 SG Drawn ND Checked

Drawing No DA20.004 Revision

As indicated@ A1

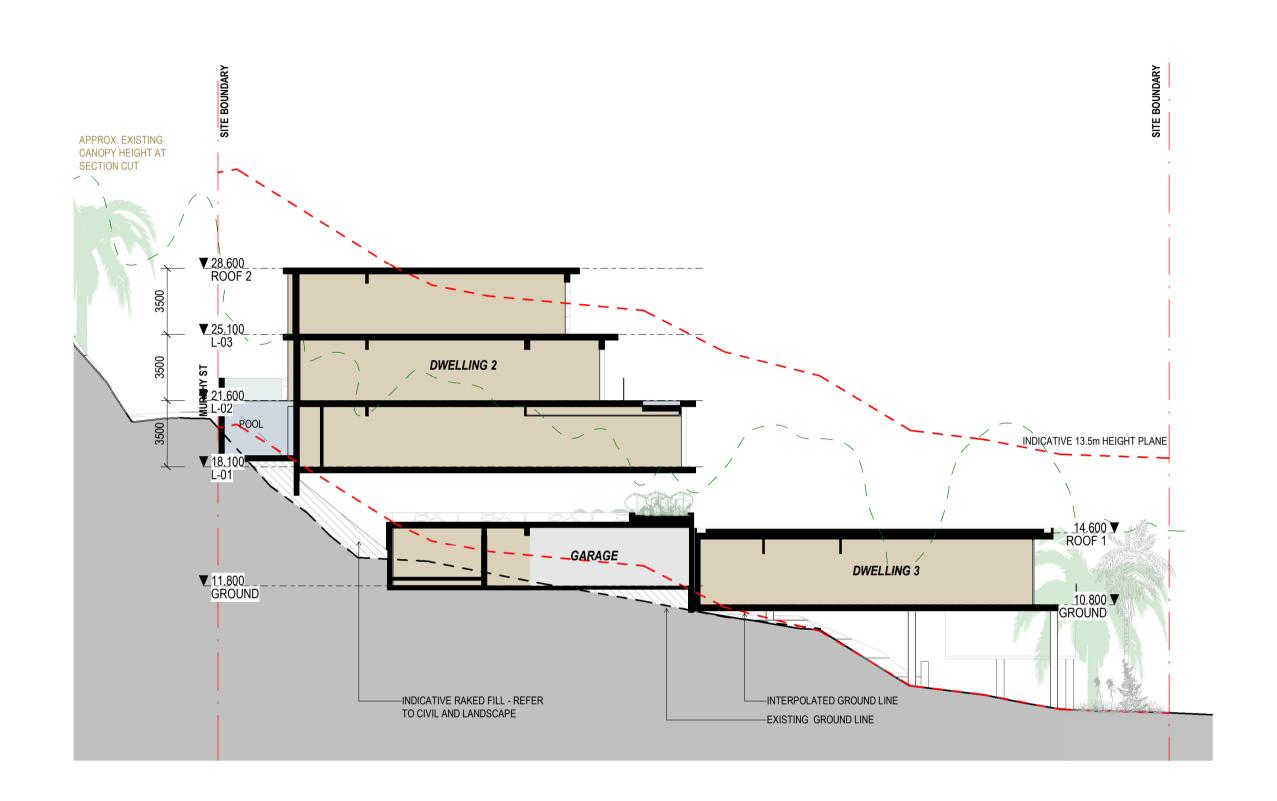

APPROX. EXISTING CANOPY HEIGHT AT SECTION CUT —LINE OF PREVIOUSLY SUBMITTED DEVELOPMENT APPLICATION DWELLING 1 ▼ 22.100 -L-02 -INDICATIVE 13.5m HEIGHT PLANE _ <u>14.600</u> ▼ ROOF 1 GARAGE **70 MACROSSAN ST** 3 STOREY RESORT DWELLING 4 ▼ 11.800 GROUND —BLOCKWORK WALL CONSTRUCTION ON BY STRUCTURAL ENGINEER —GROUND LINE FLUCTUATES - BACK FILL TO CONNECT MURPHY ST TO ESTABLISHED LEVELS. DRAINAGE AND STABILISATION TO INTERPOLATED GROUND LINE FENCE, MURPHY ST AND LANDSCAPE ZONE - TO BE DETERMINED BY STRUCTURAL/CIVIL ENGINEER -EXISTING GROUND LINE

SECTION 1

1:200

SECTION 2

1:200

Warren and Mahoney Architects
Australia Pty Ltd
—
Level 4, 141 Flinders Lane
Melbourne VIC 3000
Australia

Phone + 61 3 8547 6977

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Revisions


B 09/09/21 FOR CONSULTANT COORDINATION
C15/09/21 FOR INFORMATION
D17/09/21 FOR INFORMATION
E 21/09/21 FOR COORDINATION
F 22/09/21 DRAFT DA
G04/10/21 ISSUE FOR DA
H18/02/22 FOR INFORMATION
J 10/03/22 ISSUE RFI 01

Notes
—

ExRL +00.000

RL +00.000

EXISTING RL - REFER TO SURVEY
PROPOSED LEVEL
INDICATIVE SITE FILL

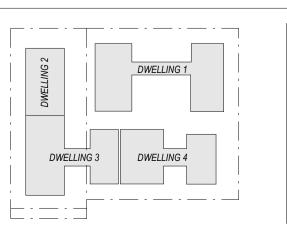

Consultants

— GURNE
Project Manager
Structural Engineer

Mechanical Engineer

Fire Engineer

Electrical Engineer

GURNER TM

Project Title

-69-73 MURPHY
STREET
PORT DOUGLAS

All dimension to be verified on site before producing shop drawings or commencing any work.
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Drawing Title

TYPICAL SECTIONS

Drawing Status
DEVELOPMENT
APPLICATION

Drawing Details

Scale As indicated@ A1

Date 10/03/22


Job No 9663

Drawn SG

Checked ND

Drawing No Revision

DA30.001

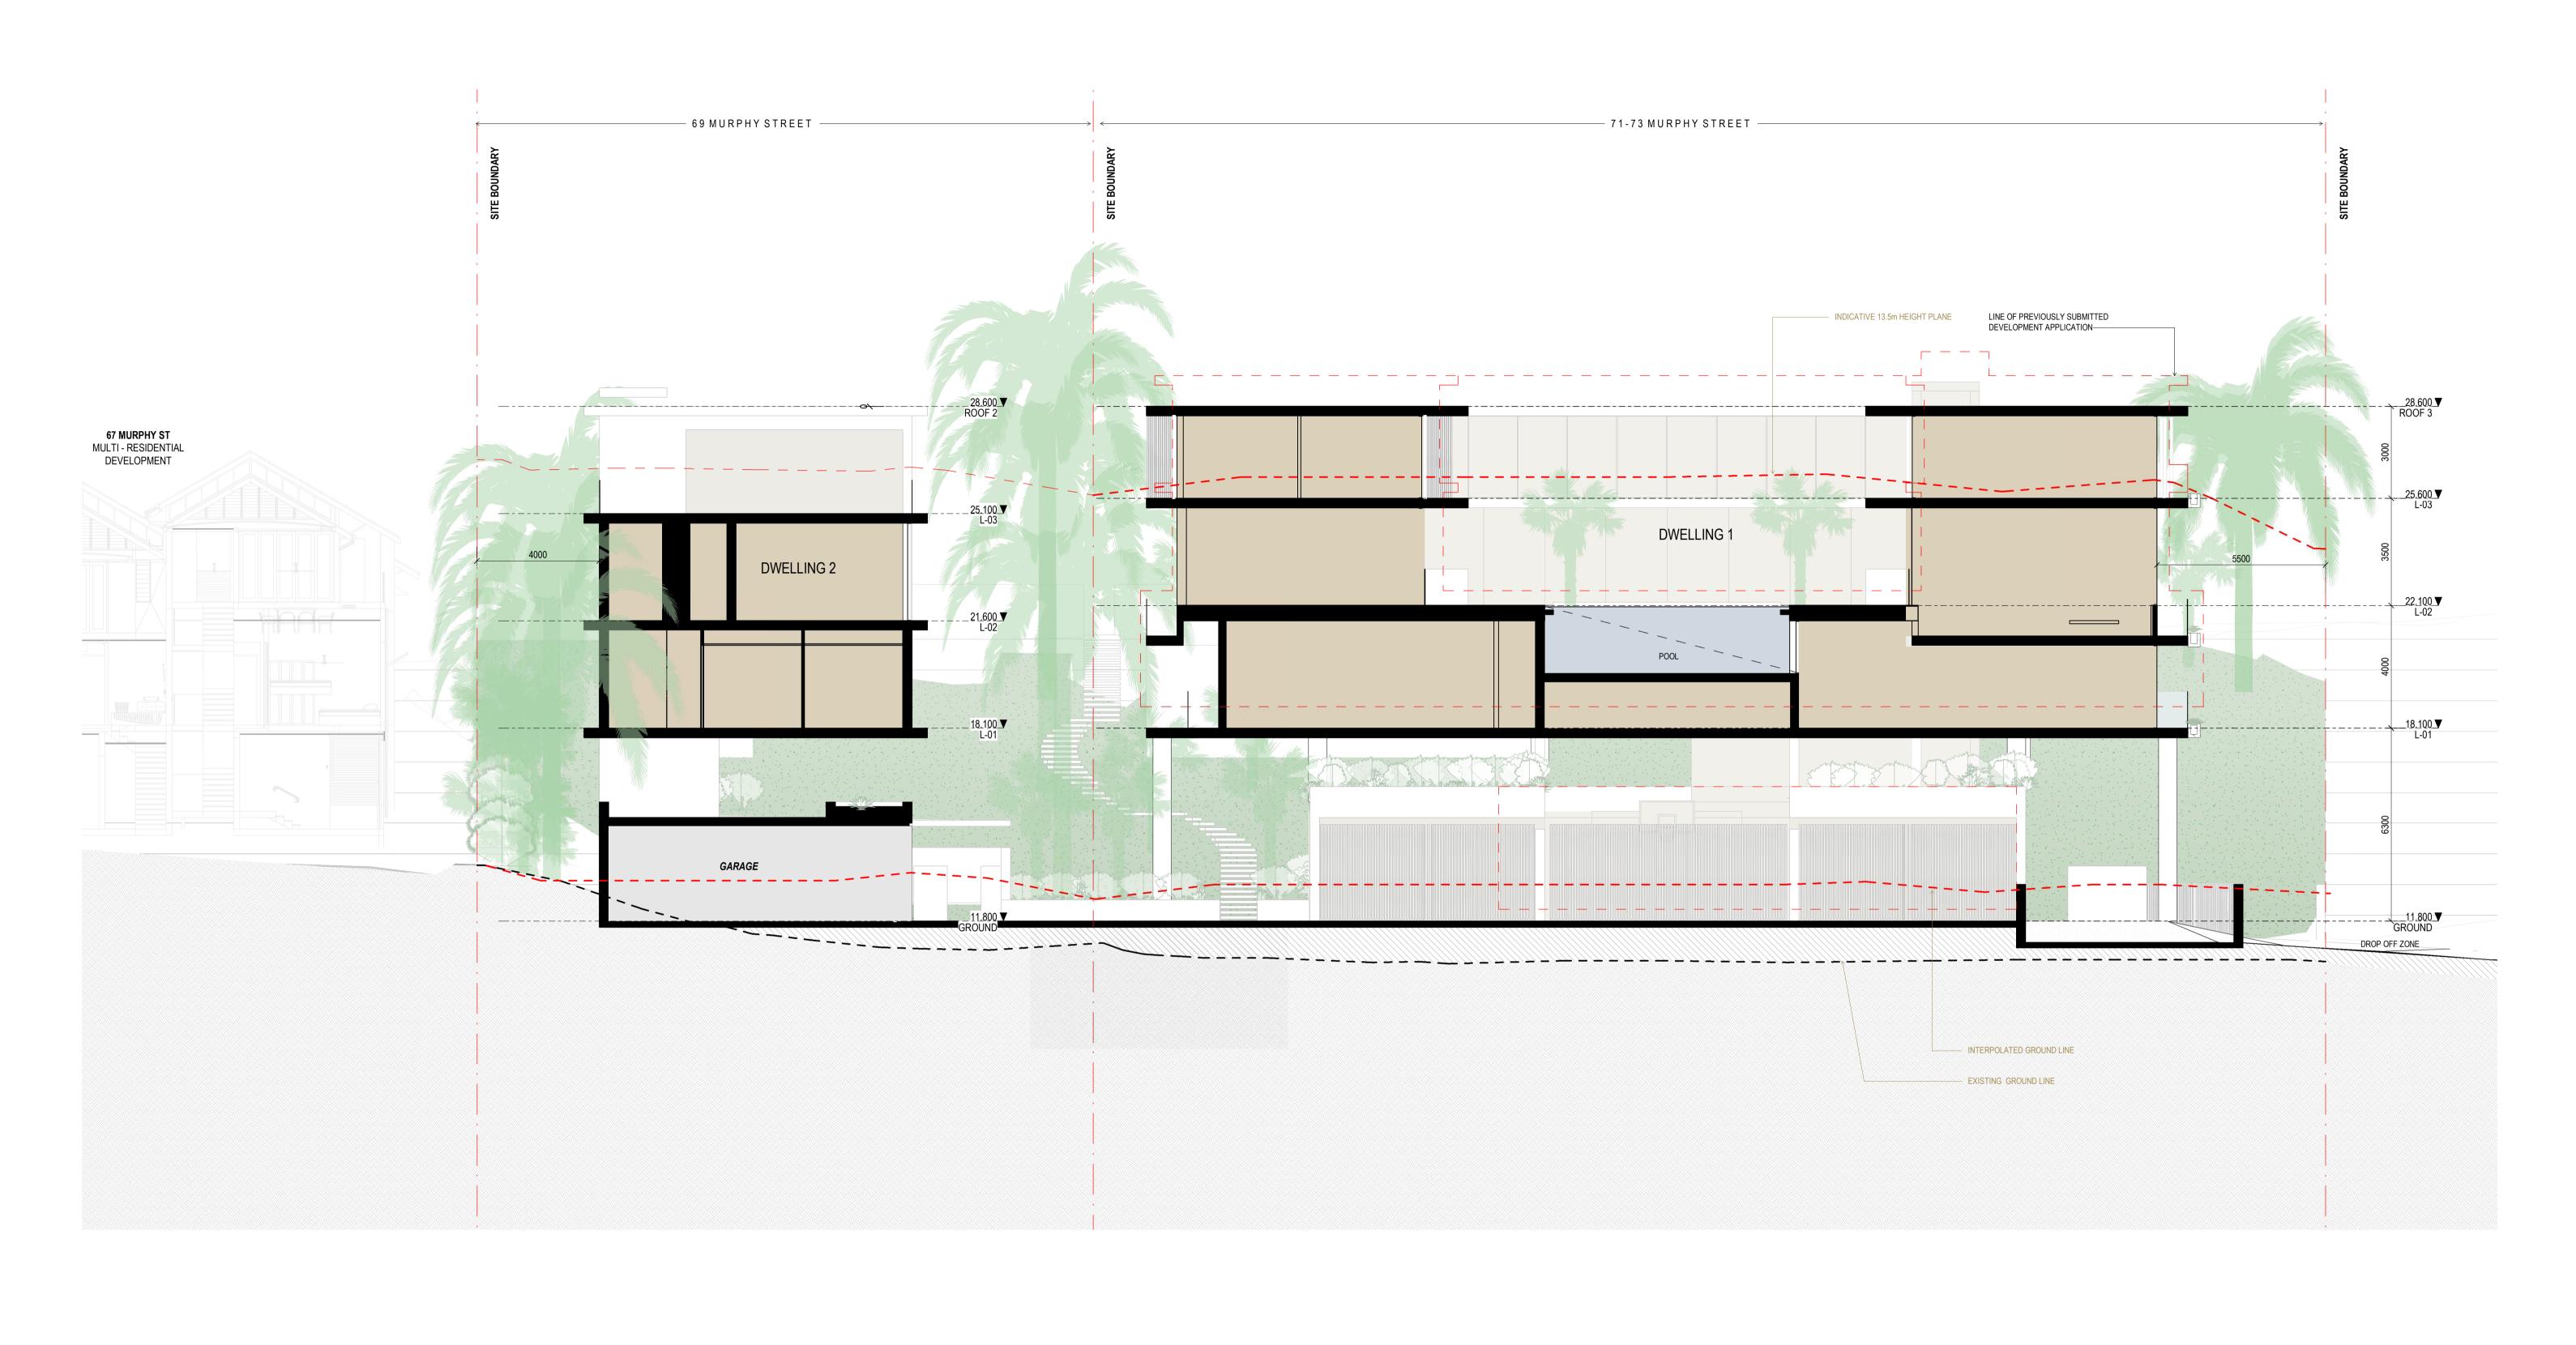



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Revisions


A 03/09/21 FOR CLIENT COMMENT B 15/09/21 FOR INFORMATION C17/09/21 FOR INFORMATION

D22/09/21 DRAFT DA E 04/10/21 ISSUE FOR DA F 10/03/22 ISSUE RFI 01

Notes —

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EXISTING RL - REFER TO SURVEY PROPOSED LEVEL INDICATIVE SITE FILL

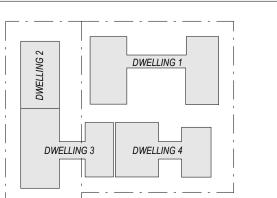

Consultants

Project Manager Structural Engineer Mechanical Engineer Fire Engineer

Electrical Engineer

Client — **GURNER TM**

GURNER™

Project Title 69-73 MURPHY

STREET PORT DOUGLAS

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Drawing Title


TYPICAL SECTIONS

Drawing Status DEVELOPMENT APPLICATION


Drawing Details

As indicated@ A1 10/03/22 Job No 9663 SG Drawn ND Checked

Drawing No DA30.002 Revision

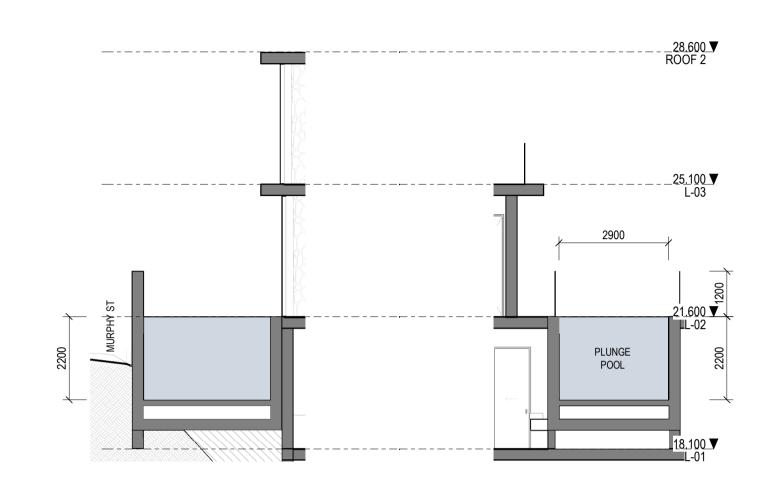


2 DWELLING 2 - POOL SECTION

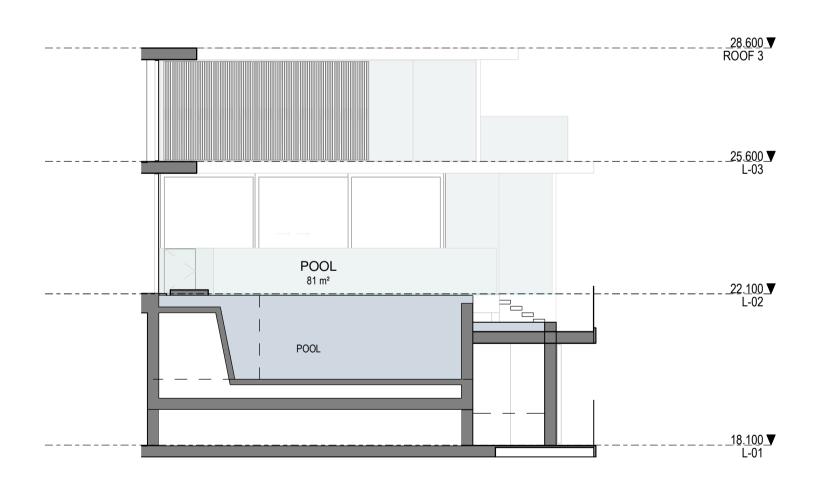


1 DWELLING 1 - POOL SECTION

1:100

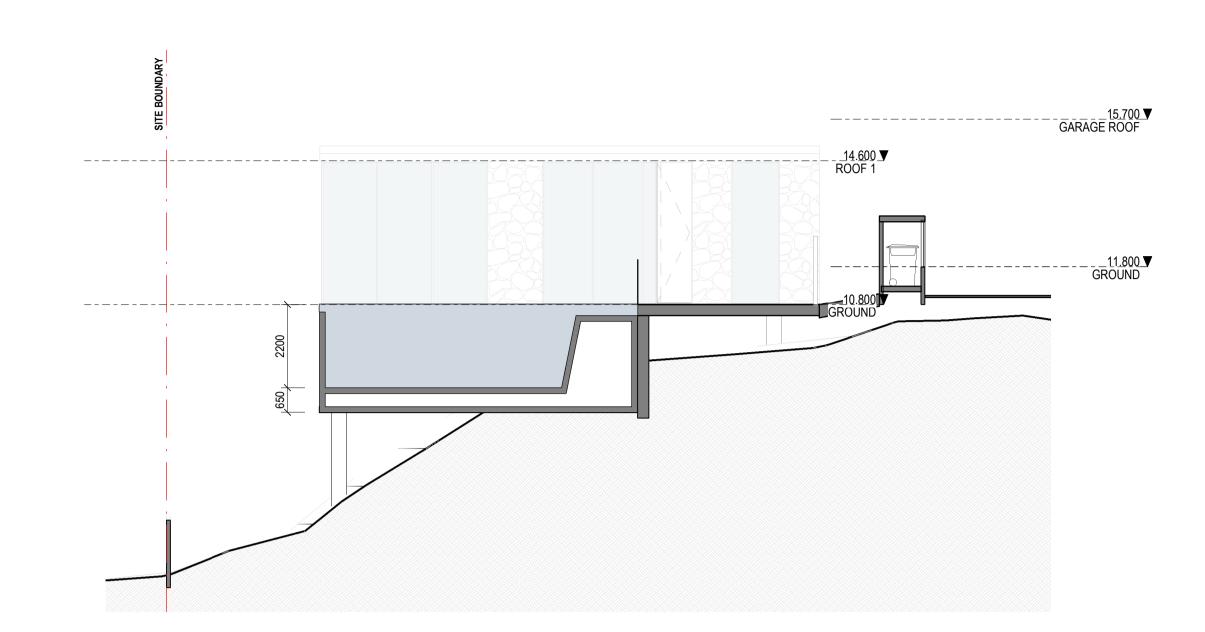

4 DWELLING 4 - POOL SECTION

1:100

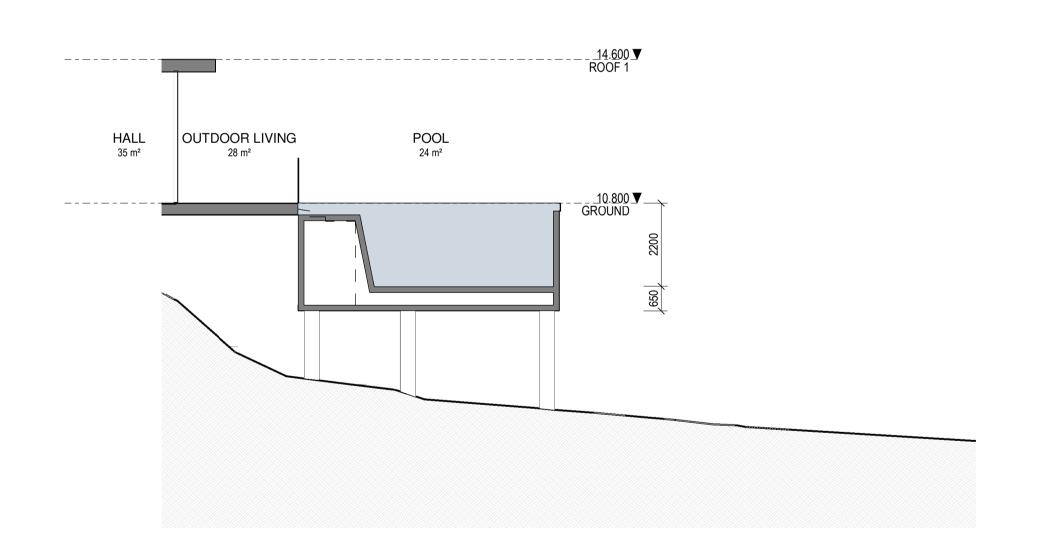

3 DWELLING 3 - POOL SECTION
1:100

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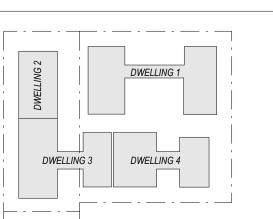
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Revisions —

A 10/03/22 ISSUE RFI 01

Notes — ExRL +00.000 RL +00.000

EXISTING RL - REFER TO SURVEY
PROPOSED LEVEL
INDICATIVE SITE FILL



Consultants
—
Project Manager
Structural Engineer
Mechanical Engineer
Fire Engineer

Electrical Engineer

Client
—
GURNER TM

GURNER TM

Project Title

69-73 MURPHY

STREET

PORT DOUGLAS

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Drawing Title
-POOL SECTIONS

Drawing Status
DEVELOPMENT
APPLICATION

Drawing Details

Scale As indicated@ A1

Date 10/03/22

Job No 9663


Drawn SG

Checked BG

Drawing No
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DA30.003






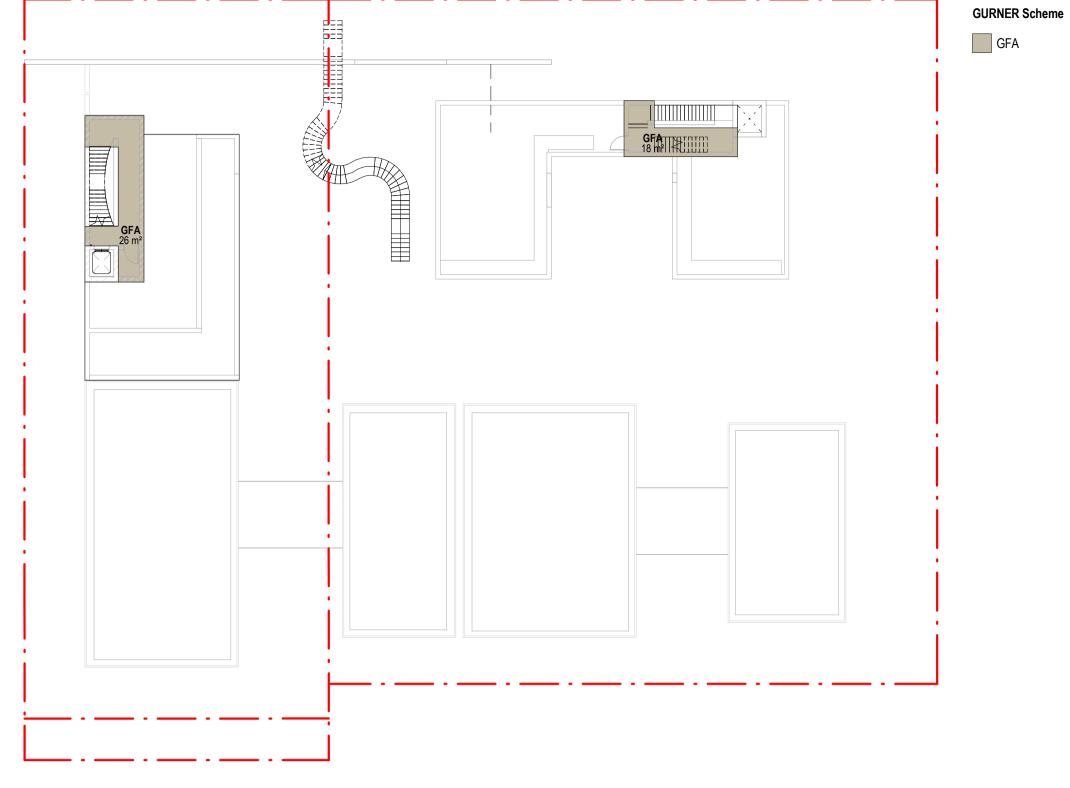

GARAGE ROOF - GFA

1:250

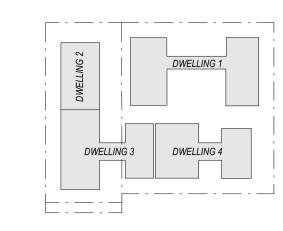

GROSS FLOOR AREA (PLANNING):

The total floor area of all storeys of a building (measured from the outside of the external walls or the centre of a common wall), other than areas used for

the following:
(a) building services, plant and equipment
(b) access between levels

(c) ground floor public lobby

(d) a mall

(e) the parking, loading and manoeuvring of motor vehicles (f) unenclosed private balconies whether roofed or not.

GFA (PLANNING)

POS (PLANNING)

TYPE	AREA	TYPE	AREA
111-	AILEA	1112	AILA
ING 1		DWELLING 1	
	1091 m ²	POS	545 m²
ING 2		DWELLING 2	•
	509 m²	POS	192 m²
ING 3		DWELLING 3	•
	233 m²	POS	190 m²
ING 4		DWELLING 4	•
	221 m²	POS	102 m²
	2055 m²		1029 m²

CIRCULATION AND SERVICES ZONES

TYPE	AREA
DWELLING 1	
CARPARK	96 m²
CIRCULATION	12 m²
SERVICES	98 m²
DWELLING 2	
CARPARK	70 m²
CIRCULATION	17 m²
SERVICES	35 m²
DWELLING 3	
CARPARK	49 m²
DWELLING 4	

DWELLING 4


CARPARK

FSR (PLANNING)

		FSR	
GFA	SITE AREA	FSR	:1
2055 m²	2832	0.73	.1





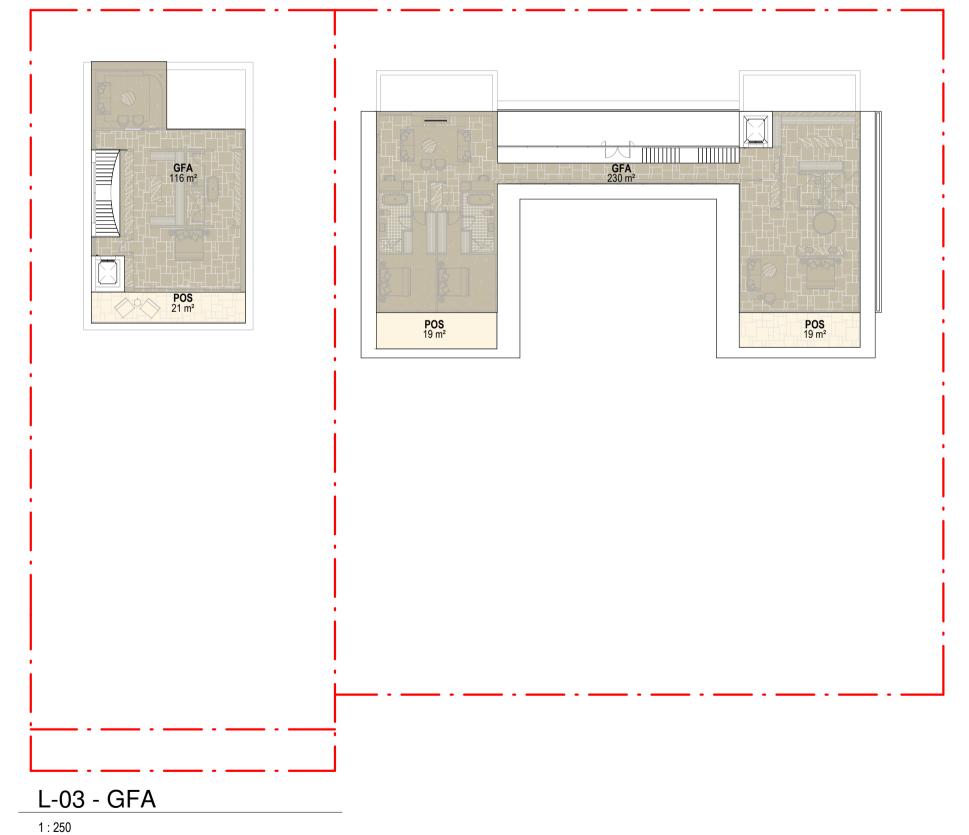

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A 15/09/21 FOR INFORMATION B 22/09/21 DRAFT DA C04/10/21 ISSUE FOR DA D18/02/22 FOR INFORMATION

Revisions

E 10/03/22 ISSUE RFI 01

Notes —

Project Manager Structural Engineer Mechanical Engineer Fire Engineer

Electrical Engineer

Consultants

Client —

GURNER TM GURNER™

Project Title 69-73 MURPHY

STREET PORT DOUGLAS

All dimension to be verified on site before producing shop drawings or commencing any work.

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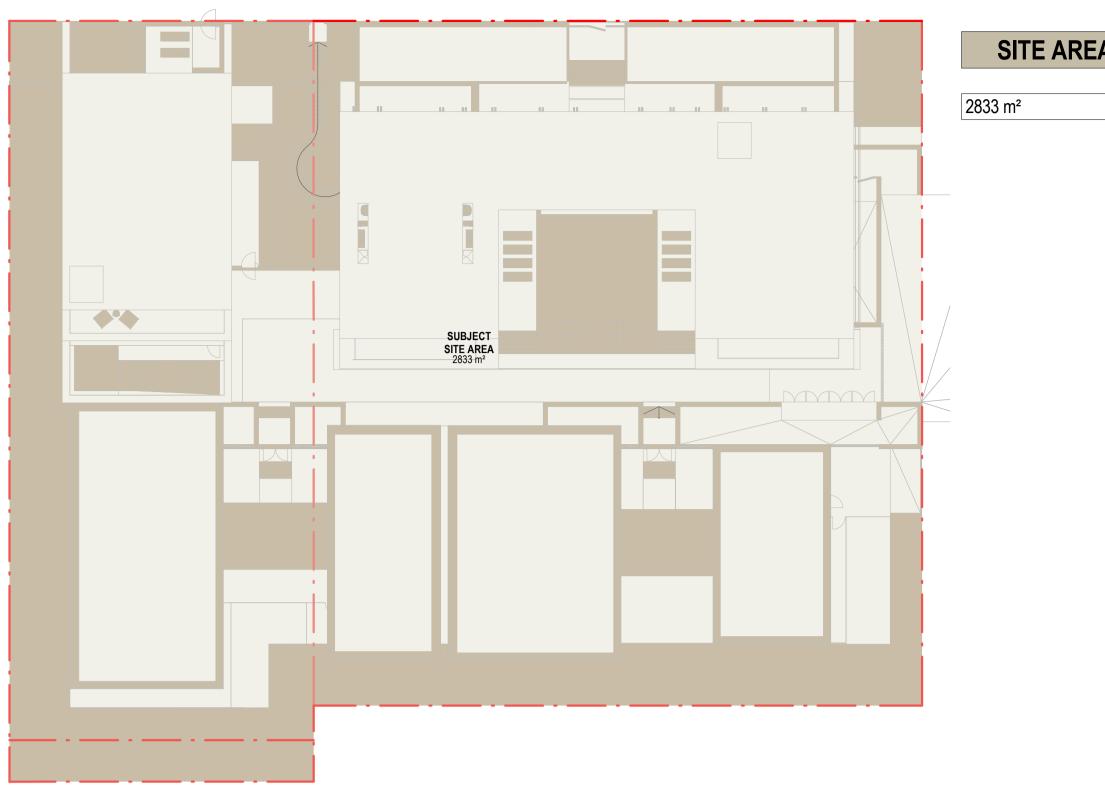
Drawing Title

DEVELOPMENT SUMMARY - GFA

Drawing Status DEVELOPMENT **Drawing Details**


Scale As indicated@ A1 Date 10/03/22 Job No 9663 SG Drawn ND Checked Revision

Drawing No DA50.001 APPLICATION



SITE AREA

1:250

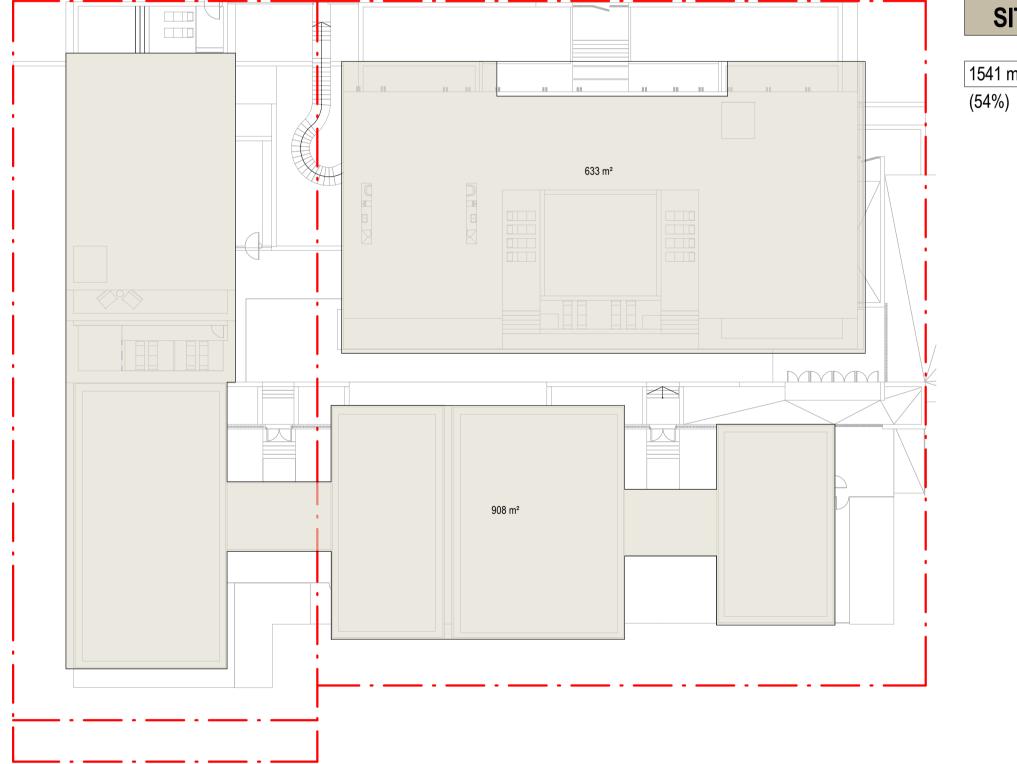

TOTAL SITE COVER

1:250

SITE AREA

L-01 40m²

AHD 19100 -

GROUND 124m² AHD 18100

PROPOSED EXCAVATED AREAS

Consultants

Project Manager

Structural Engineer

Mechanical Engineer

Electrical Engineer

Fire Engineer

1:250

SITE COVER

1541 m²

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Client — **GURNER TM**

GURNER™

Project Title 69-73 MURPHY STREET PORT DOUGLAS

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Drawing Title

DEVELOPMENT SUMMARY - SITE COVER

SITE COVER (PLANNING):

AND EXPRESSED AS A PERCENTAGE.

THE TERM DOES NOT INCLUDE:

GAZEBO OR SHADE STRUCTURE;

CHANGED, THE LEVEL AS LAWFULLY CHANGED.

THE PROPORTION OF THE SITE COVERED BY A BUILDING(S), STRUCTURE(S) ATTACHED TO THE BUILDING(S) AND CARPORT(S), CALCULATED TO THE OUTER MOST PROJECTIONS OF THE BUILDING(S)

(A) ANY STRUCTURE OR PART THEREOF INCLUDED IN A LANDSCAPED OPEN SPACE AREA SUCH AS A

THE LEVEL OF THE NATURAL GROUND, OR, WHERE THE LEVEL OF THE NATURAL GROUND HAS BEEN

(B) BASEMENT CAR PARKING AREAS LOCATED WHOLLY BELOW GROUND LEVEL.


Drawing Status DEVELOPMENT **APPLICATION**


Drawing Details

Scale 1 : 250@ A1 Date 10/03/22 Job No 9663 SG Drawn ND Checked

Drawing No DA50.002

Revision

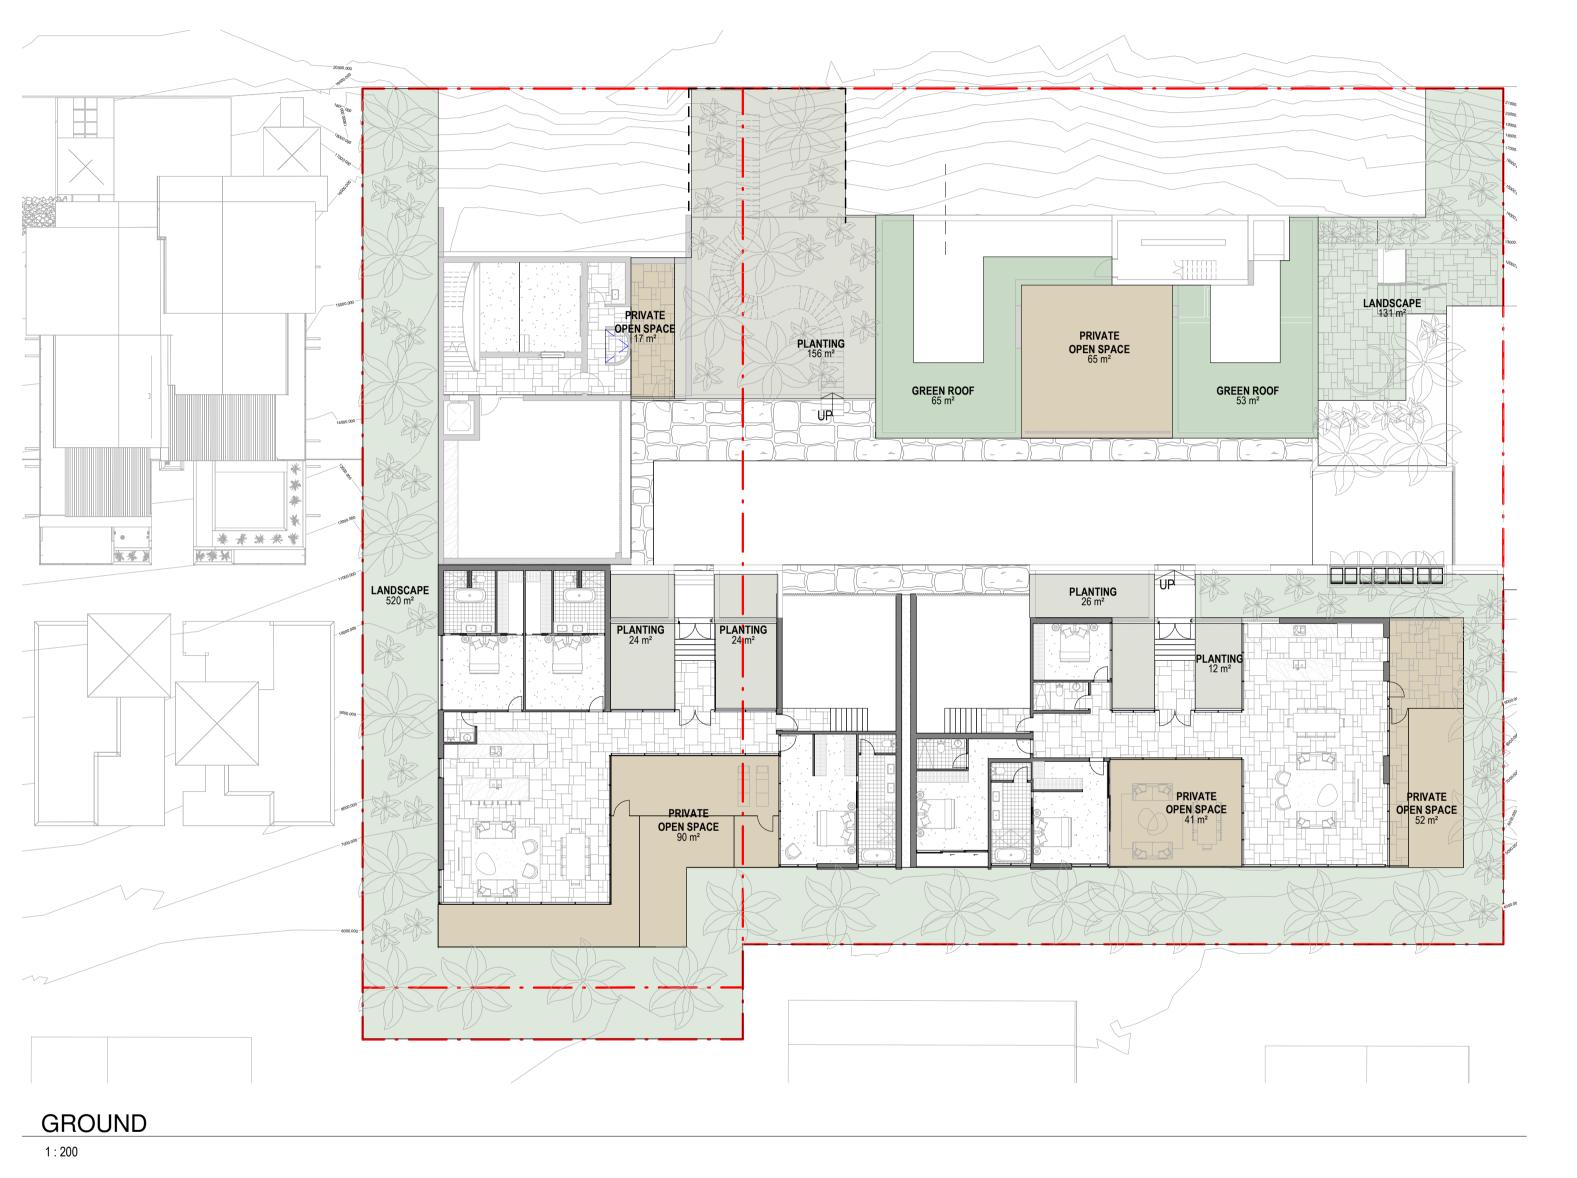

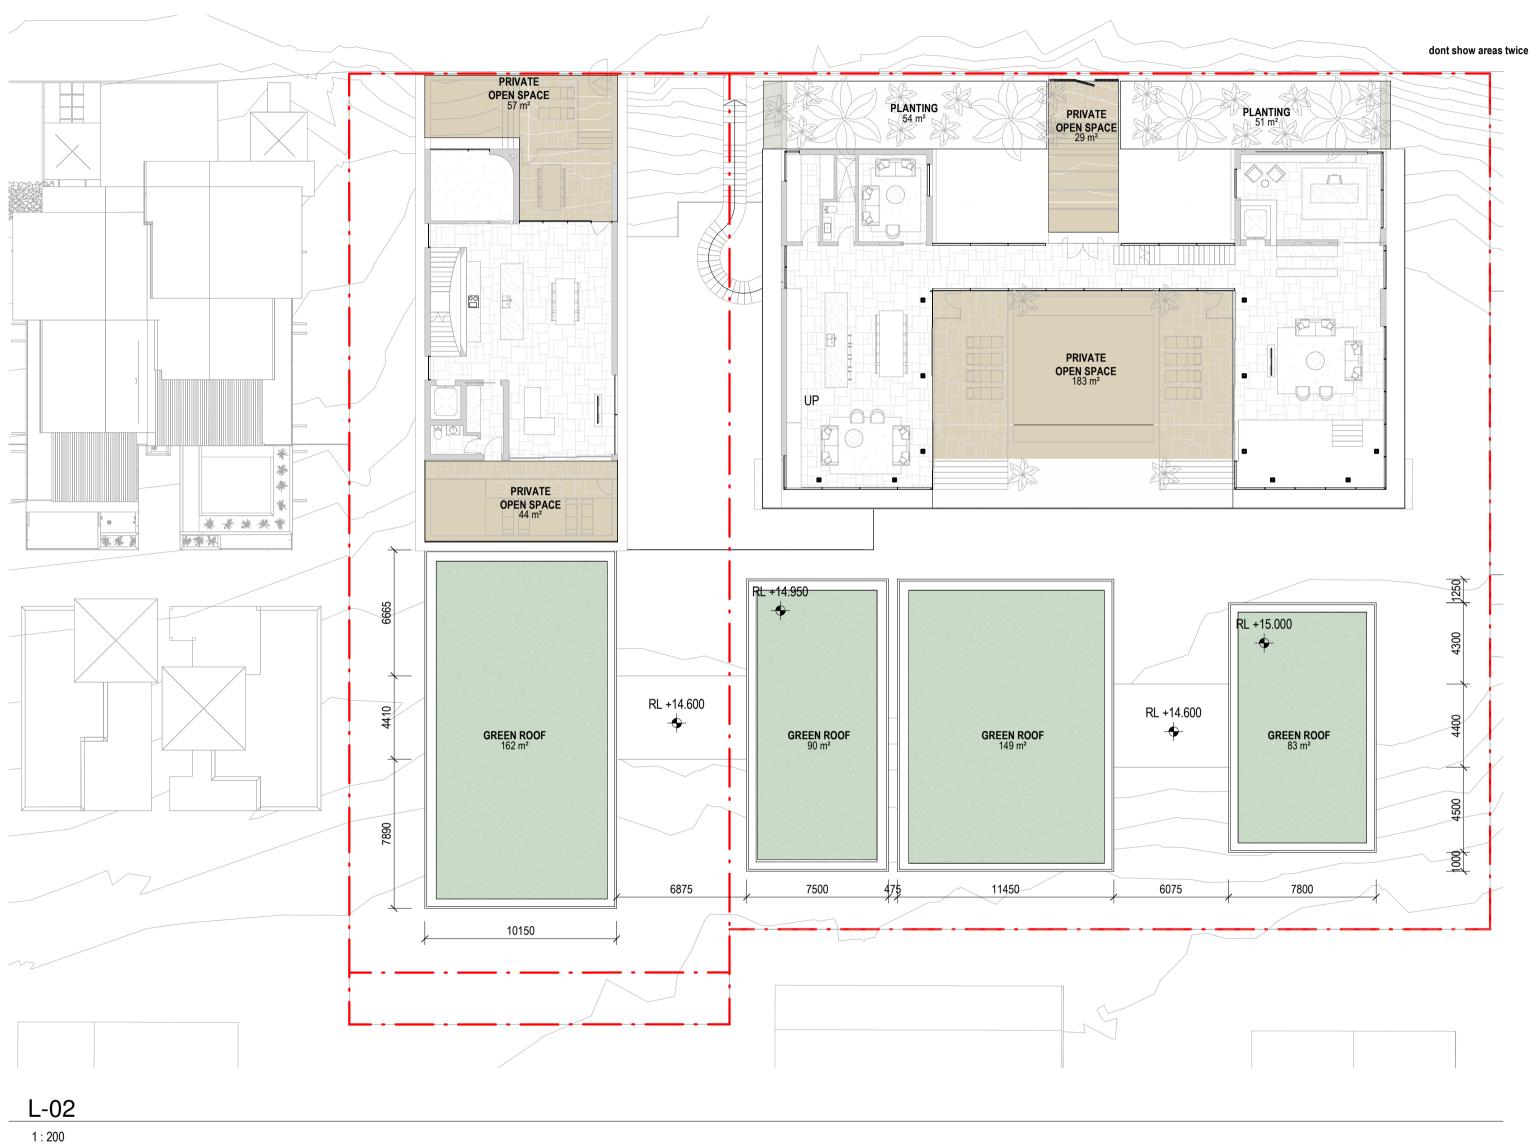

LANDSCAPE/OPEN SPACE REQUIREMENTS:

A minimum of 35% of the site is allocated as landscaping and recreation area.

Development provides landscaping as follows: (a) A dense landscape planting strip of at least 2 metres width suitable for deep planting is provided and maintained along all street frontages; (b) A dense landscape planting strip of at least 1.5 metres width suitable for deep planting is provided along all side and rear boundaries.

*not including green roof area


Development provides private open space which: (a) for ground storey dwellings, comprises of a minimum area of 35m2 with a

minimum dimension of 3 metres; (b) for dwellings above ground storey, comprises of a balcony with minimum area of 12m2 and a minimum dimension of 3 metres.


Client

Development provides private open space areas that are: (a) directly accessible from internal primary living area of the dwelling (not bedrooms);

(b) provided with a screened area of 2m2 minimum dimension capable of screening air conditioning plant, private clothes drying etc... (c) provided with adjustable, moveable or operable privacy screening where appropriate.

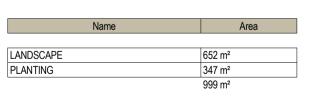

35% Landscape Coverage*

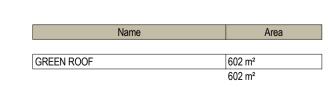


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PROJECT NORTH



Project Manager

Structural Engineer Mechanical Engineer

Consultants

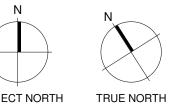Fire Engineer

Electrical Engineer

GURNER TM

GURNER™

Project Title 69-73 MURPHY STREET

PORT DOUGLAS

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Drawing Title

DEVELOPMENT SUMMARY -LANDSCAPE

Drawing Status DEVELOPMENT **APPLICATION**

Drawing Details Scale Date Job No

Drawn

Checked **Drawing No** Revision DA50.003


1 : 200@ A1

10/03/22


9663

SG


ND

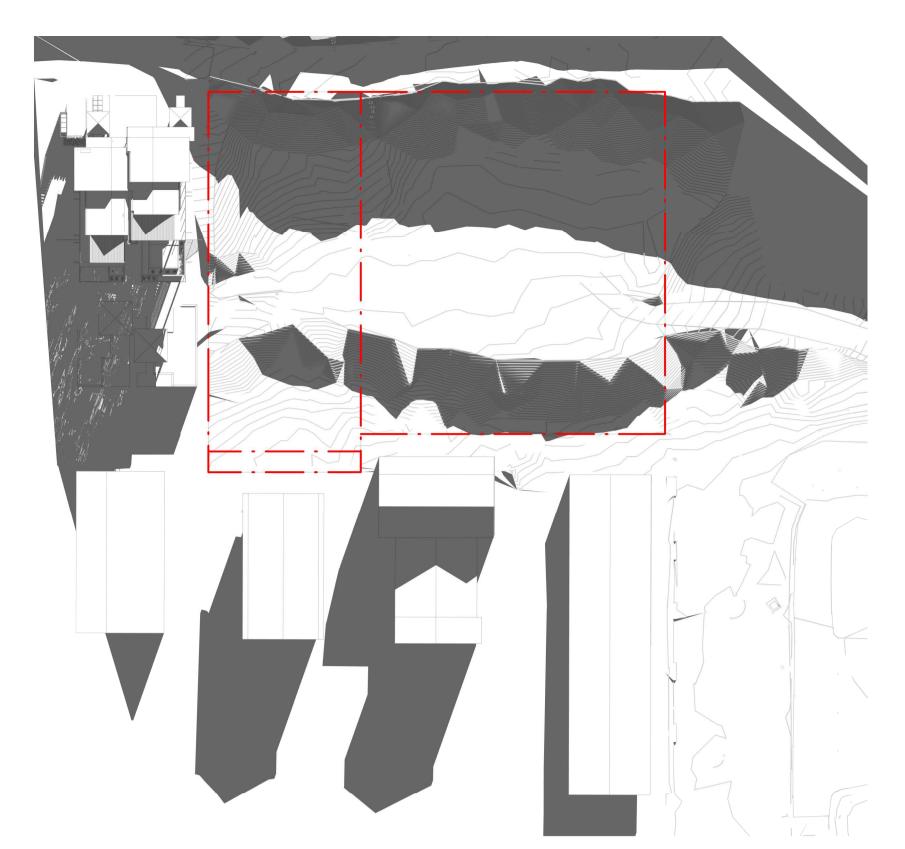


21 JUNE - 9AM EXISTING 1:500

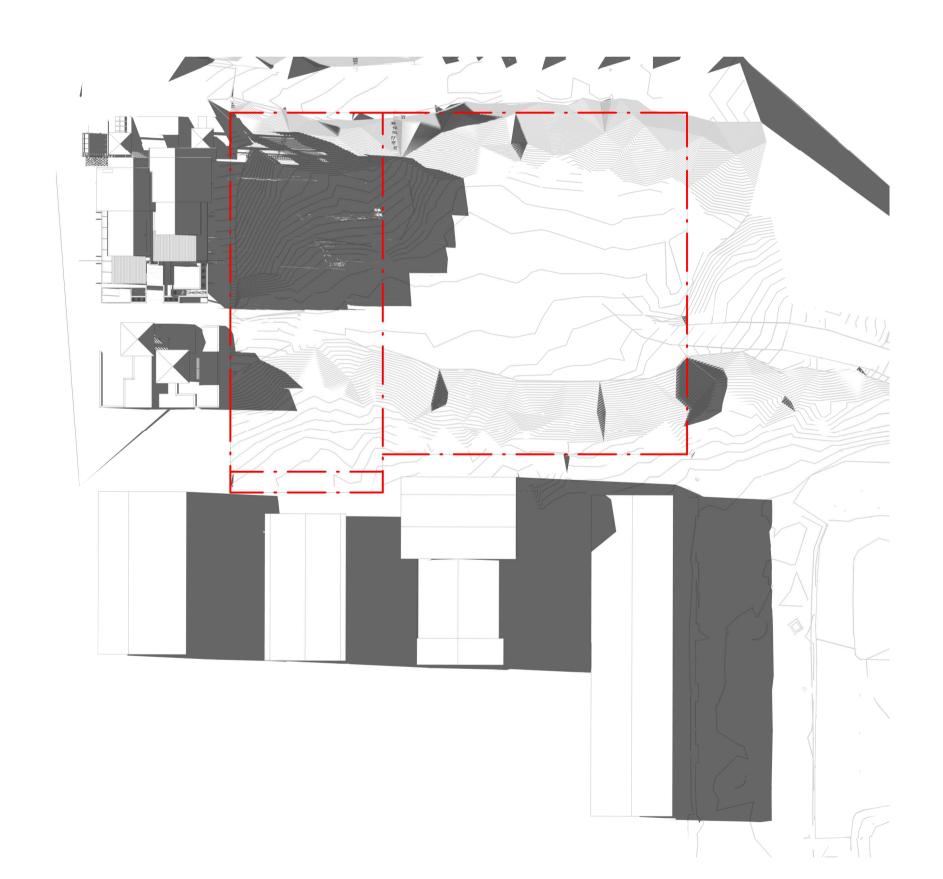

21 JUNE - 4PM EXISTING 1:500

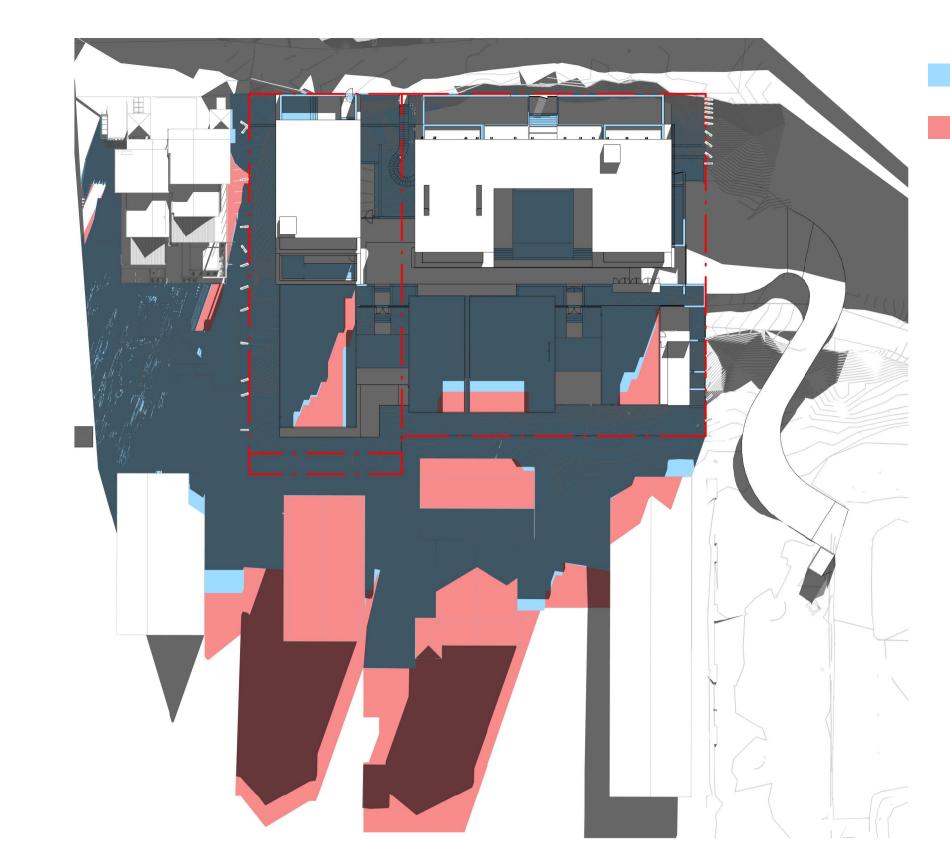

21 JUNE - 9AM PROPOSED 1:500

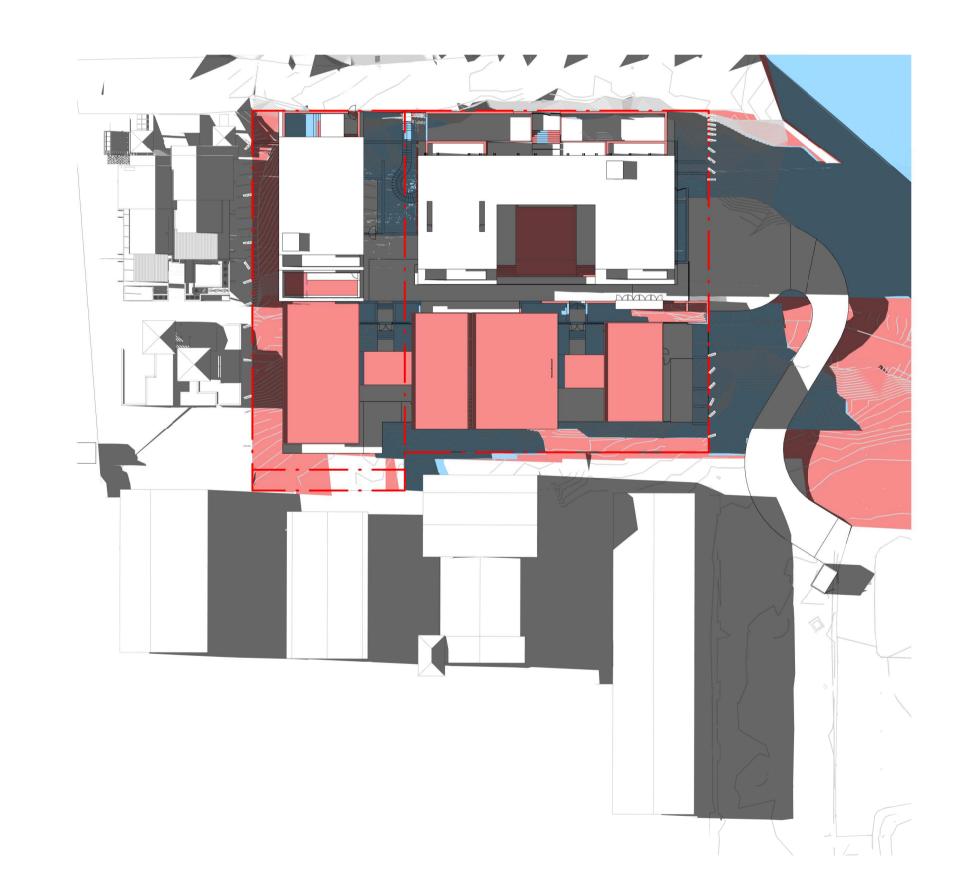

21 JUNE - 4PM PROPOSED

1:500


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Consultants

Project Manager Structural Engineer

Mechanical Engineer Fire Engineer

Electrical Engineer

Client **GURNER TM**

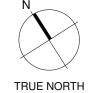Project Title 69-73 MURPHY GURNER™

STREET PORT DOUGLAS

EXTENT OF PROPOSED SCHEME - SHADOW DENOTED IN BLUE

EXTENT OF HOTEL SCHEME - SHADOW DENOTED IN RED

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Drawing Title

SOLAR ANALYSIS -JUNE 21


Drawing Status DEVELOPMENT APPLICATION

Drawing Details Scale

1 : 500@ A1 Date 10/03/22 Job No 9663 SG Drawn ND Checked

Drawing No DA80.001

Revision

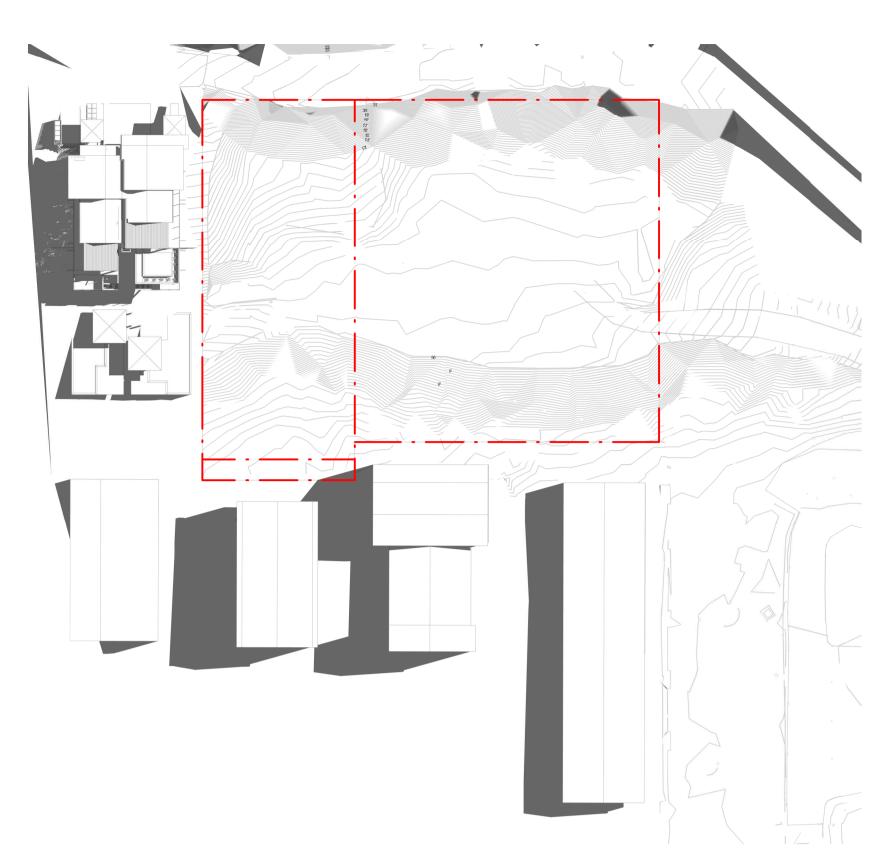



1 : 500



21 DEC - 4PM EXISTING

1 : 500



21 DEC - 9AM PROPOSED

1:500

21 DEC - 4PM PROPOSED

1 : 500

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Revisions

A 15/09/21 FOR INFORMATION
B 22/09/21 DRAFT DA
C 04/10/21 ISSUE FOR DA
D 18/02/22 FOR INFORMATION
E 10/03/22 ISSUE RFI 01

Notes

Consultants

Project Manager

Structural Engineer

Mechanical Engineer

Fire Engineer

Electrical Engineer

GURNER TM
GURNER TM

Project Title

69-73 MURPHY STREET PORT DOUGLAS

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Drawing Title
—

SOLAR ANALYSIS -DECEMBER 21

Drawing Status
DEVELOPMENT
APPLICATION

Drawing Details —

 Scale
 1:500@ A1

 Date
 10/03/22

 Job No
 9663


 Drawn
 SG

 Checked
 ND

Drawing No
—
DA80.002

No Revision E

MATERIAL FINISHES PALETTE

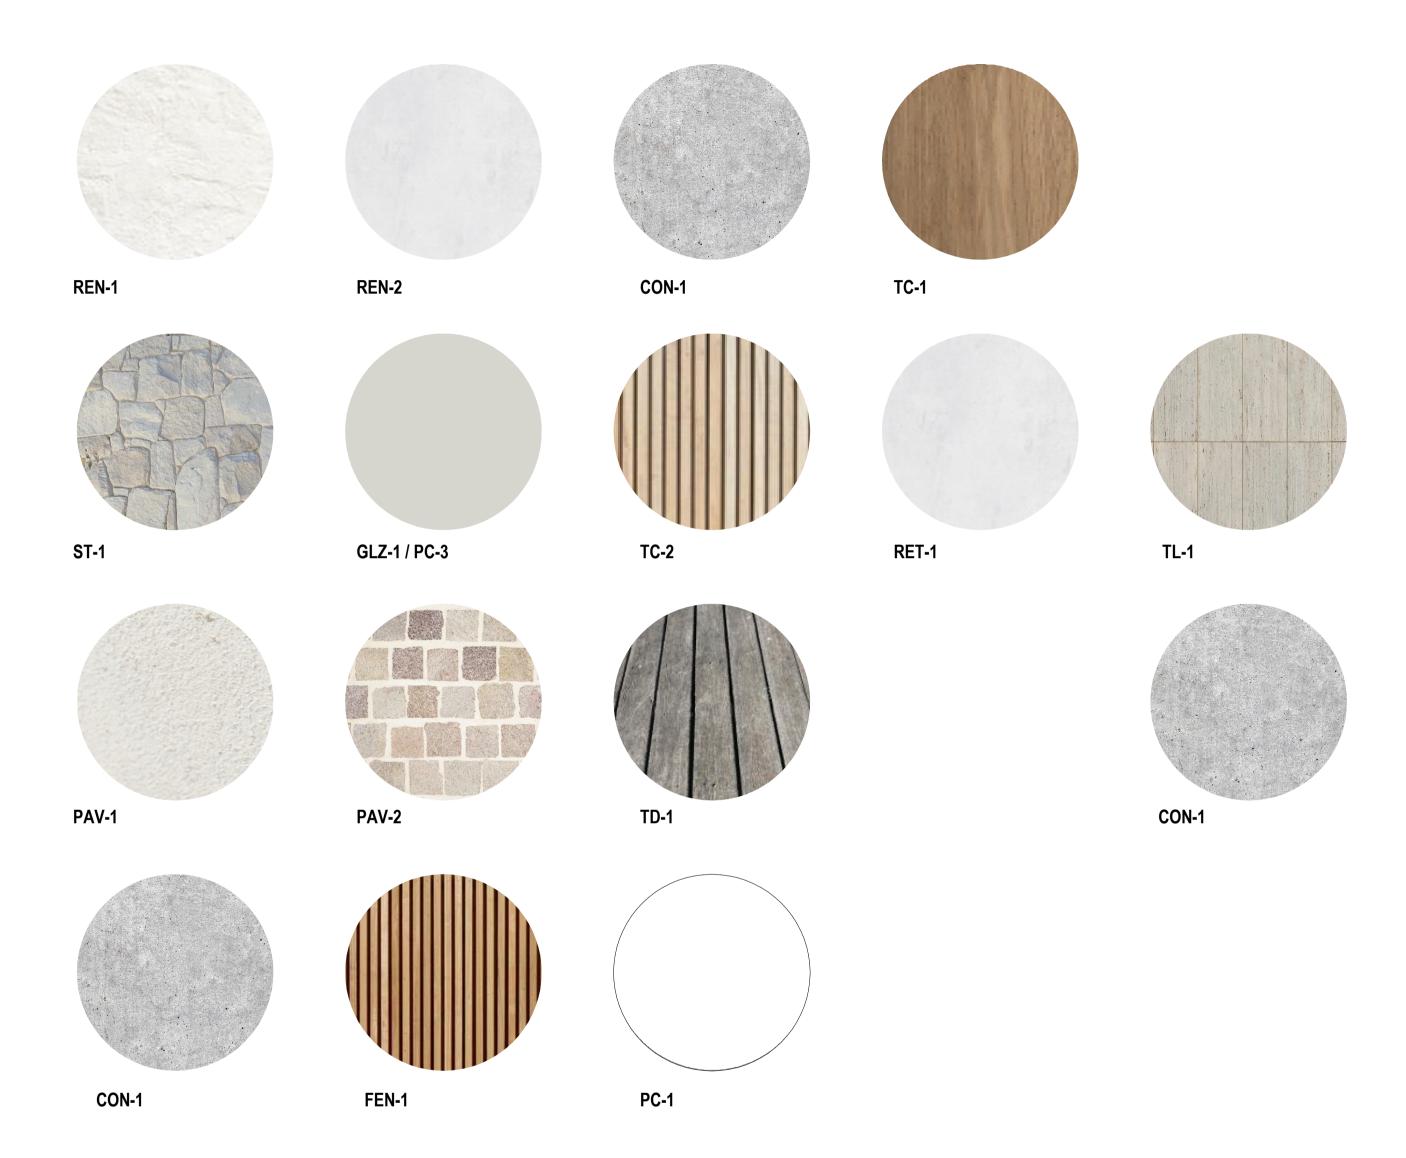

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CODE	DESCRIPTION
BAL-1	FRAMELESS GLAZED BALUSTRADE
	1200mm
CON-1	IN-SITU CONCRETE
FEN-1	TIMBER FENCING
GLZ-1/PC-3	CLEAR GLAZING / LIGHT GREY OR SIMILAR
PAV-1	TILED PAVING
PAV-2	COBBLED STONE PAVING OR STAMPED
	CONCRETE OR SIMILAR
PAV-3	CRUSHED ROCK
REN-1	TEXTURED RENDER FINISH
ST-1	STACKED STONE WALL
TC-1	TIMBER CLADDING OR FC SHEET, OR
	SIMILAR

Consultants

Project Manager

Structural Engineer

Mechanical Engineer

Fire Engineer

Electrical Engineer

Client —

GURNER TM

GURNER™

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Registered Architects and Designers www.warrenandmahoney.com Project Title
—

69-73 MURPHY STREET PORT DOUGLAS

Drawing Title
—

MATERIALS

Drawing Status DEVELOPMENT APPLICATION

Drawing Details

1 : 1@ A1 Scale 04/10/21 Date Job No 9663 SG ND Drawn Checked

Drawing No

DA90.001



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VIEW 1A: VIEW FROM THE ESPLANADE - LOOKING NORTH PROPOSED BUILDING ARTIST IMPRESSION



VIEW 1B: VIEW FROM THE ESPLANADE - LOOKING NORTH PROPOSED BUILDING OUTLINE

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Notes —

Consultants

Project Manager

Structural Engineer

Electrical Engineer

Mechanical Engineer

Fire Engineer

Client —

GURNER TM GURNER™ Project Title

69-73 MURPHY STREET PORT DOUGLAS

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Drawing Title

PERSPECTIVES -STREET VIEW 01

Drawing Status DEVELOPMENT APPLICATION

Drawing Details


Scale @ A1 Date 10/03/22 Job No 9663 WAM Drawn ND Checked

Drawing No DA90.011

Revision \bigcirc



VIEW 2A: VIEW FROM GARRICK ST - LOOKING NORTH PROPOSED BUILDING ARTIST IMPRESSION

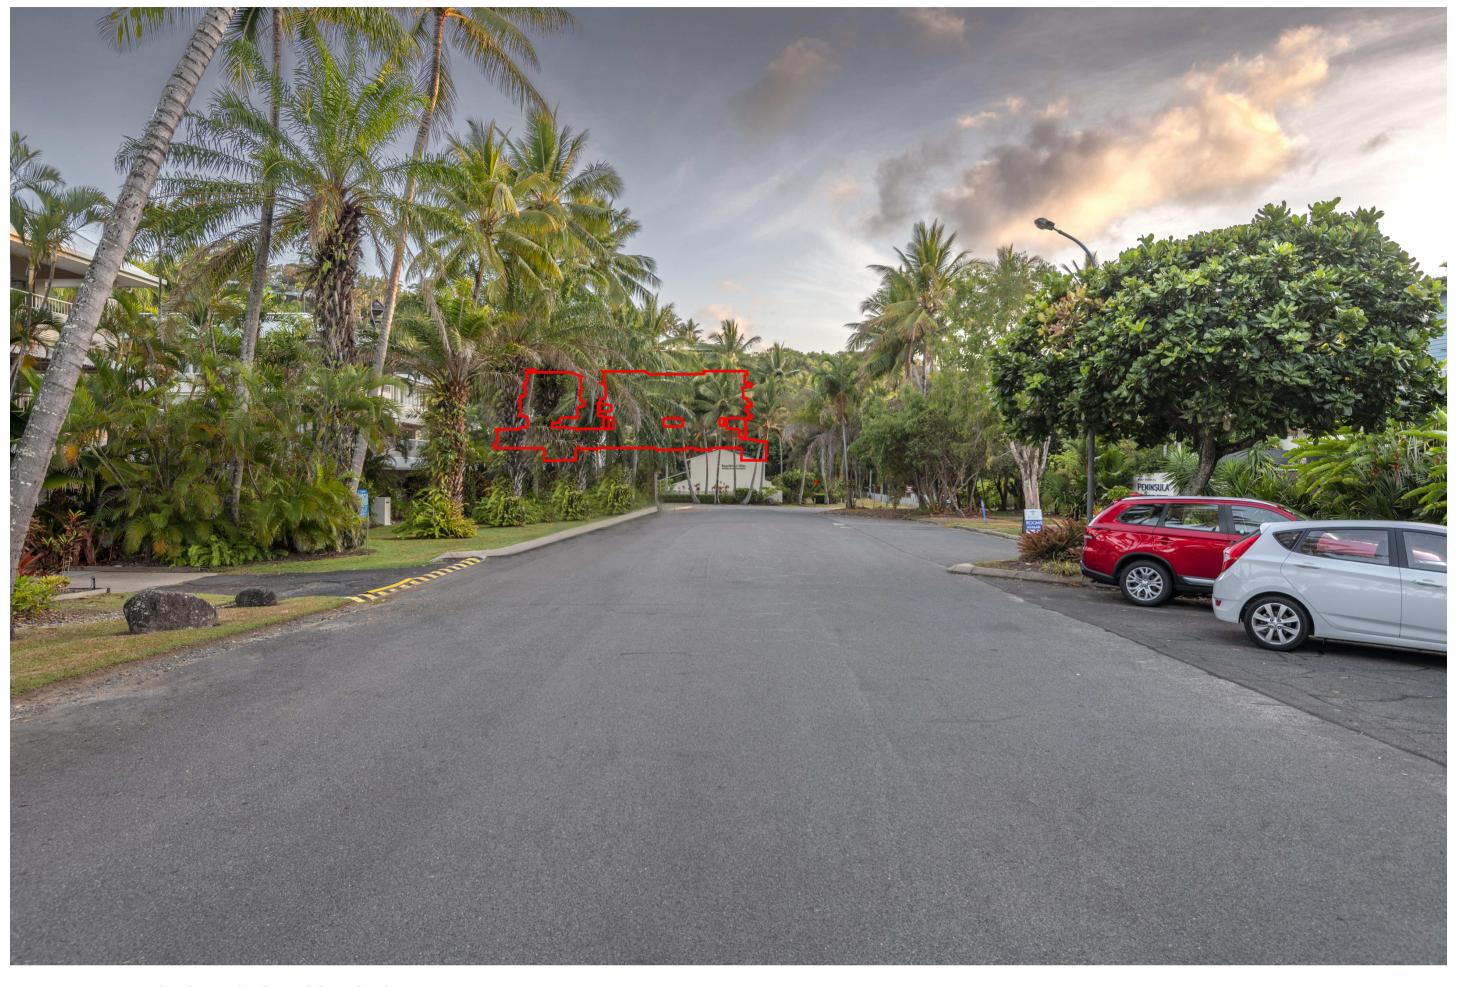

VIEW 2B: VIEW FROM GARRICK ST - LOOKING NORTH PROPOSED BUILDING OUTLINE

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Notes —

Consultants

Project Manager

Structural Engineer

Mechanical Engineer

Fire Engineer

Electrical Engineer

Client

GURNER TM GURNER™ Project Title

69-73 MURPHY STREET PORT DOUGLAS

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Drawing Title

PERSPECTIVES -STREET VIEW 02

Drawing Status DEVELOPMENT **APPLICATION**

Drawing Details

Scale @ A1 Date 10/03/22 Job No 9663 WAM Drawn Checked Checker

Drawing No DA90.012

Revision

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VIEW 3: VIEW FROM THE ESPLANADE - LOOKING NORTH PROPOSED BUILDING OUTLINE



VIEW 3A: VIEW FROM THE ESPLANADE - LOOKING NORTH PROPOSED BUILDING MASSING PREVIOUS DA - SHOWN DASHED

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Notes —

Consultants

Project Manager

Structural Engineer

Mechanical Engineer

Electrical Engineer

Fire Engineer

Client —

GURNER TM GURNER™ Project Title

69-73 MURPHY STREET PORT DOUGLAS

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Drawing Title

PERSPECTIVES -STREET VIEW 03

Drawing Status DEVELOPMENT APPLICATION

Drawing Details Scale @ A1 Date 10/03/22 Job No 9663 WAM Drawn

Drawing No

Checked


Revision DA90.013

Checker

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VIEW 4A-2: VIEW LOOKING WEST PROPOSED BUILDING MASSING



VIEW 4B-2: VIEW LOOKING WEST PROPOSED BUILDING MASSING OUTLINE PREVIOUS DA - SHOWN DASHED
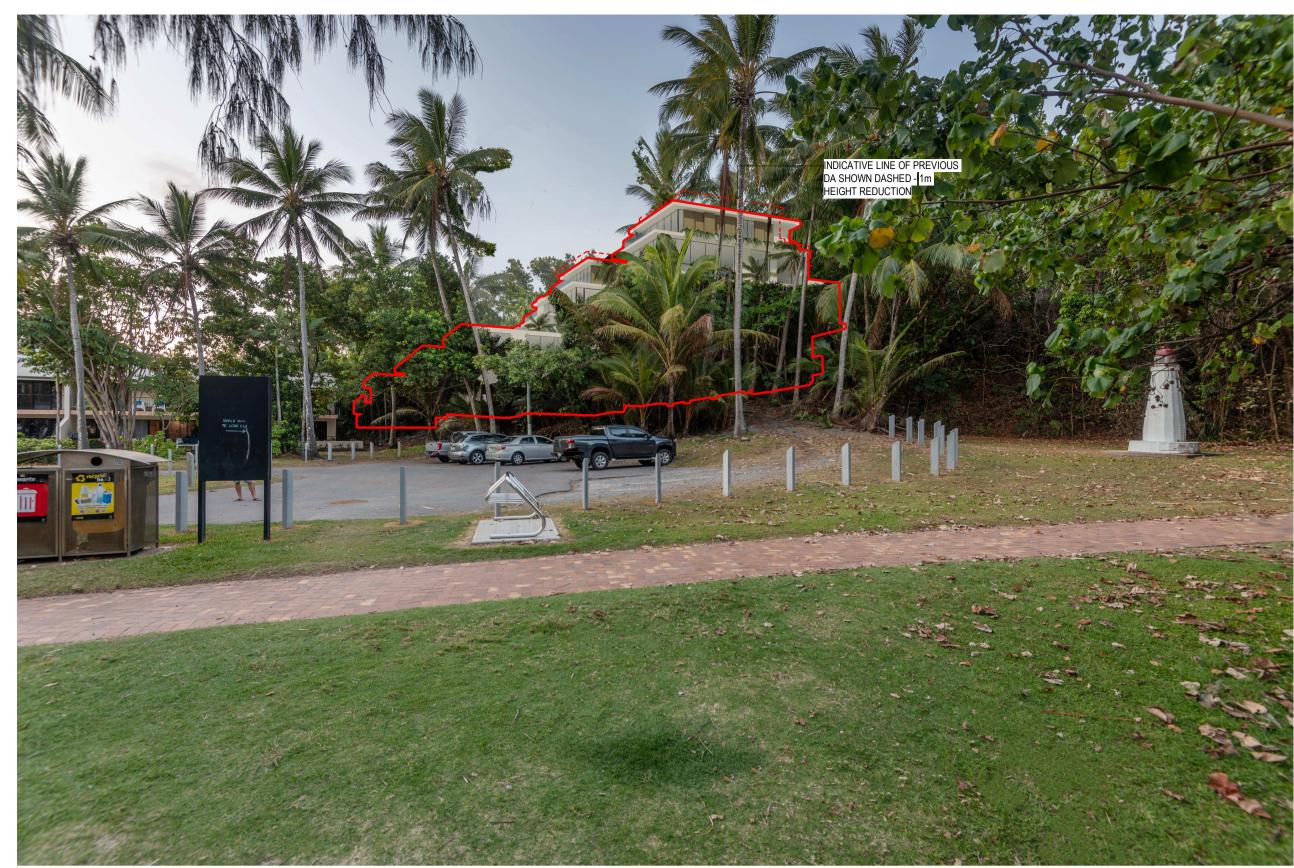
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Consultants
—

Project Manager

Structural Engineer

Mechanical Engineer

Fire Engineer

Electrical Engineer

Client —

GURNER TM GURNER™ Project Title
—

69-73 MURPHY STREET PORT DOUGLAS

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Drawing Title
—

PERSPECTIVES -STREET VIEW 04


Drawing Status DEVELOPMENT APPLICATION

Drawing Details

Scale @ A1 Date 10/03/22 Job No 9663 Drawn WAM Checked Checker

Drawing No DA90.014

Revision

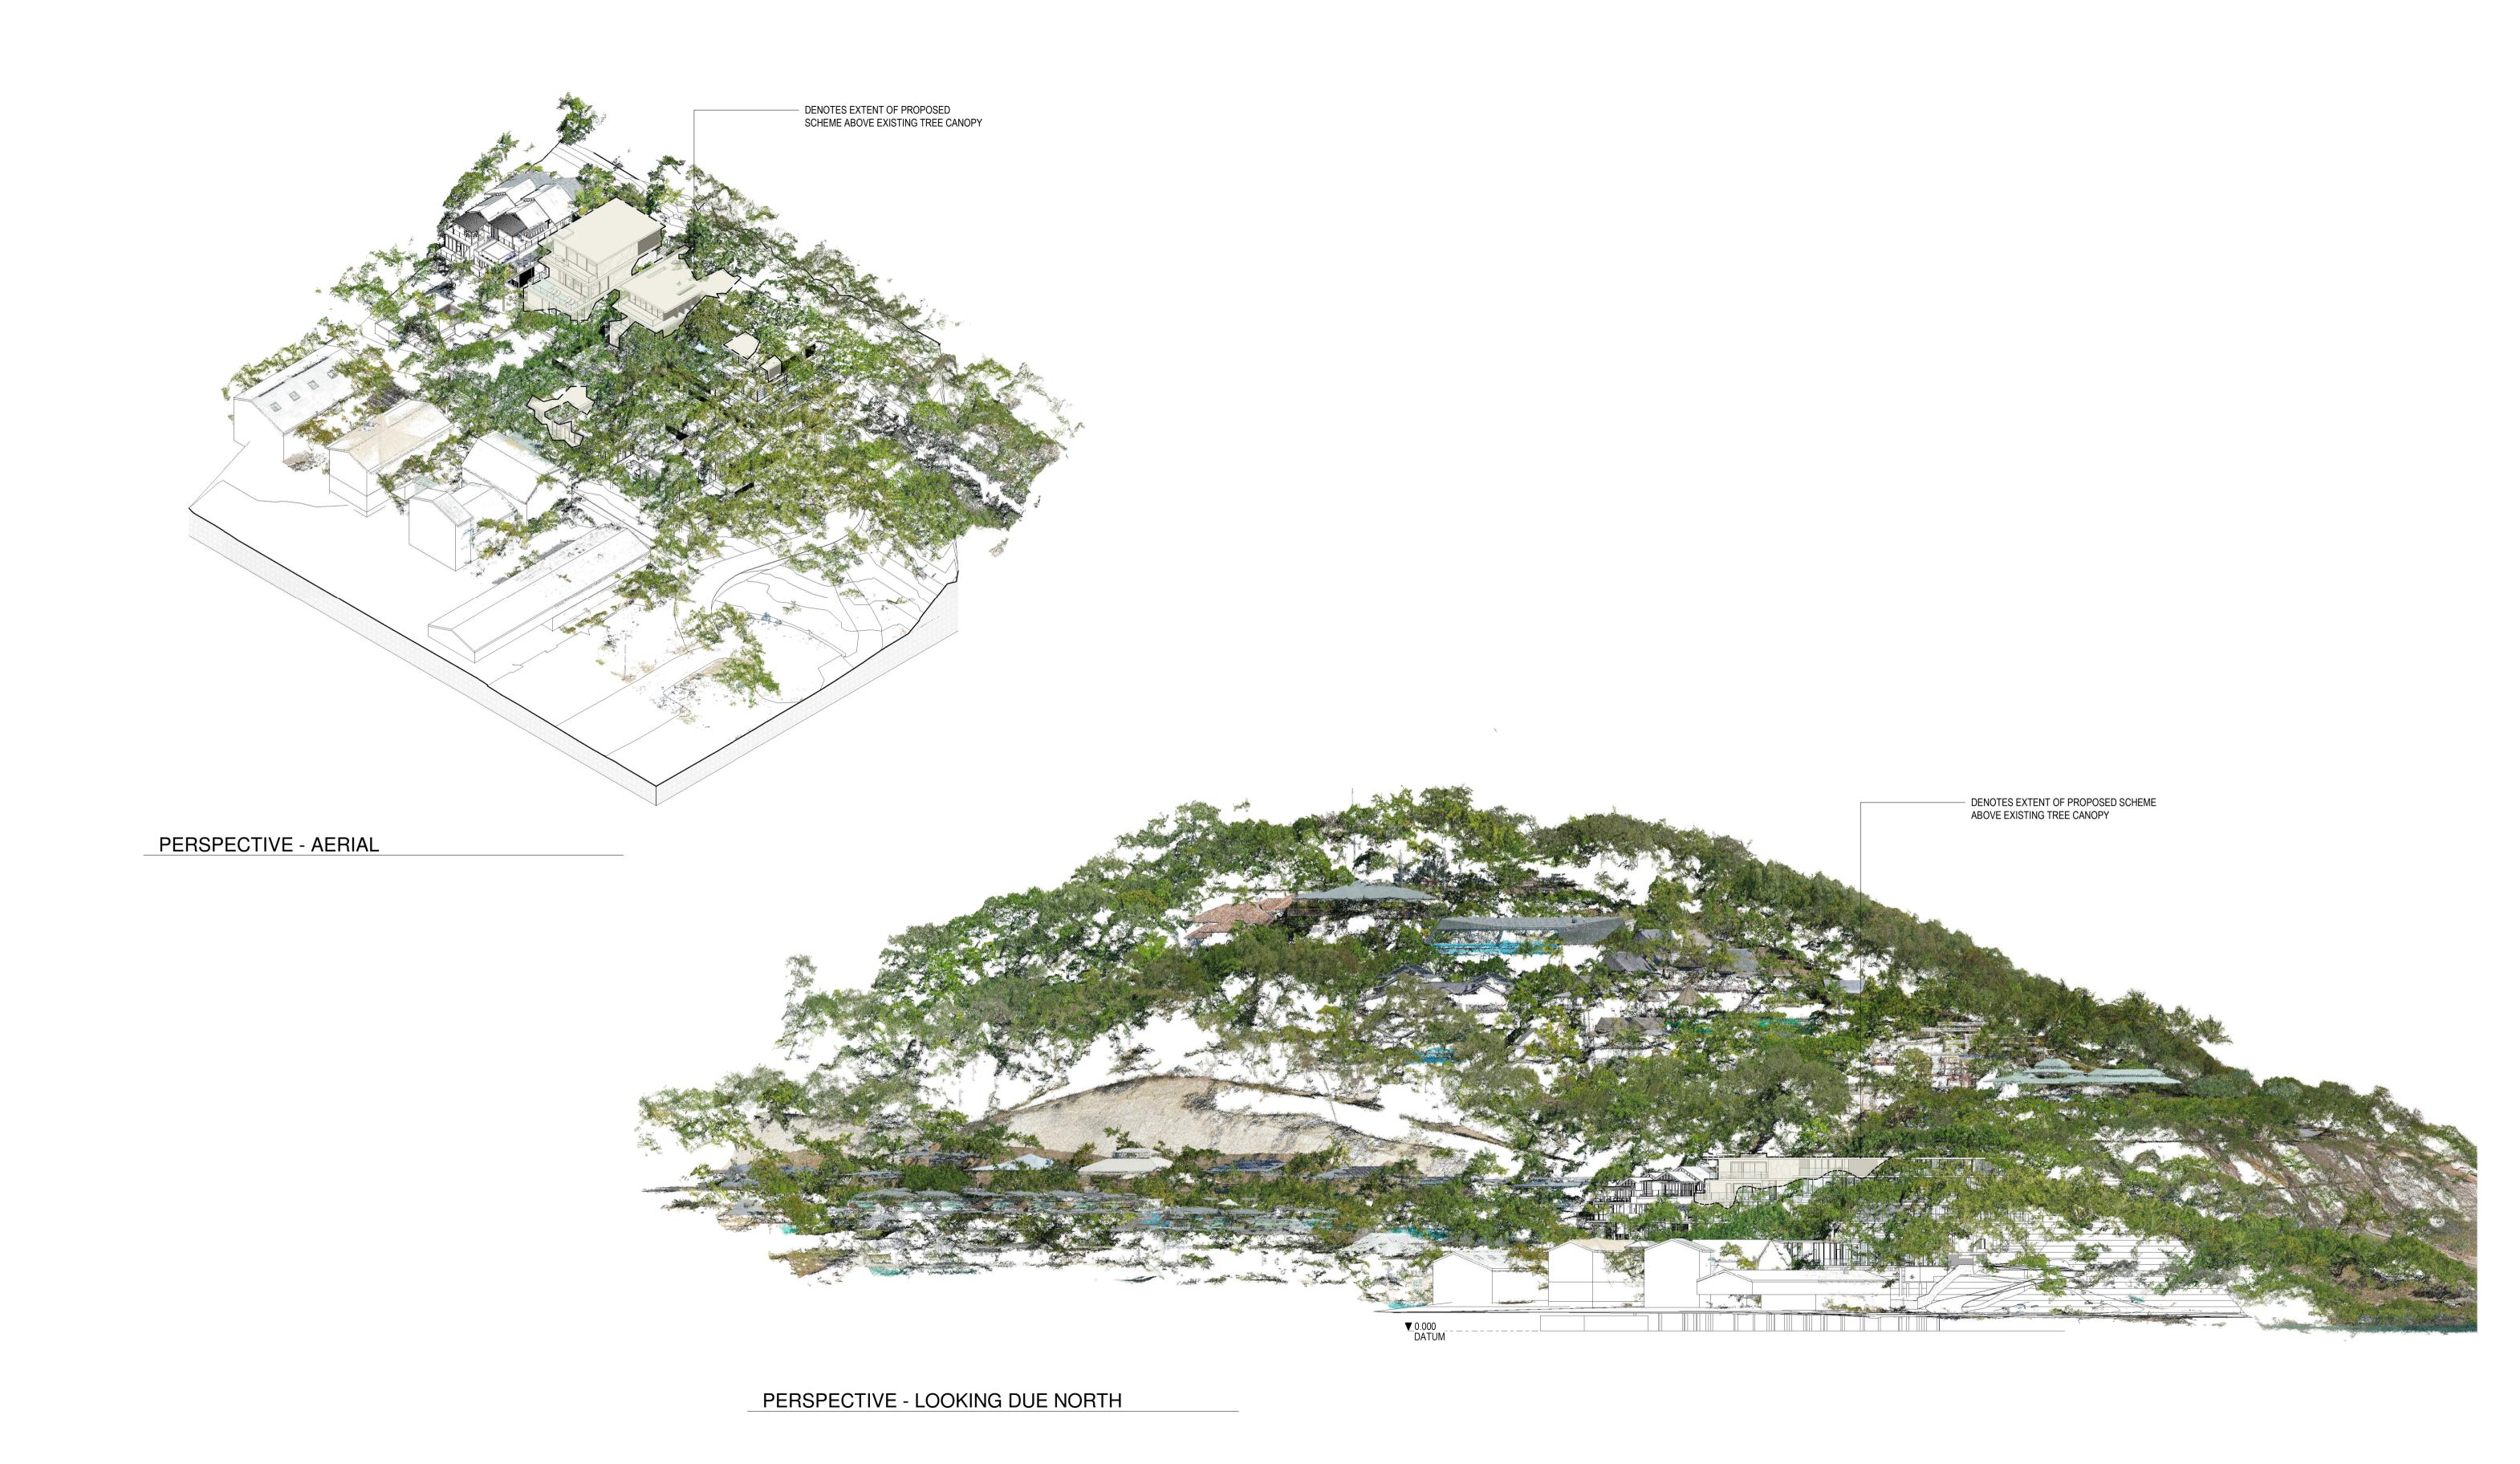

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Revisions

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Consultants

Project Manager Structural Engineer

Mechanical Engineer

Fire Engineer Electrical Engineer

GURNER TM GURNER™

Project Title 69-73 MURPHY

STREET PORT DOUGLAS

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Drawing Title
—

PERSPECTIVES - EX. TREE CANOPY

Drawing Status DEVELOPMENT APPLICATION

Drawing Details

Job No Drawn

1 : 500@ A1 04/10/21 9663 SG ND Checked

Drawing No DA90.020

Annexure 2

3D Views

