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10 June 2020

Administration Office 64 - 66 Front St Mossman P 07 4099 9444 F 07 4098 2902

 Enquiries:
 Neil Beck

 Our Ref:
 OP 2020_3493/1 (956644)

 Your Ref:
 12520641

KS5 Pty Ltd C/- Greg Applin - GHD PO Box 819 CAIRNS QLD 4870

Dear Sir

Development Application for Operational Works At 20-30 Langley Road Port Douglas On Land Described as LOT: 5 RP: 804926

Please find attached the Decision Notice for the above-mentioned development application.

Please quote Council's application number: OP3493/2020 in all subsequent correspondence relating to this development application.

Also find attached a 'Pre-Start' meeting template, which identifies the information that must be provided for Council approval, prior to the commencement of works.

The template also provides the Consulting Engineer with a format for conducting the meeting. An invitation to attend the meeting must be sent to Council's representative Neil Beck on telephone number 07 4099 9451, giving at least five (5) working days notification if possible.

In addition to the Decision Notice, Council provides the following 'Advice Statement' which relates to issues that are relevant to the proposed works:

1. The Consulting Engineer is to present all contractors with a copy of this Decision Notice and the Council approved plans, prior to the commencement of works.

Should you require any clarification regarding this, please contact Neil Beck on telephone 07 4099 9451.

Yours faithfully

For Paul Hoye Manager Environment & Planning

encl.

Decision Notice

- Approved Drawing(s) and/or Document(s)
- Concurrence Agency Response
- Advice For Making Representations and Appeals



Decision Notice

Approval (with conditions)

Given under section 63 of the Planning Act 2016

Applicant	Details
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Name: Postal Address: KS5 Pty Ltd C/- Greg Applin - GHD PO Box 819 CAIRNS QLD 4870

Property Details

Street Address:	20-30 Langley Road PORT DOUGLAS
Real Property Description:	LOT: 5 RP: 804926
Local Government Area:	Douglas Shire Council

Details of Proposed Development

Development Permit for Operational Works

Decision

Date of Decision: Decision Details: 8 June 2020 Approved (subject to conditions)

Approved Drawing(s) and/or Document(s)

Copies of the following plans, specifications and/or drawings are enclosed.

Drawing No.	Description
42-12520641-C001	COVER SHEET & SITE PLAN
42-12520641-C002	STANDARD NOTES
42-12520641-C003	GENERAL ARRANGEMENT PLAN
42-12520641-C004	DEMOLITION / CLEARING PLAN
42-12520641-C005	CONTROL LINE SETOUT

42-12520641-C006	TYPE CROSS SECTIONS & DETAILS
42-12520641-C007	MISCELLANEOUS DETAILS
42-12520641-C008	LONGTITUDINAL SECTIONS - ROAD 01 & DRAIN 01
42-12520641-C009	LANGLEY ROAD CROSS SECTIONS SHEET 1 OF 2
42-12520641-C010	LANGLEY ROAD CROSS SECTIONS SHEET 2 OF 2
42-12520641-C011	ROAD 01 CROSS SECTIONS
42-12520641-C012	DRAIN 01 CROSS SECTIONS
42-12520641-C013	LANGLEY ROAD ROADWORKS PLAN
42-12520641-C014	LANGLEY ROAD SETOUT PLAN
42-12520641-C015	LANGLEY ROAD / ROAD 01 INTERSECTION PLAN
42-12520641-C016	TRENCH GRATE DETAILS
42-12520641-C017	ROAD 01 CUL-DE-SAC SETOUT PLAN
42-12520641-C018	SOLANDER BOULEVARD ACCESS - PLAN &
	DETAILS
42-12520641-C019	EARTHWORKS PLAN
42-12520641-C020	RETAINING WALLS AND FENCING PLAN
42-12520641-C021	RETAINING WALL DETAILS
42-12520641-C022	BEACH ACCESS STAIRS
42-12520641-C023	SEWER RETICULATION PLAN
42-12520641-C024	SEWER LONG SECTIONS
42-12520641-C025	WATER RETICULATION PLAN
42-12520641-C026	EROSION AND SEDIMENT CONTROL STRATEGY -
	PLAN
42-12520641-C027	EROSION AND SEDIMENT CONTROL STRATEGY -
	DETAILS SHEET 1 OF 2
42-12520641-C028	EROSION AND SEDIMENT CONTROL STRATEGY -
	DETAILS SHEET 2 OF 2

Landscape Plans

Drawing No.	Description
198-L00 Rev D	COVER PAGE
198-L101 Rev D	LANDSCAPE PLAN & PLANTING SCHEDULE
198-L102 Rev D	ENTRY WALL DETAILS
198-L103 Rev D	TYP. DETAILS
198-L200 Rev C	COVER PAGE
198-L201 Rev C	LANDSCAPE PLAN 01
198-L202 Rev C	LANDSCAPE PLAN 02 & DETAIL PLANS
198-L203 Rev C	TYP. DETAILS & PLANTING SCHEDULE
198-L204 Rev C	ENTRY WALL, RET WALL AND STAIR DETAILS

Note – The plans referenced above will require amending in order to comply with conditions of this Decision Notice.

Assessment Manager Conditions & Advices

1. General

a. Drawings must be submitted "for construction" and must be certified as approved by a registered professional engineer of Queensland (RPEQ).

2. Earthworks

a. The applicant is to ensure that any earthworks undertaken as part of the works maintains a free draining surface with no ponding of standing water resulting. Any amendments proposed to the existing finished surface profiles are to be identified

and reported to Council prior to being undertaken on site. Resultant amendments shall be recorded on as constructed drawings to be submitted at the completion of the project.

b. Earthworks on Stage 2 lots (Lot 7 and 9) are to be completed for a minimum of 1.5m east from the Stage 1 boundary to ensure no interfacing issues in the future stage.

3. Roads and Paths

- a. Pavement design details are to be confirmed prior to pavement construction. Details provided to Council shall include subgrade CBR results for each pavement section, confirmation of traffic loadings adopted (as per FNQROC requirements) and final pavement design.
- b. The integrity of the pavement at the proposed new intersection between Road 01 and Langley Road must be investigated by a suitably qualified and experienced person (RPEQ) and must be certified as suitable for the additional traffic loading and movements at the intersection. Council requires justification on why the pavement between Ch 40m and 70m is not being reconstructed consistent with the section up to Ch40m.
- c. Amended drawings are to be provided to include the 50mm AC overlay for the new intersection being created where the new cul-de-sac intersects with Langley Road. The applicant is to confirm the underlying pavement condition and may need to replace the pavement between Ch 40 and 70 subject to the outcomes of the pavement review.
- d. The applicant is to demonstrate that vehicles can turn around at Solander Boulevard without relying on the concrete pathway to complete the turn around manoeuvre. Turning templates for the B99 vehicle are to be provided to demonstrate that sufficient footprint exists. The turnaround area is to be imperviously sealed and must have a minimum 200mm gravel pavement for the full extent of the turning area as defined from the turn templates.
- e. The pathway in Solander Boulevard is to be constructed for the full frontage of the site as a concrete pathway in accordance with the FNQROC Development Manual;
- f. Tactile indicators are to be included on access ramps on footpaths and at other locations where required for compliance;
- g. An additional Bollard is to be placed on the Langley Raod side of the drain and culvert to prevent vehicles using the pathway to turn around.

4. Stormwater

- a. The proposed development must not create ponding nuisances and/or a concentration of stormwater flows to adjoining properties.
- b. All stormwater from the property must be directed to a lawful point of discharge such that it does not adversely affect surrounding properties or properties downstream, in accordance with the Queensland Urban Drainage Manual, Fourth Edition (2016).

c. Unless an alternative surface treatment is approved, otherwise approved, the full extent of the batters on the open drain on Langley Road and Solander Boulevard are to be turfed .

5. Sewer

a. Unless otherwise agreed with Council, the property connection branches for Lot 7 and 9 are to be completed with Stage 1 and finished 1m below the surface with appropriate marker, (minimum requirement is locator tape and surface picket to denote location).

6. Water

- a. The water reticulation layout is to be amended as follows:
 - i. All road crossings are to be minimum 100mm DICL, road crossing between lot 1 and Lot 8 to be amended;
 - ii. The section of water main nominated as DN125 main is to be replaced with DN150mm,
 - iii. All hose connection tappings are to be completed by the developer and the individual water service connections extended into the property by 0.5m. The property connections are to be located in the mid-point of the lot frontages unless otherwise approved by Council.
- b. Include on the water reticulation plan the location of light pole footings and confirm the clearance between the footing and the water main. The revised drawing is to be endorsed by Council prior to commencement of water reticulation works.
- c. The minimum clearance between light pole footings and water mains are to be in accordance with WSA and verified and recorded by the consulting engineer during construction.

7. Erosion and Sediment Control

a. A copy of the Contractor's Erosion and Sediment Control (ESC) Plan is to be submitted to Council and endorsed by the Consulting Engineer, prior to commencement of any works. In particular, the ESC Plan must address the Institution of Engineers Australia Guidelines for Soil Erosion and Sediment Control and the Environment Protection (Water) Policy and Clauses CP1.05, CP1.13 and D5.10 of Council's FNQROC Development Manual.

8. Landscape Plan

- a. Street trees are to be planted a minimum of 2000mm from back of kerb. Amended drawings are to nominate the location of trees and include this minimum offset.
- b. Replace Terminalia Muelleri with a non deciduous tree species such as Malaleuca Viridiflora or other suitable tree species in order to avoid blockages in drains and grates due to leaf drop and improve overall aesthetics.

c. All entry works and wall features are to be contained within the allotments and not located on road reserve. All landscape plantings other than street trees will be the Applicant or future owner's responsibility to maintain. Future owners are to be advised in writing of this requirement at the time of purchasing the land.

9. Miscellaneous

- a. The applicant is to provide a street lighting plan and show the locations of the street lights on the relevant civil plans prior to the pre-start meeting to confirm any conflicts between light pole locations and other services.
- b. Prior to the pre-start meeting, the applicant must provide written evidence from Ergon and Telstra confirming arrangements have been made for the provision of services to the stage.
- c. The applicant is to provide an acid sulphate report prior to the Prestart meeting and ensure that the Contractor is aware of the management measures and testing requirements where applicable.
- d. CCTV inspections are to be reviewed by the supervising engineer and the Engineering Report and Certification by an RPEQ provided to Council prior to Works Acceptance as required under FNQROC Development Manual CP1.25 Project Documentation.
- e. The applicant is to confirm that the fence is design has considered wind loading noting its total height and more exposed location on the top of the retaining walls.

Further Development Permits

Not applicable

Concurrence Agency Response

None Applicable


Currency Period for the Approval

This approval, granted under the provisions of the *Planning Act 2016*, shall lapse two (2) years from the day the approval takes effect in accordance with the provisions of Section 85 of the *Planning Act 2016*.

Rights to make Representations & Rights of Appeal

The rights of applicants to make representations and rights to appeal to a Tribunal or the Planning and Environment Court against decisions about a development application are set out in Chapter 6, Part 1 of the *Planning Act 2016*.

A copy of the relevant appeal provisions are attached.

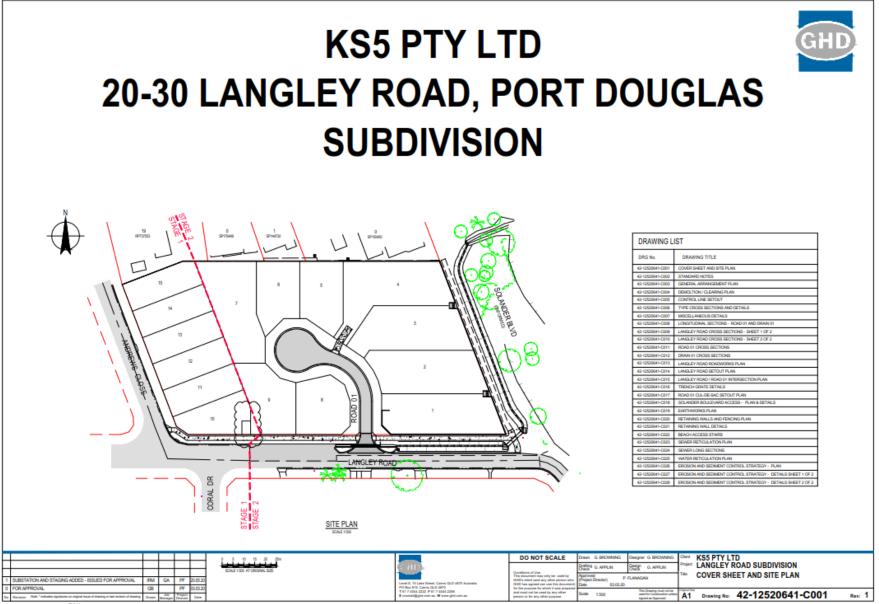

No Dales 20 May 2020 111 M AM Philled Myr. Plak Mashan Gal Phi No. C Users/insubar/Desiling/Temporary Phil/Andreas Control antigetical 1202061 CB11.4mg

SURVEY CONTROL NOTES

1. SURVEY CONDUCTED BY GARY POZZI- CADASTRAL SURVEYOR, PH 07 4057 7177

AND PSM SSMS RL 3 DH1 SIN OF LEVELS MGA ZONE SS MERCIAN

GENERAL NOTES

- ALL WORKS MUST BE CARRED OUT IN ACCORDANCE WITH THE RELEVANT PROPORTION DATES. SPECIFICATIONS, WHERE OFFERENCES EXIST BETWEEN THE PLANS AND THE DEVELOPMENT MANUAL, THESE PLANS SHALL THE PRECEDENCE.
- THE CONTRACTOR IS TO ENGLIRE A COPY OF THE OPERATIONAL WORKS APPROVAL IS AVAILABLE ONSITE: THE SITE FOREMANIS TO ENGLIRE ALL WORKS ARE UNDERTAKEN IN ACCORDINGS WITH THE APPROVAL.
- The LOCATORS OF UNREXPECTING SERVICES HAVE BEEN REPERTIONED FROM PORTIONE OF VALUES WARLES, ETC. PROFILO ANY DIRACTION EXEMPTION OF CONSTRUCTION OF SITE, THE CONTRACTOR MUST CONFICT RELEVANT AUTHORITIES FOR POSSIBLE LOCATION OF FURTHER SERVICES WID DETAILED LOCATION OF ALL SERVICES.
- 4. EXISTING SERVICES ARE TO BE PROTECTED FROM DAVINGE DURING CONSTRUCTION, WHERE NECESSARY THE CONTRACTOR SHALL COMPARING THE DESTINATION OF THE CONTRACTOR STATE OF THE INCLUSION OF THE OWNER OF THE CONTRACTOR SHALL BE COMPARING SERVICES IN POTOLNIC BEFORE COMMENCIANE WORKS. THE SUPERVISED OF SHALL BE COMPARING WORKS THE CONTRACTOR COMPARING SERVICES IN POTOLNIC BEFORE WORKS.
- 5 ALL DMENSIONS AND RADILARE EXPRESSED IN METRES UNLESS NOTED OTHER INSE.
- WHERE REFERENCE IS MADE TO THE STANDARD DRAWING, THE CONTRACTOR SHALL DRURE THAT THE LATEST VERSION SSUED BY THE RELEWANT AUTHORITY AT THE TIME OF CONSTRUCTION, IS USED.

EROSION AND SEDIMENT CONTROL NOTES

- PROR TO CONSTRUCTION COMMENCING. THE CONTRACTOR MUST PREPARE AN EROSION & SEDMENT CONTROL PLAN ESCP. TO IMPAGE THE SITE DURING CONSTRUCTION AND THE DEFECT LINEULTY PERIOD. 1.
- THE ESCP MUST BE CONSISTENT WITH THE APPROVED GROSION & SECHIER CONTROL STRATEGY (\$5:CS) AND SHALL THE INTO CONSIDERATION THE CONTRACTOR'S PROPOSED CONSTRUCTION METHODOLOgY AND PROGRAM.
- 1. AN ESCP THAT DIFFERS TO THE APPROVED ESCS MUST BE SUBMITTED TO THE SUPERINTENDENT FOR APPROVAL
- NO EARTHMORKS SHALL COMMENTS ON MY PART OF THE SITE FROM TO APPROFRATE EROSION AND SEEMENT CONTROL MEASURES GEING INSTALLED DOWNSTREAM OF THE SITE AND IN ACCORDANCE WITH THE APPROVED DSCP
- AT ALL TMES THE CONTRACTOR SHULL MONTOR THE PREVALING WEATHER CONDITIONS AND TWE ALL NECESSARY PREVAILORS TO CONTROL EROSION HID DOWNSTREAM SEDMENTATION DURING ALL STAGES OF CONSTRUCTION.
- 6. THE INFACT ON THE ENVIRONMENT SHALL BE MININGED BY DESERVING THE FOLLOWING CONSTRUCTION
 - PRACTICES
 AREAS DISTURBED BY CONSTRUCTION TRAFFIC AND PROCEDURES SHALL BE MINIMSED.
 - MININGE TRAFFIC MOVEMENTS AND SPEEDS ON EXPOSED SURFACES.
 REVEGETATION OF DISTURBED AREAS SHALL BE OVERHED OUT SOON AFTER THE COMPLETION OF TOPSOL. PLACEMENT.
 - RUOW DIVERSION SHALL BE CHERRED OUT BY EARLY INSTALLATION OF DRAINS ALONG TOPS OF BATTERS WITH APPROPRIATE SILTATION CONTROL DEVICES.
 - WITH APPROPAGES ALTATION CONTROL DAVIDUS. SEDMENT INTERCEPTION BY THE PLACEMENT OF SUITIALE RETENTION SYSTEMS ACROSS GRAINAGE LINES AND AT INTERCEPTION POINTS FOR SOM THE CONSTRUCTION AND STODIPLE AREAS.
- ALL ACCESS TO AND FROM THE SITE SHALL BE WAIA TEMPORARY CONSTRUCTION ENTERIENT. THE CONTRACTOR SHALL NORMATE A PROPOSED ACCESS LOCATION ON THE ESC PLAN FOR APPROVAL BY THE SUPERIMEMENT.
- STOOPLES SHUL OLY BE LOOKTED IN AREAS NORMATED ON THE PROJECT DRAWINGS OR APPROVED BY THE SUPERIMITINGENT ALL STOOPLES MUST HAVE APPROPRIATE ESCIMENAURES INSTALLED TO PROVENT SEDMENT. TRANSPORT. THE MAXIMUM HEIGHT OF ALL STOCKPLES MUST BE LIMITED TO 2.0m
- 6. ALL PERMINENT AND TEMPORARY UNLINED SMALES AND DRAMS MUST HAVE APPROPRIATE TEMPORARY EROSION
- 7. ALL PARTIALLY CONSTRUCTED DRAINAGE STRUCTURES MUST BE PROTECTED AGAINST SEDMENT INFLITRATION D.RING CONSTRUCTION
- 8. ALL COMPLETED DRIVINGE STRUCTURES MUST BE PROTECTED AGAINST SEDMENT INFLITRATION UNTIL GRISSING IS 65TABL (9460)
- 10. ALL EROSION AND SEDMENT CONTROL MEASURES MUST BE CHECKED FOR DAMAGE, CLEANED OUT AND FULLY RENSTATED AFTER EACH RANFALL EVENT RESULTING IN RUNOFF.
- 11. IF ERGSION AND SEDMENT CONTROL DEVICES HAVE BEEN FOUND TO BE DEFICIENT OR FALLED IN SERVICE, DUE TO UNFORESEDN CIRCUMSTANCES, CORRECTIVE ACTION IS TO BE UNDERTAKEN INMEDIATELY INHCHINAY INCLUDE ALEXEMBNISHCOTTORS TO THE ORIGINAL APPROLED ERCISION CONTROL PLANS.
- 12. THE INSTALLATION REMOVAL, RELOCATION OR INCORPORTION TO DROGION AND SEDMENT CONTROL DEVICES MAY BE INDER BY DOUGLAS SHREE COUNCIL IF DEDIED NECESSARY AND RELEVANT.
- 1. EROSION AND SEDMENT CONTROL DEVICES SHALL REMAIN IN PLACE UNTLITHE TREATMENT AREA IS SUITABLY STABLE REPORTED TO
- 14. THE CONTRACTOR SHALL UNDERTWIE A FORMAL COMPLIANCE AUDIT OF THE ESC AT SX HEEKS INTERVALS. DURING THE CONSTRUCTION FERCED OF THE PROJECT. RECORDS OF THE AUDIT SHALL BE RETAINED ON SITE. WHERE DENTIFIED AS PART OF THE AUDIT THE ESCP SHALL BE UPDATED AND PROVIDED TO THE SUPERITINDENT.

EARTHWORKS NOTES

- ALL SAFEHIORIS MUST BE OARRED OUT IN ACCOREMANS WITH ACTIVE CALERLINES ON EARTHWORKS FOR COMMENCIAL AND RESISTANTIAL DIRECOMENTS' GOTTONICAL TESTING SERVICES SAMELISE AS ISSTEMBLED BY LIDIRE. IN ACCOREMNES WITH AS STALL CRETPERATION AND TEST RESULTS ARE TO BE COMPLEX AND PROVIDED TO BE SUPERINTEMENT FROM TO WORKS ACCEPTINGES.
- NO VEGETATION SHALL BE REMOVED WTHOUT PROR APPROVAL OF THE SUPERINTENDENT UNLESS NOTED ON THE DOUGHT TREASURES.
- FINSHED SUFFACE LEVELS SHOWN ON PROJECT DRIVINGS ARE AFTER ALL EARTHWORKS ARE COMPLETE INCLUDING TOPSCILING, ALL AREAS ARE TO BE GRIDED EVEN.Y BETWEEN FINSHED SUFFACE LEVELS UNLESS NOTED OD EDANSE
- DRY DENSITY PATIO AS REFERRED TO IN THESE NOTES IS THE RATIO DETERMINED IN ACCORDANCE WITH ASSISTED 41 OF COMPACTED DRY DENSITY IN ACCORDANCE WITH ASSISTED 31 OF ASSISTED TO THE STANDARD WOMAIN DRY DENSITY DETERMINED IN ACCORDANCE WITH ASSISTED 31 OF ASSISTED COMPACTION).
- 5 ALL VEGETAL MATTER TOPSOL AND OTHER LASSUTABLE MATERIAL SHALL BE STREPED REMOVED FROM AREAS TO BE EXCANATED OR FILED. ALL VEDETAL MATTER AND UNSUITABLE MATERIAL SHALL BE DISPOSE OF OFF-SITE UNLESS ADVISED OTHERWISE BY THE SUPERIMITINDENT. TOPSIOL SHALL BE STOCKPLED ON SITE FOR RELISE. SURPLUS TOPSON, SHALL BE DISPOSED OF OFT-SITE.
- SHOLD ANY SOFT OR UNSUITABLE INFITERALISE ODITIFIED. THE CONTRACTOR SHALL INFORM THE SUPERINTENDER'S MIEDINTELY AND SEEK THE ADVICE OF THE SUPERINTENDENT OR GTA. COMPACT FLL TO 56% DRY DENSITY RATIO IN LAYERS OF THOMESS APPROPRIATE TO THE COMPACTION PLANT
- EMPLOYED BUT NOT EXCEEDING 300mm. 8. INFORTED FILL MUST HAVE A MINIMUM SITE CLASIFICATION OF M AS PER TABLE 21 OF ASSIDUTIANTIS
- INCOERATELY REACTIVE CLAY OR SLT, OR BETTER)

ROADS & PATHWAYS NOTES

- NEW ROKES PATHS AND KEREING SHALL JON SMOOTHLY TO EXISTING WORKS, WHERE NECESSARY, EXISTING WORKS SHALL BE CUT BACK TO FORMA NEAT JON.
- ALL PATHAWAYS SHALL BE 2 In HIDE (JALESS NOTED OTHERINSE) IN ACCORDANCE WITH PAGROC STD GRAVING SHIEL PATHAWAY OR OSSEALL MUST NOT EXCEED 2 PM.
- 1 ALL KERE PROFILES TO BE AS PER PROPIOS STO DRAWING SYDE UNLESS NOTED OTHERWISE.
- 4. ALL KERE RAMPS SHALL BE CONSTRUCTED IN ACCORDANCE WITH PROPIOD STD DRG SIDIE, WIDTH OF RAMP SHALL MIDTH OF RAMP SHALL
- 5 ALL STREET SIGNS AND TRAFFIC SIGNS SHALL BE INSTALLED IN ACCORDANCE WITH PROPOD STD ORAHINGS SHOE
- RWEMENT DESIGN STATED HEREIN IS FOR A RAVEE OF SUBGRADE CER VALUES. THE CONTRACTOR IS TO CONFIRM THE SUBGRADE CER BY TESTING IN ACCORDANCE WITH THE SPECIFICATION RESULTS ARE TO BE FROMDE TO THE SUPERINTENDENT FOR FINAL PAVEMENT SELECTION

DRAINAGE NOTES

- EXCAUATION, BEDONG AND EACHFUL FOR PRECAST BCX CLEVERTS SHALL BE CARRED OUT IN ACCORDANCE WITH FINCENCE STD ORIVING STMS.
- REINFORCED CONCRETE BASES FOR CLEMENTS SHALL BE CONSTRUCTED IN ACCORDANCE WITH DEPARTMENT OF MAIN ROADS STD DRAWING (19).
- SUBSIL DRANACE SHULL BE FROMDED WHERE SHOWN ON THE PROJECT DRAINING, DRANG SHUL ACHEVE A WINIMUM OS, GRADE, RUSHING POINTS AND OUTLETS TO BE FROMDED IN ACCORDINGE WITH PROPECTS TO DRAWING \$1005.

WATER RETICULATION NOTES

- ALL PVC AND PE PRES SHILL SE CLASS PMIL PVC PRES SHILL SE RUSSER RING JOINTED AND DUCTLE IRON COMPATIBLE.
- 2. DICL PIPES SHALL BE CLASS PILIS "TYTOM" TYPE RUBBER RING JOINTED.
- FOR MAIN TRENCHING, BEDOING & AND KORKEE DETALS REFER PACINGS STO DRES SOLIS & SOLIS. DISURE COVER TO WATER MARK IS BOTHIN MINIMUM UNDER ROADINY'S AND KOOTHIN MINIMUM ELSEWHERE.
- ALL WATER MANS SHALL BE INSTALLED ON A STANDARD 2 Im OFFSET FROM THE PROPERTY BOUNDARY UNLESS NOTED OTHERWISE ON PLANS.
- DOUGLISS SHEE COUNCIL MUST BE CONTACTED TO PERFORM ANY DIRECT CONNECTION OR ALTERATION TO LIVE WATER MARKS. THE CONTRACTOR SHALL LODGE WITH COUNCIL THE APPROPRIATE APPLICATION FORMS AND FEES FOR THESE WORKS TO BE COMPLETED. IT MAY BE POSSIBLE FOR SOME WORKS TO BE PERFORMED BY THE CONTRACTOR LINERE SPECIAL ORCUMSTINGES MID SUBJECT TO APPROPRIATE CONDITIONS AGREED TO WITH COUNCIL
- ALL HORAVES AND VALVES TO BE LOCATED OFFOSTE PROFERTY BOLINDARY
 TRUNCATIONS AND CORNER UNLESS NOTED OFFENSIES ON PLANS. FOR VALVES & HIGHWIT BOXES INSTALLATION DETAILS REFER PROPOR STD DEVANOUS S2000.
- A HOR ANTS OR VALVES CONSTRUCTED IN CONCRETE ARE TO HAVE A CONFRESSIBLE LAYER (ABLEFLEX) INSTALLED ON THE SURROUND, REFER PHOROC STD ORG 2000
- 9 KERE MARKER RUATES SHALL SE PROVIDED TO CENTRY THE POSITION OF ALL VALUES AND HYDRANTS IN ACCORDANCE WITH PACED CISTO DRIVING SOLO VERSION 4-305. IN ACCITICATIO VERSI MARKER PLATES INDRWITS SHALL ALSO HAVE TEARCROP IMPRICES AND BLIE RETRO REFLECTIVE MARKERS PROVIDED ON THE ROAD PRIVENENT IN ACCORDANCE WITH PROPIOS STD DRAWING 2010 VERSION 4-2008.

SEWER RETICULATION NOTES


- ALL NEW SEVER MANS SHALL BE UNPLASTICISED PVC (PVC-U) CLASS SNE SUITABLE FOR RUBBER RING JONTS,
- ALL NEW SEVER MANS AND MANHOLES TO BE CONSTRUCTED IN ACCORDANCE WITH PROPOSISTIC DRAWINGOUS AND SOLYS.
- ALL SENER MANAGUE COVERS SHILL BE CROLLAR UNLESS NOTED OTHERMISE ON SENER LONG SECTIONS. COVERS SHALL BE TYPE BINSIDE PROPERTIES AND TYPE C SUSDIMERE.
- 4. ALL SENER MANAGLE COVER LEVELS TO BE SIME ABOVE FINISHED SURFACE LEVEL UNLESS NOTED OTHERWISE. 5. THE CONTRACTOR SHALL ENSURE THAT A REAL OF 15th RADIUS FROM THE CENTRE OF THE MANAGLE IS ROVEED AROUND ALL MANHOLES.
- ALL HOUSE CONNECTION BRANCHES TO NEW SEINER MAINS TO BE CONSTRUCTED IN ACCORDINCE WITH FINEROC STO DRAWING S2005, BRANCHES SHALL BE CLEARLY WARKED IN ACCORDINCE WITH THE SPECIFICATION.
- DOUGLAS SHIEF COUNCIL MUST BE CONTRUCTED TO PERFORM MY DIRECT CONNECTION TO UNE SEMAR MANK. THE CONTRACTOR SHALL LODGE IN THE COUNCIL THE APPROPRIATE APPLICATION FORMA MOTIRES FOR THESE WORKS TO BE CONFLICTED. IT MAY BE POSSIBLE TO RESIDENT DURING ADDRESS TO THE CONTRACTOR MUSICIPACIONAL OPCIMIETANCES AND SUBJECT TO APPROPRIATE CONSTITUCE ADDRESS TO THE COUNCIL
- 8. THE CONTRACTOR SHILL CARRY OUT A CCTV INSPECTION THROUGH ALL SEMERS CONSTRUCTED AS PART OF THIS DEVELOPMENT AND PROVIDE THE FOOTAGE TO THE SUPERINTENDENT FOR ASSESSMENT. ANY SECTIONS OF SENIER CONSIDERED SUB-STANDARD SHALL BE RECTIFIED TO THE SATISFACTION OF COUNCIL.


SITE SPECIFIC NOTES

NO DUBARING OR VEGETATION REMOVAL IS TO TAKE PLACE UNTIL CERTIFICATION IS PROVIDED FOR ANT PLANT RELOCATION (INT PLANT RELOCATION BY OTHERS)


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vision Note * Indicates signatures on original incur of dearing or last revision of dearing	Dream	Jak Vanager	Project	Date	T 61 7 4064 2222 F 61 7 4064 2288 E convertigipte converse W wave glob converse	and must not be used by any other person or for any other purpose.	Scale .	This Drawing must not like used for Constitution unless signed as Approval	A1	Drawing No: 42-12520641-C002

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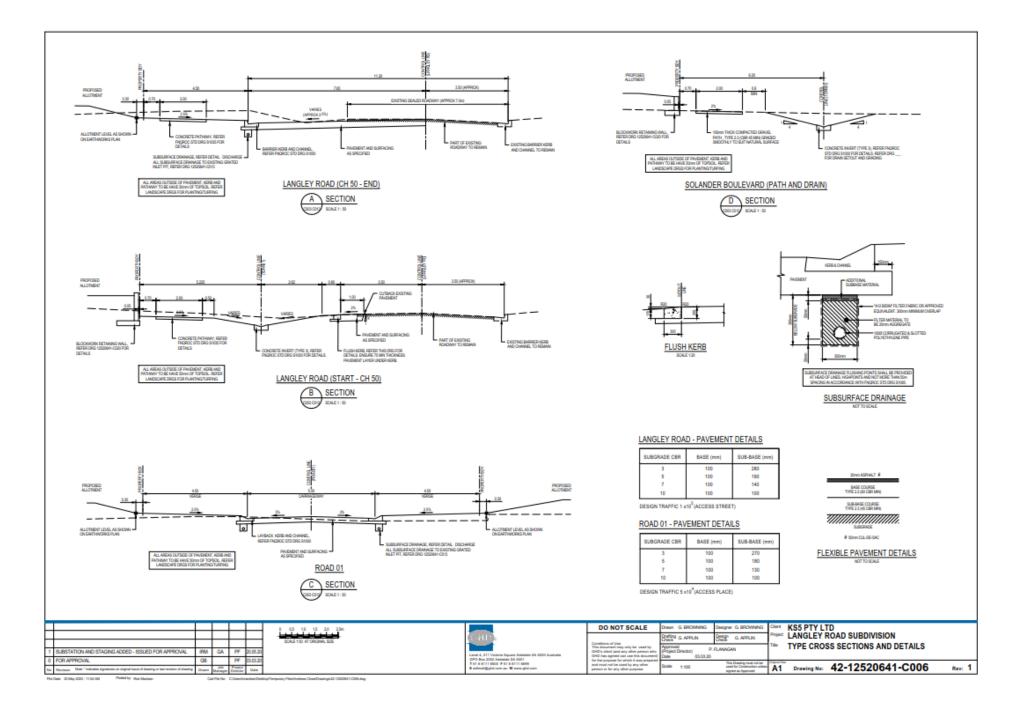


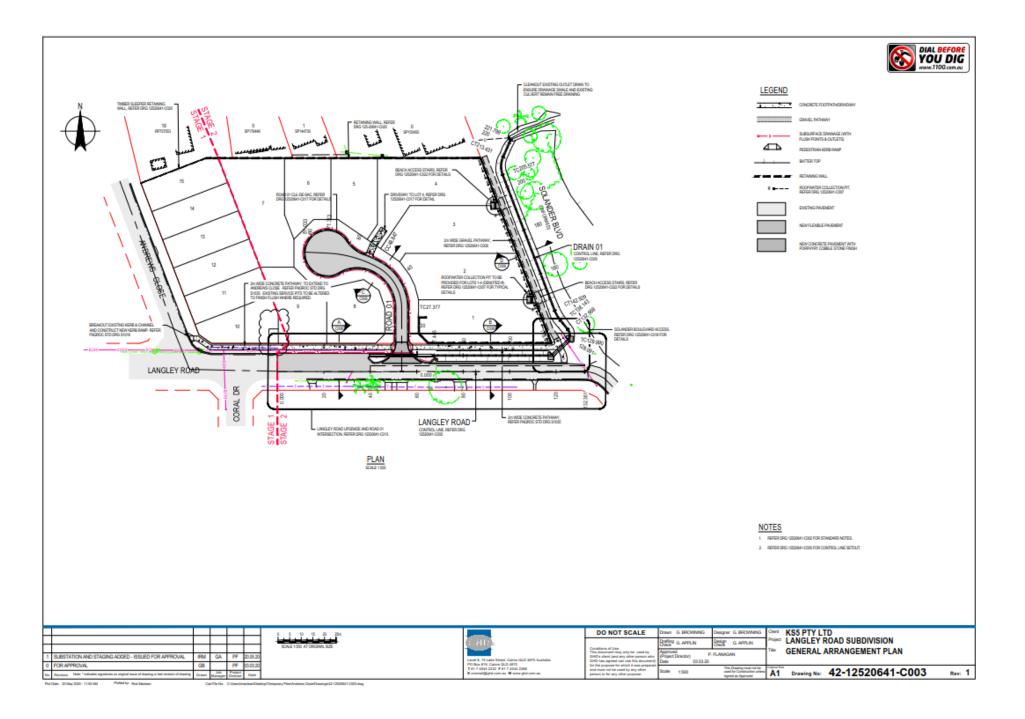


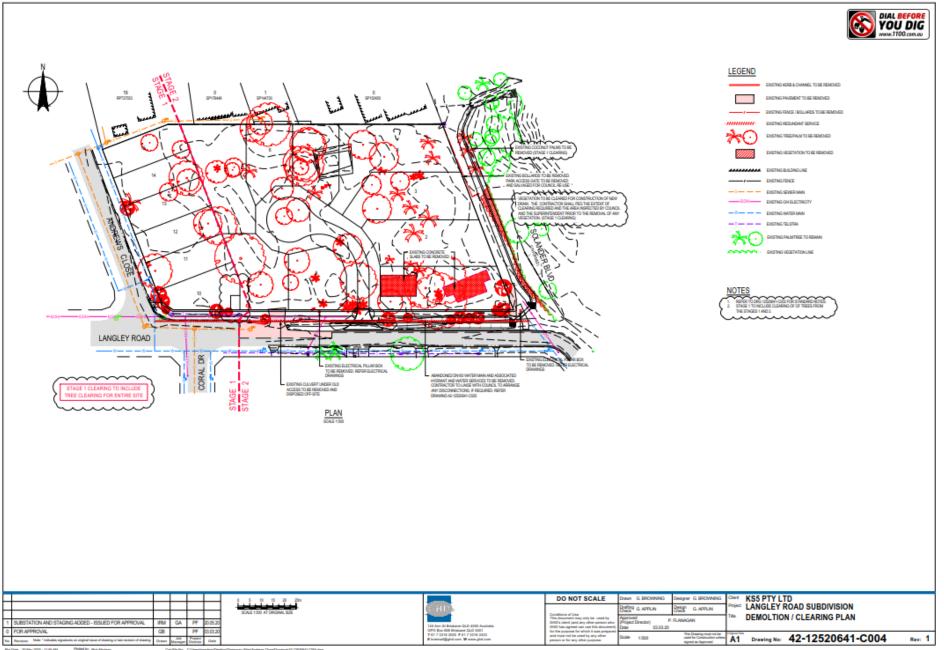
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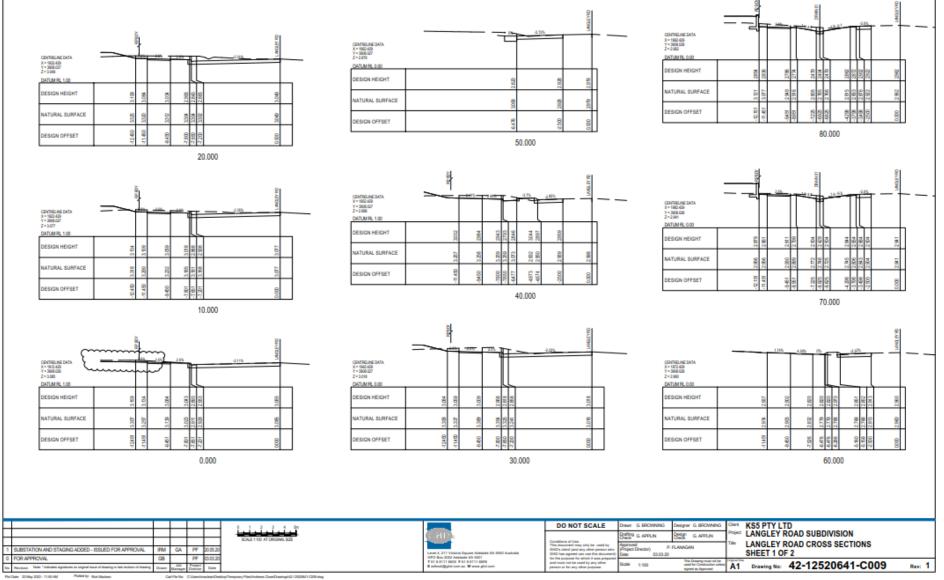
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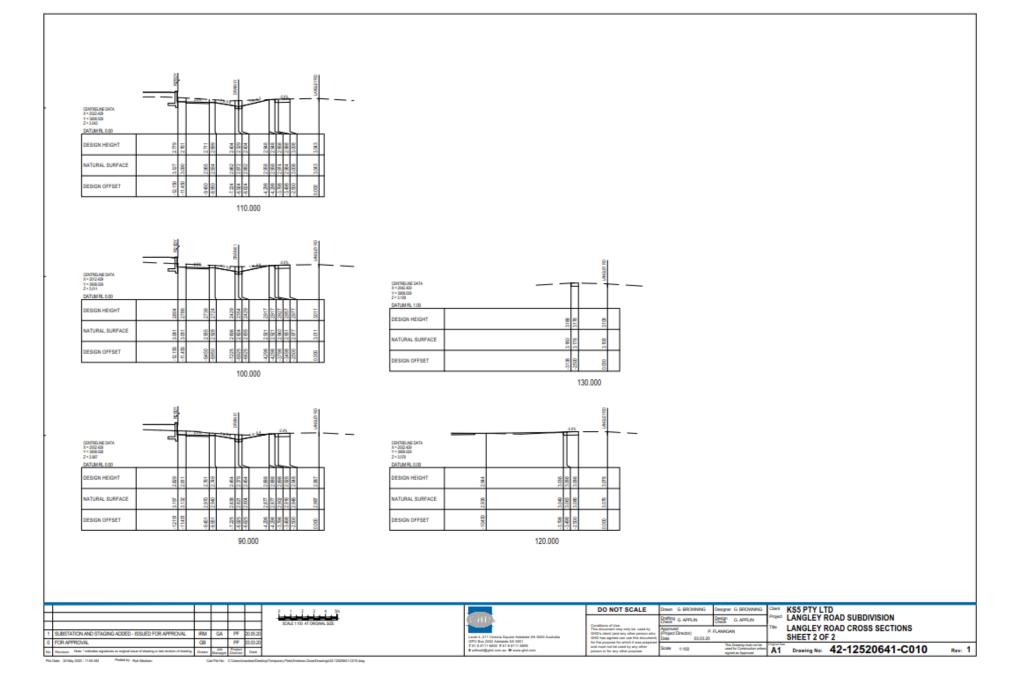





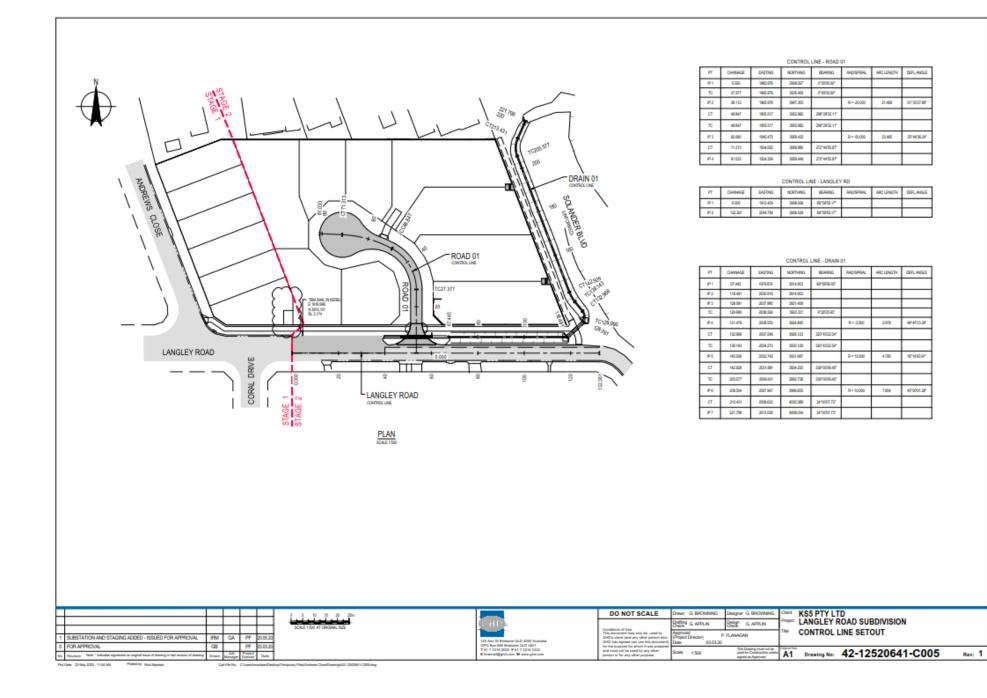

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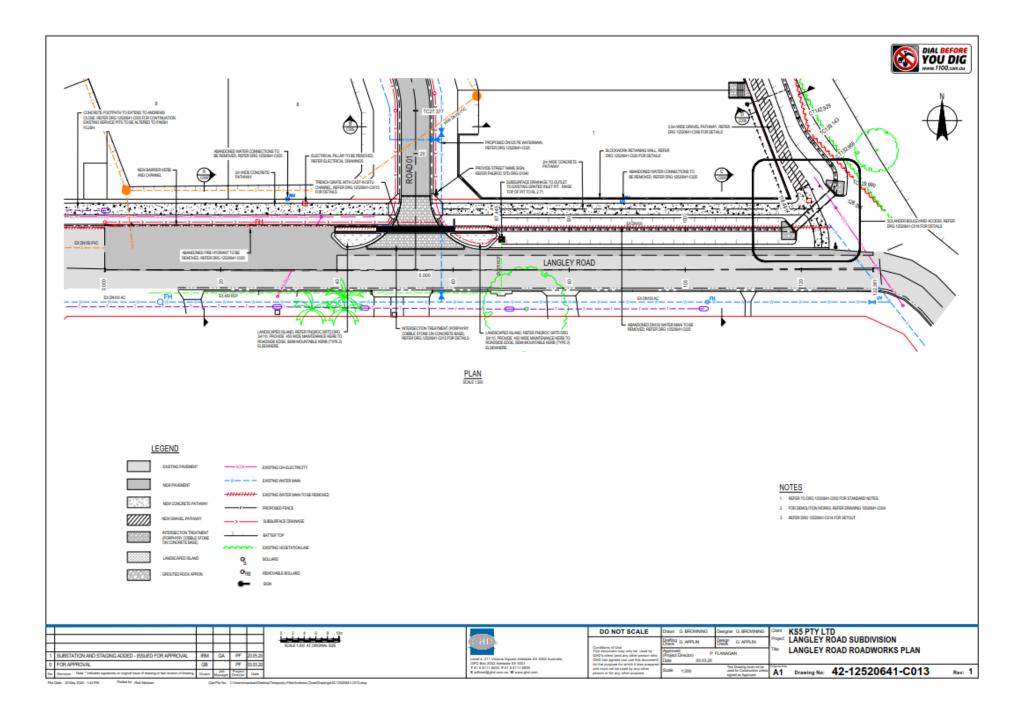
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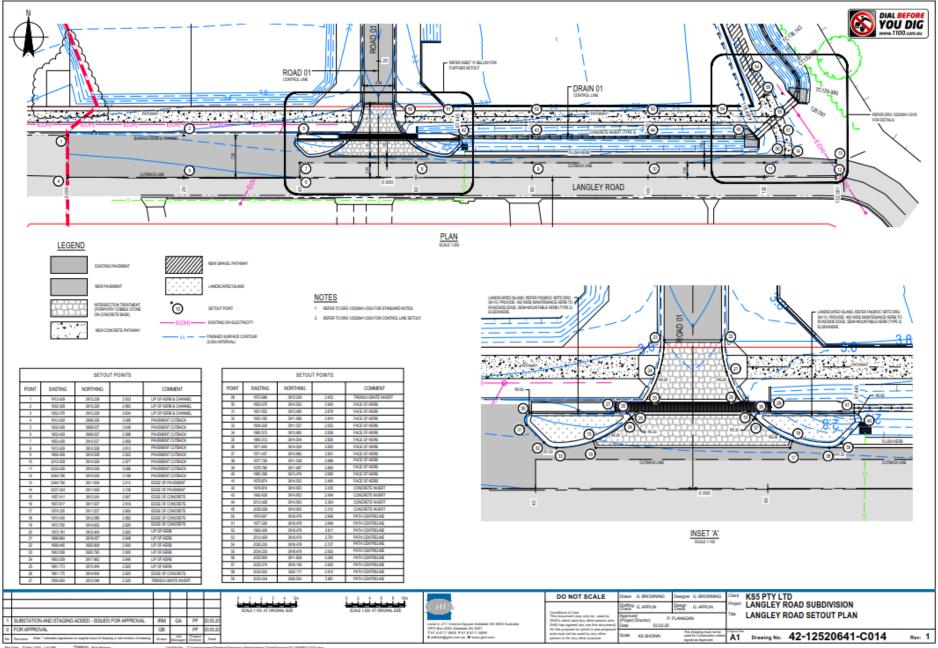
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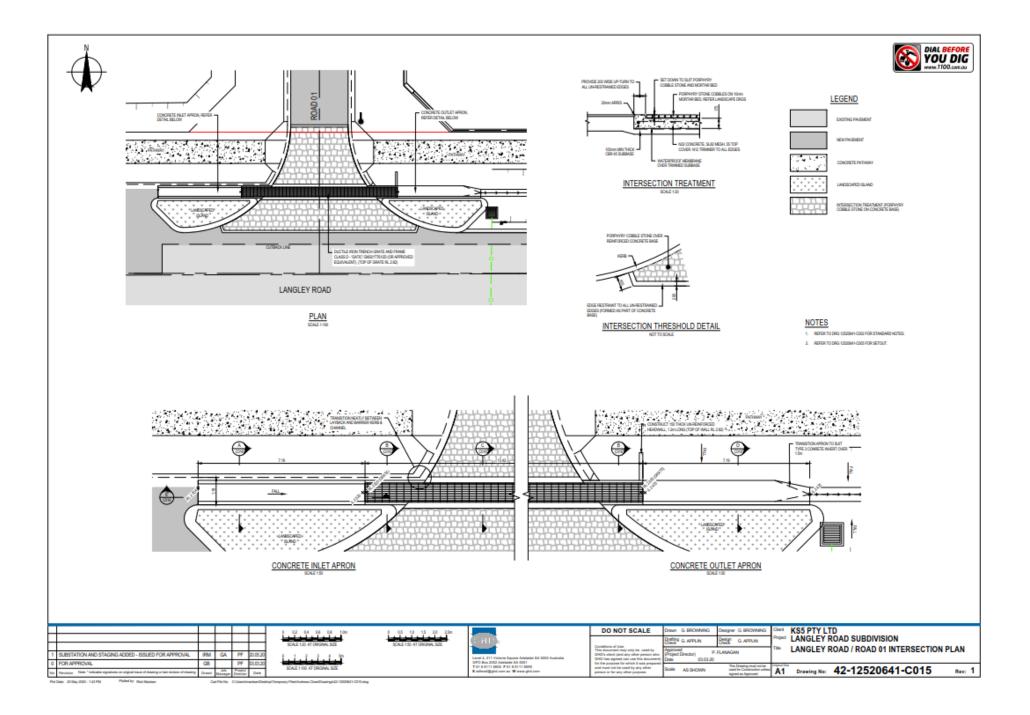
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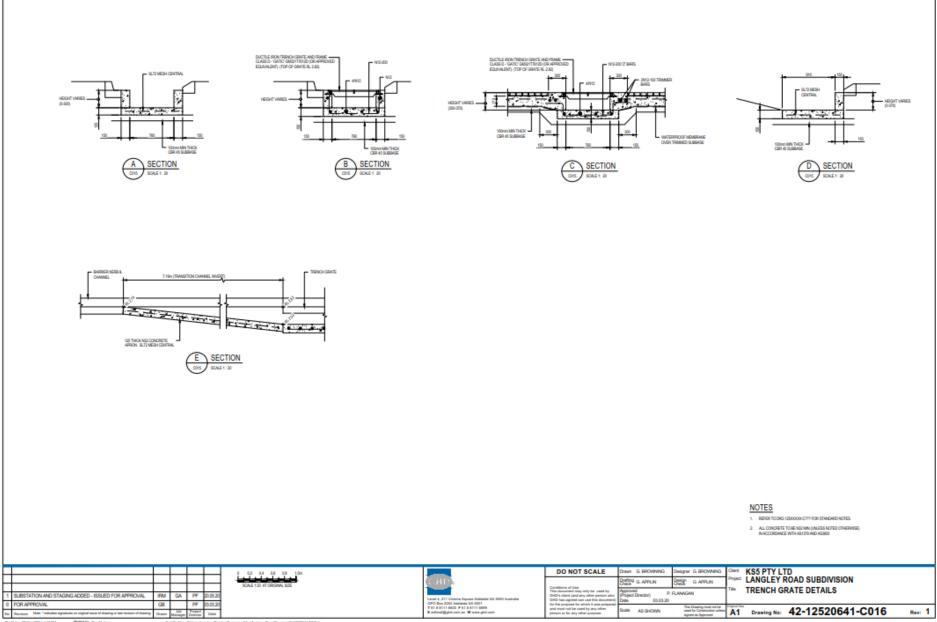


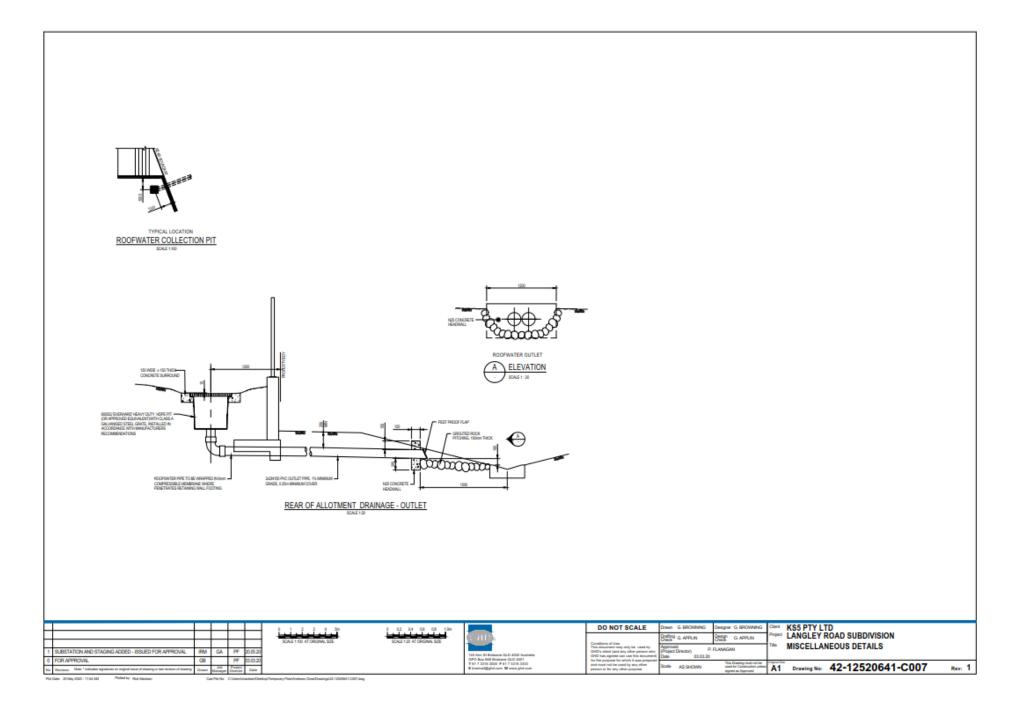

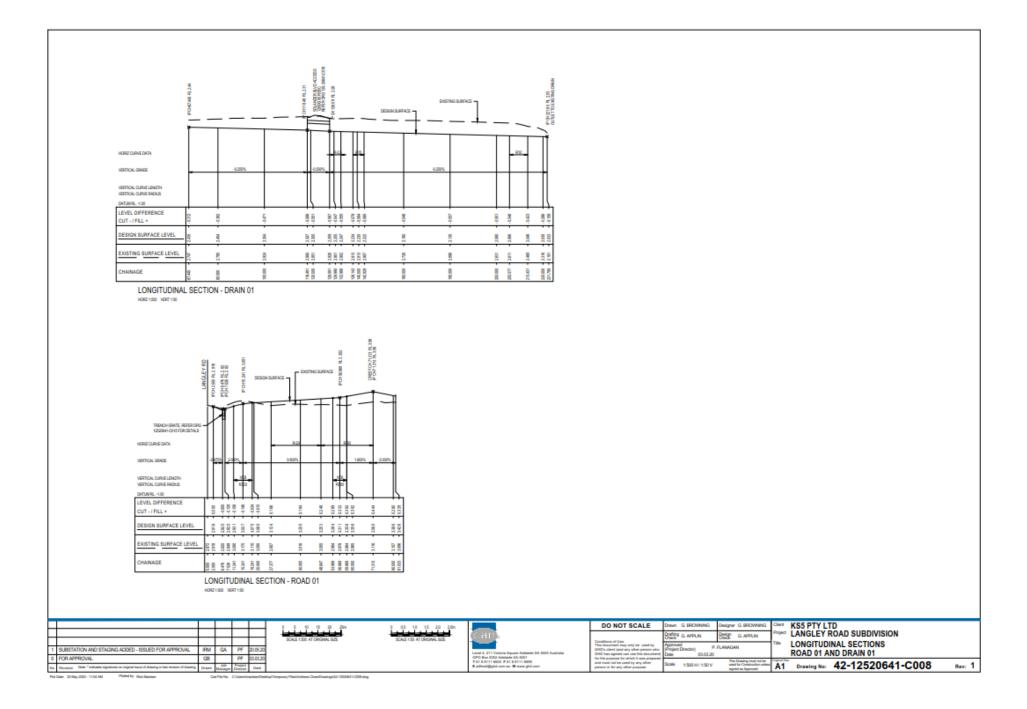
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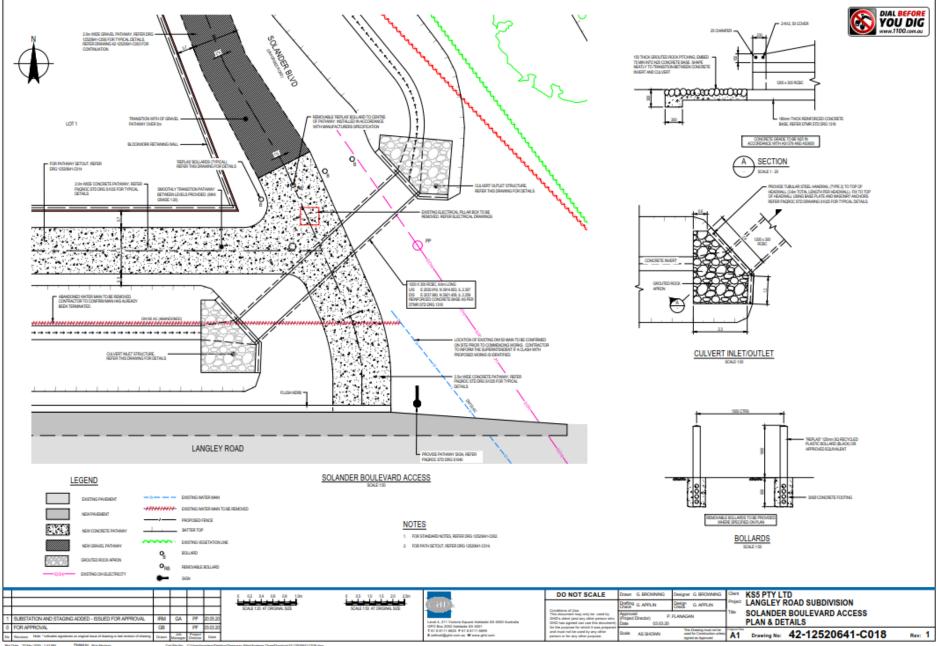

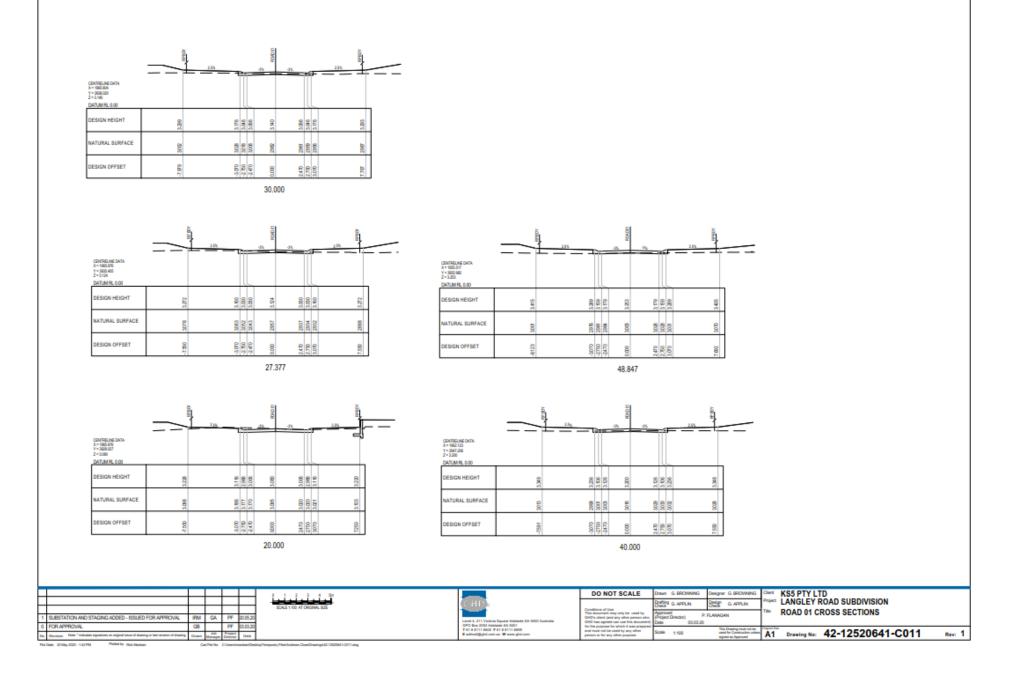
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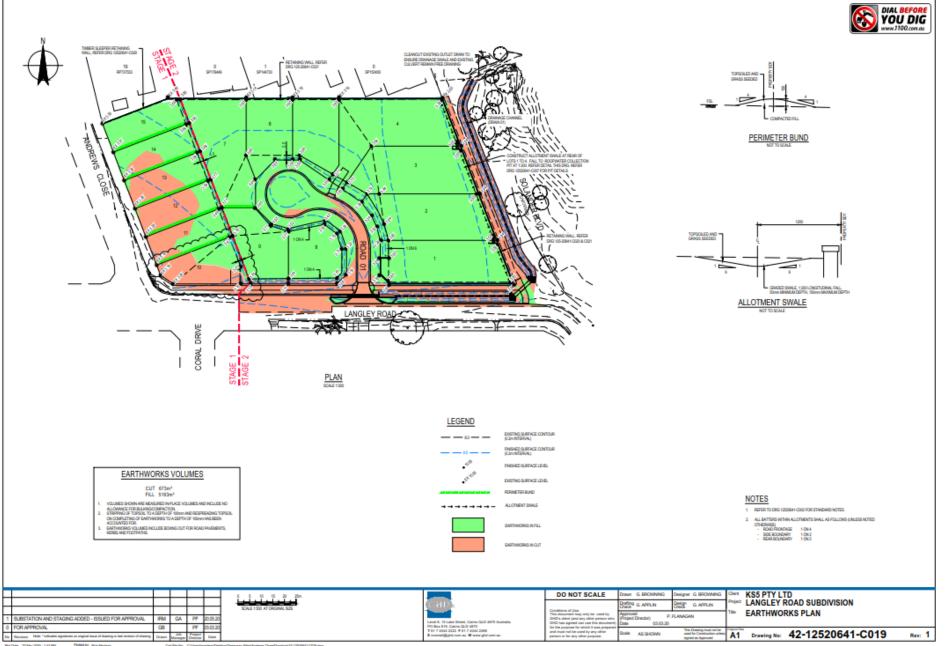



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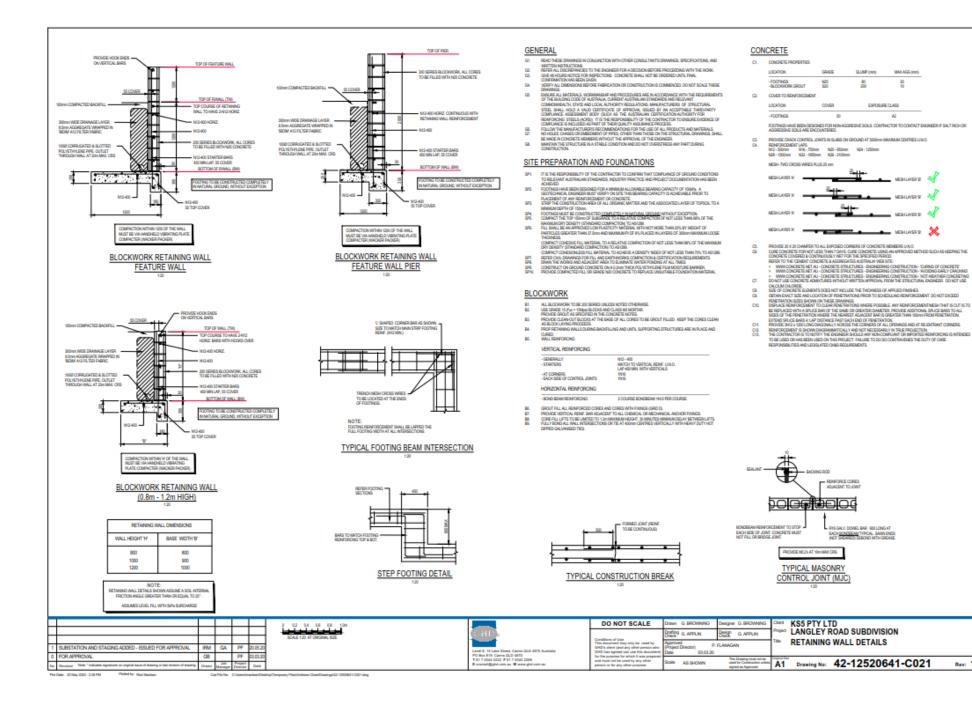


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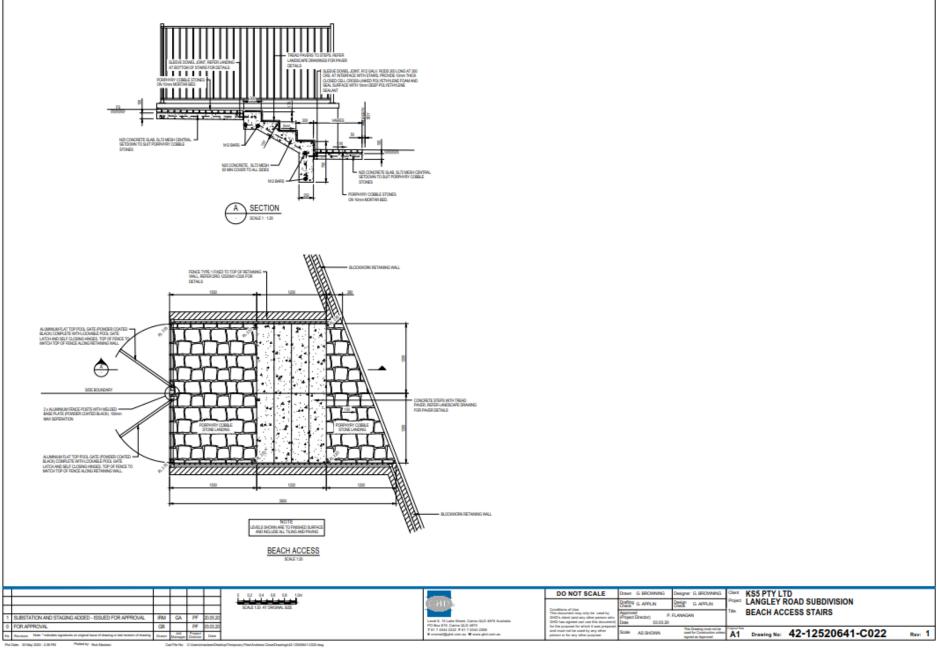


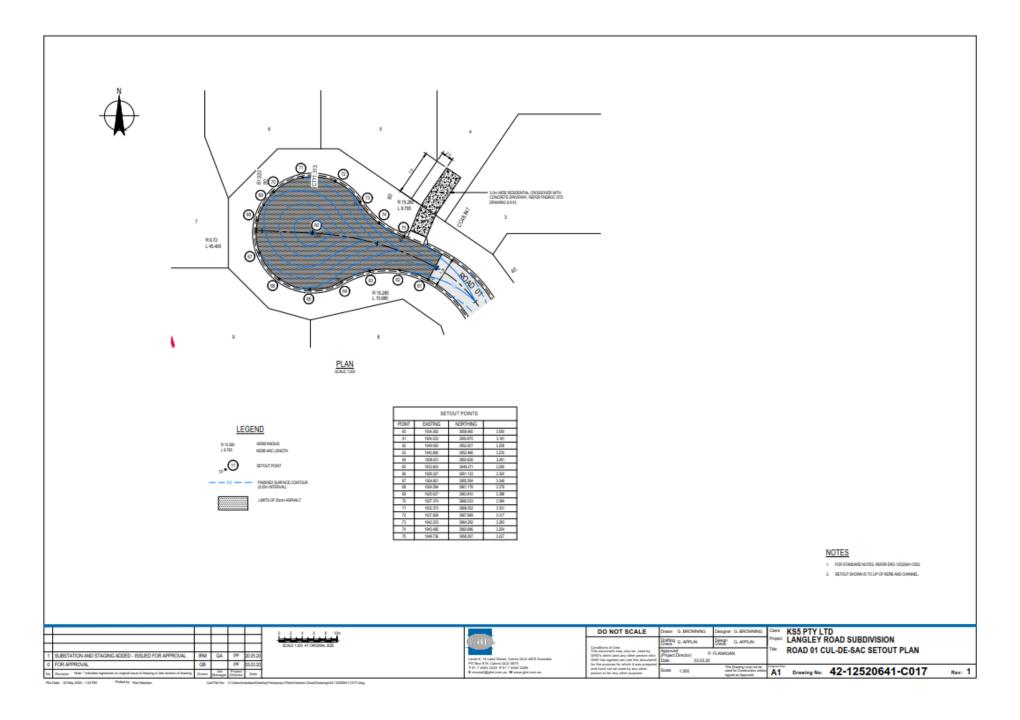



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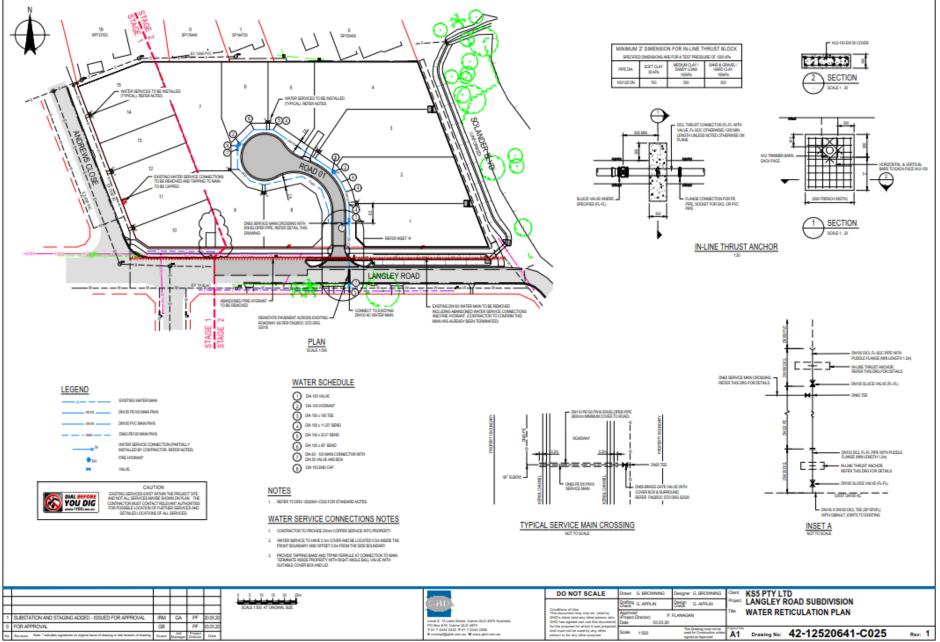
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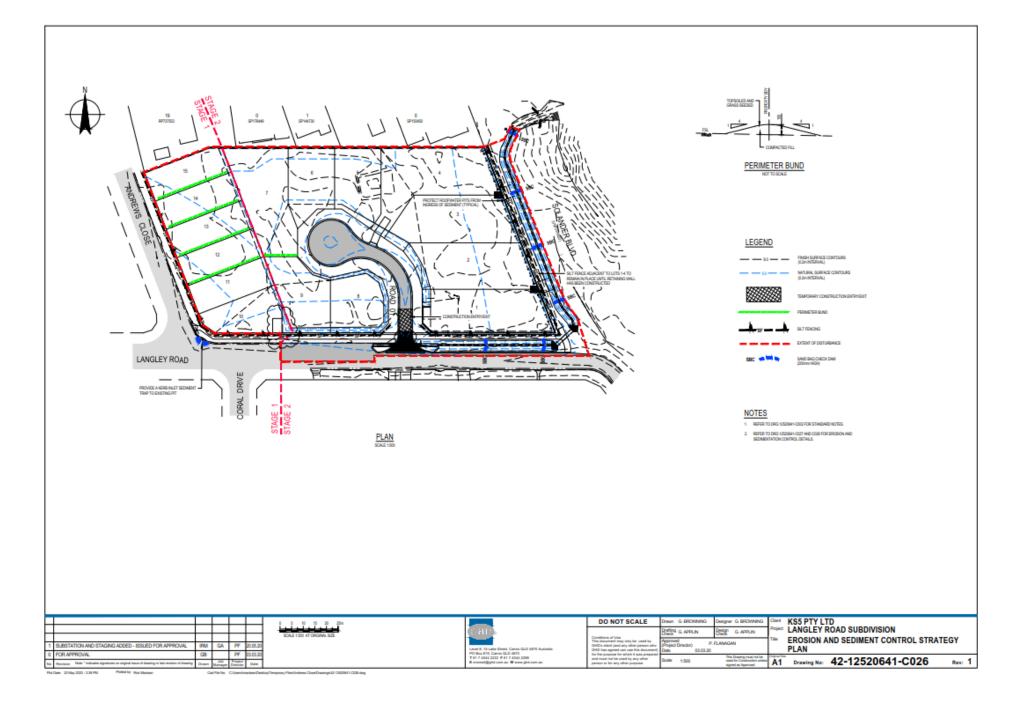




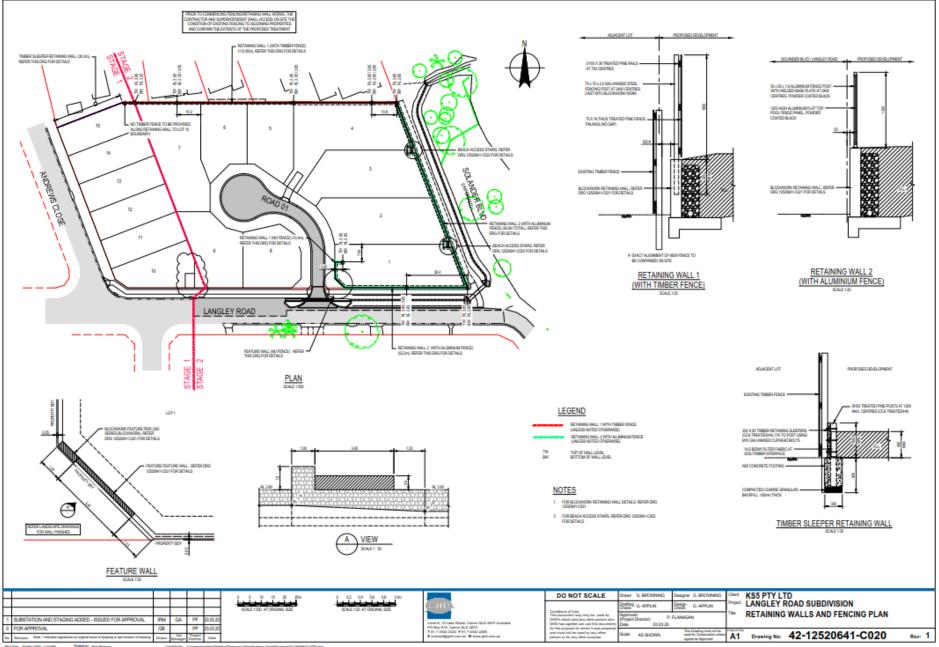

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SEDIMENT FENCE

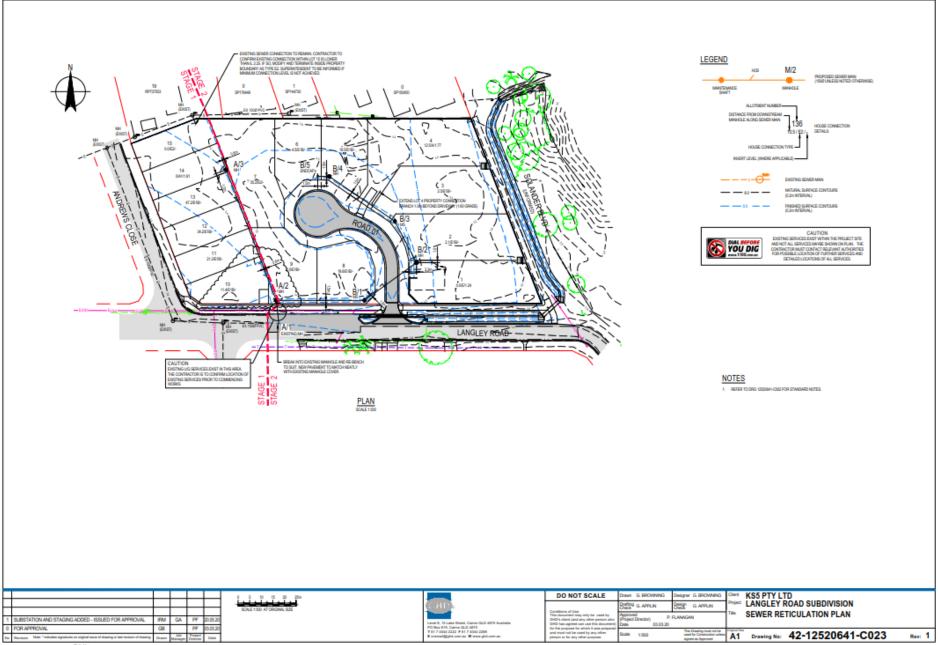MATERIAL
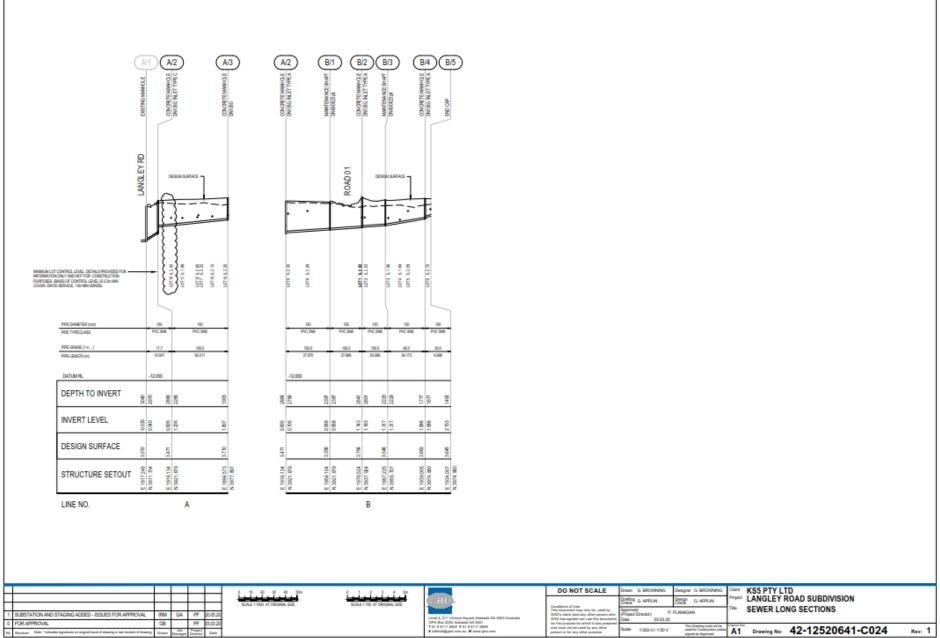
<u>Exerco</u> Polyfropyline, polymide, mylon, polyester, or polyethyline woven or non-moven fabric, at least TOmm IN WOTH AND A MINIMUM UNIT WEIGHT OF HOSSIX. ALL FABRICS TO CONTAIN LLTRAVIOLET INHIBITORS AND TABLI SERS TO PROVIDE A MINIMUM OF ENDINTIES OF LISEABLE CONSTRUCTION LIFE ALLTRAVIOLET STABILITY. ENCEPTING 704

EAGENC REINFORCEMENT: WHE OR STEEL MESH MINIMUM 14-GALIGE WITH A MAXIMUM MESH SPACING OF 200mm.


<u>SLEPORT POSTSISTANES</u> ISSEMI[®] (MN, HARDVOOD, 2500mm[®] (MN, SOFTWOOD, OR 1.5kg/m (MN, STEEL STAR PICKETS SLITABLE FOR ATTACHING FADRIC

INSTALLATION


- REFER TO APPROVED PLANS FOR LOCATION, EXITENT AND REQUIRED TYPE OF FABRIC (IF SPECIFIED), IF THERE ARE QUESTIONS OR PROBLEMS WITH THE LOCATION, EXITENT, FABRIC TYPE, OR METHOD OF INSTALLATION
- CONTACT THE ENGINEER OR RESPONSIBLE ON-SITE OFFICER FOR ASSISTANCE. 2. TO THE INVALUE DESIGNER FRACTION, AND INFERSITIER FRAME ALLON, DRUKE THE FRACE IS LOCATED 1. TOTALLY WITHIN THE PROPERTY BOUNDARIES 2. ALLONG A LINE OF CONTANT ELEVATION INFERIOR FRACTION; AT LEAST 211 FROM THE TOP OF ANY FILLING OPERATIONS THAT MAY RESULT IN SHIFTING SOL FILL
- a. A Labor 2014-02 Final Lab S with "Labor-Selection for the term term and in the term of the source Labor 2014 (Selection 2014) and the source 2014 (Selection 2014) and the source 2014 (Selection 2014) and the source 2014 (Selection 201
- EXTENENG AT LEAST 1.5m UP THE SLOPE.
- 6 FTHE SEDMENT FENCE IS TO BE INSTALLED ALONG THE EDGE OF DISTING TREES, DISURE CARE IS TAKEN TO PROTECT THE TREES AND THEIR ROOT SYSTEMS DURING INSTALLATION OF THE FENCE, DO NOT ATTACH THE
- FABRIC TO THE THEES. 1. UNLISS OPECADD IN THE SITE SUPERVISOR OR THE APPROVED PLANS, EXCANATE A 200mm INDE BY 200mm DEEP TREACH ALONG THE PROPOSED FENCELING, PLACING THE EXCANATES INITERIA, ON THE UP-SLOPE SEE:
- OF THE TRENCH. A LONG THE LOWER SIDE OF THE TRENCH APPROPRIATELY SECURE THE STAKES MTO THE GROUND SPACED NO. REATER THAN 3m IF SUPPORTED BY A TOP SUPPORT HIRE OR WEIR MESH BADKING, OTHER MISE NO GREATER HAN 2m.
- 104028. 8 F SPECTRO SECUREY ATTACH THE SERVICE WEIGHT WEIGHT DE LE PLACE DE SECURE OF THE STREET WORKS. 8 F SPECTRO SECUREY ATTACH THE SERVICE WEIGHT DE LE PLACE DE SECURE DE THE STREET THE SECURE DE LE PLACE DE LECT DE STREET AND DE LE PLACE DE SECURE ATTACH DE LE PLACE DE SECURE ATTACH DE LE PLACE DE SECURE SECURE DE LE PLACE DE LECT DE LE STREET AND DE LE PLACE DE SECURE ATTACH DE LE PLACE DE SECURE DE SECURE ATTACH DE LE PLACE DE SECURE DE SECURE ATTACH DE SECURE ATTACH DE LE PLACE DE SECURE ATTACH DE LE PLACE DE SECURE ATTACH DE LE PLACE DE SECURE DE LE PLACE DE SECURE ATTACH DE SECURE DE SECURE ATTACH DE SECURE DE SECURE DE SECURE DE SECURE DE SECURE ATTACH DE SECURE DE SECURE ATTACH DE SECURE D
- ATTACHEACH END TO TWO OVERLAPPING STAKES WITH THE FABRIC FOLDING AROUND THE ASSOCIATED


STALE ONE TUPE, MAN WITH THE TING STAKES THE TOLETHER WITH WIRE OR 0. OREAL PER FARINE TO HE MAIN ALL MARKET ALL REPORT FORTS SECURELY ATTACH THE RARKET TO THE SUPPORT POSTS USING 25 X 125mm STAPLES, OR TIE WIRE AT INKOMAN STORM SPACES.

- Tom SPANE. 5 SCORE V ATTACHTE FARE TO THE SUPPORT WEENER/F ANY AT AUXABLM SPACING OF Im. 10 SCORE V ATTACHTE FARE TO THE SUPPORT WEENER/F ANY AT AUXABLM SPACING OF Im. 10 SCORE THE COMPARISON OF THE SPACE AT A STATE AND A STATE AT A STATE AT A STATE AT A STATE AT A STATE MERICIPACITY AND A STATE AT A STATE 10 SCORE THE STATE AT A STATE 10 SCORE THE STATE AT A STATE 10 SCORE THE STATE AT A STATE 10 SCORE THE STATE AT A STATE 10 SCORE THE STATE AT A STATE 10 SCORE THE STATE AT A STATE 10 SCORE THE STATE AT A STATE
- ADDITIONAL REQUIREMENTS FOR THE INSTALLATION OF SPILL-THROUGH WEIR
- LOOKE THE SPLI-THROUGH HER SLOV THAT THE HER OREST VILL BE LOWER THAN THE GROUND LEVEL AT BOOLDD OF THE FENCE.
- EACHED OF THE FINCE. 1. EXALUSE THE GEST OF THE SPILL-THEOLOGI HIGH IS AT LEAST X00mm THE GROUND BLEWATION 1. SECURELY THE AHORIZONTAL CROSS MEMBER (HIGH TO THE SUPPORT POSTSISTANCE EACH SIZE OF THE WERK CUT THE FAMILY SOCIES THE ANDRE. APPROFRAMELY SOCIES THE FAMILY.
- APPROPRATELY SECLES THE RARPIC. 19. INSTALL A SUTRELE SPLAN PRO AND/OR CHUTE MMEDIATELY DOWN SLOPE OF THE SPLIL-THROUGH WER TO CONTROL SOL EPOSION HAD APPROPRATELY DISCHARGE THE CONCONTRATED FLOM PROBING OVER THE WER NOTING OVER THE WEIR
- MAINTENANCE 19. INFRUT THE SEDMENT FRICE AT LEAST WEEKLY AND AFTER ANY SIGNFOANT RAN. INVERSESSARY REPARES INVESTIGATES. 20. REPARE INVESTIGAL SECTIONS WITH A CONTINUOUS PRECE OF FARRIC FROM ROST TO POST.
- 22. REVENUE TO BE BEFORE, ALL STATES THAT CONTROL AND ALL OF HARD HEAR HEAR TO THE THE ALL STATES AN AREADED
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- 34. DEPOSE OF SECIMENT IN A SUITABLE MANNER THAT WILL NOT CAUSE AN EROSON OF POLITION HAZARD. 25. REPLACE THE FARRC IS THE SERVICE LIFE OF THE DISTING FARRC DICEEDS I MONTHS.
- REMOVAL
- REMOVAL 38. Web DOSTURED ARCHALLARE OF THE SEDMENT FINCE ARE SUFFICIENTLY STABLISED TO RESTRAN EROSON, THE FINCE MUST BE REMOVED. 37. REMOVE INTERNET AND COLLECTED SEDMENT AND ORFOSE OF IN A SUTFILE INVINE. THAT WILL NOT OUGH AND RESOLVE OF RELITION WARD.
- AN ERDSION OR POLLUTION HAZARD. 28. REHABILITATE REVEGETATE THE DISTURBED GROUND AS NECESSARY TO MINIMSE THE ERDSION HAZARD.

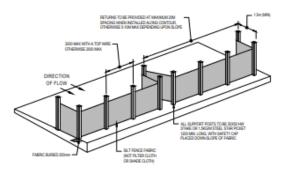



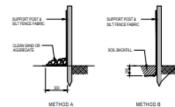


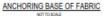




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	uo		Project	101020	T 41 8 ANT 4600 F 41 8 811 4600 E allmailight com as W www.phi.com	and must not be used by any other	Scale AS SHOWN	This Drawing must not be used for Construction unless	A1	Drawing No: 42-12520641-C027
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KERB INLET SEDIMENT TRAP

MATERIAL

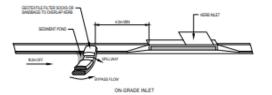SOCIE MANNA ZORINI DAMETER SYNTHETIC OR BIODEGRADALE TUBES MANUFACTURED FROM NOHWOVEN OR COMPOSITE FARRIC SUITALLE FOR THE FRUTRATION OF COMPSE SEDMENT.

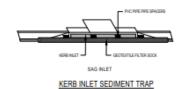THE MATERIA: STRANDARE BLICH, COMPOSITE MATERIAL (ASHISH, COLRESS SAND OR CLEAN AGGREGATE.

INSTALLATION

- BETRETD APPROVED RANS FOR THE LOCATION AND INSTALLATION DETAILS. IF THERE ARE QUESTIONS OR PROBLEMS WITH THE LOCATION, DMEMSIONS OR METHOD OF INSTALLATION CONTACT THE DISINEER OR

- PROGRAM WITH THE LOCIDINg UNBRACING GARANTERIOG FARITALITION CONTROL THE DECOMPOSITION
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- A REMOVE COLLECTED SEDMENT AND DISPOSE OF IN A SUITHELE WAINER THAT WILL NOT CAUSE AN EROSION OR
 POLITICAL HERORD.
- AVAILABLE . 2. IF NECESSARY FOR SAFETY REASONS, THE SEALED SURFACE SHALL ONLY BE WASHED CLEAN AFTER ALL

- a biological control for rescales (in tradition) in the biological control of a monte cutor source of the biological control for the biological control f

ROCK FILTER DAM

MATERIALS

RODE 75 TO 100mm NOMINAL DIAMETER, HARD, EROSION RESISTANT ROOK.

SECTORILE FAIRC: HEAVY-OUTY NEEDLE-PUNCHES, NON-HOVEN FLITER CLOTH (SDM AXI OR EQUIVALENT).

INSTALLATION

- INSTRUCTIONS INSTRUCTIONS REGISTER INTO REAVER TO LOCATION HID NETLLATING TATLES. THERE ARE GENERATION INSTRUCTIONES INTO THE ALL DOWNS THE INSTRUMENT AND THE AND THE AND THE INSTRUCTIONES INTO THE ALL DOWNS THE INSTRUMENT AND THE AND THE AND THE INSTRUMENT AND THE INSTRUMENT AND THE AND THE AND THE AND THE AND THE INSTRUMENT AND THE INSTRUMENT AND THE AND THE AND THE AND THE AND THE INSTRUMENT AND THE INSTRUMENT AND THE AND THE AND THE AND THE AND THE INSTRUMENT AND THE INSTRUMENT AND THE AND THE AND THE AND THE INSTRUMENT AND THE INSTRUMENT AND THE AND THE AND THE AND THE AND THE INSTRUMENT AND THE INSTRUMENT AND THE AND THE AND THE AND THE AND THE INSTRUMENT AND THE INSTRUMENT AND THE AND THE AND THE AND THE AND THE INSTRUMENT AND THE INSTRUMENT AND THE AND THE AND THE AND THE AND THE INSTRUMENT AND THE INSTRUMENT AND THE AND THE AND THE AND THE AND THE INSTRUMENT AND THE INSTRUMENT AND THE AND THE AND THE AND THE AND THE AND THE INSTRUMENT AND THE INSTRUMENT AND THE AND T DOWNSTREAM SPLASH PAD
- MAINTENANCE
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- MORPET DAVIE TO THE REPORT AND THE REPORT AT UNDER AT UNDER THE ADVIT THE ADVISOR OF THE REPORT AND ADVISOR ADVIS

- REMAN WITHIN THE CHANNEL. 6. DISPOSE OF COLLECTED SEDMENT IN A SUITABLE MANNER THAT WILL NOT CAUSE AN EROSION OR POLLUTION. HADARD

- REMOVAL 5. INFO. INSTRUCTOR VIORI INTER THE DRIVING AREA ADARTINE THE FLITE DRIVING BEEN CORPLETED AND THE DISTURDANCE AREA NOT THE DRIVING DAMAGE ARE AREA DISTORDER TO TREASTON RECOON, ALL TRANSPORT DRIVING WAS INTER FRANCED. ALL TRANSPORT DRIVING AND INTER FRANCED.
- RDMONE THE FRUTTER DWILLARD ASSOCIATED SEDMENT AND DISPOSE OF IN A SUITABLE NAMER THAT WILL NOT CHUSE AN EROSION OR POLLUTION HAZARD.

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LANDSCAPE DESIGN LANGLEY RD SUBDIVISION - STAGE 1 LANGLEY ROAD, PORT DOUGLAS, QLD JUNE 2020 - TENDER ISSUE

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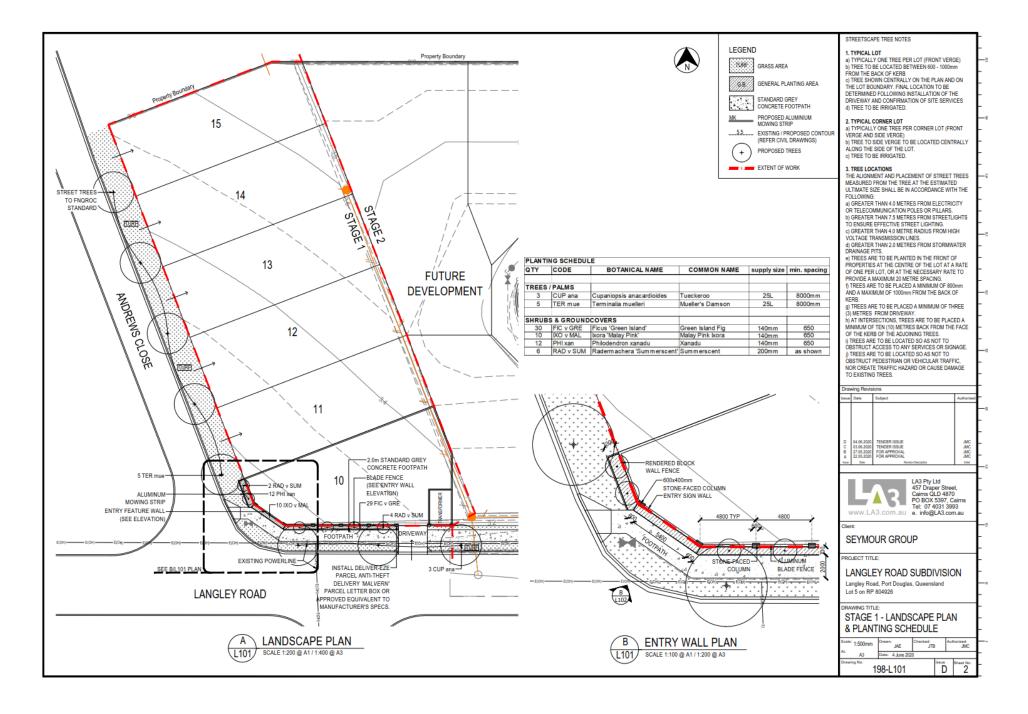
DWG NO.	REV	DRAWING NAME	SCALE (A3 SIZE)
198-L100	D	COVER PAGE	As Shown
198-L101	D	LANDSCAPE PLAN & PLANTING SCHEDULE	1:400
198-L102	D	ENTRY WALL DETAILS	As Shown
198-L103	D	TYP. DETAILS	As Shown





STANDARD NOTES	8. HARD LANDSCAPE
I. SETOUT AND DIMENSIONS I. SETOUT AND DIMENSIONS THE CONTRACTOR SHALL SET OUT ALL PATHS, WALLS, HARD SURFACES AND ELEMENTS EITHER ON OR OFF SITE PRIOR TO CONSTRUCTION AND SHALL OBTAIN THE SUPERINTENDENTS SET OUT APPROVAL PRIOR TO WORKS COMMENCING. WRITTEN DIMENSIONS SHALL DRAWINGS SCALES IN CONJUNCTION WITH DRAWINGS SIZE COORDINATE ALL WORKS WITH OTHER TRADES AND HEAD CONTRACTOR. E. SERVICES AND SITE ASSETS THE CONTRACTOR SHALL INVESTIGATE THE NATURE AND LICATION OF ALL EXISTING SERVICES AND RETAINED SITE ASSETS AFFECTED BY THEIR WORKS. FAILURE TO TAKE DIVE CARE SHALL NOT LIMIT THE CONTRACTORS LIABILITES.	18. HARD LANDSCAPE SAMPLES: UNLESS OTHERWISE NOTED, ALL TEMS MUST BE APPROVED PRIOR TO INSTALLATION AND MUST MEET CURRENT AUSTRALIANS TANDARDS AND BEST PRACTICE GUIDELINES. PROVIDE SAMPLES OF ALL SURFACE FINISHES AND MATERIALS TO BE PLACED IN THE CONSTRUCTED LANDSCAPE, ESPECIALLY ALTERNATIVES TO PROPRIETARY NOTICE TO THE SUPERINTENDENTS REPRESENTATIVE TO ATTEND OR REVIEW THE SAMPLE FOR COMMENT OR REJECTION, PROVIDE MAUFACTURES GUIDES AND REPLACEMENT WARRANTIES AND INSTALLATIC SPECIFICATIONS WHERE APPLICABLE. 9. IRRIGATION
3. REFERENCES THE CONTRACTOR SHALL REFER TO ALL CONTRACT DOCUMENTS, THE SPECIFICATION AND DRAWINGS PRIOR TO AND DURING THE WORKS.	TO FNQROC STANDARDS, CERTIFIED BY AN IA CID (IRRIGATION AUSTRALIAN ASSOCIATION CERTIFIED IRRIGATION DESIGNER) AND TO CLIENT'S APPROVAL
4. DISCREPANCIES	10. PLANT ESTABLISHMENT & MAINTENANCE
NOTIFY SUPERINITENDENT OF ANY SUSPECTED OR KNOWN DISCREPANCIES OR ERRORS PRIOR TO THE ORDERING OF AFFECTED MATERIALS AND/OR CONSTRUCTION OF AFFECTED WORKS. 5. RELEVANT STANDARDS	AREAS OF PLANTING CAN ONLY BE GIVEN FINA COMPLETION AFTER MINIMUM 13 WEEKS ESTABLISHMENT POST PRACTICAL COMPLETION. REPLACE ALL DEAD PLANT STOCK DURING THIS PERIOD AND NEW STOCK
THE CONTRACTOR SHALL UNDERTAKE ALL PRICING AND WORKS IN ACCORDANCE WITH CURRENT INDUSTRY BEST PRACTICE AND ALL RELEVANT AUSTRALIAN AND LOCAL STANDARDS AND THE FNQROC.	ESTABLISHED FOR MINIMUM 13 WEEKS. FINAL COMPLETION IS GIVEN AT 13 WEEKS POST PRACTICAL COMPLETION AND ONGOING MAINTENANCE BEGINS.
6. SERVICE LOCATOR	11. WORK HEALTH & SAFETY (WHS)
THE CONTRACTOR SHALL UNDERTAKE A DIAL BEFORE YOU DIG PROCESS PRIOR TO COMMENCING WORKS ON SITE. THE CONTRACTOR SHALL ENGAGE A SERVICE LOCATOR TO MAP THE SPECIFIC LOCATIONS AND DEPTH OF ALL SERVICES AND ADVISE ALL RELEVANT STAFF AND SUBCONTRACTORS IN WRITING PRIOR TO COMMENCING WORKS ON SITE.	THE CONTRACTOR SHALL FOLLOW THE APPROVED & CURRENT PROJECT WORK HEALTH & SAFETY MANUAL.
7. SOFT LANDSCAPE	
ALL CONTAINER STOCK SHALL BE INSPECTED IN THE NURSERY PRIOR TO TRANSPORT TO SITE. Z. ALL CONTAINER STOCK PLANTING SHALL BE INSPECTED PRIOR TO PLANTING ON SITE. GIVE (5) WORKING DAYS NOTICE PRIOR TO SUCH ACTIVITY TO ALLOW LANDSCAPE ARCHITECT'S REPRESENTATIVE TO ATTEND. ALL SOL BLENDS APPROVED TO AUSTRALIAN	D 04.05.2000 TENDER ISSUE JM C 01.05.2000 TENDER ISSUE JM B 27.05.2000 FENDER ISSUE JM A 22.05.2000 FCR APPROVAL JM Imme Emilier FCR APPROVAL JM
STANDARDS / A5419. 4. TURF SHALL CONSIST OF 25MM DEPTH OF DENSE, WELL ROOTED, VIGOROUS GRASS GROWTH WITH 25MM DEPTH OF TOPSOIL. 5. TURF TO BE USED SHOULD BE ROLLED B GRADE TURF	LA3 Pty Ltd 457 Draper Street, Cairies OLD 4870 PO BOX 5397. Cairins Tel: 07 4031 3993 e. info@LA3.com.au
MIX OF SPECIES 80% BUFFALO GRASS (AXONOPUS COMPRESSUS) & 20% COUCH GRASS VARIETIES. 6. EXCAVATE EXISTING SITE SOIL ON ALL GARDEN BEDS	Client: SEYMOUR GROUP
TO 300mm DEPTH AND REPLACE WITH APPROVED SOIL BLENDS. USE SITE STOCKED TOPSOIL AND AMEND WHERE POSSIBLE. LANDSCAPE CONTRACTOR TO ASSESS SUITABILITY FOR REUSE. IF UNSUITABLE, TOPSOIL TO BE REMOVED BY OTHERS.	PROJECT TITLE: LANGLEY ROAD SUBDIVISION Langley Road, Port Douglas, Queensland Lot 5 on RP 804926

D Sheet No.

198-L100



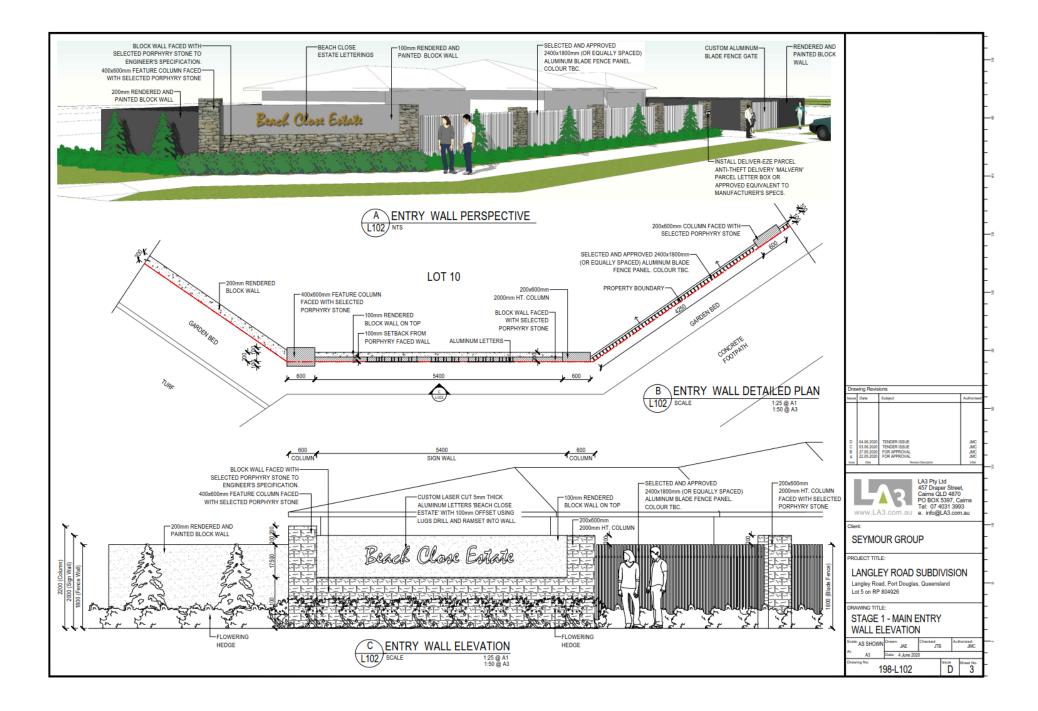

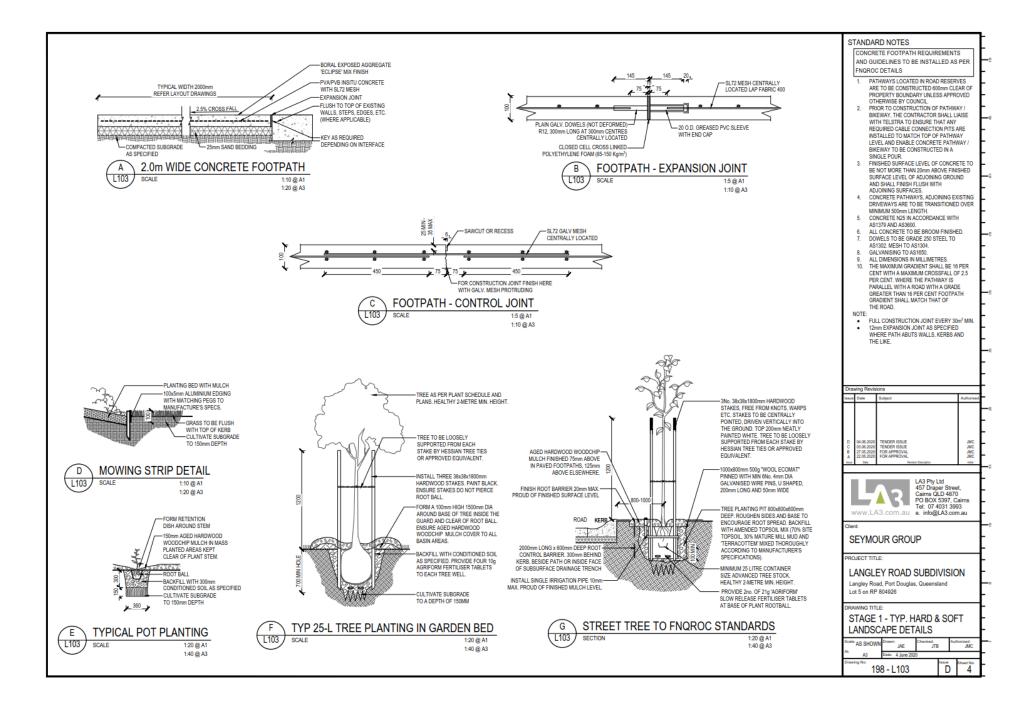

LANDSCAPE DESIGN LANGLEY RD SUBDIVISION - STAGE 2 LANGLEY ROAD, PORT DOUGLAS, QLD JUNE 2020 - TENDER ISSUE

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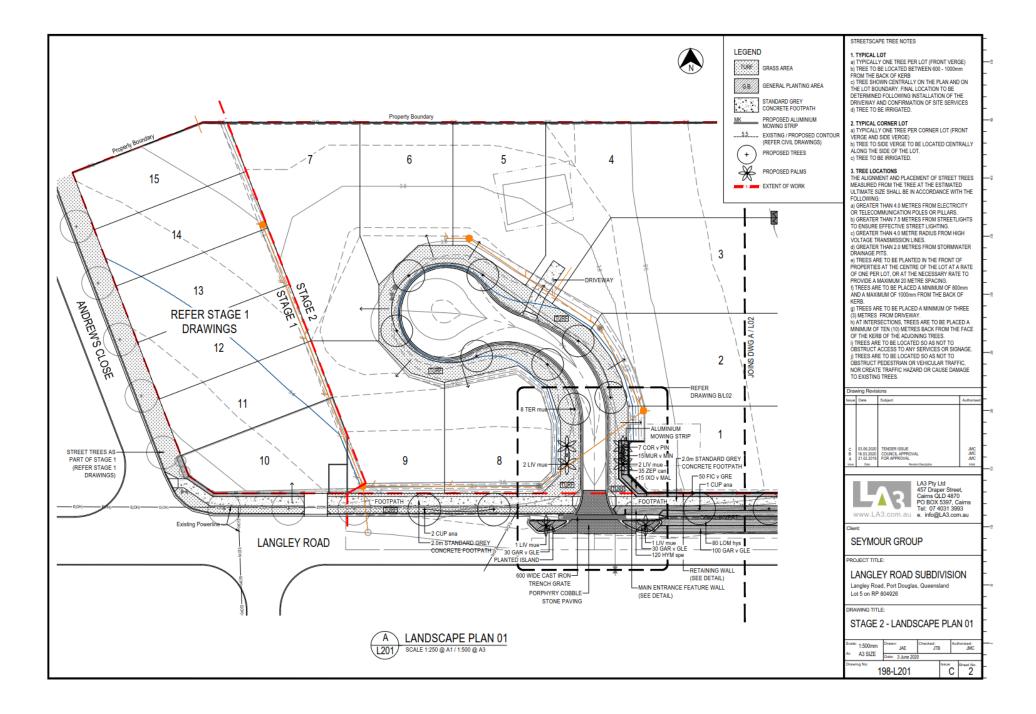
DWG NO.	REV	DRAWING NAME	SCALE (A3 SIZE)
198-L200	С	COVER PAGE	As Shown
198-L201	С	LANDSCAPE PLAN 01	1:500
198-L202	С	LANDSCAPE PLAN 02 & DETAIL PLANS	As Shown
198-L203	С	TYP. DETAILS & PLANTING SCHEDULE	As Shown
198-L204	С	ENTRY WALL, RET. WALL AND STAIRS DETAILS	As Shown





STANDARD NOTES	8. HARD LANDSCAPE	
1. SETOUT AND DIMENSIONS THE CONTRACTOR SHALL SET OUT ALL PATHS, WALLS, HARD SURFACES AND ELEMENTS EITHER ON OR OFF SITE PRIOR TO CONSTRUCTION AND SHALL OBTAIN THE SUPERITEINDENTS SET OUT APPROVAL PRIOR TO WORKS COMMENCING, WRITTEN DIMENSIONS SHALL TAKE PRECEDENCE OVER SCALE: CHECK ALL DRAWINGS SCALES IN CONJUNCTION WITH DRAWINGS SUZE. COORDINATE ALL WORKS WITH OTHER TRADES AND HEAD CONTRACTOR. 2. SERVICES AND SITE ASSETS THE CONTRACTOR SHALL	C. THARD LANDSCAPE SAMPLES UNLESS OTHERWISE NOTED, ALL TTEMS MUST BE APPROVED PRIOR TO INSTALLATION AND MUST MEET CURRENT AUSTRALIAN STANDARDS AND BEST PRACTICE GUIDELINES. PROVIDE SAMPLES OF ALL SURFACE FINISHES AND MATERIALS TO BE PLACED IN THE CONSTRUCTED LANDSCAPE, ESPECIALLY ALTERNATIVES TO PROPRIETARY NOTICE TO THE SUPERINTENDENTS REPRESENTATIVE TO ATTEND OR REVIEW THE SAMPLE FOR COMMENT OR REJECTION. PROVIDE MANUFACTURERS GUIDES AND REPLACEMENT WARRANTES AND INSTALLATIC SPECIFICATIONS WHERE APPLICABLE. 9. IRRIGATION	
AND LOCATION OF ALL EXISTING SERVICES AND RETAINED SITE ASSETS AFFECTED BY THEIR WORKS. FAILURE TO TAKE DUE CARE SHALL NOT LIMIT THE CONTRACTORS LIABILITIES.		
CONTRACTORS LIABILITIES. (3. REFERENCES THE CONTRACTOR SHALL REFER TO ALL CONTRACT DOCUMENTS, THE SPECIFICATION AND DRAWINGS PRIOR TO AND DURING THE WORKS.	DESIGN AND CONSTRUCT IRRIGATION SYSTEM TO FNOROC STANDARDS, CERTIFIED BY AN IAA CID (IRRIGATION AUSTRALIAN ASSOCIATION CERTIFIED IRRIGATION DESIGNER) AND TO CLIENT'S APPROVAL	
A. DISCREPANCIES NOTIFY SUPERINTENDENT OF ANY SUSPECTED OR KNOWN DISCREPANCIES OR ERRORS PRIOR TO THE ORDERING OF AFFECTED MATERIALS AND/OR	10. PLANT ESTABLISHMENT & MAINTENANCE AREAS OF PLANTING CAN ONLY BE GIVEN FINAL COMPLETION AFTER MINIMUM 13 WEEKS ESTABLISHMENT POST PRACTICAL COMPLETION AREFLACE ALL DEAD PLANT STOCK DURING THIS PERIOD AND NEW STOCK ESTABLISHED FOR MINIMUM 13 WEEKS. FINAL COMPLETION IS GIVEN AT 13 WEEKS POST PRACTICAL COMPLETION AND ONGOING MAINTENANCE BEGINS.	
CONSTRUCTION OF AFFECTED WORKS. 5. RELEVANT STANDARDS THE CONTRACTOR SHALL UNDERTAKE ALL PRICING AND WORKS IN ACCORDANCE WITH CURRENT INDUSTRY BEST PRACTICE AND ALL RELEVANT AUSTRALIAN AND LOCAL STANDARDS AND THE FNQROC.		
6. SERVICE LOCATOR THE CONTRACTOR SHALL UNDERTAKE A DIAL BEFORE	11. WORK HEALTH & SAFETY (WHS)	
YOU DIG PROCESS PRIOR TO COMMENCING WORKS ON SITE. THE CONTRACTOR SHALL ENGAGE A SERVICE LOCATOR TO MAP THE SPECIFIC LOCATIONS AND DEPTH OF ALL SERVICES AND ADVISE ALL RELEVANT STAFF AND SUBCONTRACTORS IN WRITING PRIOR TO COMMENCING WORKS ON SITE.	APPROVED & CURRENT PROJECT WORK HEALTH & SAFETY MANUAL. Drawing Revisions Issue Date Subject Autors	
7. SOFT LANDSCAPE		
1. ALL CONTAINER STOCK SHALL BE INSPECTED IN THE NURSERY PRIOR TO TRANSPORT TO SITE. 2. ALL CONTAINER STOCK PLANTING SHALL BE INSPECTED PRIOR TO PLANTING ON SITE. GIVE (5) WORKING DAYS NOTICE PRIOR TO SUCH ACTIVITY TO ALLOW LANDSCAPE ARCHITECT'S REPRESENTATIVE TO ATTEND. 3. ALL SOIL BLENDS APPROVED TO AUSTRALIAN STANDARDS / SAS419.	C 01953000 1 1633000 COUNCL APPROVAL M TOR PPROVAL M Tore Counce Approval M Textores 1504 Textores 1504 M M M M M M M M M M M M M	
4. TURF SHALL CONSIST OF 28MM DEPTH OF DENSE, WELL ROOTED, VIGOROUS GRASS GROWTH WITH 28MM DEPTH OF TOPSOIL. 5. TURF TO BE USED SHOULD BE ROLLED B GRADE TURF MIX OF SPECIES 80% BUFLALL OG GRASS (AXONOPUS COMPRESSUS) & 20% COUCH GRASS VARIETIES. 0. EXCAVATE EXISTING SITE SOIL ON ALL GARDEN BEDS	Caims GLD 4870 WWW.LA3.com.au Clent: SEYMOUR GROUP	
8. EXCRVATE EXISTING SITE SOIL ON ALL GARDEN BEDS TO 300mm DEPTH AND REPLACE WITH APRROVED SOIL BLENDS, USE SITE STOCKED TOPSOIL AND AMEND WHERE POSSIBLE. LANDSCAPE CONTRACTOR TO ASSESS SUITABILITY FOR REUSE. I UNSUITABILET, OPSOIL TO BE	PROJECT TITLE: LANGLEY ROAD SUBDIVISION Langley Road, Port Douglas, Queensland Lot 5 on RP 804926 DRAWING TITLE: STAGE 2 - COVER PAGE	


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Planning Act 2016 Chapter 3 Development assessment [s 74]

Division 2 Changing development approvals

Subdivision 1 Changes during appeal period

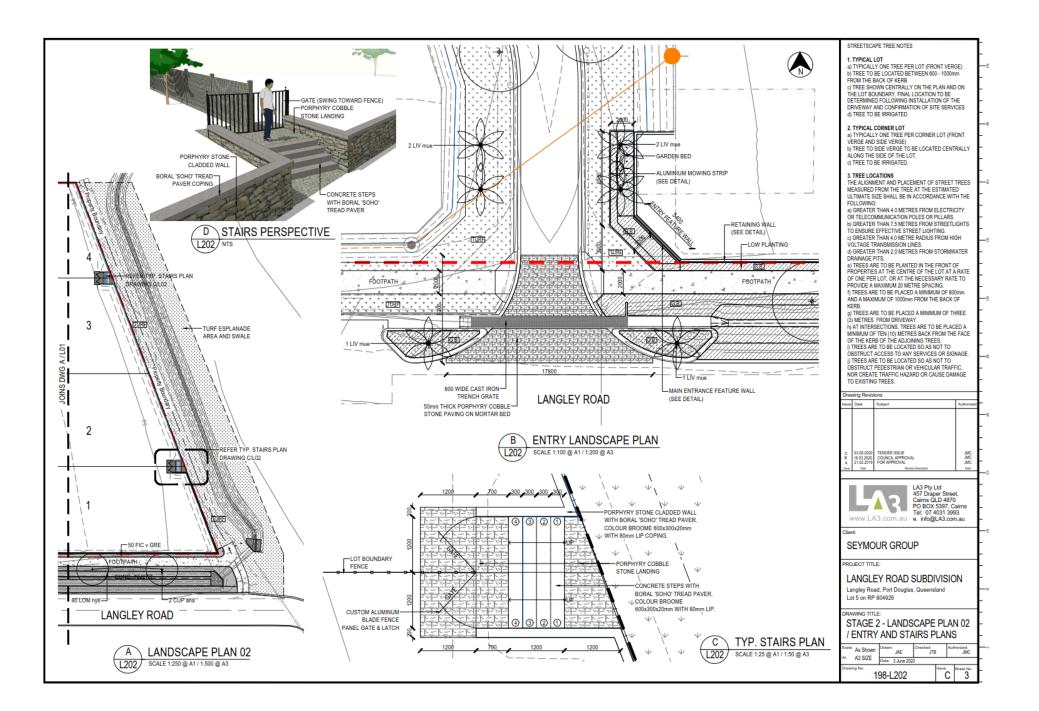74 What this subdivision is about

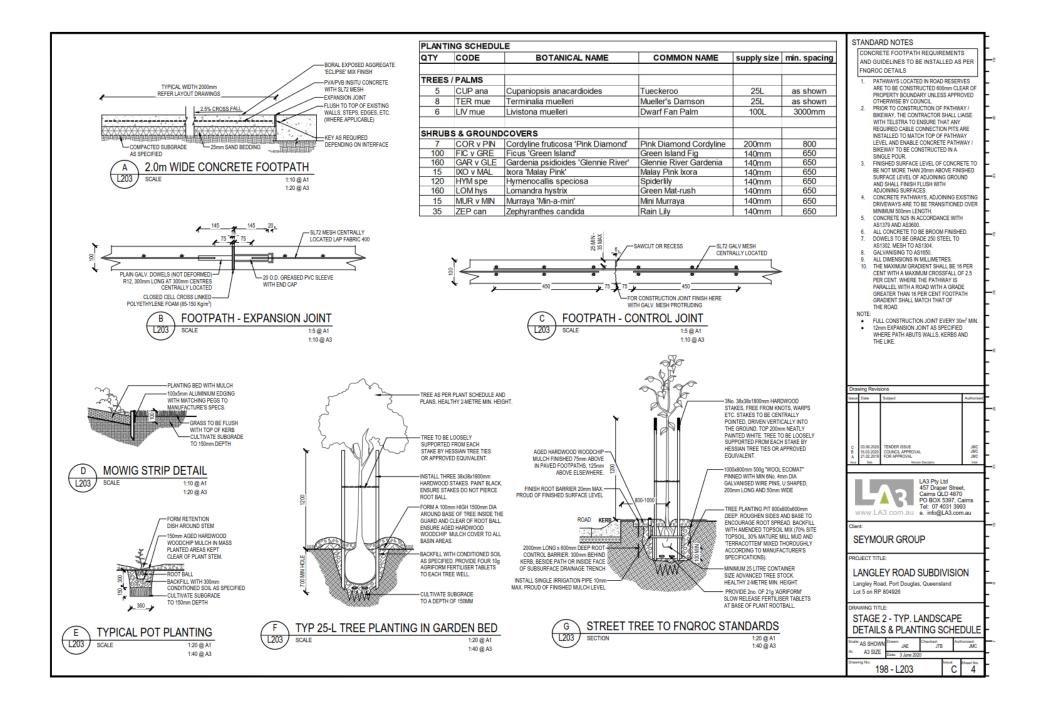- This subdivision is about changing a development approval before the applicant's appeal period for the approval ends.
- (2) This subdivision also applies to an approval of a change application, other than a change application for a minor change to a development approval.
- (3) For subsection (2), sections 75 and 76 apply-
 - (a) as if a reference in section 75 to a development approval were a reference to an approval of a change application; and
 - (b) as if a reference in the sections to the assessment manager were a reference to the responsible entity; and
 - (c) as if a reference in section 76 to a development application were a reference to a change application; and
 - (d) as if the reference in section 76(3)(b) to section 63(2) and (3) were a reference to section 83(4); and
 - (e) with any other necessary changes.

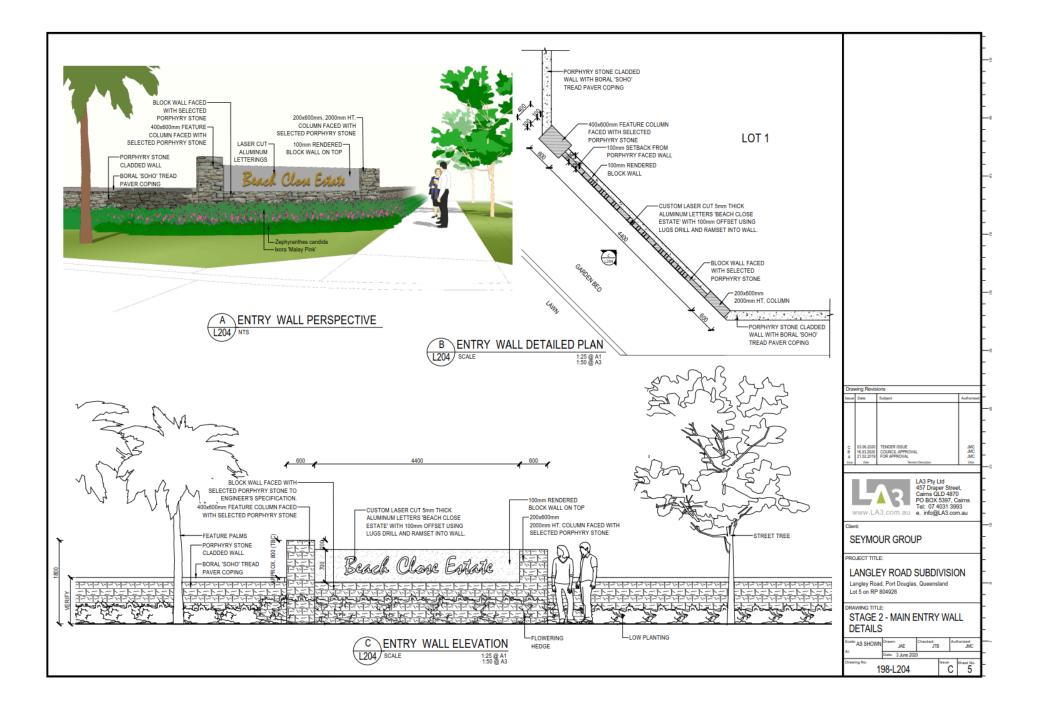75 Making change representations

- (1) The applicant may make representations (change representations) to the assessment manager, during the applicant's appeal period for the development approval, about changing—
 - (a) a matter in the development approval, other than-
 - a matter stated because of a referral agency's response; or

Page 94

Current as at 1 July 2019

- (ii) a development condition imposed under a direction made by the Minister under chapter 3, part 6, division 2; or
- (b) if the development approval is a deemed approval—the standard conditions taken to be included in the deemed approval under section 64(8)(c).
- (2) If the applicant needs more time to make the change representations, the applicant may, during the applicant's appeal period for the approval, suspend the appeal period by a notice given to the assessment manager.
- (3) Only 1 notice may be given.
- (4) If a notice is given, the appeal period is suspended-
 - (a) if the change representations are not made within a period of 20 business days after the notice is given to the assessment manager—until the end of that period; or
 - (b) if the change representations are made within 20 business days after the notice is given to the assessment manager, until—
 - (i) the applicant withdraws the notice, by giving another notice to the assessment manager; or
 - (ii) the applicant receives notice that the assessment manager does not agree with the change representations; or
 - (iii) the end of 20 business days after the change representations are made, or a longer period agreed in writing between the applicant and the assessment manager.
- (5) However, if the assessment manager gives the applicant a negotiated decision notice, the appeal period starts again on the day after the negotiated decision notice is given.

76 Deciding change representations

 The assessment manager must assess the change representations against and having regard to the matters that

Current as at 1 July 2019

Page 95

must be considered when assessing a development application, to the extent those matters are relevant.

- (2) The assessment manager must, within 5 business days after deciding the change representations, give a decision notice to—
 - (a) the applicant; and
 - (b) if the assessment manager agrees with any of the change representations—
 - (i) each principal submitter; and
 - (ii) each referral agency; and
 - (iii) if the assessment manager is not a local government and the development is in a local government area—the relevant local government; and
 - (iv) if the assessment manager is a chosen assessment manager—the prescribed assessment manager; and
 - (v) another person prescribed by regulation.
- (3) A decision notice (a *negotiated decision notice*) that states the assessment manager agrees with a change representation must—
 - (a) state the nature of the change agreed to; and
 - (b) comply with section 63(2) and (3).
- (4) A negotiated decision notice replaces the decision notice for the development application.
- (5) Only 1 negotiated decision notice may be given.
- (6) If a negotiated decision notice is given to an applicant, a local government may give a replacement infrastructure charges notice to the applicant.

Extracts from the Planning Act 2016 – Appeal Rights

Planning Act 2016 Chapter 6 Dispute resolution

[s 229]

- (2) The person is taken to have engaged in the representative's conduct, unless the person proves the person could not have prevented the conduct by exercising reasonable diligence.
- (3) In this section—

conduct means an act or omission.

representative means-

- (a) of a corporation—an executive officer, employee or agent of the corporation; or
- (b) of an individual—an employee or agent of the individual.

state of mind, of a person, includes the person's-

- (a) knowledge, intention, opinion, belief or purpose; and
- (b) reasons for the intention, opinion, belief or purpose.

Chapter 6 Dispute resolution

Part 1 Appeal rights

229 Appeals to tribunal or P&E Court

- (1) Schedule 1 states-
 - (a) matters that may be appealed to—
 - (i) either a tribunal or the P&E Court; or
 - (ii) only a tribunal; or
 - (iii) only the P&E Court; and
 - (b) the person
 - who may appeal a matter (the *appellant*); and
 - (ii) who is a respondent in an appeal of the matter; and

Page 212

Current as at 1 July 2019

- (iii) who is a co-respondent in an appeal of the matter; and
- (iv) who may elect to be a co-respondent in an appeal of the matter.
- (2) An appellant may start an appeal within the appeal period.
- (3) The appeal period is-
 - (a) for an appeal by a building advisory agency—10 business days after a decision notice for the decision is given to the agency; or
 - (b) for an appeal against a deemed refusal—at any time after the deemed refusal happens; or
 - (c) for an appeal against a decision of the Minister, under chapter 7, part 4, to register premises or to renew the registration of premises—20 business days after a notice is published under section 269(3)(a) or (4); or
 - (d) for an appeal against an infrastructure charges notice— 20 business days after the infrastructure charges notice is given to the person; or
 - (e) for an appeal about a deemed approval of a development application for which a decision notice has not been given—30 business days after the applicant gives the deemed approval notice to the assessment manager; or
 - (f) for an appeal relating to the *Plumbing and Drainage Act* 2018—
 - (i) for an appeal against an enforcement notice given because of a belief mentioned in the *Plumbing and Drainage Act 2018*, section 143(2)(a)(i), (b) or (c)—5 business days after the day the notice is given; or
 - (ii) for an appeal against a decision of a local government or an inspector to give an action notice under the *Plumbing and Drainage Act 2018*—5 business days after the notice is given; or

Current as at 1 July 2019

Page 213

- (iii) otherwise—20 business days after the day the notice is given; or
- (g) for any other appeal—20 business days after a notice of the decision for the matter, including an enforcement notice, is given to the person.

Note—

See the P&E Court Act for the court's power to extend the appeal period.

- (4) Each respondent and co-respondent for an appeal may be heard in the appeal.
- (5) If an appeal is only about a referral agency's response, the assessment manager may apply to the tribunal or P&E Court to withdraw from the appeal.
- (6) To remove any doubt, it is declared that an appeal against an infrastructure charges notice must not be about—
 - (a) the adopted charge itself; or
 - (b) for a decision about an offset or refund-
 - (i) the establishment cost of trunk infrastructure identified in a LGIP; or
 - (ii) the cost of infrastructure decided using the method included in the local government's charges resolution.

230 Notice of appeal

- An appellant starts an appeal by lodging, with the registrar of the tribunal or P&E Court, a notice of appeal that—
 - (a) is in the approved form; and
 - (b) succinctly states the grounds of the appeal.
- (2) The notice of appeal must be accompanied by the required fee.
- (3) The appellant or, for an appeal to a tribunal, the registrar, must, within the service period, give a copy of the notice of appeal to—

Page 214

Current as at 1 July 2019

- (a) the respondent for the appeal; and
- (b) each co-respondent for the appeal; and
- (c) for an appeal about a development application under schedule 1, section 1, table 1, item 1—each principal submitter for the application whose submission has not been withdrawn; and
- (d) for an appeal about a change application under schedule 1, section 1, table 1, item 2—each principal submitter for the application whose submission has not been withdrawn; and
- (e) each person who may elect to be a co-respondent for the appeal other than an eligible submitter for a development application or change application the subject of the appeal; and
- (f) for an appeal to the P&E Court—the chief executive; and
- (g) for an appeal to a tribunal under another Act—any other person who the registrar considers appropriate.
- (4) The service period is-
 - (a) if a submitter or advice agency started the appeal in the P&E Court—2 business days after the appeal is started; or
 - (b) otherwise—10 business days after the appeal is started.
- (5) A notice of appeal given to a person who may elect to be a co-respondent must state the effect of subsection (6).
- (6) A person elects to be a co-respondent to an appeal by filing a notice of election in the approved form—
 - (a) if a copy of the notice of appeal is given to the person within 10 business days after the copy is given to the person; or
 - (b) otherwise—within 15 business days after the notice of appeal is lodged with the registrar of the tribunal or the P&E Court.

Current as at 1 July 2019

Page 215

[s 231]

(7) Despite any other Act or rules of court to the contrary, a copy of a notice of appeal may be given to the chief executive by emailing the copy to the chief executive at the email address stated on the department's website for this purpose.

231 Non-appealable decisions and matters

- Subject to this chapter, schedule 1 and the P&E Court Act, unless the Supreme Court decides a decision or other matter under this Act is affected by jurisdictional error, the decision or matter is non-appealable.
- (2) The Judicial Review Act 1991, part 5 applies to the decision or matter to the extent it is affected by jurisdictional error.
- (3) A person who, but for subsection (1) could have made an application under the *Judicial Review Act 1991* in relation to the decision or matter, may apply under part 4 of that Act for a statement of reasons in relation to the decision or matter.
- (4) In this section—

decision includes-

- (a) conduct engaged in for the purpose of making a decision; and
- (b) other conduct that relates to the making of a decision; and
- (c) the making of a decision or the failure to make a decision; and
- (d) a purported decision; and
- (e) a deemed refusal.

non-appealable, for a decision or matter, means the decision or matter—

- (a) is final and conclusive; and
- (b) may not be challenged, appealed against, reviewed, quashed, set aside or called into question in any other way under the *Judicial Review Act 1991* or otherwise,

Page 216

Current as at 1 July 2019

whether by the Supreme Court, another court, any tribunal or another entity; and

(c) is not subject to any declaratory, injunctive or other order of the Supreme Court, another court, any tribunal or another entity on any ground.

232 Rules of the P&E Court

- A person who is appealing to the P&E Court must comply with the rules of the court that apply to the appeal.
- (2) However, the P&E Court may hear and decide an appeal even if the person has not complied with rules of the P&E Court.

Part 2 Development tribunal

Division 1 General

233 Appointment of referees

- (1) The Minister, or chief executive, (the *appointer*) may appoint a person to be a referee, by an appointment notice, if the appointer considers the person—
 - has the qualifications or experience prescribed by regulation; and
 - (b) has demonstrated an ability
 - to negotiate and mediate outcomes between parties to a proceeding; and
 - (ii) to apply the principles of natural justice; and
 - (iii) to analyse complex technical issues; and
 - (iv) to communicate effectively, including, for example, to write informed succinct and well-organised decisions, reports, submissions or other documents.

Current as at 1 July 2019

Page 217