DA Form 1 – Development application details

Approved form (version 1.3 effective 28 September 2020) made under section 282 of the Planning Act 2016.

This form **must** be used to make a development application **involving code assessment or impact assessment**, except when applying for development involving only building work.

For a development application involving **building work only**, use *DA Form 2 – Building work details*.

For a development application involving **building work associated with any other type of assessable development** (i.e. material change of use, operational work or reconfiguring a lot), use this form (*DA Form 1*) and parts 4 to 6 of *DA Form 2 – Building work details*.

Unless stated otherwise, all parts of this form **must** be completed in full and all required supporting information **must** accompany the development application.

One or more additional pages may be attached as a schedule to this development application if there is insufficient space on the form to include all the necessary information.

This form and any other form relevant to the development application must be used to make a development application relating to strategic port land and Brisbane core port land under the *Transport Infrastructure Act 1994*, and airport land under the *Airport Assets (Restructuring and Disposal) Act 2008*. For the purpose of assessing a development application relating to strategic port land and Brisbane core port land, any reference to a planning scheme is taken to mean a land use plan for the strategic port land, Brisbane port land use plan for Brisbane core port land, or a land use plan for airport land.

Note: All terms used in this form have the meaning given under the Planning Act 2016, the Planning Regulation 2017, or the Development Assessment Rules (DA Rules).

PART 1 - APPLICANT DETAILS

1) Applicant details	
Applicant name(s) (individual or company full name)	K P Cullen & N G Biddle & George Argyrou
Contact name (only applicable for companies)	C/- Greg Applin – Applin Consulting
Postal address (P.O. Box or street address)	19 Mullins Street
Suburb	Whitfield
State	QLD
Postcode	4870
Country	Australia
Contact number	0414 768 109
Email address (non-mandatory)	greg@applinconsulting.com.au
Mobile number (non-mandatory)	0414 768 109
Fax number (non-mandatory)	n/a
Applicant's reference number(s) (if applicable)	n/a

2) Owner's consent
2.1) Is written consent of the owner required for this development application?



PART 2 - LOCATION DETAILS

3) Location of the premises (complete 3.1) or 3.2), and 3.3) as applicable) Note: Provide details below and attach a site plan for any or all premises part of the development application. For further information, see <u>DA Forms Guide: Relevant plans.</u>									
3.1) Street address and lot on plan									
Street address AND lot on plan (all lots must be listed), or									
Street address AND lot on plan for an adjoining or adjacent property of the premises (appropriate for development in water but adjoining or adjacent to land e.g. jetty, pontoon. All lots must be listed).									
	Unit No.	Stree	t No.	Stree	Street Name and Type				Suburb
12-14 Murphy Street					Port Douglas				
a) Postcode Lot No. Plan Type and Number (e.g. RP, SP)		Local Government Area(s)							
	4873	113&	114	PTD2	2094				Douglas Shire Council
	Unit No.	Stree	t No.	Stree	t Name and	Туре			Suburb
b)	Postcode	Lot N	0.	Plan	Type and Nu	ımber ((e.g. RF	P, SP)	Local Government Area(s)
							-		
3.2) C	oordinates o	of prem	ises (ap	propriat	e for developme	ent in ren	note area	as, over part of a	a lot or in water not adjoining or adjacent to land
e.	g. channel dred	dging in I	Moreton E	Bay)					
	lace each set o			•	e row. de and latitud	0			
Longit		premis	Latitud		e and latitud	Datur	m		Local Government Area(s) (if applicable)
Longit	uue(s)		Lalliu	Je(S)			/GS84		Local Government Area(s) (ii applicable)
							DA94		
							ther:		
ПСо	ordinates of	premis	es by e	astina	and northing				
Eastin		Ī	ning(s)		Zone Ref.	Datur	m		Local Government Area(s) (if applicable)
	9(-)		9(-)		□ 54		/GS84		
					☐ 5 -		DA94		
					□ 56		ther:		
3.3) A	dditional pre	mises							
Ad	ditional pren	nises a	re relev	ant to	this developr	nent a	pplicati	on and the de	etails of these premises have been
atta	ached in a so				opment appli				·
⊠ No	t required								
4) 1.1								., .	
					· · · · · · · · · · · · · · · · · · ·			vide any rele	vant details
	•				itercourse or	in or a	bove a	n aquiter	
Name of water body, watercourse or aquifer: On strategic port land under the <i>Transport Infrastructure Act 1994</i>									
	• •				·	structur	e Act 1	994	
ŀ	plan descrip		•	•	land:				
	of port auth	ority fo	r the lot	:					
_	a tidal area								
·					area (if applica	able):			
	of port auth								
☐ On	airport land	under	the Airp	oort As	sets (Restru	cturing	and D	isposal) Act 2	2008
Namo	of airport						1		

$\ \ \square$ Listed on the Environmental Management Register (EN	IR) under the Environmental Protection Act 1994			
EMR site identification:				
Listed on the Contaminated Land Register (CLR) unde	the Environmental Protection Act 1994			
CLR site identification:				
5) Are there any existing easements over the premises? Note: Easement uses vary throughout Queensland and are to be identified correctly and accurately. For further information on easements and how they may affect the proposed development, see <u>DA Forms Guide</u> .				
how they may affect the proposed development, see <u>DA Forms Guide.</u>	d correctly and accurately. For further information on easements and			
	,			

PART 3 – DEVELOPMENT DETAILS

Section 1 – Aspects of development

6.1) Provide details about the first development aspect				
a) What is the type of development? (tick only one box)				
☐ Material change of use ☐ Reconfiguring a lot ☐ Operational work ☐ Building work				
b) What is the approval type? (tick only one box)				
□ Development permit □ Preliminary approval □ Preliminary approval that includes a variation approval				
c) What is the level of assessment?				
☐ Code assessment ☐ Impact assessment (requires public notification)				
d) Provide a brief description of the proposal (e.g. 6 unit apartment building defined as multi-unit dwelling, reconfiguration of 1 lot into 3 lots):				
Operational work in Council Road reserve to construct external stairs				
e) Relevant plans Note: Relevant plans are required to be submitted for all aspects of this development application. For further information, see <u>DA Forms guide:</u> Relevant plans.				
Relevant plans of the proposed development are attached to the development application				
6.2) Provide details about the second development aspect				
a) What is the type of development? (tick only one box)				
☐ Material change of use ☐ Reconfiguring a lot ☐ Operational work ☐ Building work				
b) What is the approval type? (tick only one box)				
☐ Development permit ☐ Preliminary approval ☐ Preliminary approval that includes a variation approva				
c) What is the level of assessment?				
☐ Code assessment ☐ Impact assessment (requires public notification)				
d) Provide a brief description of the proposal (e.g. 6 unit apartment building defined as multi-unit dwelling, reconfiguration of 1 lot into 3 lots):				
e) Relevant plans Note: Relevant plans are required to be submitted for all aspects of this development application. For further information, see DA Forms Guide: Relevant plans .				
Relevant plans of the proposed development are attached to the development application				
6.3) Additional aspects of development				
Additional aspects of development are relevant to this development application and the details for these aspects that would be required under Part 3 Section 1 of this form have been attached to this development application				

Section 2 - Further development details

Occilon 2 Turiner acvelop	micht ac	ians					
7) Does the proposed develop	ment appli	cation invol	ve any of the follow	ving?			
Material change of use	ge of use						
Reconfiguring a lot	☐ Yes –	es – complete division 2					
Operational work	⊠ Yes –	- complete division 3					
Building work	Yes –	complete	DA Form 2 – Buildi	ng work det	tails		
Division 1 Motorial aboves	4						
Division 1 – Material change of Note : This division is only required to be		any part of th	e development applicati	ion involves a l	material cl	nange of use asse	ssable against a
local planning instrument. 8.1) Describe the proposed ma	terial chan	nae of use					
Provide a general description of proposed use		Provide th	ne planning scheme h definition in a new rov			er of dwelling f applicable)	Gross floor area (m²) (if applicable)
8.2) Does the proposed use inv	olve the u	se of existi	ng buildings on the	premises?			
Yes							
□ No							
Division 2 – Reconfiguring a lo Note: This division is only required to be 9.1) What is the total number of	completed if			on involves re	configuring	g a lot.	
,			·				
9.2) What is the nature of the lo	ot reconfig	uration? (tid	k all applicable boxes)				
Subdivision (complete 10))			Dividing land i	nto parts by	agreen	nent (complete 1	1))
Boundary realignment (comp	olete 12))		Creating or ch from a constru				s to a lot
10) Subdivision							
10.1) For this development, ho	w many lo	ts are beino	g created and what	is the inten	ded use	of those lots:	
Intended use of lots created	Reside	ntial	Commercial	Industrial		Other, please	specify:
Number of lots created							
10.2) Will the subdivision be st	aged?						
☐ Yes – provide additional det☐ No	tails below						
How many stages will the work	s include?						
What stage(s) will this develop apply to?							

11) Dividing land int parts?	o parts b	y ag	reement – how	v man	y parts a	re being c	reated and what	is the intended use of the
Intended use of parts created		Residential C		Comme	rcial	Industrial	Other, please specify:	
Number of parts cre	ated							
Number of parts cre	aicu							
12) Boundary realig	nment							
12.1) What are the	current a	nd p	roposed areas	for e	ach lot co	mprising	the premises?	
Current lot						Prop	osed lot	
Lot on plan descript	tion	Are	rea (m²)		Lo	Lot on plan description		Area (m²)
12.2) What is the re	ason for	the	boundary reali	gnme	nt?			
12) What are the di	manaiana	on	d natura of any	voviet	ing coor	monto boi	ng obenged end	for any proposed assembnt?
(attach schedule if there	are more ti	han t	u Hature of arry wo easements)	EXIST	ing easei	nents ben	ng changed and/	or any proposed easement?
Existing or proposed?	Width (r	m)	Length (m)		oose of th strian acces	e easeme ss)	ent? (e.g.	Identify the land/lot(s) benefitted by the easement
Division 2 On smat	مير امما	ء اس						
Division 3 – Operat <i>Note: This division is only</i> :			ompleted if anv par	rt of the	e developme	ent applicati	on involves operation	nal work.
14.1) What is the na						1.0		
□ Road work			\boxtimes	Stor	mwater		Water inf	rastructure
□ Drainage work □					hworks	_ 5		
Landscaping	.,		L	Sign	age			vegetation
Other – please s							1	
14.2) Is the operation			-	itate ti	ne creation	on of new	IOts? (e.g. subdivis	ion)
Yes – specify nu	imber of i	new	lots:					
No	on otori ()	, alu	o of the propos	ad an	orational	work? //-	alada OOT waatadal	
14.3) What is the m	onetary v	/aiut	e or the propos	eu op	eralionai	work? (in	ciude GST, materiais	s and labour)
Ψ230,000								
PART 4 – ASS	ESSMI	ΕN	T MANAG	ER I	DETAI	LS		
15) Identify the asso	essment	man	nager(s) who w	ill be a	assessin	g this dev	elopment applica	ition
Douglas Shire Cour	ncil							
16) Has the local go	overnmer	nt ag	reed to apply a	a supe	erseded p	olanning s	cheme for this d	evelopment application?
Yes – a copy of	the decis	ion	notice is attach	ed to	this deve	elopment	application	
attached	nment is t	ake	n to have agre	ed to	the super	seded pla	anning scheme re	equest – relevant documents
⊠ No								

PART 5 - REFERRAL DETAILS

17) Does this development application include any aspects that have any referral requirements? Note: A development application will require referral if prescribed by the Planning Regulation 2017.
No, there are no referral requirements relevant to any development aspects identified in this development application – proceed to Part 6
Matters requiring referral to the Chief Executive of the Planning Act 2016:
☐ Clearing native vegetation
Contaminated land (unexploded ordnance)
Environmentally relevant activities (ERA) (only if the ERA has not been devolved to a local government)
Fisheries – aquaculture
Fisheries – declared fish habitat area
Fisheries – marine plants
Fisheries – waterway barrier works
Hazardous chemical facilities
Heritage places – Queensland heritage place (on or near a Queensland heritage place)
☐ Infrastructure-related referrals – designated premises
☐ Infrastructure-related referrals – state transport infrastructure
☐ Infrastructure-related referrals – State transport corridor and future State transport corridor
☐ Infrastructure-related referrals – State-controlled transport tunnels and future state-controlled transport tunnels
☐ Infrastructure-related referrals – near a state-controlled road intersection
☐ Koala habitat in SEQ region – interfering with koala habitat in koala habitat areas outside koala priority areas
☐ Koala habitat in SEQ region – key resource areas
☐ Ports – Brisbane core port land – near a State transport corridor or future State transport corridor
☐ Ports – Brisbane core port land – environmentally relevant activity (ERA)
Ports – Brisbane core port land – tidal works or work in a coastal management district
Ports – Brisbane core port land – hazardous chemical facility
Ports – Brisbane core port land – taking or interfering with water
Ports – Brisbane core port land – referable dams
Ports – Brisbane core port land – fisheries
Ports – Land within Port of Brisbane's port limits (below high-water mark)
☐ SEQ development area
 SEQ regional landscape and rural production area or SEQ rural living area – tourist activity or sport and recreation activity
SEQ regional landscape and rural production area or SEQ rural living area – community activity
SEQ regional landscape and rural production area or SEQ rural living area – indoor recreation
SEQ regional landscape and rural production area or SEQ rural living area – urban activity
SEQ regional landscape and rural production area or SEQ rural living area – combined use
☐ Tidal works or works in a coastal management district
Reconfiguring a lot in a coastal management district or for a canal
☐ Erosion prone area in a coastal management district
☐ Urban design
☐ Water-related development – taking or interfering with water
☐ Water-related development – removing quarry material (from a watercourse or lake)
☐ Water-related development – referable dams
☐ Water-related development –levees (category 3 levees only)
☐ Wetland protection area
Matters requiring referral to the local government:
☐ Airport land
Environmentally relevant activities (ERA) (only if the ERA has been devolved to local government)

☐ Heritage places – Local heritage places				
Matters requiring referral to the Chief Executive of the di Infrastructure-related referrals – Electricity infrastructur		on entity:		
Matters requiring referral to:				
The Chief Executive of the holder of the licence, if	not an individual			
The holder of the licence, if the holder of the licence				
☐ Infrastructure-related referrals – Oil and gas infrastruct	ure			
Matters requiring referral to the Brisbane City Council : ☐ Ports − Brisbane core port land				
Matters requiring referral to the Minister responsible for ☐ Ports − Brisbane core port land (where inconsistent with the ☐ Ports − Strategic port land				
Matters requiring referral to the relevant port operator , if ☐ Ports − Land within Port of Brisbane's port limits (below	• • • • • • • • • • • • • • • • • • • •			
Matters requiring referral to the Chief Executive of the re Ports – Land within limits of another port (below high-water)	-			
Matters requiring referral to the Gold Coast Waterways A Tidal works or work in a coastal management district (iii				
Matters requiring referral to the Queensland Fire and Em Tidal works or work in a coastal management district (ii)		berths))		
40)				
18) Has any referral agency provided a referral response f ☐ Yes − referral response(s) received and listed below ar ☐ No				
Referral requirement	Referral agency	Date of referral response		
Identify and describe any changes made to the proposed development application that was the subject of the referral response and this development application, or include details in a schedule to this development application (if applicable).				
PART 6 – INFORMATION REQUEST				
19) Information request under Part 3 of the DA Rules				
	n a a a a a w , for this day along the ant	opplication		
☑ I agree to receive an information request if determined☐ I do not agree to accept an information request for this	•	application		
Note : By not agreeing to accept an information request I, the applicant, a				
that this development application will be assessed and decided base application and the assessment manager and any referral agencie Rules to accept any additional information provided by the application parties	sed on the information provided when m s relevant to the development applicatio	n are not obligated under the DA		

Part 3 of the DA Rules will still apply if the application is an application listed under section 11.3 of the DA Rules.

Further advice about information requests is contained in the <u>DA Forms Guide</u>.

PART 7 – FURTHER DETAILS

20) Are there any associated						
	w or include details in a sched	lule to this d	evelopment appli	cation		
List of approval/development application references	Reference number	Date		Assessment manager		
☐ Approval ☐ Development application	MCUC 2024_5563/1	24 Ap	oril 2024	Daniel Lamond		
☑ Approval☑ Development application	MCUC 2022_4732/1	7 Oct	tober 2022	Sara Roberts / Jenny Elphinstone		
21) Has the portable long ser operational work)	vice leave levy been paid? (or	nly applicable to	development applica	ations involving building work or		
	ted QLeave form is attached t					
	rovide evidence that the porta ides the development applicat					
	val only if I provide evidence t					
	ng and construction work is le	-	_			
Amount paid	Date paid (dd/mm/yy)		QLeave levy nu	mber (A, B or E)		
\$			-			
	1					
22) Is this development applic notice?	cation in response to a show o	ause notice	or required as a	result of an enforcement		
Yes – show cause or enfor	rcement notice is attached					
⊠ No	⊠ No					
23) Further legislative require	ments					
Environmentally relevant ac	ctivities					
	olication also taken to be an ap					
	nent (form ESR/2015/1791) fo					
accompanies this develop	ment application, and details a					
No No Note: Application for an environment	tal authority can be found by searchir	og "ESD/2015/1	701" as a search term	a at your ald gov ay. An EDA		
	to operate. See <u>www.business.qld.go</u>			Tat <u>www.qiu.gov.au</u> . AT LNA		
Proposed ERA number:		Proposed E	RA threshold:			
Proposed ERA name:						
Multiple ERAs are applicable to this development application and the details have been attached in a schedule to this development application.						
Hazardous chemical facilitie	es_					
23.2) Is this development app	olication for a hazardous che	mical facility	y ?			
	n of a facility exceeding 10%			tached to this development		
⊠ No						
Note: See www.husiness.cld.cov.ov	for further information about hazarde	un ahamiaal na	tifications			

Clearing native vegetation
23.3) Does this development application involve clearing native vegetation that requires written confirmation that the chief executive of the <i>Vegetation Management Act 1999</i> is satisfied the clearing is for a relevant purpose under section 22A of the <i>Vegetation Management Act 1999</i> ?
☐ Yes – this development application includes written confirmation from the chief executive of the <i>Vegetation Management Act 1999</i> (s22A determination)
Note: 1. Where a development application for operational work or material change of use requires a s22A determination and this is not included, the development application is prohibited development. 2. See https://www.qld.gov.au/environment/land/vegetation/applying for further information on how to obtain a s22A determination.
Environmental offsets
23.4) Is this development application taken to be a prescribed activity that may have a significant residual impact on a prescribed environmental matter under the <i>Environmental Offsets Act 2014</i> ?
 Yes – I acknowledge that an environmental offset must be provided for any prescribed activity assessed as having a significant residual impact on a prescribed environmental matter No
Note: The environmental offset section of the Queensland Government's website can be accessed at www.qld.gov.au for further information on environmental offsets.
Koala habitat in SEQ Region
23.5) Does this development application involve a material change of use, reconfiguring a lot or operational work which is assessable development under Schedule 10, Part 10 of the Planning Regulation 2017?
Yes – the development application involves premises in the koala habitat area in the koala priority area
Yes – the development application involves premises in the koala habitat area outside the koala priority area
No Note: If a koala habitat area determination has been obtained for this premises and is current over the land, it should be provided as part of this development application. See koala habitat area guidance materials at www.des.qld.gov.au for further information.
Water resources
Water resources 23.6) Does this development application involve taking or interfering with underground water through an artesian or subartesian bore, taking or interfering with water in a watercourse, lake or spring, or taking overland flow water under the <i>Water Act 2000</i> ?
23.6) Does this development application involve taking or interfering with underground water through an artesian or subartesian bore, taking or interfering with water in a watercourse, lake or spring, or taking overland flow water under the <i>Water Act 2000</i> ? Yes – the relevant template is completed and attached to this development application and I acknowledge that a relevant authorisation or licence under the <i>Water Act 2000</i> may be required prior to commencing development
23.6) Does this development application involve taking or interfering with underground water through an artesian or subartesian bore, taking or interfering with water in a watercourse, lake or spring, or taking overland flow water under the <i>Water Act 2000</i> ? ☐ Yes − the relevant template is completed and attached to this development application and I acknowledge that a relevant authorisation or licence under the <i>Water Act 2000</i> may be required prior to commencing development ☐ No
23.6) Does this development application involve taking or interfering with underground water through an artesian or subartesian bore, taking or interfering with water in a watercourse, lake or spring, or taking overland flow water under the <i>Water Act 2000</i> ? Yes – the relevant template is completed and attached to this development application and I acknowledge that a relevant authorisation or licence under the <i>Water Act 2000</i> may be required prior to commencing development Note: Contact the Department of Natural Resources, Mines and Energy at www.dnrme.qld.gov.au for further information.
23.6) Does this development application involve taking or interfering with underground water through an artesian or subartesian bore, taking or interfering with water in a watercourse, lake or spring, or taking overland flow water under the <i>Water Act 2000</i> ? ☐ Yes − the relevant template is completed and attached to this development application and I acknowledge that a relevant authorisation or licence under the <i>Water Act 2000</i> may be required prior to commencing development ☐ No
23.6) Does this development application involve taking or interfering with underground water through an artesian or subartesian bore, taking or interfering with water in a watercourse, lake or spring, or taking overland flow water under the <i>Water Act 2000</i> ? □ Yes − the relevant template is completed and attached to this development application and I acknowledge that a relevant authorisation or licence under the <i>Water Act 2000</i> may be required prior to commencing development □ No Note: Contact the Department of Natural Resources, Mines and Energy at www.dnrme.qld.gov.au for further information. DA templates are available from https://planning.dsdmip.qld.gov.au/. If the development application involves: • Taking or interfering with underground water through an artesian or subartesian bore: complete DA Form 1 Template 1 • Taking or interfering with water in a watercourse, lake or spring: complete DA Form1 Template 2
23.6) Does this development application involve taking or interfering with underground water through an artesian or subartesian bore, taking or interfering with water in a watercourse, lake or spring, or taking overland flow water under the <i>Water Act 2000</i> ? ☐ Yes − the relevant template is completed and attached to this development application and I acknowledge that a relevant authorisation or licence under the <i>Water Act 2000</i> may be required prior to commencing development ☐ No Note: Contact the Department of Natural Resources, Mines and Energy at www.dnrme.qld.gov.au for further information. DA templates are available from https://planning.dsdmip.qld.gov.au/ . If the development application involves: Taking or interfering with underground water through an artesian or subartesian bore: complete DA Form 1 Template 1 Taking overland flow water: complete DA Form 1 Template 3.
23.6) Does this development application involve taking or interfering with underground water through an artesian or subartesian bore, taking or interfering with water in a watercourse, lake or spring, or taking overland flow water under the Water Act 2000? Yes – the relevant template is completed and attached to this development application and I acknowledge that a relevant authorisation or licence under the Water Act 2000 may be required prior to commencing development No Note: Contact the Department of Natural Resources, Mines and Energy at www.dnrme.qld.gov.au for further information. DA templates are available from https://planning.dsdmip.qld.gov.au . If the development application involves: Taking or interfering with underground water through an artesian or subartesian bore: complete DA Form 1 Template 1 Taking or interfering with water in a watercourse, lake or spring: complete DA Form1 Template 2 Taking overland flow water: complete DA Form 1 Template 3. Waterway barrier works
23.6) Does this development application involve taking or interfering with underground water through an artesian or subartesian bore, taking or interfering with water in a watercourse, lake or spring, or taking overland flow water under the Water Act 2000? Yes – the relevant template is completed and attached to this development application and I acknowledge that a relevant authorisation or licence under the Water Act 2000 may be required prior to commencing development Note: Contact the Department of Natural Resources, Mines and Energy at www.dnrme.gld.gov.au for further information. DA templates are available from https://planning.dsdmip.gld.gov.au . If the development application involves: Taking or interfering with underground water through an artesian or subartesian bore: complete DA Form 1 Template 1 Taking or interfering with water in a watercourse, lake or spring: complete DA Form1 Template 2 Taking overland flow water: complete DA Form 1 Template 3. Waterway barrier works 23.7) Does this application involve waterway barrier works? Yes – the relevant template is completed and attached to this development application
23.6) Does this development application involve taking or interfering with underground water through an artesian or subartesian bore, taking or interfering with water in a watercourse, lake or spring, or taking overland flow water under the Water Act 2000? Yes – the relevant template is completed and attached to this development application and I acknowledge that a relevant authorisation or licence under the Water Act 2000 may be required prior to commencing development No Note: Contact the Department of Natural Resources, Mines and Energy at www.dnrme.qld.gov.au for further information. DA templates are available from https://planning.dsdmip.qld.gov.au . If the development application involves: Taking or interfering with underground water through an artesian or subartesian bore: complete DA Form 1 Template 1 Taking or interfering with water in a watercourse, lake or spring: complete DA Form1 Template 2 Taking overland flow water: complete DA Form 1 Template 3. Waterway barrier works 23.7) Does this application involve waterway barrier works?
23.6) Does this development application involve taking or interfering with underground water through an artesian or subartesian bore, taking or interfering with water in a watercourse, lake or spring, or taking overland flow water under the Water Act 2000? Yes – the relevant template is completed and attached to this development application and I acknowledge that a relevant authorisation or licence under the Water Act 2000 may be required prior to commencing development No Note: Contact the Department of Natural Resources, Mines and Energy at www.dnrme.gld.gov.au for further information. DA templates are available from https://planning.dsdmip.gld.gov.au . If the development application involves: Taking or interfering with underground water through an artesian or subartesian bore: complete DA Form 1 Template 1 Taking or interfering with water in a watercourse, lake or spring: complete DA Form1 Template 2 Taking overland flow water: complete DA Form 1 Template 3. Waterway barrier works 23.7) Does this application involve waterway barrier works? Yes – the relevant template is completed and attached to this development application No DA templates are available from https://planning.dsdmip.gld.gov.au/ . For a development application involving waterway barrier works, complete
23.6) Does this development application involve taking or interfering with underground water through an artesian or subartesian bore, taking or interfering with water in a watercourse, lake or spring, or taking overland flow water under the Water Act 2000? Yes – the relevant template is completed and attached to this development application and I acknowledge that a relevant authorisation or licence under the Water Act 2000 may be required prior to commencing development No. Note: Contact the Department of Natural Resources, Mines and Energy at www.dnrme.qld.gov.au for further information. DA templates are available from https://planning.dsdmip.qld.gov.au/ . If the development application involves: Taking or interfering with underground water through an artesian or subartesian bore: complete DA Form 1 Template 1 Taking or interfering with water in a watercourse, lake or spring: complete DA Form1 Template 2 Taking overland flow water: complete DA Form 1 Template 3. Waterway barrier works 3.7) Does this application involve waterway barrier works? Yes – the relevant template is completed and attached to this development application No DA templates are available from https://planning.dsdmip.qld.gov.au/ . For a development application involving waterway barrier works, complete DA Form 1 Template 4.
23.6) Does this development application involve taking or interfering with underground water through an artesian or subartesian bore, taking or interfering with water in a watercourse, lake or spring, or taking overland flow water under the Water Act 2000? Yes - the relevant template is completed and attached to this development application and I acknowledge that a relevant authorisation or licence under the Water Act 2000 may be required prior to commencing development No Note: Contact the Department of Natural Resources, Mines and Energy at www.dnrme.qld.gov.au for further information. DA templates are available from https://planning.dsdmip.qld.gov.au . If the development application involves: • Taking or interfering with underground water through an artesian or subartesian bore: complete DA Form 1 Template 1 • Taking or interfering with water in a watercourse, lake or spring: complete DA Form1 Template 2 • Taking overland flow water: complete DA Form 1 Template 3. Waterway barrier works 23.7) Does this application involve waterway barrier works? Yes - the relevant template is completed and attached to this development application involving waterway barrier works, complete DA Form 1 Template 4. Marine activities 23.8) Does this development application involve aquaculture, works within a declared fish habitat area or

Quarry materials from a watercourse or lake				
23.9) Does this development application involve the removal of under the <i>Water Act 2000?</i>	quarry materials from a wate	rcourse or lake		
☐ Yes – I acknowledge that a quarry material allocation notice☒ No	must be obtained prior to comm	encing development		
Note : Contact the Department of Natural Resources, Mines and Energy at www.information.	v.dnrme.qld.gov.au and www.business.q	<u>ald.gov.au</u> for further		
Quarry materials from land under tidal waters				
23.10) Does this development application involve the removal of under the <i>Coastal Protection and Management Act 1995?</i>	of quarry materials from land (under tidal water		
☐ Yes – I acknowledge that a quarry material allocation notice☒ No	must be obtained prior to comm	encing development		
Note: Contact the Department of Environment and Science at www.des.qld.gov	<u>au</u> for further information.			
Referable dams				
23.11) Does this development application involve a referable d asection 343 of the <i>Water Supply (Safety and Reliability) Act 200</i>		assessed under		
☐ Yes – the 'Notice Accepting a Failure Impact Assessment' from Supply Act is attached to this development application	om the chief executive administe	ering the Water		
No Note: See guidance materials at www.dnrme.qld.gov.au for further information.				
Tidal work or development within a coastal management dis	<u>strict</u>			
23.12) Does this development application involve tidal work or	development in a coastal mar	nagement district?		
Yes – the following is included with this development applica				
 Evidence the proposal meets the code for assessable if application involves prescribed tidal work) 	development that is prescribed	tidal work (only required		
☐ A certificate of title				
⊠ No				
Note: See guidance materials at www.des.qld.gov.au for further information. Queensland and local heritage places				
		lie the Occasional		
23.13) Does this development application propose development heritage register or on a place entered in a local government's		in the Queensiand		
\square Yes – details of the heritage place are provided in the table because No	pelow			
Note: See guidance materials at www.des.gld.gov.au for information requireme	nts regarding development of Queensla	nd heritage places.		
	ce ID:	<u> </u>		
Brothels				
23.14) Does this development application involve a material ch	ange of use for a brothel?			
Yes – this development application demonstrates how the proposal meets the code for a development				
application for a brothel under Schedule 3 of the <i>Prostitution</i> No	Regulation 2014			
Decision under section 62 of the <i>Transport Infrastructure A</i>	ct 1994			
23.15) Does this development application involve new or change		road?		
Yes – this application will be taken to be an application for a				
Infrastructure Act 1994 (subject to the conditions in section 7 satisfied)				
Satisfied) ⊠ No				

Walkable neighbourhoods assessment benchmarks under Schedule 12A of the Planning Regulation 23.16) Does this development application involve reconfiguring a lot into 2 or more lots in certain residential zones (except rural residential zones), where at least one road is created or extended? ☐ Yes − Schedule 12A is applicable to the development application and the assessment benchmarks contained in schedule 12A have been considered ☐ No Note: See guidance materials at www.planning.dsdmip.gld.gov.au for further information.

PART 8 – CHECKLIST AND APPLICANT DECLARATION

24) Development application checklist	
I have identified the assessment manager in question 15 and all relevant referral requirement(s) in question 17 Note: See the Planning Regulation 2017 for referral requirements	⊠ Yes
If building work is associated with the proposed development, Parts 4 to 6 of <u>DA Form 2 – Building work details</u> have been completed and attached to this development application	☐ Yes☒ Not applicable
Supporting information addressing any applicable assessment benchmarks is with the development application Note: This is a mandatory requirement and includes any relevant templates under question 23, a planning report and any technical reports required by the relevant categorising instruments (e.g. local government planning schemes, State Planning Policy, State Development Assessment Provisions). For further information, see DAForms Guide: Planning Report Template .	⊠ Yes
Relevant plans of the development are attached to this development application Note: Relevant plans are required to be submitted for all aspects of this development application. For further information, see <u>DA Forms Guide: Relevant plans.</u>	⊠ Yes
The portable long service leave levy for QLeave has been paid, or will be paid before a development permit is issued (see 21)	☑ Yes☑ Not applicable
25) Applicant declaration	
By making this development application, I declare that all information in this development correct	application is true and
Where an email address is provided in Part 1 of this form, I consent to receive future electron the assessment manager and any referral agency for the development application was required or permitted pursuant to sections 11 and 12 of the <i>Electronic Transactions Actions</i>	here written information

Privacy – Personal information collected in this form will be used by the assessment manager and/or chosen assessment manager, any relevant referral agency and/or building certifier (including any professional advisers which may be engaged by those entities) while processing, assessing and deciding the development application. All information relating to this development application may be available for inspection and purchase, and/or published on the assessment manager's and/or referral agency's website.

Personal information will not be disclosed for a purpose unrelated to the *Planning Act 2016*, Planning Regulation 2017 and the DA Rules except where:

- such disclosure is in accordance with the provisions about public access to documents contained in the *Planning Act 2016* and the Planning Regulation 2017, and the access rules made under the *Planning Act 2016* and Planning Regulation 2017; or
- required by other legislation (including the Right to Information Act 2009); or

Note: It is unlawful to intentionally provide false or misleading information.

· otherwise required by law.

This information may be stored in relevant databases. The information collected will be retained as required by the *Public Records Act 2002.*

PART 9 – FOR COMPLETION OF THE ASSESSMENT MANAGER – FOR OFFICE USE ONLY

<u> </u>			
Date received:	Reference num	nber(s):	
Notification of engagement of	of alternative assessment ma	nager	
Prescribed assessment man	ager		
Name of chosen assessmen	t manager		
Date chosen assessment ma	anager engaged		
Contact number of chosen a	ssessment manager		
Relevant licence number(s)	of chosen assessment		
manager			
QLeave notification and pay	ment		
Note: For completion by assessmen	nt manager if applicable		
Description of the work			
QLeave project number			
Amount paid (\$)		Date paid (dd/mm/yy)	
Date receipted form sighted	by assessment manager		

Name of officer who sighted the form

Our Ref: 24003 OW Submission 12 and 14 Murphy Street

Friday, 3 May 2024

The Chief Executive Officer

Douglas Shire Council PO Box 723 MOSSMAN QLD 4873

Attention: Daniel Lamond

Dear Daniel.

OPERATIONAL WORKS SUBMISSION

MCU - DWELLING HOUSE (MCUC 2023_5563/1)

12 AND 14 MURPHY STREET, PORT DOUGLAS (L113 PTD2094 & L114 PTD2094)

We refer to Douglas Shire Council's (Council) Decision Notice MCUC 2023_5563/1 (DN) dated 24 April 2024 for 12 Murphy Street and MCUC 2022_4732/1 dated 7 October 2022. Applin Consulting has been engaged to document the civil Operational Works (OW) plans associated across both properties and to submit and compile a response to Council's conditions which are relevant to the shared driveway referenced in MCUC 2023_5563/1.

Attached for your information and action are the following:

- Compliance Assessment fees to be invoiced amounting to \$1,674.00 (agreed fee)
- Civil Construction Drawings: 12 Murphy St (1 x A3 PDF set: 24003-C001 (B) to C023 (B))
- Civil Construction Drawings: 14 Murphy Street (1 x A3 PDF set: 24004-C001 (A) to C011 (A))
- GEO design letter (Ref:22083AB-D-L03-v3)
- DA Form 1
- OPW Checklist
- Certified Statement of Compliances

Also find below our responses to the relevant conditions, which are repeated below in the order in which it appeared in the DN for MCUC 2023_5563/1.

Operational Works

3. The proposal triggers the need for an Operational Works Development Permit. The development application must include RPEQ certified 'for construction' plans for detailed design and the Operational Works application must be made over both 12 and 14 Murphy Street as one application.

Complied, See attached Civil construction drawings.

Internal Access Driveway

4. Prior to Works Acceptance, provide access to the development site generally in accordance with Applin Consulting drawings 24003-C003 (A), C004 (A), C005 (A) and to the requirement of the FNQROC Regional Development Manual.


Complied, See attached Civil construction drawings 24003-C003 (B) – C005 (B).


Shared Access Driveway

5. Amend the Shared Access Driveway to contain stormwater flows within the carriageway to Murphy Street. Unless otherwise agreed with Council, the shared access driveway must be amended to include:

a. Drainage kerb along the downslope edge of the carriageway from Chainage 10.0m to Chainage 69.478m in accordance with FNQROC Standard Drawing S1110;


The strip footing for the guardrail has been lifted to create a 125mm high barrier kerb along the downslope edge. Refer detail below from drawing 24003-C013 (B).

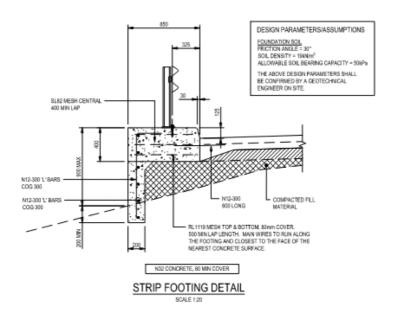

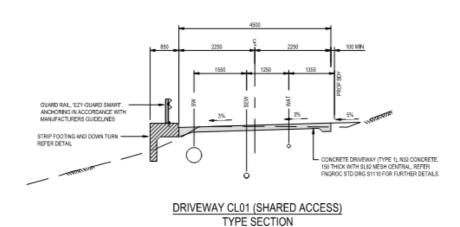

b. A concrete batter chute or inlet pit must also be provided at approximate Chainage 10 to direct stormwater from the driveway into the existing Murphy Street roadside drain;

Batter chute added. Refer detail below from drawing 24003-C018 (B).

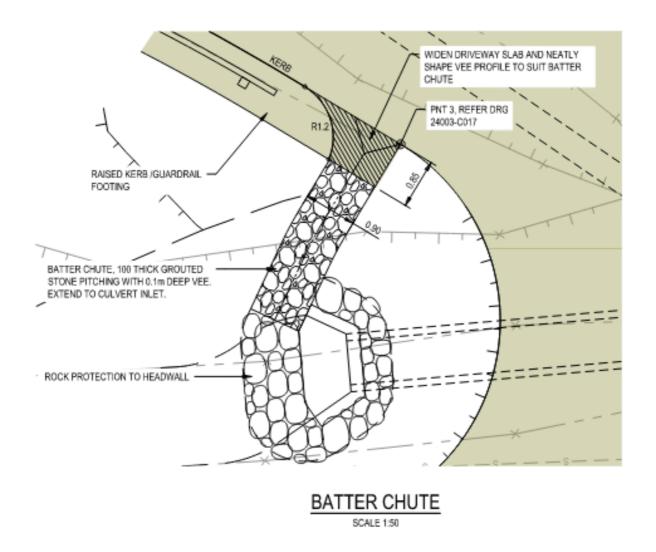

6. Revise the grade of the Shared Access Driveway to achieve a minimum grade of 0.3% between Chainage 40.0m to 64.444m to aid the conveyance of stormwater to Murphy Street. Amendment to the shared access driveway design must be provided to the satisfaction of the Chief Executive Officer prior to the issue of a Development Permit for Operational Works.

Complied, See attached Civil construction drawings 24003 C013 (B) – C016 (B).

7. Prior to Works Acceptance, construct a 4.5m wide sealed shared access driveway connecting from the Murphy Street Road carriageway to the property boundary generally in accordance with the location, alignment and grades detailed on Applin Consulting drawings 24003-C003 (A), C004 (A), C005 (A), except where amended by the conditions of this approval.

The shared driveway must include footings and earth retaining structures on the downslope side generally as detailed in Applin Consulting drawings 24003-C013 (A), C015 (A). Vehicle safety barriers as per the approved drawings must be constructed along the outer edge for the extent shown. The shared driveway must be constructed in accordance with Applin Consulting drawings and FNQROC Development Manual Standard Drawings S1015 and S1110 to the satisfaction of the Chief Executive Officer.

Advice Note: The water and sewer main augmentations in road reserve will be put on maintenance to become donated assets. The private driveway components of the design on road reserve, inclusive of drainage features will not become donated assets.

Complied. Guardrail has been extended for the entire length of the driveway.

8. Ownership, operation and maintenance of the private shared access driveway infrastructure will vest at all times with the Murphy Street property owners for which the infrastructure services.

Noted

Earthworks & Retaining Walls

9. Prior to Works Acceptance, construct the earthworks generally in accordance with Applin Consulting drawings 24003-C006 (A), and C007 (A). All earthworks must be in accordance with the FNQROC Development Manual to the satisfaction of the Chief Executive Officer.

Noted.

10. Prior to the issue of a Development Permit for Operational Works, provide a geotechnical report supporting the slope stability measures proposed for all temporary and permanent batters steeper than 1 in 2 or higher than 1.5 metres on the civil plans. The nominated slope stability measures must be endorsed by a suitably qualified and experienced RPEQ Geotechnical Engineer.

Complied, See attached Geotechnical Report 22083AB-D-L03-v3.

11. Prior to the pre-start meeting, all retaining walls or structures higher than 1 metre must be structurally certified by a suitably qualified RPEQ Structural Engineer. Where the profile or height of the wall is redesigned during structural certification, amended plan(s) must be endorsed by the Chief Executive Officer.

Noted.

Stormwater

12. Revise the proposed stormwater design to achieve compliance with the requirements of Queensland Urban Drainage Manual (QUDM). In particular, revise the pipe grade and stormwater velocities between structure 2/A and 4/A.

Advice Note: The Applicant may consider adopting a 375mm diameter pipe graded at 15% to achieve compliance with QUDM and limit the invert level depth increase required. 13. Prior to Works Acceptance, construct the stormwater generally in accordance with civil plans by Applin Consulting drawing, except as modified by the conditions of this approval, to the requirements of the FNQROC Development Manual and satisfaction of the Chief Executive Officer.

These grades were considered during design and an engineering-based decision was made to follow the driveway gradient due to the following reasons:

- In order to flatten the grade the drainage line would be deeper than 3m.
- The drainage line is essentially a privately owned roof water line.
- Constructability issues:
 - Trenches above 3m in depth require benching as per WPHS and the trench width at the top would end up as wide as the driveway.
 - A deep trench cut into the terraced batter would have the potential to make the lower side unstable.
- The stormwater pipes are PPE, therefore they are less prone then reinforced concrete pipes to erosion due to the higher velocities of the flows along the pipe invert.

Given the reasons above, we have not altered the design.

Water Supply

14. Prior to Works Acceptance, complete the water supply connections generally in accordance with Applin Consulting drawing 24003-C019 (A), to the requirements of the FNQROC Development Manual and satisfaction of the Chief Executive Officer.

Noted

Sewerage Reticulation

15. Prior to Works Acceptance, complete the sewerage reticulation connections generally in accordance with Applin Consulting drawings 24003-C020 (A) and C021 (A), to the requirements of the FNQROC Development Manual and satisfaction of the Chief Executive Officer.

Noted

Exterior Finishes

16. The exterior finishes and colours of the house must be non-reflective and must blend with the natural colours of the surrounding environment. Shades of white including Dulux Lexicon and Dulux Mt Aspiring are not approved for use. The exterior finishes must be provided to Council for endorsement by the Chief Executive Officer prior to the issue of a Development Permit for Building Work.

Noted

Damage to Council Infrastructure

17. In the event that any part of Council's existing sewer, water or road infrastructure is damaged as a result of construction activities occurring on the site, the applicant/owner must notify Council immediately of the affected infrastructure and have it replaced at no cost to Council.

Noted

Vehicle Parking

18. The amount of vehicle parking must be as specified in Council's Planning Scheme which is a minimum of two (2) spaces located on site. In addition, all parking, driveway and vehicular manoeuvring areas must be imperviously sealed and drained.

Provided in the house.

Storage of Machinery and Plant

19. The storage of any machinery, material and vehicles must not cause a nuisance to surrounding properties, to the satisfaction of the Chief Executive Officer.

Noted

Landscaping Plan

- 20. The site must be landscaped in accordance with details included on a landscaping plan. The plan must detail;
 - a. compliance with Planning Scheme Policy SC6.7 Landscaping;
 - b. fencing details;
 - c. a detailed species list;
 - d. pot sizes;
 - e. species with high screening qualities and planting regime to effectively screen the property from view from the house at 14 Murphy Street.

The landscaping plan must be endorsed by the Chief Executive Officer prior to building work commencing and landscaping must be implemented prior to commencement of use.

Noted, and not part of this application.

Ponding and/or Concentration of Stormwater

21. The proposed development is not to create ponding nuisances and/or concentration of stormwater flows to adjoining properties.

Noted.

Sediment and Erosion Control

22. All earthworks must be carried out in accordance with section CP1.13 and D5 of the FNQROC Development Manual and;

A copy of the contractors Erosion and Sediment Control Plan (ESCP) is to be submitted to Council prior to the issue of a Development Permit for Operational Work and;

Measures nominated in the ESCP must be implemented prior to commencement of any earthworks and;

The ESC Plan must address the Institution of Engineers' Australia Guidelines for Soil Erosion and Sediment Control and the Environment Protection (Water) Policy and Clauses CP1.06, CP1.13 and D5.10 of Council's FNQROC Development Manual.

Complies. See attached drawings 24003 - C022 (B) and C023 (B).

Bushfire Hazard

23. The house must be developed in accordance with AS3959- 2009.

Noted

We trust the above and attached is sufficient for Council's purposes and allows Council to finalise the Operational Works Approval for the civil plans submitted.

Please do not hesitate to contact the undersigned should you have any further questions in relation to this matter.

Yours faithfully
APPLIN CONSULTING

GREG APPLIN B Eng (Civil) RPEQ 6073



3 May 2024

GEO Ref: 22083AB-D-L03-v3

Your Ref: TBA

George Argyrou
Hickory Constructions Group
3/21 Constitution Hill Road
SORRENTO VIC 3943

and Neil Biddle 12 Murphy Street

PORT DOUGLAS QLD 4877

Transmission via email: g.argyrou@hickory.com.au

PROPOSED RESIDENTIAL DEVELOPMENTS 12 AND 14 MURPHY STREET, PORT DOUGLAS

REVIEW OF CURRENT DRAWINGS

Dear George/Neil,

GEO Design (GEO) has carried out a review of the provided updated civil drawings for the proposed residential developments at 12 and 14 Murphy Street, Port Douglas. The updated civil design and drawings were provided by Applin Consulting.

The drawings reviewed included Drawings 24003 C001(B) to C023(B) and 24004 C001(A) to C011(A) which form the final civil design package for the allotment and connections to the associated shared driveway section based on the finalised architectural design. The details of the shared driveway are presented in the civil drawings properad for 12 Murphy Street, Port Douglas. It is understood that civil construction works for both 12 and 14 Murphy Street will be carried out concurrently.

GEO Design has previously provided preliminary advice regarding temporary and permanent batter stabilisation works at the subject site. The preliminary advice included typical treatment types for various batters including shotcrete walls and reinforced retaining structures.

Based on our review of the provided drawings, it is considered that the proposed works are feasible from a geotechnical point of view and similar treatment options to those already provided would be adequate to achieve a Low level of risk in accordance with the Landslide Risk Management Concepts and Guidelines and to those outlined in the Australian Geoguide LR7 (Landslide Risk).

It is considered that the following treatments should be adopted.

- 1. Construction of a Geosynthetically Confined Soil (GCS) wall along the southwestern boundary of the proposed building platform and a portion of the driveway for 14 Murphy Street.
- 2. Construction of a shotcrete reinforced wall along the northeastern boundary of the building platform. The permanent shotcrete batter may include soil nails and other reinforcement. The temporary batter that will ultimately be covered by fill adjacent to the proposed building will generally comprise shotcrete surfacing only.

Where required, detailed design drawings would be developed for the slope retention schemes. The detailed designs would be carried out by GEO Design based on the current information and based on site inspections during construction. All civil works where new batters are to be formed will be carried out under the supervision and direction of a suitably qualified geotechnical engineer. All earthworks would be carried out under Level 1 supervision. Certification of the completed retention works and earthworks would be provided following completion of the works to the satisfaction of the supervising geotechnical engineer.

We would be pleased to answer any questions that you may have regarding this matter.

Yours sincerely,

Steve Ford

Principal Geotechnical Engineer

BSc (Geo) BSc (Geo) Hons MEngSc (Geotechnical) MMinEng (Geomechanics)

RPEQ 25762



Operational Works Receipting Checklist (To be completed by Consulting engineer making the application)

Name of Council: **Douglas Shire Council**

Development and Location: 12 and 14 Murphy Street, Port Douglas Name

MCUC 2023_5563/1 and Planning Permit No/Council File No: ··MUCU 2022_4732/1

<u>DESIGN SUBMISSION</u>	CHECK	<u>COMMENT</u>
Completed 'Statement of Compliance' form. (FNQROC - AP1 – Appendix A)	Υ	
IDAS Forms A ,E & IDAS Assessment Checklist (Available from www.ipa.qld.gov.au)	Y	IDAS Form 1 attached
Payment of Engineering Application Fees (Copy of receipt to be attached)	Υ	To be Paid
4. Copy of Decision Notice for Development Application Conditions, inc. explanation of how each condition is to be addressed (Statement of Compliance)	Y	
5. Engineering Design drawings - Complete sets (1 x A1 set, 2 x A3 sets and 1 x electronic copy on compact disc in 'PDF' format)	Y	
6. One copy of Design and Standard Specifications (Unbound Copy Preferable)	N	
7. Written consent from adjoining property owners authorising any works on their property	N/A	
8. Water reticulation network in electronic format (Engineer to confirm system requirements and compatibility with Cairns Water)	Y	
9. Landscape drawings - Complete set (1 x A1 set, 2 x A3 sets and 1 x electronic copy on compact disc in 'PDF' format). These must be accompanied by elements of the stormwater & street ltg. layout design, to avoid conflicts.	N	



Operational Works Receipting Checklist (To be completed by Consulting engineer making the application)

DESIGN SUBMISSION	CHECK	COMMENT
10. Overall network drawings (for staged development) for:	Y	
• Water	Y	
Stormwater	Y	
Sewer	Y	
Pathways and roads	Y	
Street Lighting	N/A	
Electrical	N	
• Gas	N/A	
Public Transport	N/A	
Park Reserves	N/A	
Drainage Reserves	N/A	
11. Pavement design criteria	N/A	
12. Geotechnical reports for proposed earthworks	Y	
13. Structural and geotechnical certificates for retaining walls etc.	N	
14. Water supply/sewerage pump station design parameters	N.A.	
15. Stormwater drainage calculations	N	
16. Erosion and Sediment Control Strategy (ESCS)	Y	
17. Declared Pest Management Plan (if applicable)	N.A.	
18. The approval of any other Authorities & concurrence agencies likely to be affected by the works.	N.A.	



Operational Works Receipting Checklist (To be completed by Consulting engineer making the application)

19. Contact details of the Consulting Engineer who is submitting the Application:

Name of Engineer	Gregory M Applin		
Name of Company	Applin Consulting Pty. Ltd.		
Telephone Number (s)	Office: Mobile: 0414 768 109		
Email address	greg@applinconsulting.com.au		
RPEQ No.	6073		

20. Date of submission of application / / 200

(For further information on all of the above refer to the FNQROC Development Manual Section AP1)

FNQROC DEVELOPMENT MANUAL

Council	Douglas Shire Council
	(INSERT COUNCIL NAME)

STATEMENT OF COMPLIANCE OPERATIONAL WORKS DESIGN

This form duly completed and signed by an authorised agent of the Designer shall be submitted with the Operational Works Application for Council Approval.

Name of De	evelopment 12 and 14 Murphy Streets
	Development 12 and 14 Murphy Street, Port Douglas
Applicant	Kim Cullen & Neil Biddle & George Argyrou
Designer	Applin Consulting

It is hereby certified that the Calculations, Drawings, Specifications and related documents submitted herewith have been prepared, checked and amended in accordance with the requirements of the FNQROC Development Manual and that the completed works comply with the requirements therein, **except** as noted below.


Compliance with the requirements of the Operational Works Design Guidelines	Non-Compliance refer to non-compliance report / drawing number		
Plan Presentation	Yes		
Geotechnical requirements	Yes		
Geometric Road Design	N/A		
Pavements	Yes		
Structures / Bridges	N/A		
Subsurface Drainage	N/A		
Stormwater Drainage	Yes		
Site Re-grading	N/A		
Erosion Control and Stormwater Management	Yes		
Pest Plant Management	N/A		
Cycleway / Pathways	N/A		

Landscaping	N/A
Water Source and Disinfection/Treatment Infrastructure (if applicable)	N/A
Water Reticulation, Pump Stations and water storages	Yes
Sewer Reticulation and Pump Stations	Yes
Electrical Reticulation and Street Lighting	N/A
Public Transport	N/A
Associated Documentation/ Specification	Yes
Priced Schedule of Quantities	No
Referral Agency Conditions	N/A
Supporting Information (AP1.08)	Yes
Other	

Conscientions behalf of:	ously believing the above statement	s to be true and c	correct, signed on	
	Applin Consulting		RPEQ No 6073	
	_{ull} Gregory M Applin			
	Clopp		Date 30/04/2024	

CULLEN-BIDDLE RESIDENCE

12 MURPHY STREET (LOT113 PTD2094), PORT DOUGLAS CIVIL WORKS

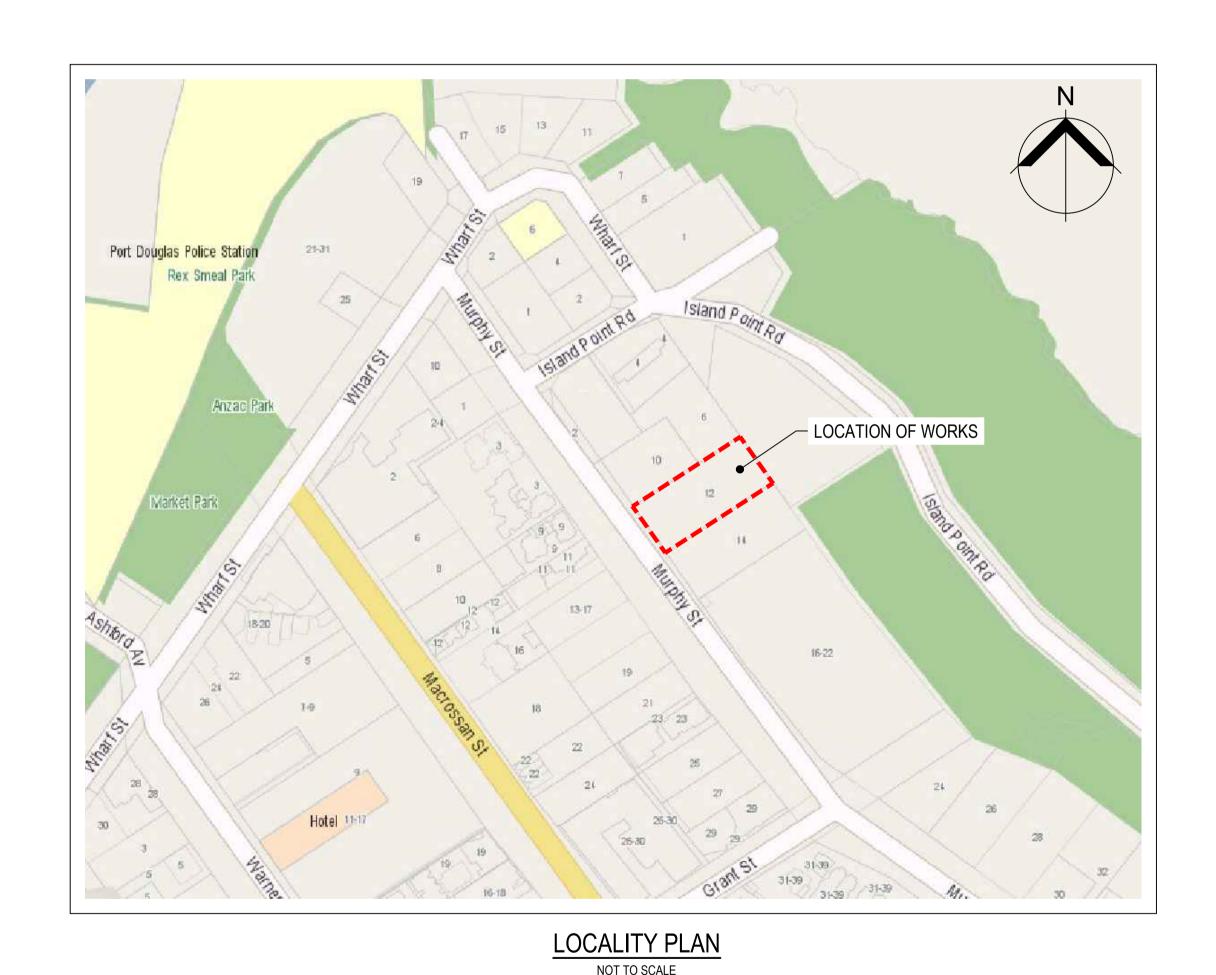

	DRAWING LIST				
DRG No.	DRAWING TITLE				
24003-C001	COVER SHEET, LOCALITY PLAN AND DRAWING INDEX				
24003-C002	STANDARD NOTES AND LEGEND				
24003-C003	OVERALL SITE PLAN				
24003-C004	GENERAL ARRANGEMENT PLAN - SHEET 1 OF 2				
24003-C005	GENERAL ARRANGEMENT PLAN - SHEET 2 OF 2				
24003-C006	BULK EARTHWORKS PLAN - SHEET 1 OF 3				
24003-C007-1	BULK EARTHWORKS PLAN - SHEET 2 OF 3				
24003-C007-2	BULK EARTHWORKS PLAN - SHEET 3 OF 3				
24003-C008-1	SITE SECTIONS AND DETAILS - SHEET 1 OF 2				
24003-C008-2	SITE SECTIONS AND DETAILS - SHEET 2 OF 2				
24003-C009	BATTER STABILISATION PLAN				
24003-C010	RETAINING WALLS - PLAN & SETOUT				
24003-C011	RETAINING WALLS - LONGITUDINAL SECTIONS				
24003-C012	STORMWATER LONGITUDINAL SECTIONS				
24003-C013	DRIVEWAY CL01 - LONGITUDINAL AND TYPE SECTION				
24003-C014	DRIVEWAY CL02 - LONGITUDINAL AND TYPE SECTION				
24003-C015	DRIVEWAY CL01 - CROSS SECTIONS				
24003-C016	DRIVEWAY CL02 - CROSS SECTIONS				
24003-C017	DRIVEWAY CONNECTIONS				
24003-C018	MISCELLANEOUS DETAILS				
24003-C019	WATER RETICULATION PLAN				
24003-C020	SEWER RETICULATION PLAN				
24003-C021	SEWER RETICULATION LONGITUDINAL SECTION AND DETAILS				
24003-C022	EROSION AND SEDIMENT CONTROL STRATEGY - PLAN				
24003-C023	EROSION AND SEDIMENT CONTROL STRATEGY - DETAILS				

B					SCALES		DESIGNED G. BROWNING	PROJECT CULLEN-BIDDLE RESIDENCE	FOR APPROVAL	
დ —	ISSUED FOR APPROVAL PRELIMINARY ISSUE	GB GA 0 GB GA 1	1/05/24 3/03/24	APPLIN ——— CONSULTING		KIM CULLEN & NEIL BIDDLE	DRAWN G. BROWNING	12 MURPHY STREET (LOT 113 PTD2094)	SCALE (AT FULL SIZE)	SIZE A1
CAD File: 2400	THIS DRAWING IS COPYRIGHT AND THE PROPERTY OF APPLIN CONSULTING. IT MUST ONLY BE USED BY THE NOMINATED CLIENT AND BY ANY PERSON WHO HAS BEEN AGREED TO BY APPLIN CONSULTING FOR THE PURPOSE FOR WHICH IT WAS PREPARED FOR.	DRN APP CERTIFICATION G. APPLIN	RPEQ 6073	M 0414 768 109 E greg@applinconsulting.com.au			CHECKED G. APPLIN	COVER SHEET, LOCALITY PLAN AND DRAWING INDEX	DRAWING NUMBER 24003-C001	REVISION

SURVEY CONTROL NOTES

SURVEY ORIGIN

LEVEL DATUM: ORIGIN OF LEVELS: PM 500028 RL 4.241 MERIDIAN: GDA94 ZONE 55 ORIGIN OF COORDINATES: PM 500028 E 335870.890 N 8177302.733

THE CONTRACTOR MUST LIAISE DIRECT WITH RPS SURVEYORS (PORT DOUGLAS) TO CONFIRM COORDINATES AND LEVELS OF SUITABLE SITE BENCHMARKS.

GENERAL NOTES

- DO NOT SCALE FROM THE PROJECT DRAWINGS.
- ALL LEVELS AND DIMENSIONS ARE IN METERS, UNLESS NOTED OTHERWISE.
- ALL WORKS MUST BE CARRIED OUT IN ACCORDANCE WITH THE RELEVANT FNQROC DEVELOPMENT MANUAL SPECIFICATIONS. WHERE DIFFERENCES EXIST BETWEEN THE PLANS AND THE DEVELOPMENT MANUAL, THESE PLANS SHALL TAKE PRECEDENCE.
- THE CONTRACTOR IS TO ENSURE A COPY OF THE OPERATIONAL WORKS APPROVAL IS AVAILABLE ON SITE. THE SITE FOREMAN IS TO ENSURE ALL WORKS ARE UNDERTAKEN IN ACCORDANCE WITH THE APPROVAL.
- THE LOCATIONS OF UNDERGROUND SERVICES HAVE BEEN APPROXIMATED FROM THE KNOWN POSITIONS OF VALVES, MANHOLES, ETC. PRIOR TO ANY DEMOLITION, EXCAVATION OR CONSTRUCTION ON SITE, THE CONTRACTOR MUST CONTACT RELEVANT AUTHORITIES FOR POSSIBLE LOCATION OF FURTHER SERVICES AND DETAILED LOCATIONS OF ALL SERVICES.
- EXISTING SERVICES ARE TO BE PROTECTED FROM DAMAGE DURING CONSTRUCTION. WHERE NECESSARY THE CONTRACTOR SHALL CONFIRM THE DEPTH TO EXISTING SERVICES BY POTHOLING BEFORE COMMENCING WORKS THE SUPERINTENDENT SHALL BE CONSULTED WHERE THE CONTRACTOR CONSIDERS SPECIFIC PROTECTION WORKS NECESSARY TO PROTECT THE SERVICE.
- WHERE REFERENCE IS MADE TO THE STANDARD DRAWINGS, THE CONTRACTOR SHALL ENSURE THAT THE LATEST VERSION ISSUED BY THE RELEVANT AUTHORITY, AT THE TIME OF CONSTRUCTION, IS USED.

EROSION AND SEDIMENT CONTROL NOTES

- PRIOR TO CONSTRUCTION COMMENCING, THE CONTRACTOR MUST PREPARE AN EROSION & SEDIMENT CONTROL PLAN (ESCP) TO MANAGE THE SITE DURING CONSTRUCTION AND THE DEFECT LIABILITY PERIOD.
- THE ESCP MUST BE CONSISTENT WITH THE APPROVED EROSION & SEDIMENT CONTROL STRATEGY (ESCS) AND SHALL TAKE INTO CONSIDERATION THE CONTRACTOR'S PROPOSED CONSTRUCTION METHODOLOGY AND PROGRAM. THE DEVICES/MEASURES SHOWN ON THE ESCS PLAN ARE MINIMUM RECOMMENDATIONS.
- AN ESCP THAT DIFFERS TO THE APPROVED ESCS MUST BE SUBMITTED TO THE SUPERINTENDENT FOR APPROVAL PRIOR TO SUBMITTING TO COUNCIL.
- NO EARTHWORKS SHALL COMMENCE ON ANY PART OF THE SITE PRIOR TO APPROPRIATE EROSION AND SEDIMENT CONTROL MEASURES BEING INSTALLED DOWNSTREAM OF THE SITE AND IN ACCORDANCE WITH THE APPROVED
- THE CONTRACTOR SHALL AT ALL TIMES MONITOR THE PREVAILING WEATHER CONDITIONS AND TAKE ALL NECESSARY PRECAUTIONS TO CONTROL EROSION AND DOWNSTREAM SEDIMENTATION DURING ALL STAGES OF CONSTRUCTION.
- THE IMPACT ON THE ENVIRONMENT SHALL BE MINIMISED BY OBSERVING THE FOLLOWING CONSTRUCTION
 - PRACTICES: AREAS DISTURBED BY CONSTRUCTION TRAFFIC AND PROCEDURES SHALL BE MINIMISED.
 - MINIMISE TRAFFIC MOVEMENTS AND SPEEDS ON EXPOSED SURFACES.
 - REVEGETATION OF DISTURBED AREAS SHALL BE CARRIED OUT SOON AFTER THE COMPLETION OF TOPSOIL PLACEMENT.
 - FLOW DIVERSION SHALL BE CARRIED OUT BY EARLY INSTALLATION OF DRAINS ALONG TOPS OF BATTERS WITH APPROPRIATE SILTATION CONTROL DEVICES.
 - SEDIMENT INTERCEPTION BY THE PLACEMENT OF SUITABLE RETENTION SYSTEMS ACROSS DRAINAGE
 - LINES AND AT INTERCEPTION POINTS FOR BOTH THE CONSTRUCTION AND STOCKPILE AREAS.
- ALL ACCESS TO AND FROM THE SITE SHALL BE VIA A TEMPORARY CONSTRUCTION ENTRY/EXIT. THE CONTRACTOR SHALL NOMINATE A PROPOSED ACCESS LOCATION ON THE ESC PLAN FOR APPROVAL BY THE SUPERINTENDENT.
- STOCKPILES SHALL ONLY BE LOCATED IN AREAS NOMINATED ON THE PROJECT DRAWINGS OR APPROVED BY THE SUPERINTENDENT. ALL STOCKPILES MUST HAVE APPROPRIATE ESC MEASURES INSTALLED TO PREVENT SEDIMENT TRANSPORT. THE MAXIMUM HEIGHT OF ALL STOCKPILES MUST BE LIMITED TO 2.0m
- ALL PERMANENT AND TEMPORARY UNLINED SWALES AND DRAINS MUST HAVE APPROPRIATE TEMPORARY **EROSION PROTECTION.**
- 10. ALL PARTIALLY CONSTRUCTED DRAINAGE STRUCTURES MUST BE PROTECTED AGAINST SEDIMENT INFILTRATION DURING CONSTRUCTION.
- 11. ALL COMPLETED DRAINAGE STRUCTURES MUST BE PROTECTED AGAINST SEDIMENT INFILTRATION UNTIL GRASSING IS ESTABLISHED.
- 12. THE CONTRACTOR IS RESPONSIBLE FOR THE CONTROL OF DUST EMANATING FROM THE SITE AT ALL TIMES FOR THE DURATION OF CONSTRUCTION. WET SUPPRESSION METHODS TO BE USED.
- 13. ALL EROSION AND SEDIMENT CONTROL MEASURES MUST BE CHECKED FOR DAMAGE, CLEANED OUT AND FULLY REINSTATED AFTER EACH RAINFALL EVENT RESULTING IN RUNOFF.
- 14. IF EROSION AND SEDIMENT CONTROL DEVICES HAVE BEEN FOUND TO BE DEFICIENT OR FAILED IN SERVICE, DUE TO UNFORESEEN CIRCUMSTANCES, CORRECTIVE ACTION IS TO BE UNDERTAKEN IMMEDIATELY WHICH MAY INCLUDE AMENDMENTS/ADDITIONS TO THE ORIGINAL APPROVED EROSION CONTROL PLANS.
- THE INSTALLATION, REMOVAL, RELOCATION OR MODIFICATION TO EROSION AND SEDIMENT CONTROL DEVICES MAY BE MADE BY COUNCIL IF DEEMED NECESSARY AND RELEVANT.
- EROSION AND SEDIMENT CONTROL DEVICES SHALL REMAIN IN PLACE UNTIL THE TREATMENT AREA IS SUITABLY STABILISED/VEGETATED.

EARTHWORKS NOTES

- ALL EARTHWORKS MUST BE CARRIED OUT IN ACCORDANCE WITH THE CURRENT FNQROC DEVELOPMENT MANUAL SPECIFICATION - S1 'EARTHWORKS'.
- FNQROC SPECIFICALLY REFERENCES AS3798 'GUIDELINES ON EARTHWORKS FOR COMMERCIAL AND RESIDENTIAL DEVELOPMENTS' IN RELATION TO ALL EARTHWORKS INCLUDING APPROPRATE METHODS OF TESTING, FREQUENCY OF TESTING AND REPORTING PROCEDURES. GEOTECHNICAL TESTING SERVICES SHALL BE AS DETERMINED BY LEVEL 1 IN ACCORDANCE WITH AS 3798. ALL CERTIFICATION AND TEST RESULTS ARE TO BE COMPILED AND PROVIDED TO THE SUPERINTENDENT PRIOR TO WORKS ACCEPTANCE.
- DRY DENSITY RATIO AS REFERRED TO IN THESE NOTES IS THE RATIO DETERMINED IN ACCORDANCE WITH AS1289.5.4.1 OF COMPACTED DRY DENSITY IN ACCORDANCE WITH AS1289.5.3.1 OR AS1289.5.8.1 TO THE STANDARD MAXIMUM DRY DENSITY DETERMINED IN ACCORDANCE WITH AS1259.5.1.11 (STANDARD COMPACTION).
- ALL BATTERS, TEMPORARY OR PERMANENT, STEEPER THAN 1H:4V OR HIGHER THAN 1.5m MUST BE INSPECTED WITHIN 24HRS OF EXCAVATION AND CERTIFIED BY AN RPEQ GEOTECHNICAL ENGINEER TO CONFIRM THEIR SHORT TERM AND LONG TERM STABILITIES.
- FINISHED SURFACE LEVELS SHOWN ON PROJECT DRAWINGS ARE AFTER ALL EARTHWORKS ARE COMPLETE INCLUDING TOPSOILING. ALL AREAS ARE TO BE GRADED EVENLY BETWEEN FINISHED SURFACE LEVELS UNLESS NOTED OTHERWISE.
- NO VEGETATION SHALL BE REMOVED WITHOUT PRIOR APPROVAL OF THE SUPERINTENDENT UNLESS NOTED ON THE PROJECT DRAWINGS.
- ALL VEGETAL MATTER, TOPSOIL AND OTHER UNSUITABLE MATERIAL SHALL BE STRIPPED/REMOVED FROM AREAS TO BE EXCAVATED OR FILLED. ALL VEGETAL MATTER AND UNSUITABLE MATERIAL SHALL BE DISPOSE OF OFF-SITE UNLESS ADVISED OTHERWISE BY THE SUPERINTENDENT. TOPSOIL SHALL BE STOCKPILED ON-SITE FOR REUSE. SURPLUS TOPSOIL SHALL BE DISPOSED OF OFF-SITE.
- SHOULD ANY SOFT OR UNSUITABLE MATERIAL BE IDENTIFIED, THE CONTRACTOR SHALL INFORM THE SUPERINTENDENT IMMEDIATELY AND SEEK THE ADVICE OF THE SUPERINTENDENT OR GITA.
- COMPACT FILL TO 95% DRY DENSITY RATIO IN LAYERS OF THICKNESS APPROPRIATE TO THE COMPACTION PLANT EMPLOYED BUT NOT EXCEEDING 300mm.
- 10. AL DISTURBED AREAS SHALL BE GRASS SEEDED, HYDROMULCHED OR LANDSCAPED. DISTURBED AREAS WITHIN THE ROAD RESERVE SHALL APPROPRIATELY TREATED TO COUNCILS SATISFACTION.

CONCRETE NOTES

ALL CONCRETE WORKS (INCLUDING THE SUPPLY, PALCEMENT, COMPACTION, REINFORCEMENT AND FINISHING) SHALL BE CARRIED OUT IN ACCORDANCE WITH THE CURRENT FNQROC DEVELOPMENT MANUAL SPECIFICATION -S7 'CONCRETE WORKS'.

DRAINAGE NOTES

- ALL STORMWATER DRAINAGE WORKS SHALL BE CARRIED OUT IN ACCORDANCE WITH THE CURRENT FNQROC DEVELOPMENT MANUAL SPECIFICATION - S4 'STORMWATER DRAINAGE'.
- POLYPROPYLENE PIPES SHALL BE CLASS SN8, UNLESS NOTED OTHERWISE
- INSTALLATION OF POLYPROPYLENE AND PVC PIPES SHALL BE CARRIED OUT IN ACCORDANCE WITH AS 2566 AND MANUFACTURERS SPECIFICATIONS.
- ALTERNATIVE PIPE MATERIALS TO THOSE SPECIFIED MAY BE USED, SUBJECT TO COUNCIL APPROVAL.
- BASE SLABS FOR BOX CULVERTS SHALL BE CAST-IN-SITU IN ACCORDANCE WITH DTMR STD DRG S1260.
- EXCAVATION, BEDDING AND BACKFILL FOR BOX CULVERTS SHALL BE CARRIED OUT IN ACCORDANCE WITH FNQROC STANDARD DRAWING S1045.
- ALL PIPES TO BE LAID AT 1% MINIMUM GRADE, UNLESS NOTED OTHERWISE.

WATER RETICULATION NOTES

- ALL WATER RETICULATION WORKS SHALL BE CARRIED OUT IN ACCORDANCE WITH THE CURRENT FNQROC DEVELOPMENT MANUAL SPECIFICATION - S5 'WATER RETICULATION'.
- ALL PVC AND PE PIPES SHALL BE CLASS PN16. PVC PIPES SHALL BE RUBBER RING JOINTED AND DUCTILE IRON COMPATIBLE.
- DICL PIPES SHALL BE CLASS PN35 "TYTON" TYPE RUBBER RING JOINTED.
- FOR MAIN TRENCHING, BEDDING & ANCHORAGE DETAILS REFER FNQROC STD DRAWINGS S2015 & S2016. ENSURE COVER TO WATER MAINS IS 800mm MINIMUM UNDER MURPHY STREET AND 600mm MINIMUM ELSEWHERE. WHERE MINIMUM COVER CANNOT BE ACHIEVED, DICL PIPEWORK SHALL BE PROVIDED AS WELL AS CONCRETE ENCASEMENT.
- FOR MAIN CONNECTION DETAILS, REFER FNQROC STD DRAWING S2020.
- COUNCIL MUST BE CONTACTED TO PERFORM ANY DIRECT CONNECTION OR ALTERATION TO LIVE WATER MAINS. THE CONTRACTOR SHALL LODGE WITH COUNCIL THE APPROPRIATE APPLICATION FORMS AND FEES FOR THESE WORKS TO BE COMPLETED. IT MAY BE POSSIBLE FOR SOME WORKS TO BE PERFORMED BY THE CONTRACTOR UNDER SPECIAL CIRCUMSTANCES AND SUBJECT TO APPROPRIATE CONDITIONS AGREED TO WITH COUNCIL.
- ALL HYDRANTS AND VALVES TO BE LOCATED OPPOSITE PROPERTY BOUNDARY TRUNCATIONS AND CORNERS, UNLESS NOTED OTHERWISE ON PLANS. FOR VALVES & HYDRANT BOXES INSTALLATION DETAILS REFER FNQROC STD DRAWINGS S2000 & S2005.
- HYDRANTS OR VALVES CONSTRUCTED IN CONCRETE ARE TO HAVE A COMPRESSIBLE LAYER (ABLEFLEX) INSTALLED ON THE SURROUND. REFER FNQROC STD DRG 2000.


SCALES

KERB MARKER PLATES SHALL BE PROVIDED TO IDENTIFY THE POSITION OF ALL VALVES AND HYDRANTS IN ACCORDANCE WITH FNQROC STD DRAWING S2010. IN ADDITION TO KERB MARKER PLATES, HYDRANTS SHALL ALSO HAVE TEARDROP MARKERS AND BLUE RETRO-REFLECTIVE MARKERS PROVIDED ON THE ROAD PAVEMENT IN ACCORDANCE WITH FNQROC STD DRAWING 2005.

SEWER RETICULATION NOTES

- ALL SEWER RETICULATION WORKS SHALL BE CARRIED OUT IN ACCORDANCE WITH THE CURRENT FNQROC DEVELOPMENT MANUAL SPECIFICATION - S6 'SEWERAGE RETICULATION'.
- ALL NEW SEWER MAINS SHALL BE UNPLASTICISED PVC (PVC-U) CLASS SN8 SUITABLE FOR RUBBER RING JOINTS, UNLESS NOTED OTHERWISE. WHERE SPECIFIED, DICL MAINS SHALL BE CLASS PN35.
- ALL NEW SEWER MAINS AND MANHOLES TO BE CONSTRUCTED IN ACCORDANCE WITH FNQROC STD DRAWINGS 3000 AND S3015.
- ALL SEWER MANHOLE COVERS SHALL BE CIRCULAR UNLESS NOTED OTHERWISE ON SEWER LONG SECTIONS. COVERS SHALL BE TYPE B INSIDE PROPERTIES AND TYPE C ELSEWHERE. RECTANGULAR COVERS SHALL BE PROVIDED ON MANHOLES LESS THAN 1.55m DEEP.
- ALL SEWER MANHOLE COVER LEVELS TO BE 50mm ABOVE FINISHED SURFACE LEVEL UNLESS WHERE LOCATED WITHIN A ROADWAY OR PATH WHERE THEY SHALL BE FLUSH WITH THE SURROUNDING SURFACE.
- THE CONTRACTOR SHALL ENSURE THAT A FLAT AREA OF 1.5m RADIUS FROM THE CENTRE OF THE MANHOLE IS PROVIDED AROUND ALL MANHOLES.
- ALL PROPERTY CONNECTION BRANCHES TO NEW SEWER MAINS TO BE CONSTRUCTED IN ACCORDANCE WITH FNQROC STD DRAWING S3005. BRANCHES SHALL BE CLEARLY MARKED IN ACCORDANCE WITH THE SPECIFICATION.
- COUNCIL MUST BE CONTACTED TO PERFORM ANY DIRECT CONNECTION TO LIVE SEWER MAINS. THE CONTRACTOR SHALL LODGE WITH COUNCIL THE APPROPRIATE APPLICATION FORMS AND FEES FOR THESE WORKS TO BE COMPLETED. IT MAY BE POSSIBLE FOR SOME WORKS TO BE PERFORMED BY THE CONTRACTOR UNDER SPECIAL CIRCUMSTANCES AND SUBJECT TO APPROPRIATE CONDITIONS AGREED TO WITH COUNCIL.
- THE CONTRACTOR SHALL CARRY OUT A CCTV INSPECTION THROUGH ALL SEWERS CONSTRUCTED AS PART OF THIS DEVELOPMENT AND PROVIDE THE FOOTAGE TO THE SUPERINTENDENT FOR ASSESSMENT. ANY SECTIONS OF SEWER CONSIDERED SUB-STANDARD SHALL BE RECTIFIED TO THE SATISFACTION OF COUNCIL.



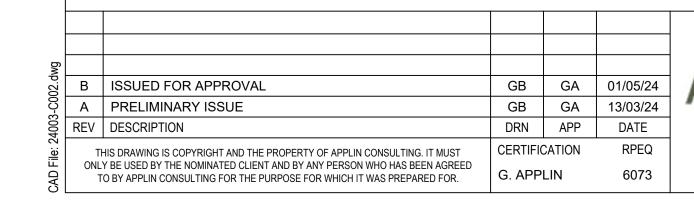

APPLIN ——— CONSULTING

M 0414 768 109 | E greg@applinconsulting.com.au

KIM CULLEN & NEIL BIDDLE

CLIENT

DESIGNED G. BROWNING G. BROWNING CHECKED


G. APPLIN


CULLEN-BIDDLE RESIDENCE 12 MURPHY STREET (LOT 113 PTD2094)


STANDARD NOTES AND LEGEND

SCALE (AT FULL SIZE)

FOR APPROVAL SIZE **A**1 REVISION 24003-C002 B

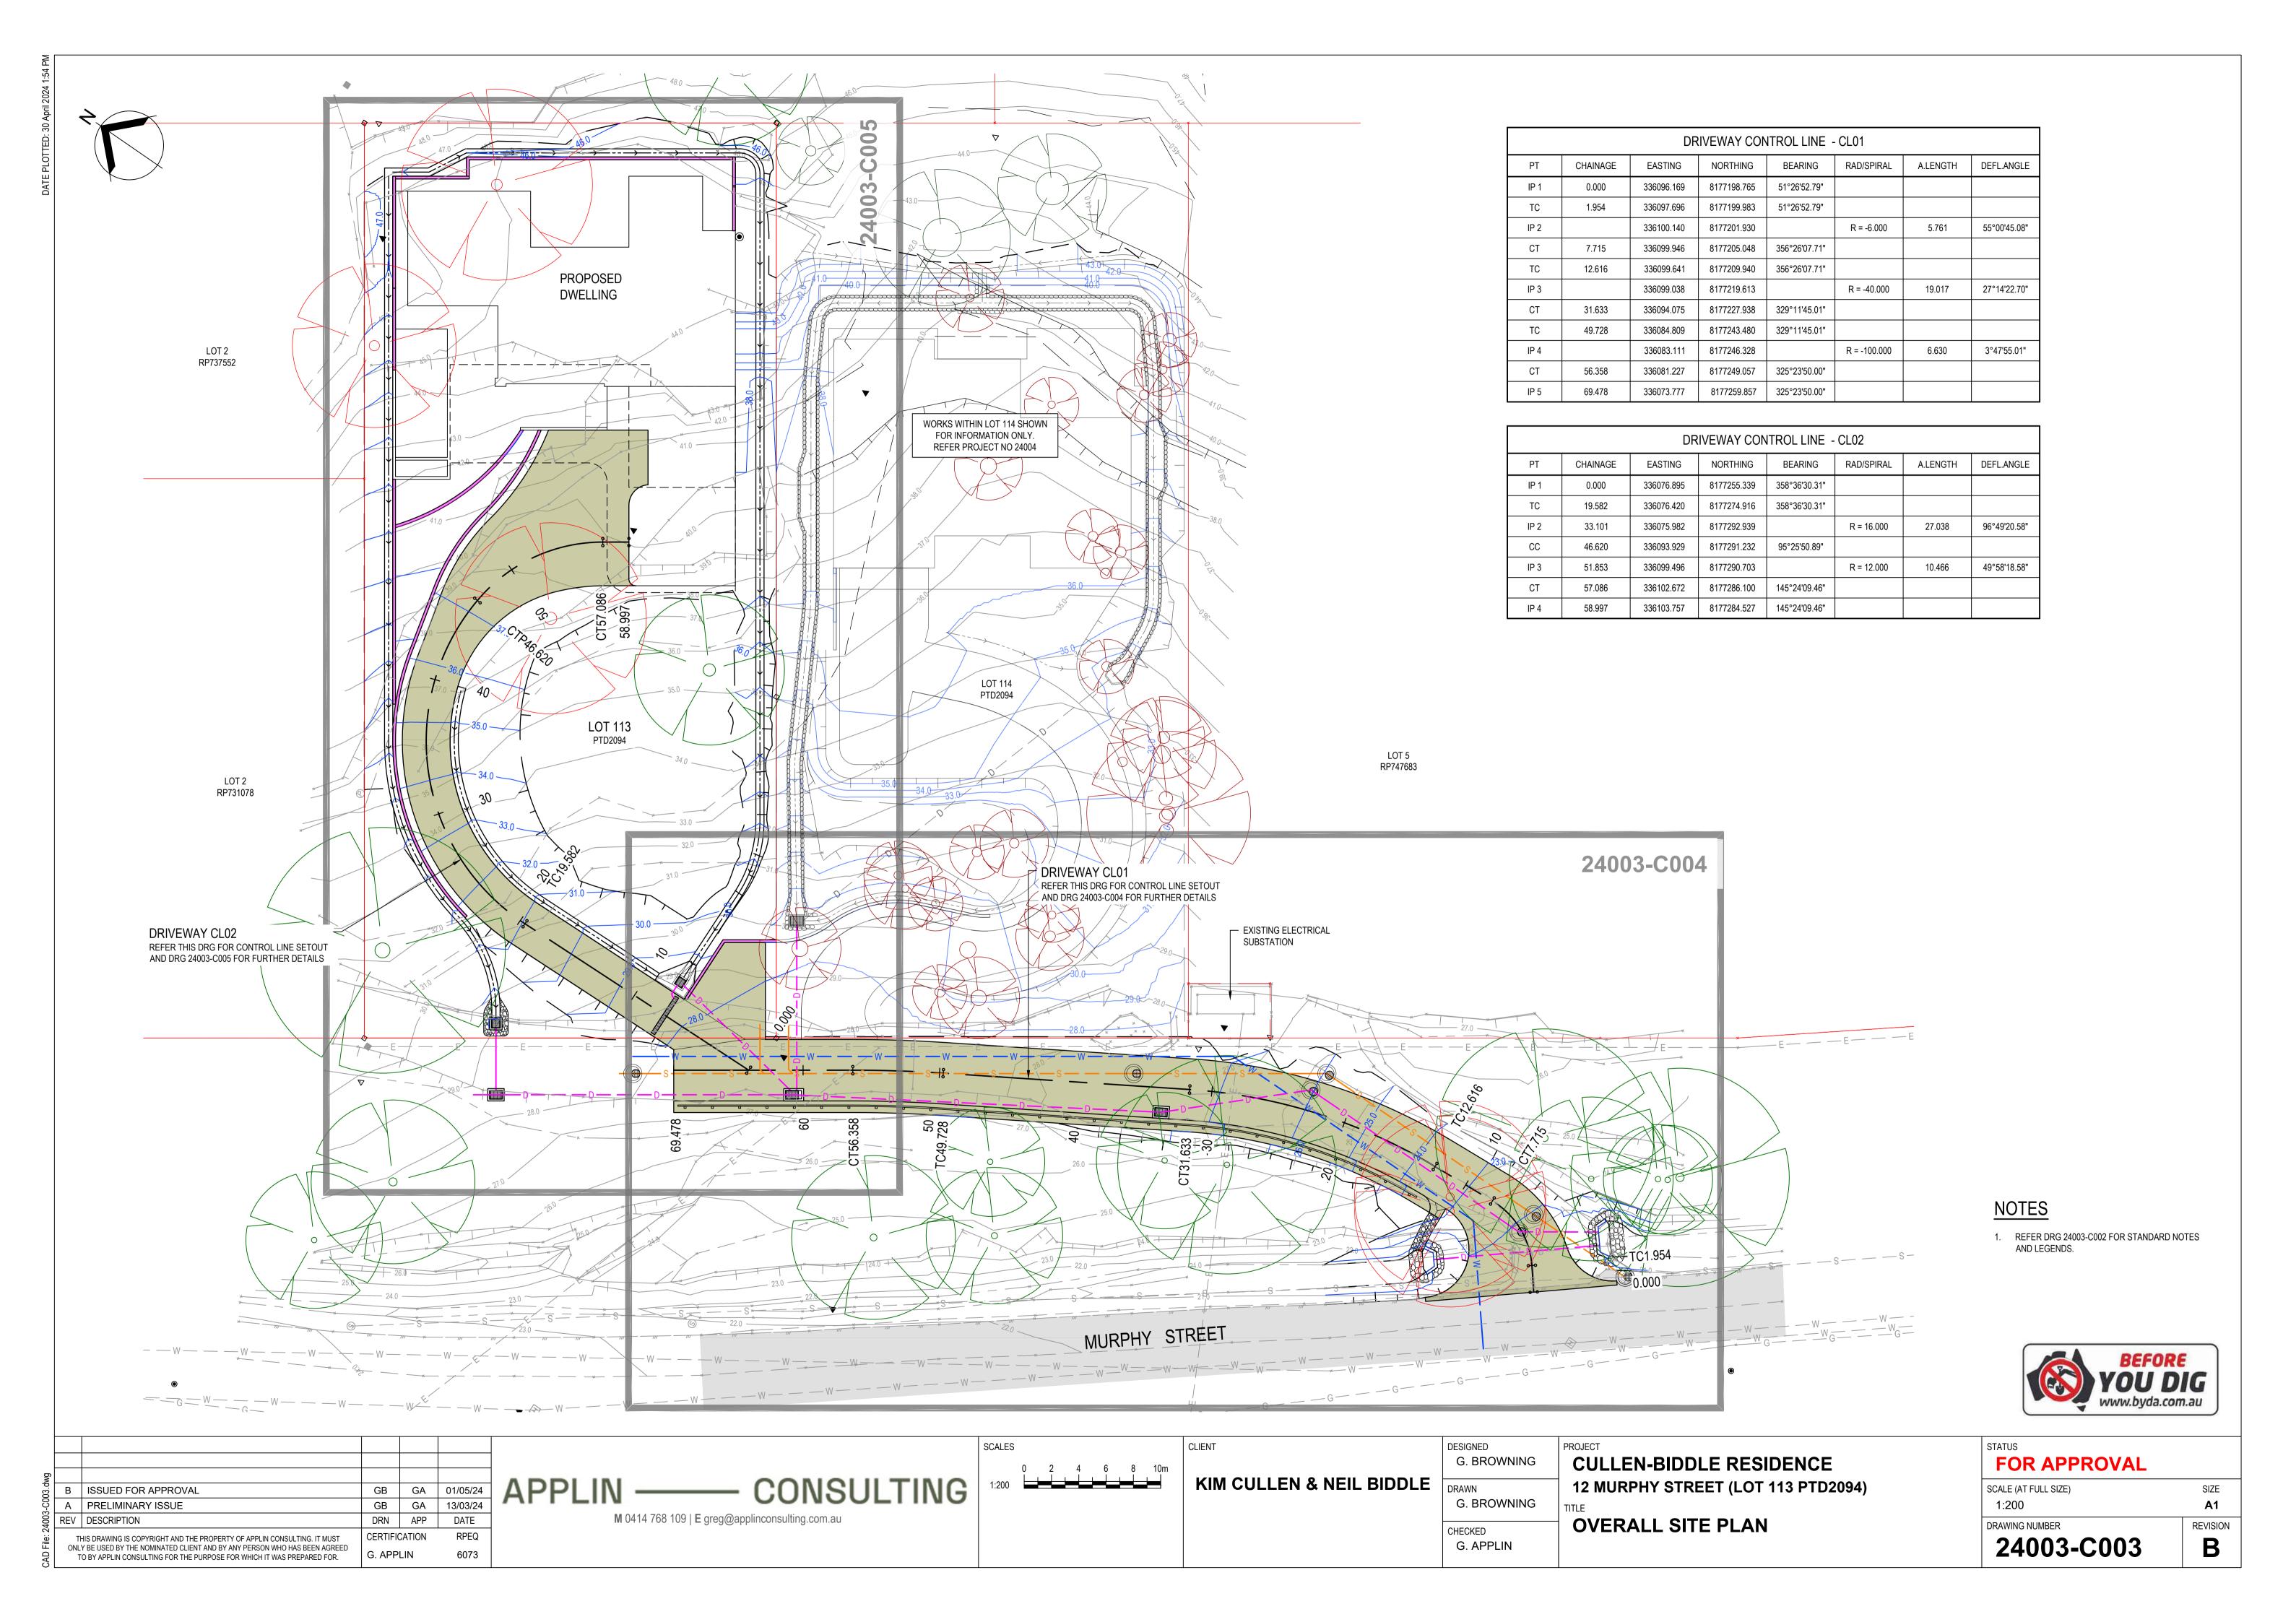

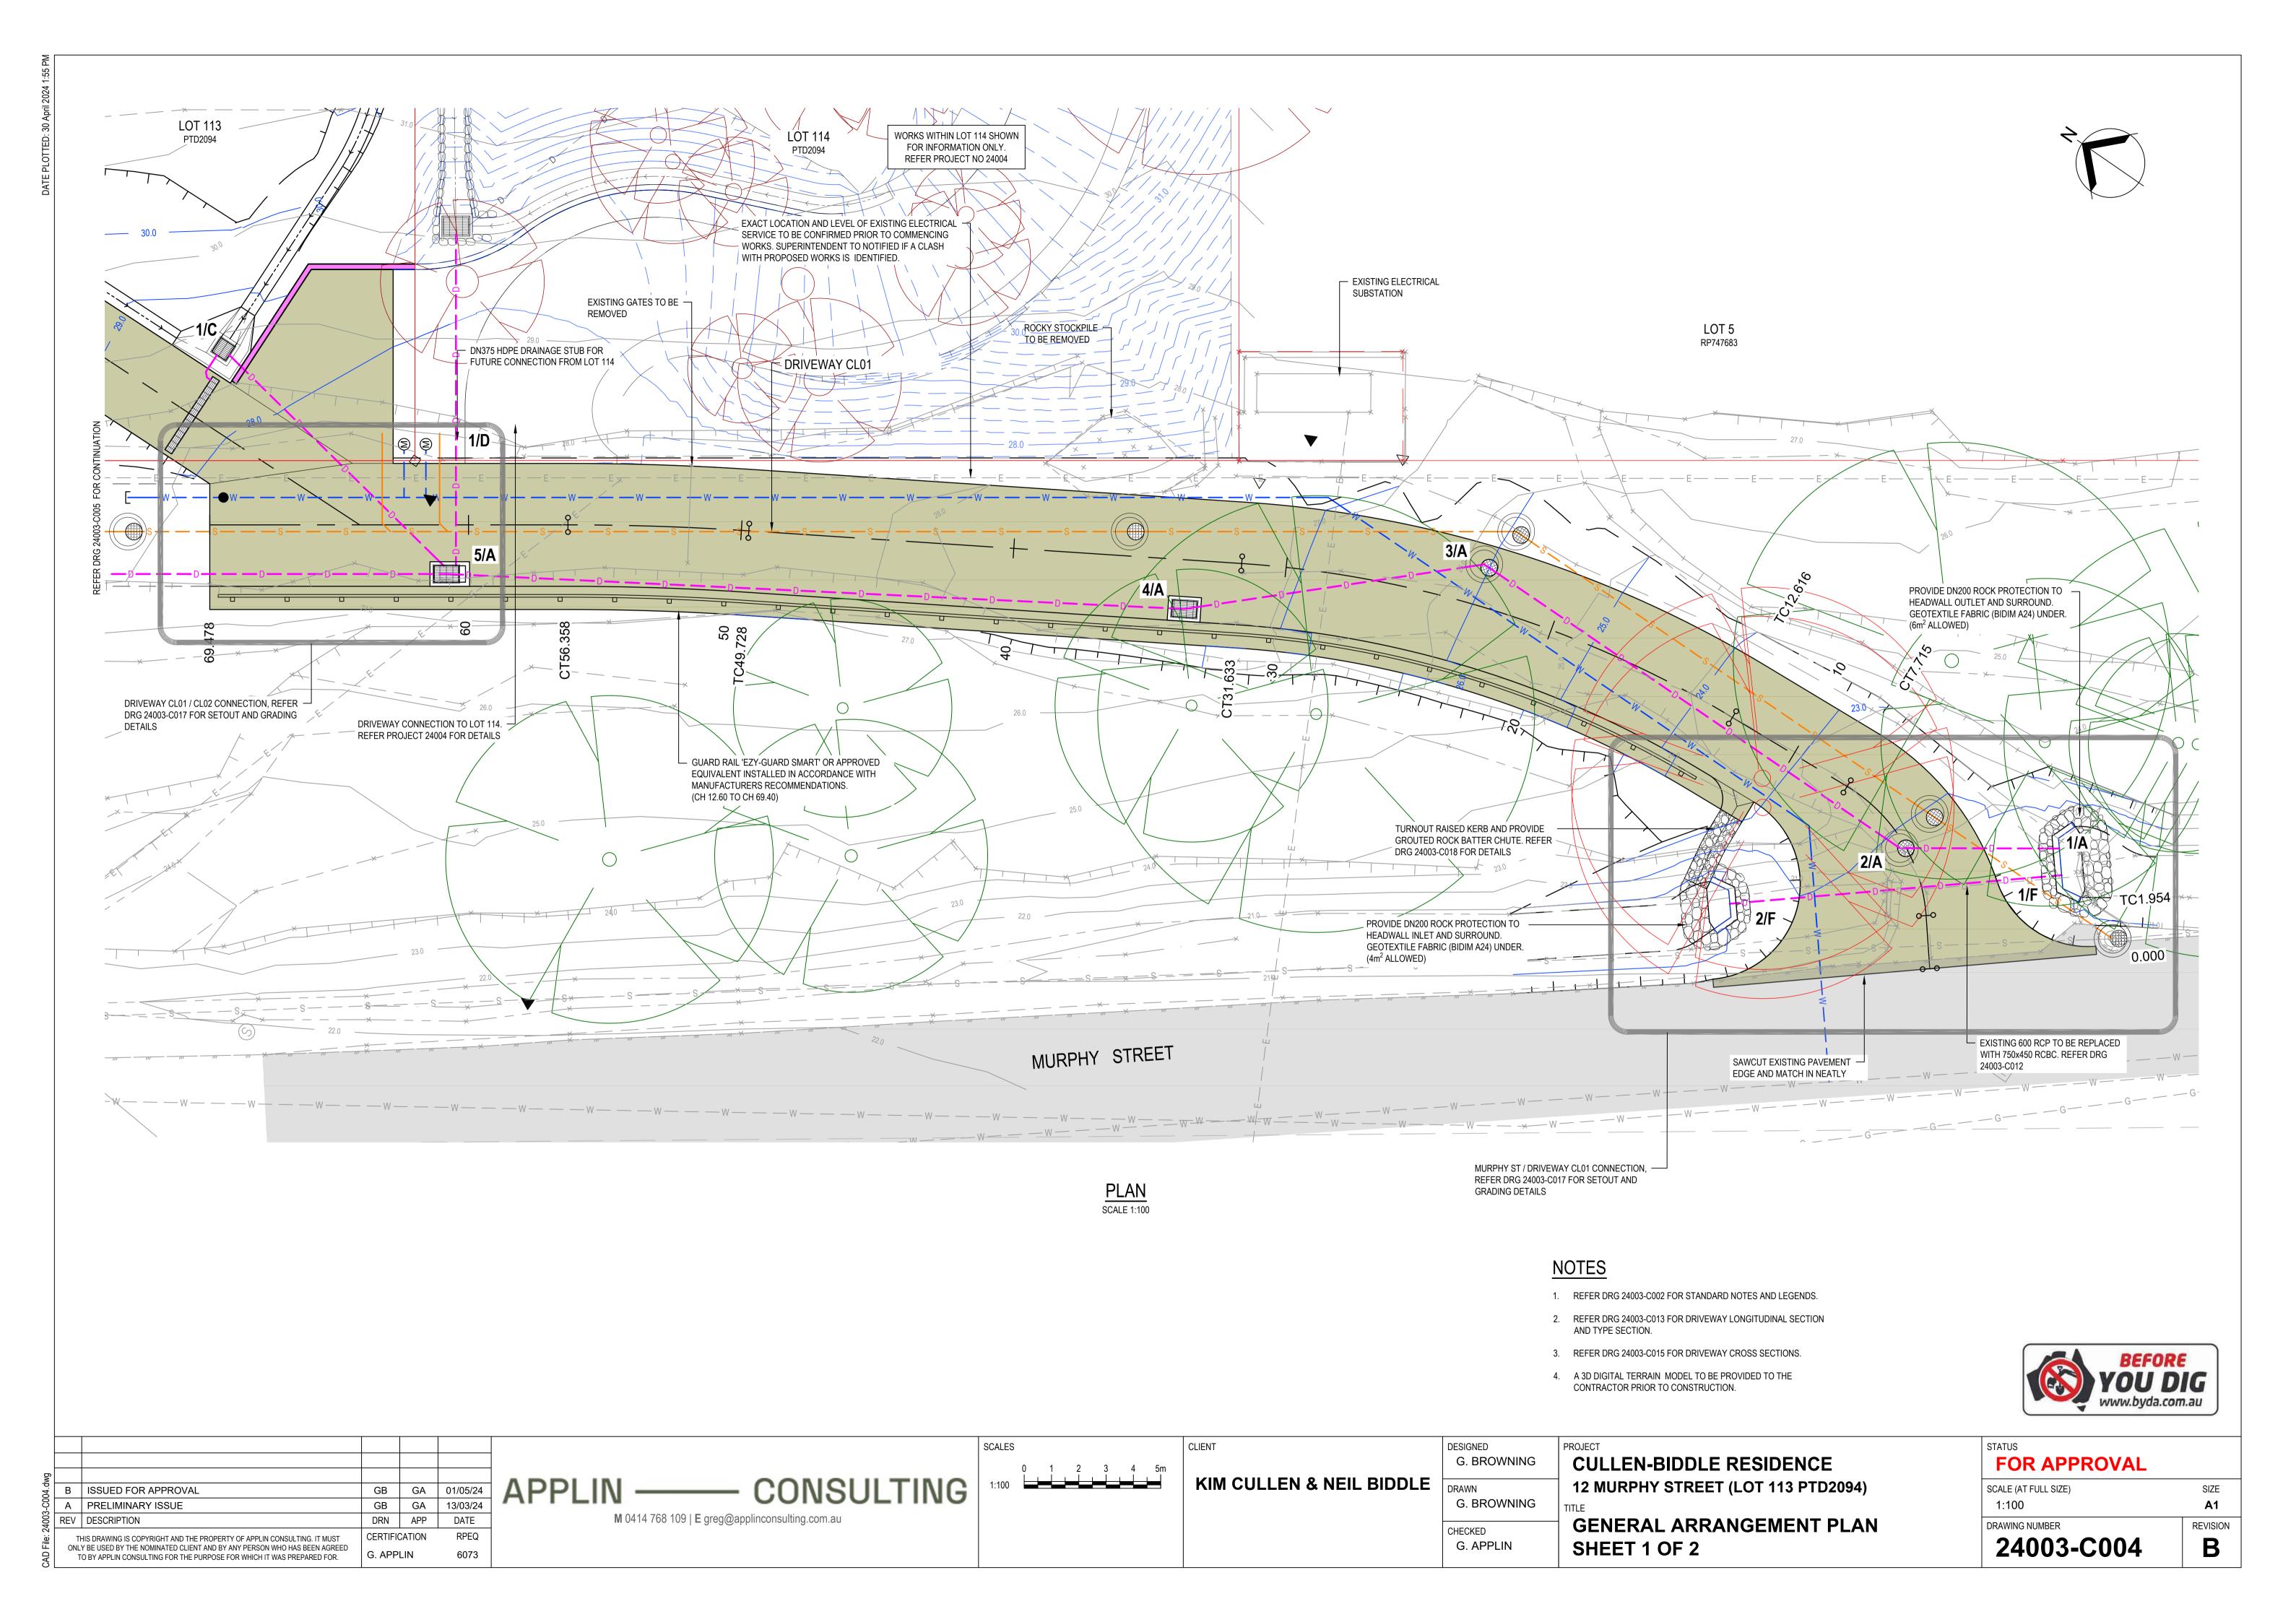

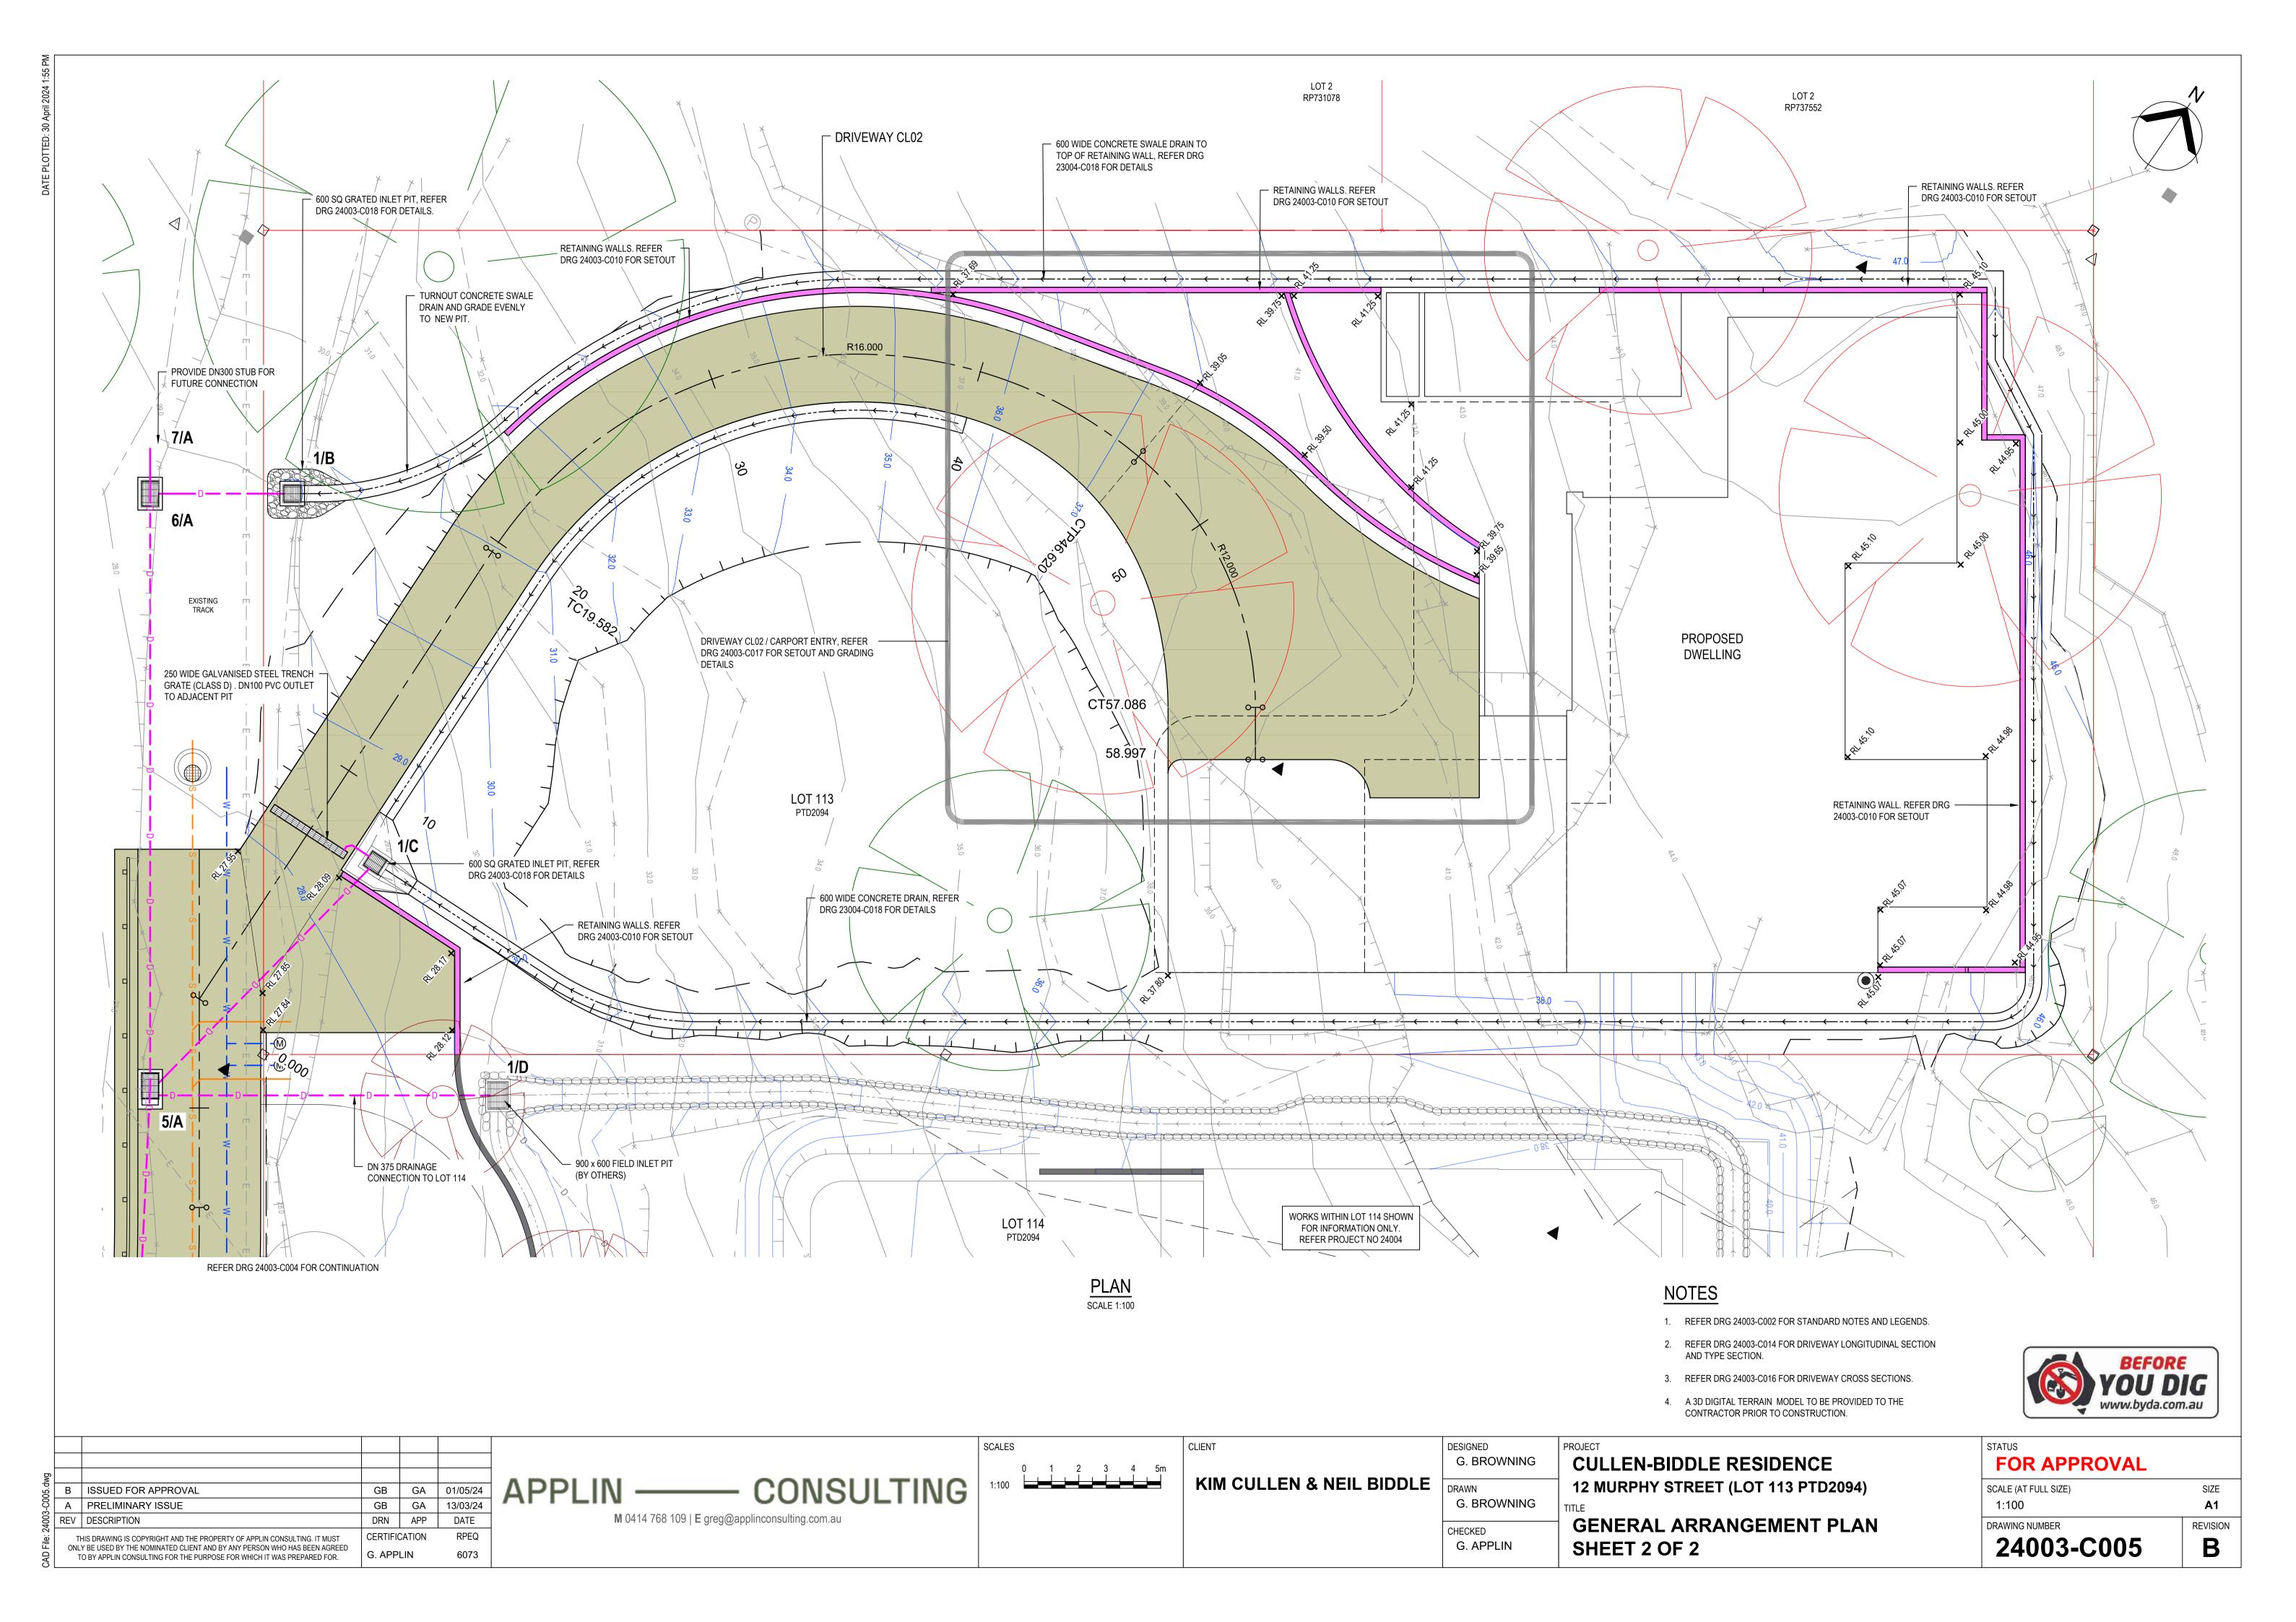



ESTIMATED EARTHWORKS VOLUMES (MURPHY STREET ROAD RESERVE)

CUT: 135 m^3 FILL: 25 m^3

EARTHWORKS VOLUMES SHOWN ARE STRAIGHT VOLUMETRIC MEASUREMENTS BETWEEN SURVEYED NATURAL SURFACE AND THE PROPOSED BULK EARTHWORKS SURFACE. VOLUMES NOTED ABOVE ARE FOR EARTHWORKS WITHIN MURPHY STREET ROAD RESERVE ONLY.

- THE ABOVE VOLUMES DO NOT ALLOW FOR THE FOLLOWING
- LOSES/COMPACTION TOPSOIL STRIPING
- DETAILED EXCAVATION / BACKFILL OF FOOTINGS/RETAINING STRUCTURES

- 1. REFER DRG 24003-C002 FOR STANDARD NOTES AND LEGENDS.
- 2. REFER DRG 24003-C006 FOR CUT/FILL DEPTH SHADING LEGEND.
- 3. REFER DRG 24003-C008 FOR TYPICAL BULK EARTHWORK PLATFORM

DEPTH RANGE TABLE DEPTH RANGE (m) FROM TO -30.0 -6.8 -6.6 -6.4 -6.2 -6.0 -6.0 -5.8 -5.6 -5.4 -5.2 -5.2 -5.0 -4.8 -4.6 -4.4 -4.2 -4.0 -3.8 -3.6 -3.4 -3.2 -3.0 -2.8 -2.6 -2.4 -2.4 -2.2 -2.0 -1.8 -1.6 -1.4 -1.2 -1.0 -1.0 -0.8 -0.8 -0.6 -0.6 -0.4 -0.4 -0.2 -0.2

DEPTH RANGE (m) FROM TO 0.0 0.2 0.2 0.4	R		
FROM TO 0.0 0.2 0.2 0.4			
0.2 0.4			
0.4 0.6			
0.6 0.8			
0.8 1.0			
1.0 1.2			
1.2 1.4			
1.4 1.6			
1.6 1.8			
1.8 2.0			
2.0 2.2			
크 2.2 2.4			
2.4 2.6			
2.6 2.8			
2.8 3.0			
3.0 3.2			
3.2 3.4			
3.4 3.6			
3.6 3.8			
3.8 4.0			
4.0 4.2			
4.2 4.4			
4.4 4.6			
4.6 4.8			
4.8 5.0			
5.0 5.2			
5.2 5.4			
5.4 5.6			
5.6 5.8			
5.8 30.0	***************************************		

NOTES

4. A 3D DIGITAL TERRAIN MODEL TO BE PROVIDED TO THE CONTRACTOR PRIOR TO CONSTRUCTION.

NOTE ALL BATTERS, TEMPORARY OR PERMANENT, STEEPER THAN 1H:4V OR HIGHER THAN 1.5m MUST BE INSPECTED WITHIN 24HRS OF EXCAVATION AND CERTIFIED BY AN RPEQ GEOTECHNICAL ENGINEER TO CONFIRM THEIR SHORT TERM AND LONG TERM STABILITIES.



В	ISSUED FOR APPROVAL	GB	GA	01/05/24
Α	PRELIMINARY ISSUE	GB	GA	13/03/24
REV	DESCRIPTION	DRN	APP	DATE
		CERTIFICATION		RPEQ
		G. APPLIN		6073
	A REV	A PRELIMINARY ISSUE	A PRELIMINARY ISSUE REV DESCRIPTION THIS DRAWING IS COPYRIGHT AND THE PROPERTY OF APPLIN CONSULTING. IT MUST ONLY BE USED BY THE NOMINATED CLIENT AND BY ANY PERSON WHO HAS BEEN AGREED C. ADDR.	A PRELIMINARY ISSUE GB GA REV DESCRIPTION THIS DRAWING IS COPYRIGHT AND THE PROPERTY OF APPLIN CONSULTING. IT MUST ONLY BE USED BY THE NOMINATED CLIENT AND BY ANY PERSON WHO HAS BEEN AGREED C A PRIMINAL CONSULTING.

APPLIN — CONSULTING M 0414 768 109 | E greg@applinconsulting.com.au




KIM	CULLEN	&	NEIL	BIDDLE	


DESIGNED G. BROWNING	
DRAWN G. BROWNING	
CHECKED G. APPLIN	

CULLEN-BIDDLE RESIDENCE 12 MURPHY STREET (LOT 113 PTD2094)

TITLE
BULK EARTHWORKS PLAN
SHEET 1 OF 3

TUS	
FOR APPROVAL	
LE (AT FULL SIZE)	SIZ
:100	Α
WING NUMBER	REVIS
24003-C006	E

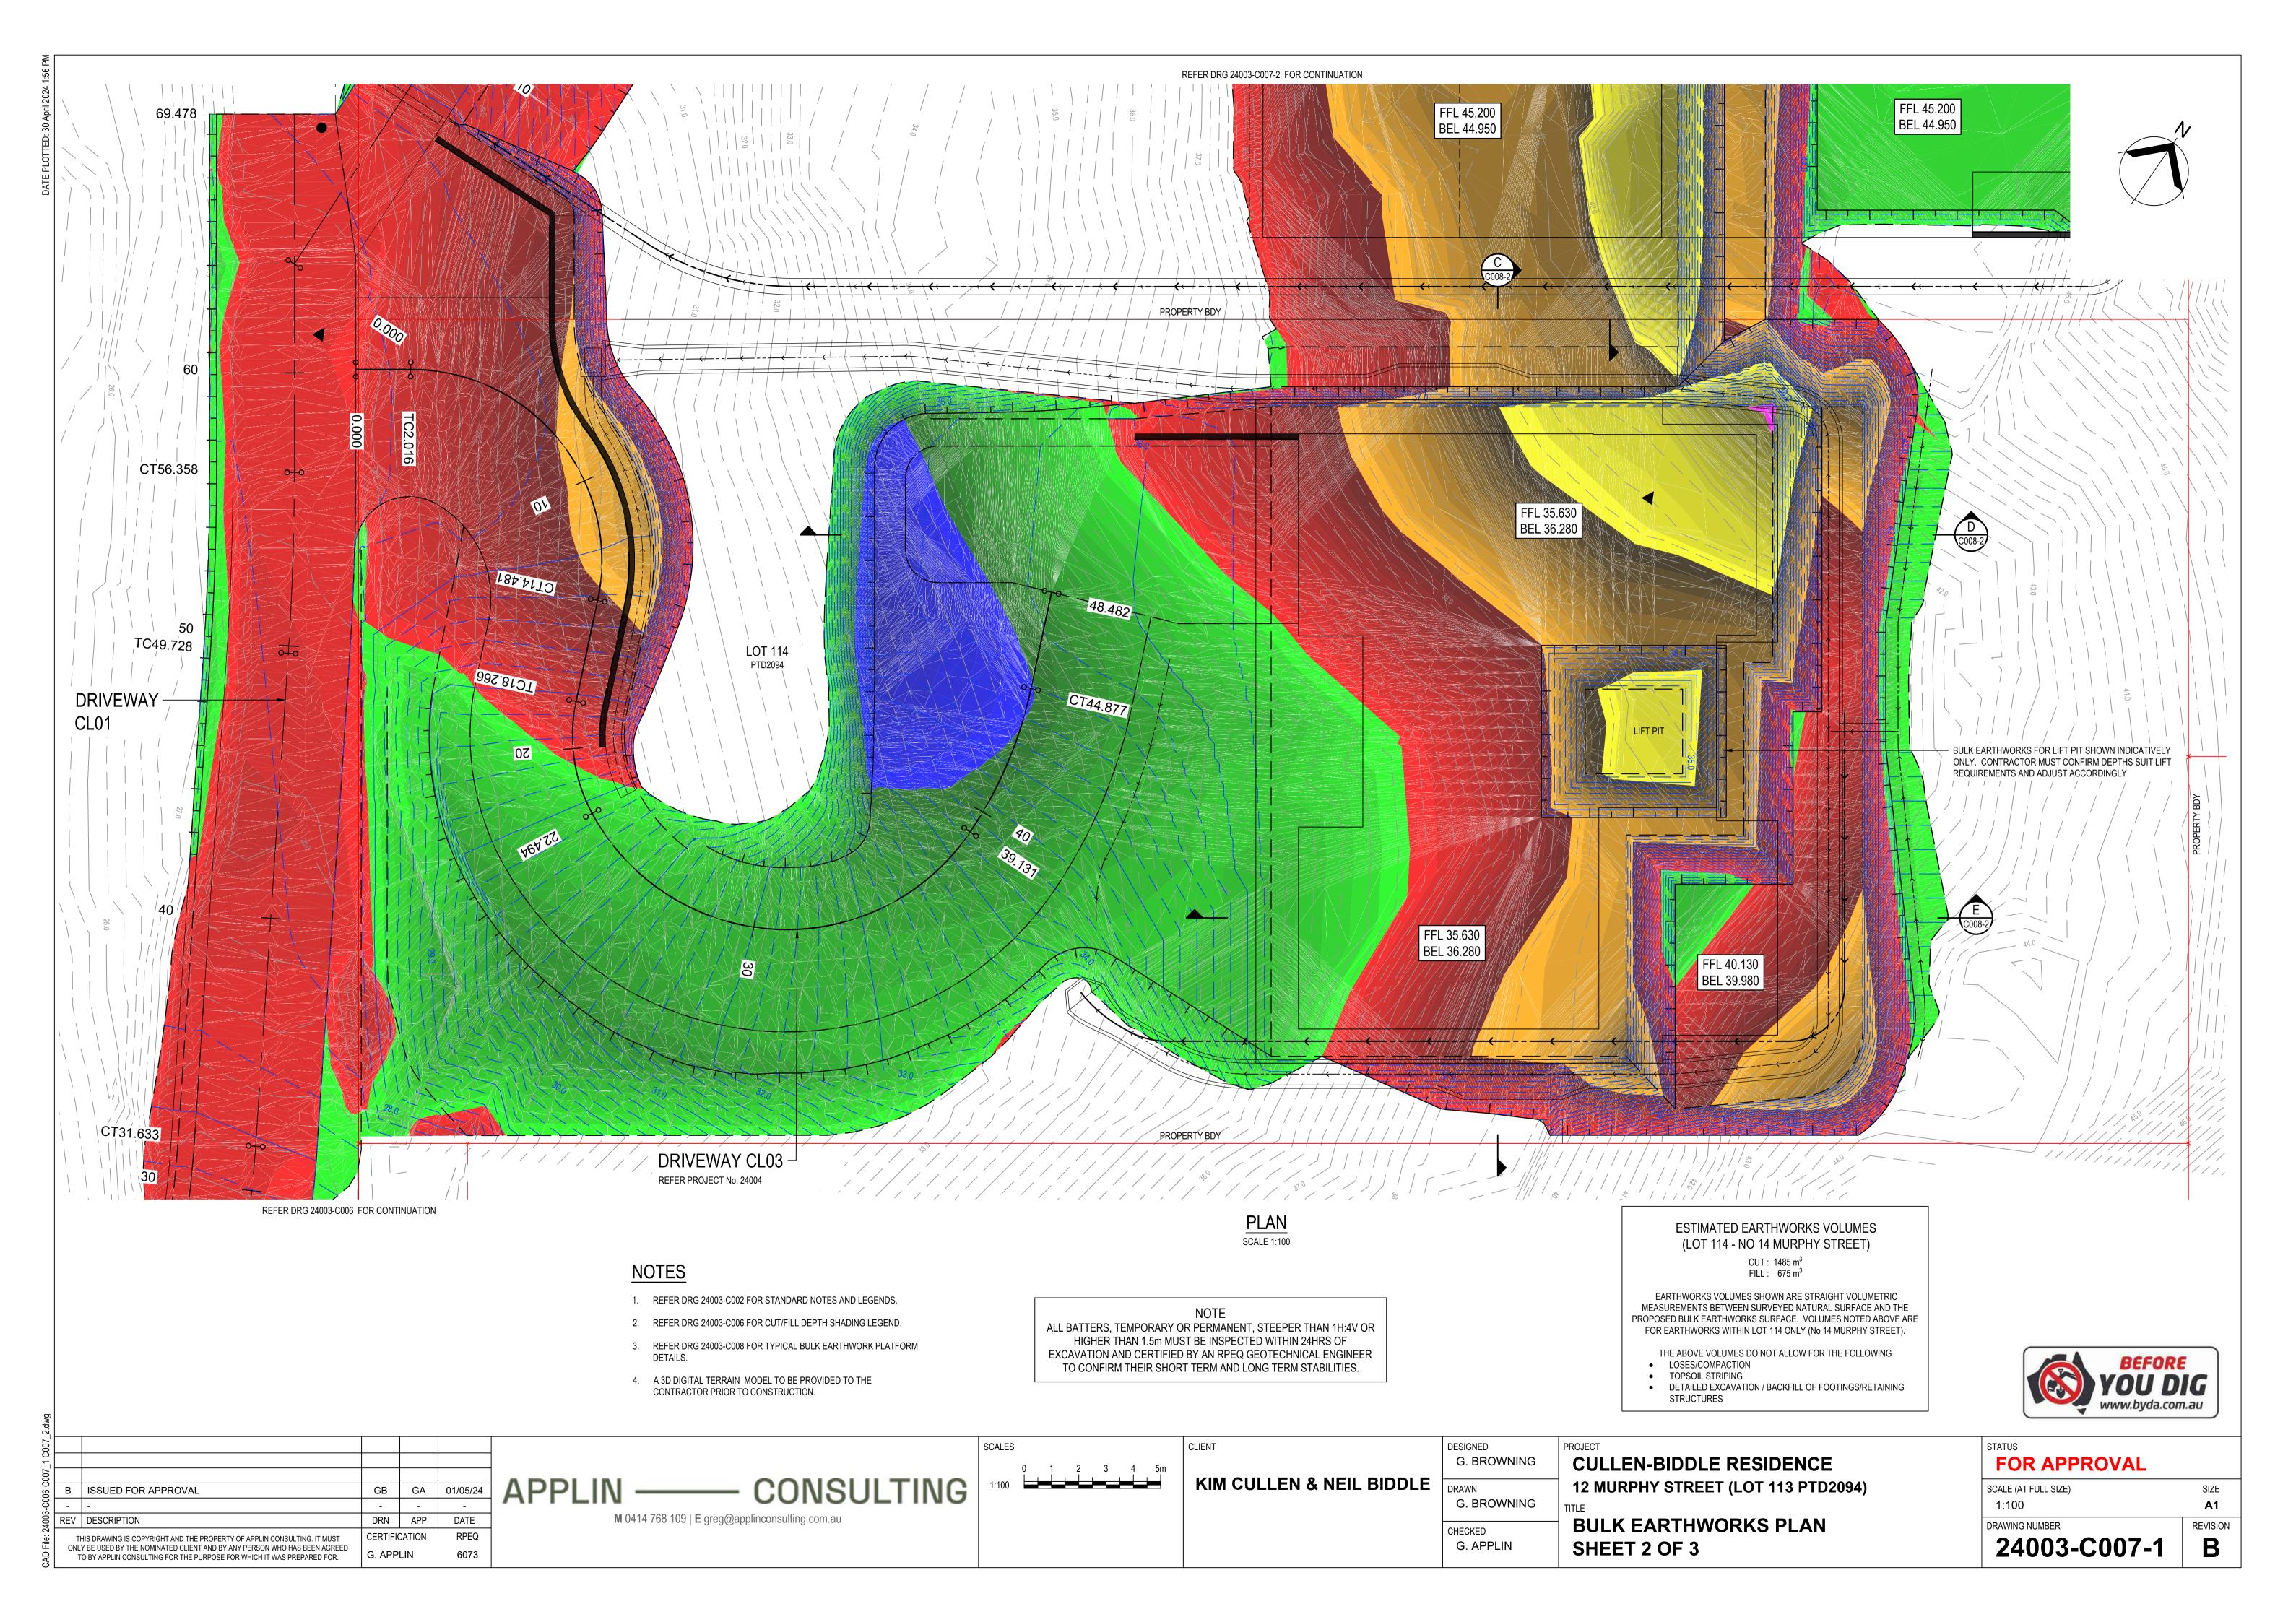

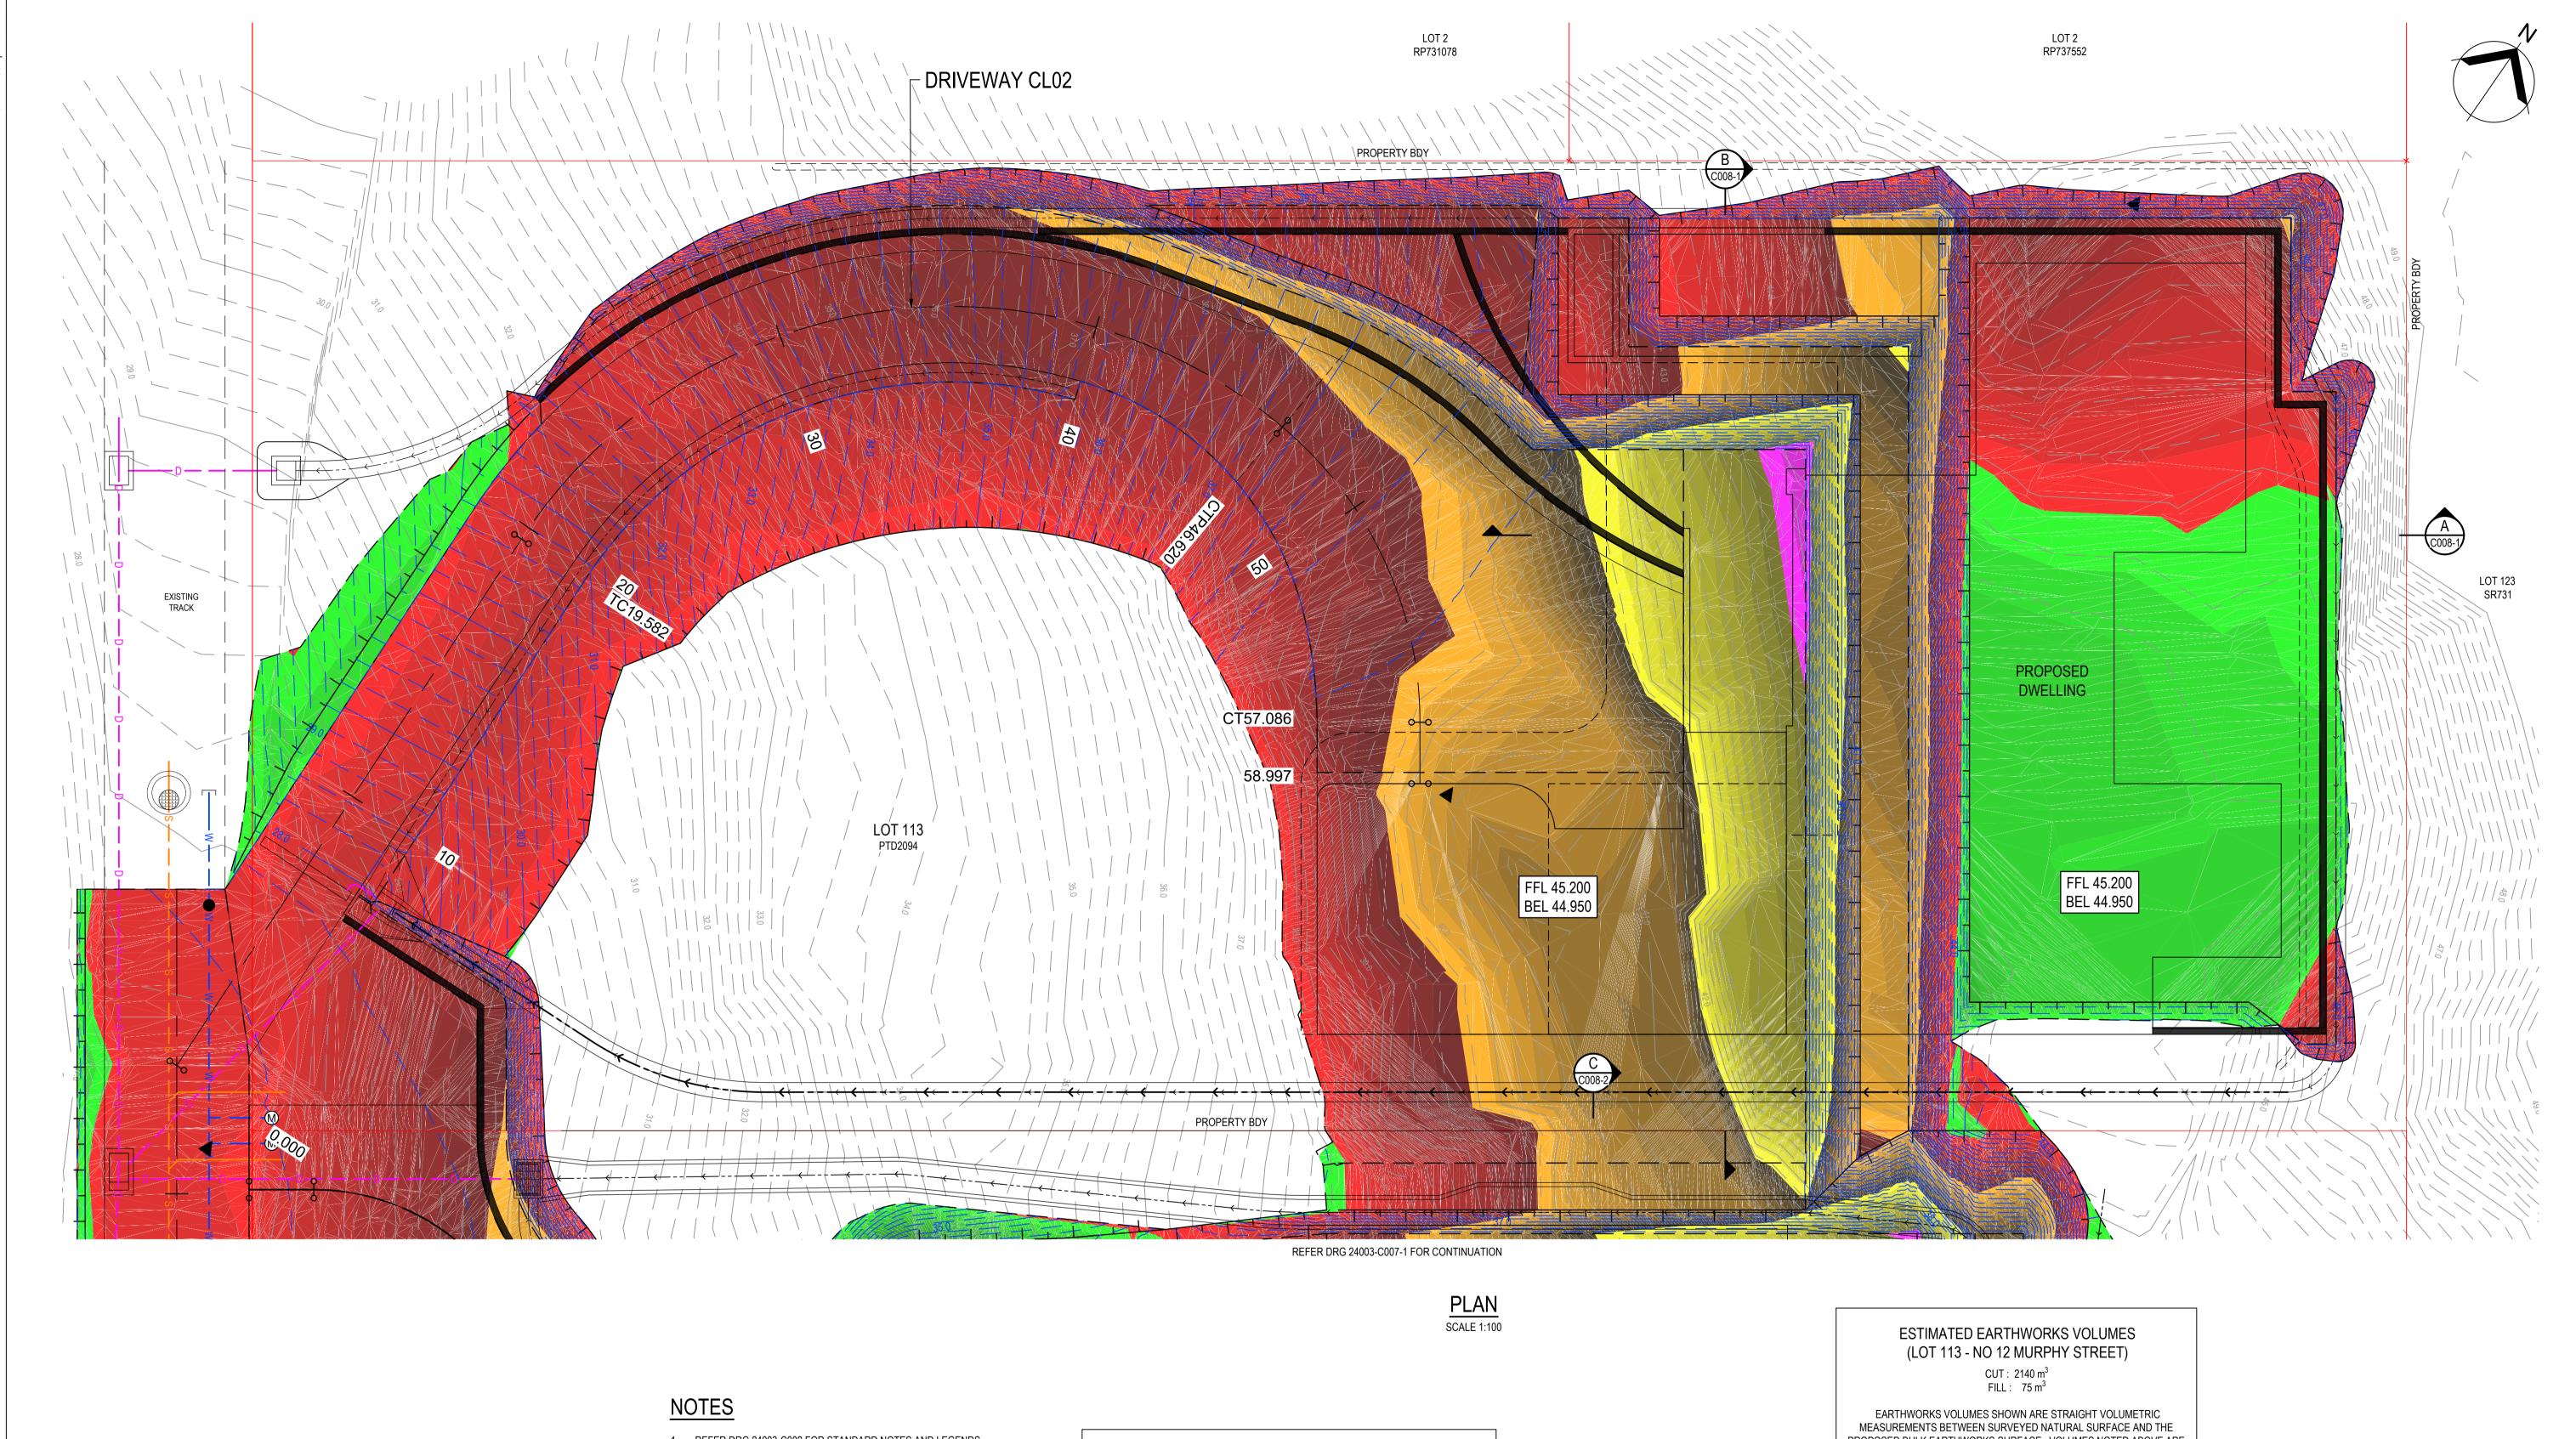

- 1. REFER DRG 24003-C002 FOR STANDARD NOTES AND LEGENDS.
- 2. REFER DRG 24003-C006 FOR CUT/FILL DEPTH SHADING LEGEND.
- 3. REFER DRG 24003-C008 FOR TYPICAL BULK EARTHWORK PLATFORM
- 4. A 3D DIGITAL TERRAIN MODEL TO BE PROVIDED TO THE CONTRACTOR PRIOR TO CONSTRUCTION.

NOTE

ALL BATTERS, TEMPORARY OR PERMANENT, STEEPER THAN 1H:4V OR HIGHER THAN 1.5m MUST BE INSPECTED WITHIN 24HRS OF EXCAVATION AND CERTIFIED BY AN RPEQ GEOTECHNICAL ENGINEER TO CONFIRM THEIR SHORT TERM AND LONG TERM STABILITIES.

PROPOSED BULK EARTHWORKS SURFACE. VOLUMES NOTED ABOVE ARE FOR EARTHWORKS WITHIN LOT 113 ONLY (No 12 MURPHY STREET).

- THE ABOVE VOLUMES DO NOT ALLOW FOR THE FOLLOWING


 LOSES/COMPACTION
- TOPSOIL STRIPING
- DETAILED EXCAVATION / BACKFILL OF FOOTINGS/RETAINING STRUCTURES



В	ISSUED FOR APPROVAL	GB	GA	01/05/24
Α	PRELIMINARY ISSUE	GB	GA	13/03/24
REV	DESCRIPTION	DRN	APP	DATE
		CERTIFICATION		RPEQ
		G. APPLIN 6073		
	A REV	A PRELIMINARY ISSUE	A PRELIMINARY ISSUE REV DESCRIPTION THIS DRAWING IS COPYRIGHT AND THE PROPERTY OF APPLIN CONSULTING. IT MUST ONLY BE USED BY THE NOMINATED CLIENT AND BY ANY PERSON WHO HAS BEEN AGREED C. ADDITIONAL TO THE PROPERTY OF APPLIN CONSULTING. IT MUST ONLY BE USED BY THE NOMINATED CLIENT AND BY ANY PERSON WHO HAS BEEN AGREED C. ADDITIONAL TO THE PROPERTY OF APPLIN CONSULTING. IT MUST ONLY BE USED BY THE NOMINATED CLIENT AND BY ANY PERSON WHO HAS BEEN AGREED C. ADDITIONAL TO THE PROPERTY OF APPLIN CONSULTING. IT MUST ONLY BE USED BY THE NOMINATED CLIENT AND BY ANY PERSON WHO HAS BEEN AGREED	A PRELIMINARY ISSUE REV DESCRIPTION THIS DRAWING IS COPYRIGHT AND THE PROPERTY OF APPLIN CONSULTING. IT MUST ONLY BE USED BY THE NOMINATED CLIENT AND BY ANY PERSON WHO HAS BEEN AGREED C. A P. P. L. L. L. C. A P. P. L. L. L. C. A P. P. L.

APPLIN — CONSULTING

M 0414 768 109 | E greg@applinconsulting.com.au

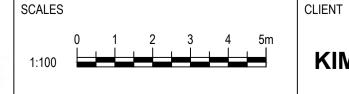

KIM CULLEN & NEIL BIDDLE

G. BROWNING	
DRAWN G. BROWNING	
CHECKED G. APPLIN	

CULLEN-BIDDLE RESIDENCE 12 MURPHY STREET (LOT 113 PTD2094)


BULK EARTHWORKS PLAN SHEET 3 OF 3


FOR APPROVAL
SCALE (AT FULL SIZE)
1:100

24003-C007-2


REVISION В


SIZE **A1**

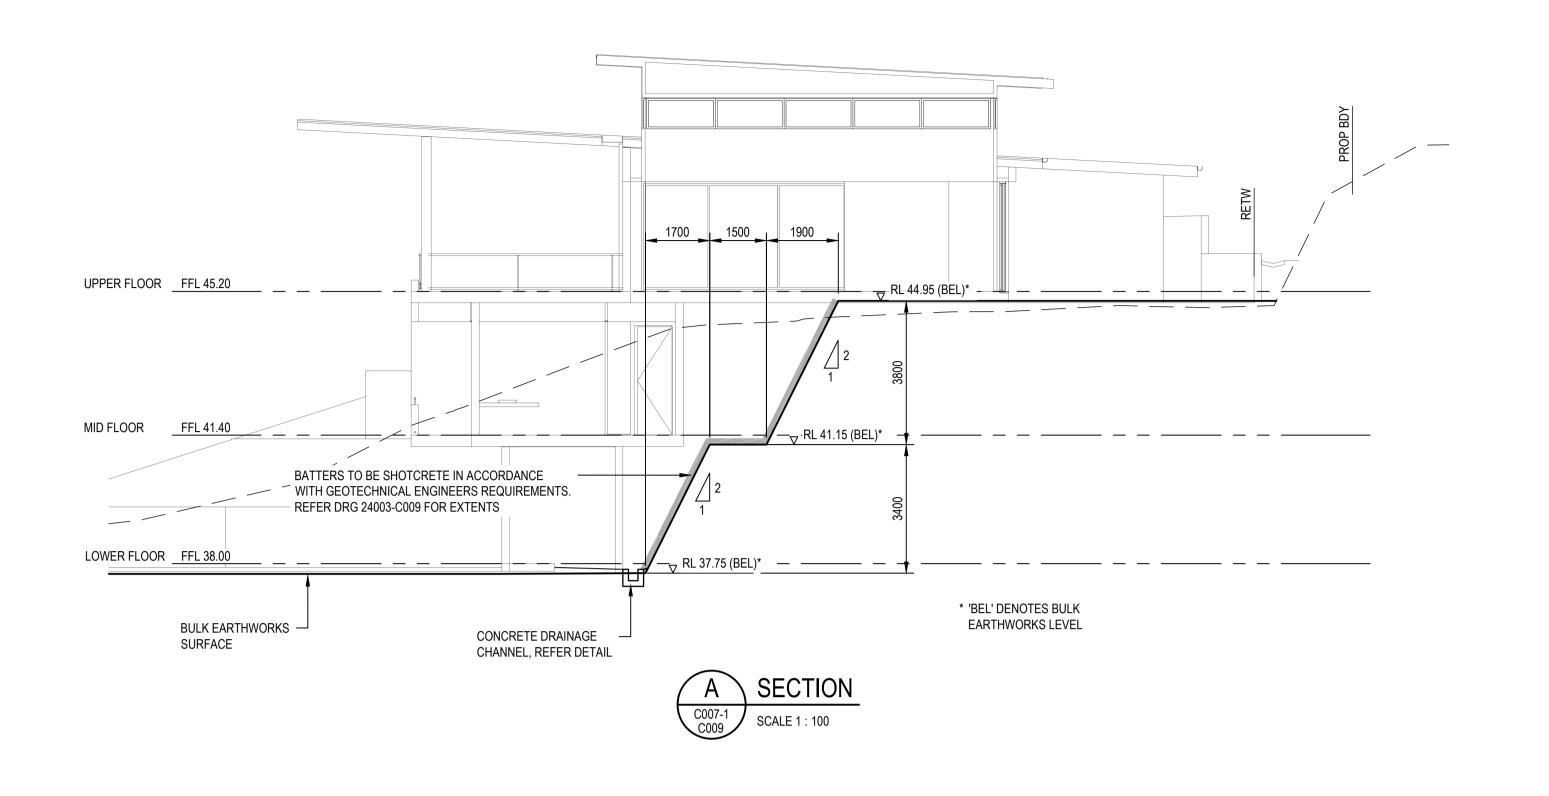

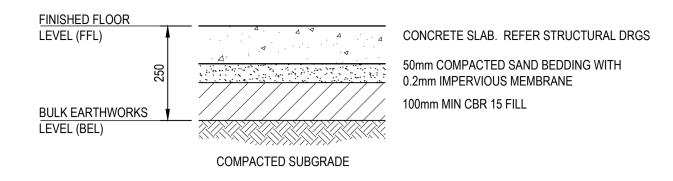

BUILDING PLATFORM

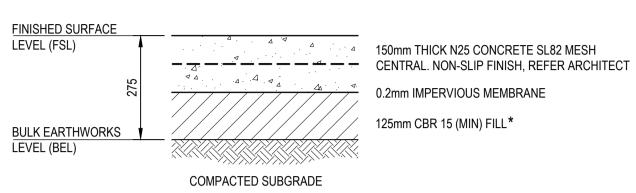

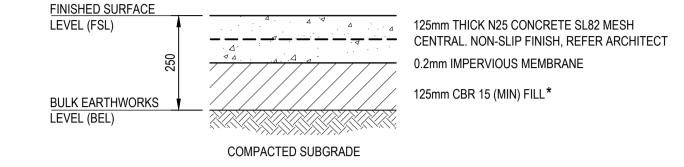

* ALTERNATIVE SUB BASE MATERIAL TYPES MAY BE CONSIDER AS A TEMPORARY RUNNING SURFACE


DRIVEWAY CL02


DRIVEWAY CL01

* ALTERNATIVE SUB BASE MATERIAL TYPES MAY BE CONSIDER AS A TEMPORARY RUNNING SURFACE

BULK EARTHWORK PLATFORM LEVELS ARE BASED ON THE DEPTHS TO FINISHED SURFACE / FLOOR LEVELS AS SHOWN ABOVE. THE CONTRACTOR IS TO CONFIRM STRUCTURAL REQUIREMENTS AND ADJUST PLATFORMS LEVELS AS REQUIRED.

BULK EARTHWORKS PLATFORM TYPICAL DETAILS

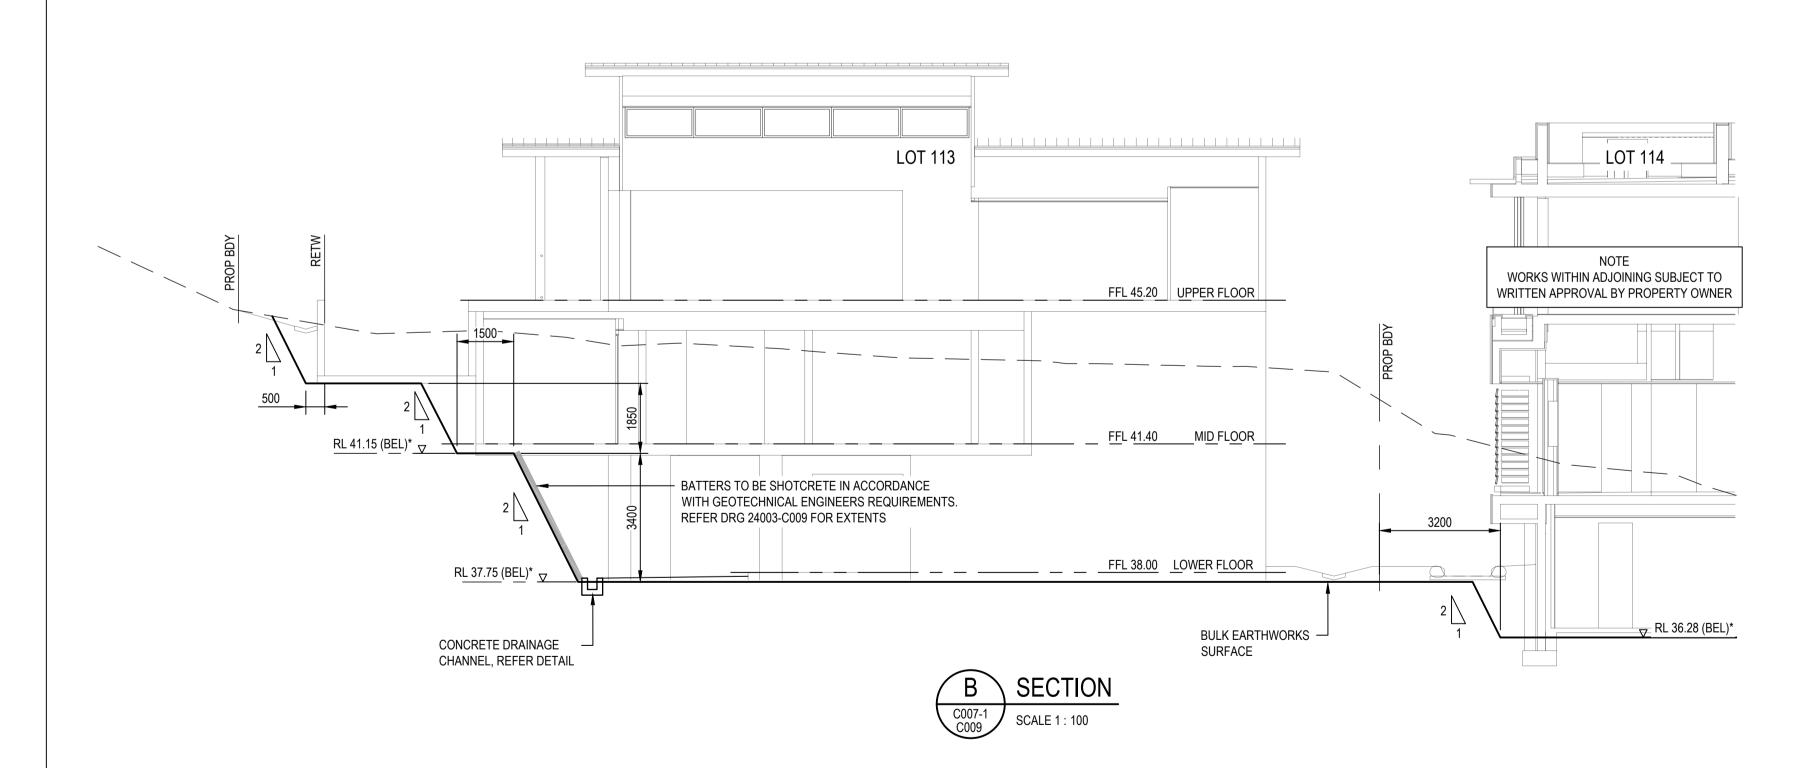

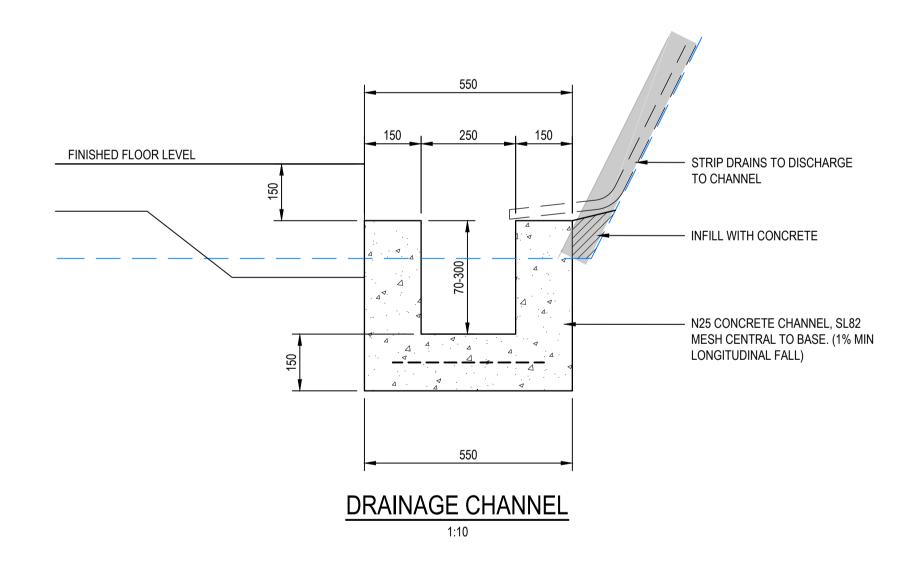


NOTES


- REFER DRG 24003-C002 FOR STANDARD NOTES AND LEGENDS.
- 2. REFER DRG 23004-C007 FOR BULK EARTHWORKS.

NOTE
ALL BATTERS, TEMPORARY OR PERMANENT, STEEPER THAN 1H:4V OR
HIGHER THAN 1.5m MUST BE INSPECTED WITHIN 24HRS OF
EXCAVATION AND CERTIFIED BY AN RPEQ GEOTECHNICAL ENGINEER

TO CONFIRM THEIR SHORT TERM AND LONG TERM STABILITIES.


2.dwg					SCALES	CLIENT	DESIGNED	PROJECT	STATUS	
800					0 1 2 3 4 5m		G. BROWNING	CULLEN-BIDDLE RESIDENCE	FOR APPROVAL	
38_1C	B ISSUED FOR APPROVAL	GB GA	01/05/24	APPLIN — CONSULTING	1:100	KIM CULLEN & NEIL BIDDLE	DRAWN	12 MURPHY STREET (LOT 113 PTD2094)	SCALE (AT FULL SIZE)	SIZE
3,00	A PRELIMINARY ISSUE	GB GA	13/03/24		0 0.1 0.2 0.3 0.4 0.5m		G. BROWNING	TITLE	AS SHOWN	A 1
2400;	REV DESCRIPTION	DRN APP	DATE	M 0414 768 109 E greg@applinconsulting.com.au	1:10		CHECKED	SITE SECTIONS AND DETAILS	DRAWING NUMBER	REVISION
<u>=</u>	THIS DRAWING IS COPYRIGHT AND THE PROPERTY OF APPLIN CONSULTING. IT MUST	CERTIFICATION	RPEQ				CHECKED G. APPLIN		24003-C008-1	D
CAD F	TO BY APPLIN CONSULTING FOR THE PURPOSE FOR WHICH IT WAS PREPARED FOR.	G. APPLIN	6073				0.711 LIN	SHEET 1 OF 2	24003-C006-1	

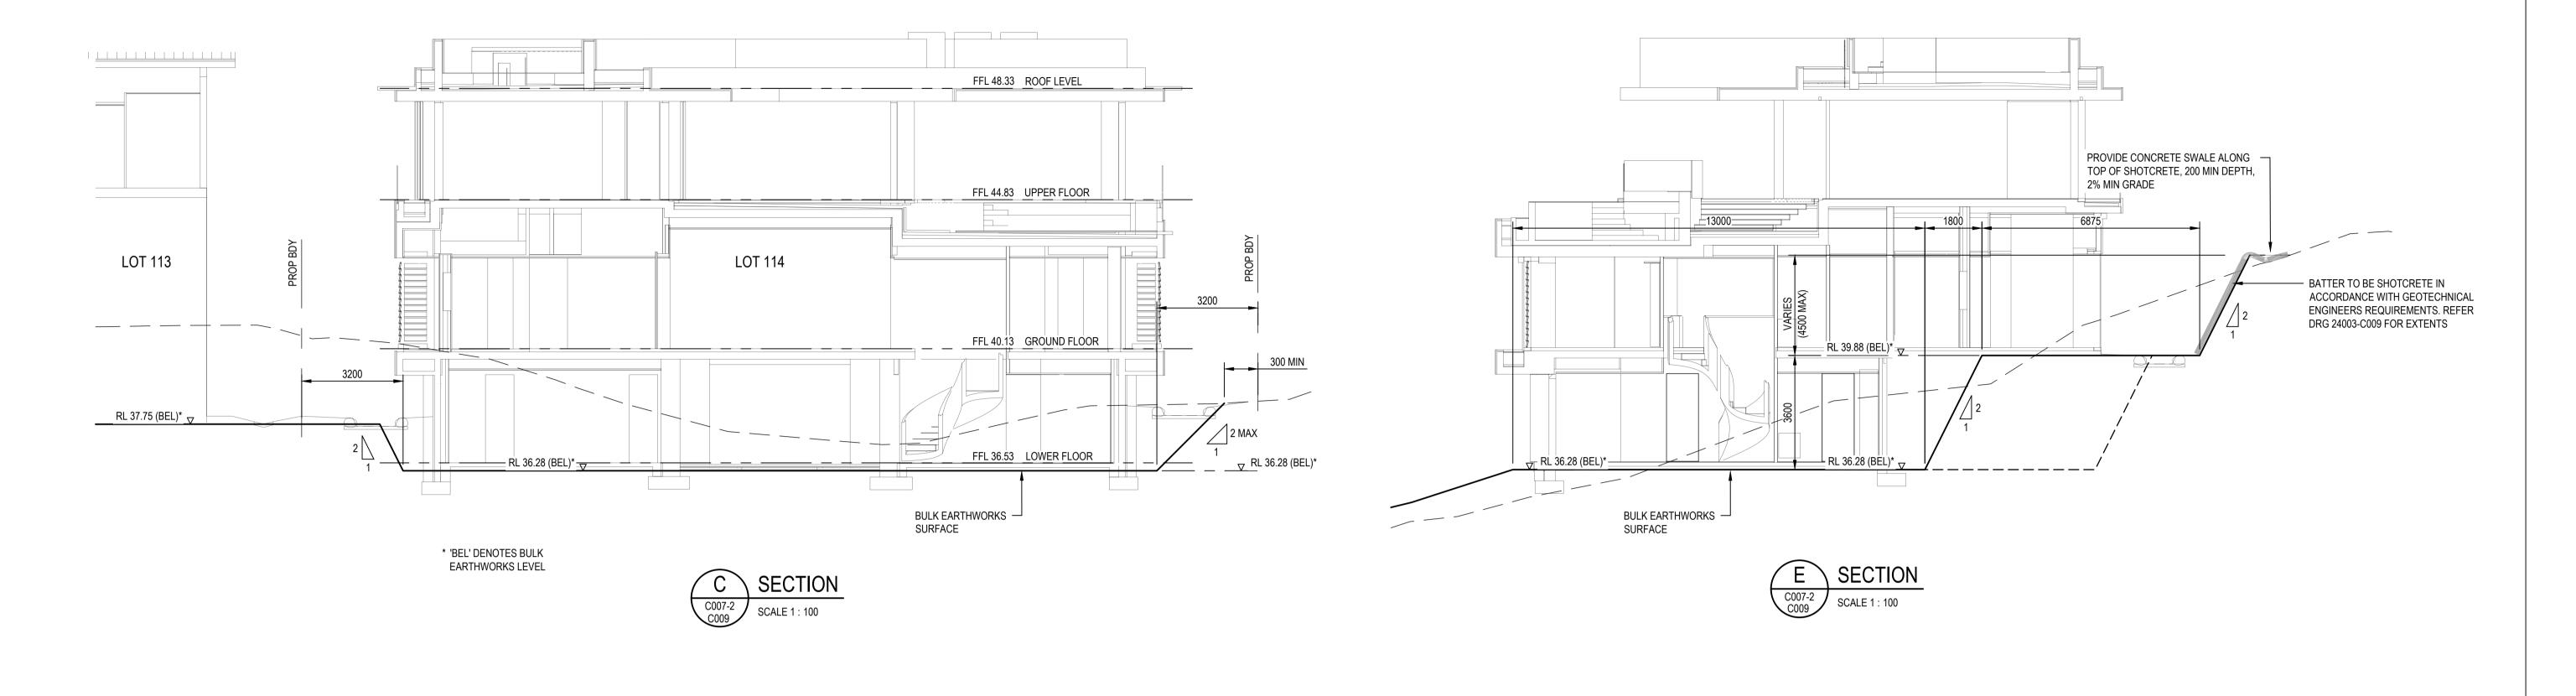


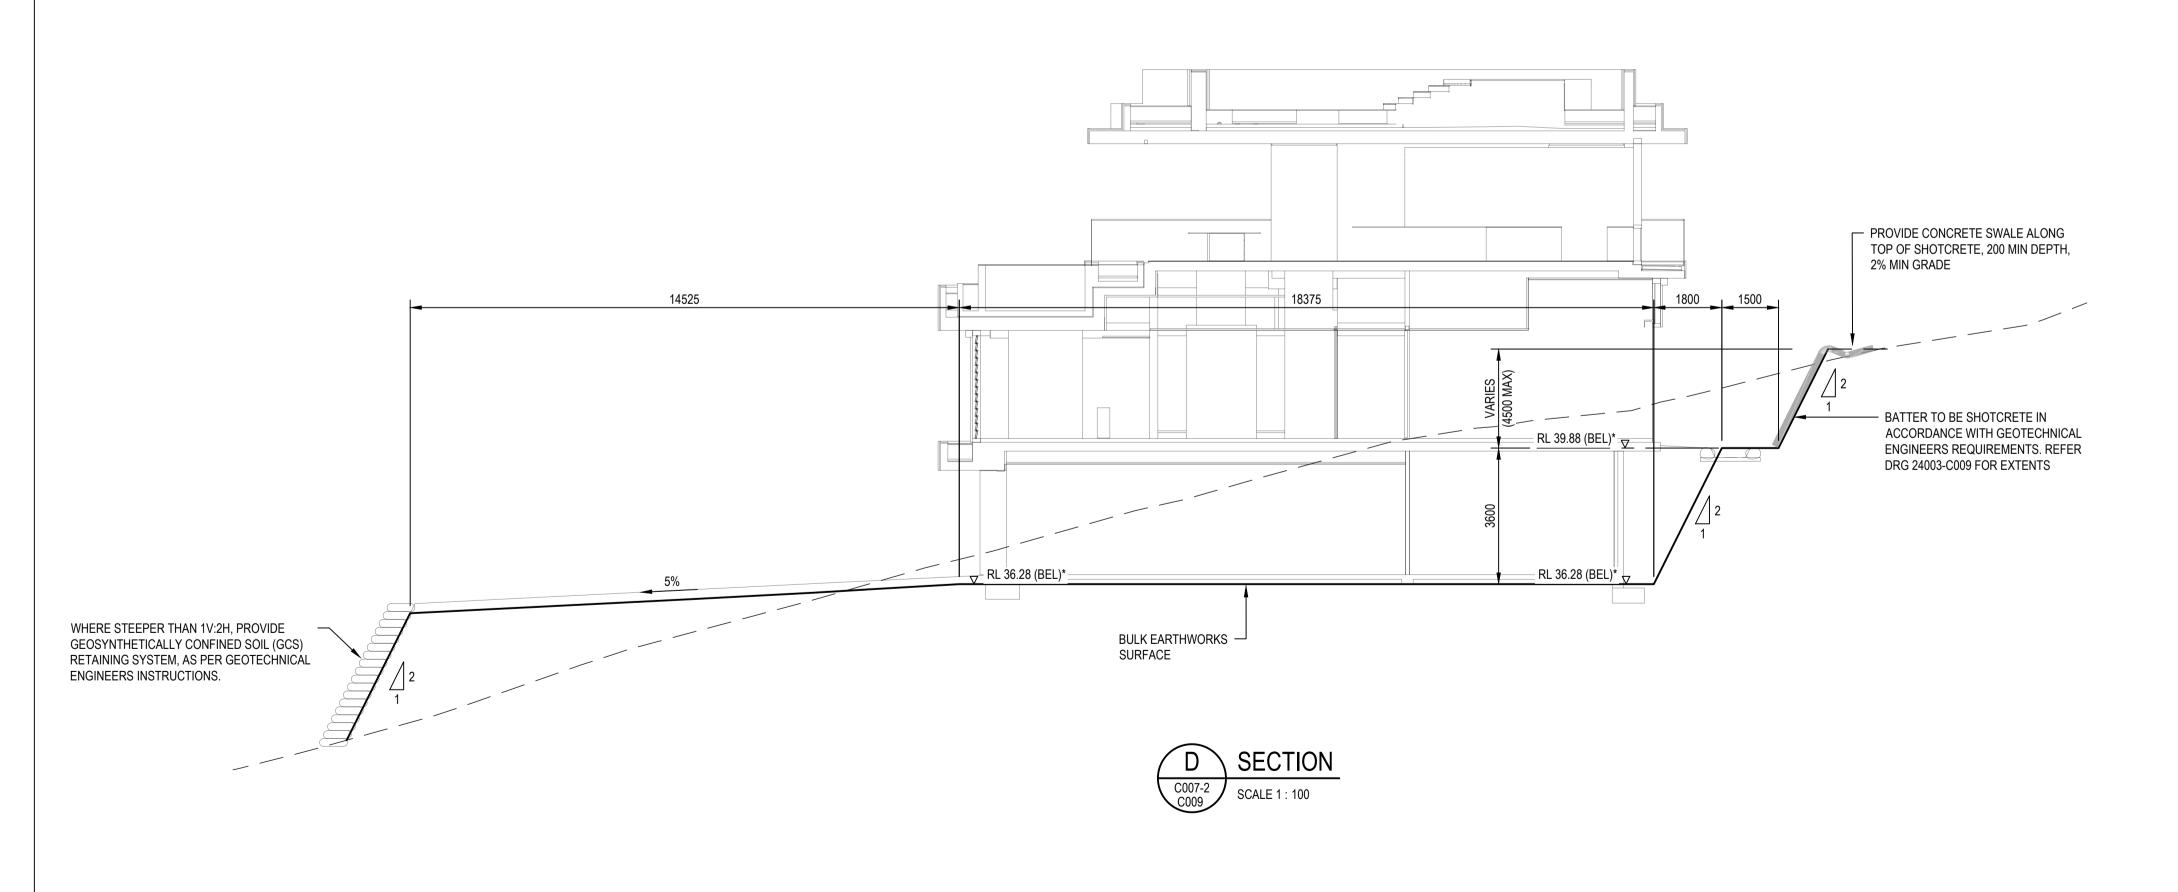


NOTE
ALL BATTERS, TEMPORARY OR PERMANENT, STEEPER THAN 1H:4V OR
HIGHER THAN 1.5m MUST BE INSPECTED WITHIN 24HRS OF
EXCAVATION AND CERTIFIED BY AN RPEQ GEOTECHNICAL ENGINEER
TO CONFIRM THEIR SHORT TERM AND LONG TERM STABILITIES.


C008_2.dwg					SCALES 0 1 2 3 4 5m	CLIENT	DESIGNED G. BROWNING	PROJECT CULLEN-BIDDLE RESIDENCE	FOR APPROVAL	
3-C008_1	ISSUED FOR APPROVAL -	GB GA	01/05/24	APPLIN ——— CONSULTING	1:100 0 0.1 0.2 0.3 0.4 0.5m	KIM CULLEN & NEIL BIDDLE	DRAWN G. BROWNING	12 MURPHY STREET (LOT 113 PTD2094)	SCALE (AT FULL SIZE) AS SHOWN	SIZE A1
CAD File: 2400	THIS DRAWING IS COPYRIGHT AND THE PROPERTY OF APPLIN CONSULTING. IT MUST INLY BE USED BY THE NOMINATED CLIENT AND BY ANY PERSON WHO HAS BEEN AGREED TO BY APPLIN CONSULTING FOR THE PURPOSE FOR WHICH IT WAS PREPARED FOR.	DRN APP CERTIFICATION G. APPLIN	DATE RPEQ 6073	M 0414 768 109 E greg@applinconsulting.com.au	1:10		CHECKED G. APPLIN	SITE SECTIONS AND DETAILS SHEET 2 OF 2	DRAWING NUMBER 24003-C008-2	REVISION

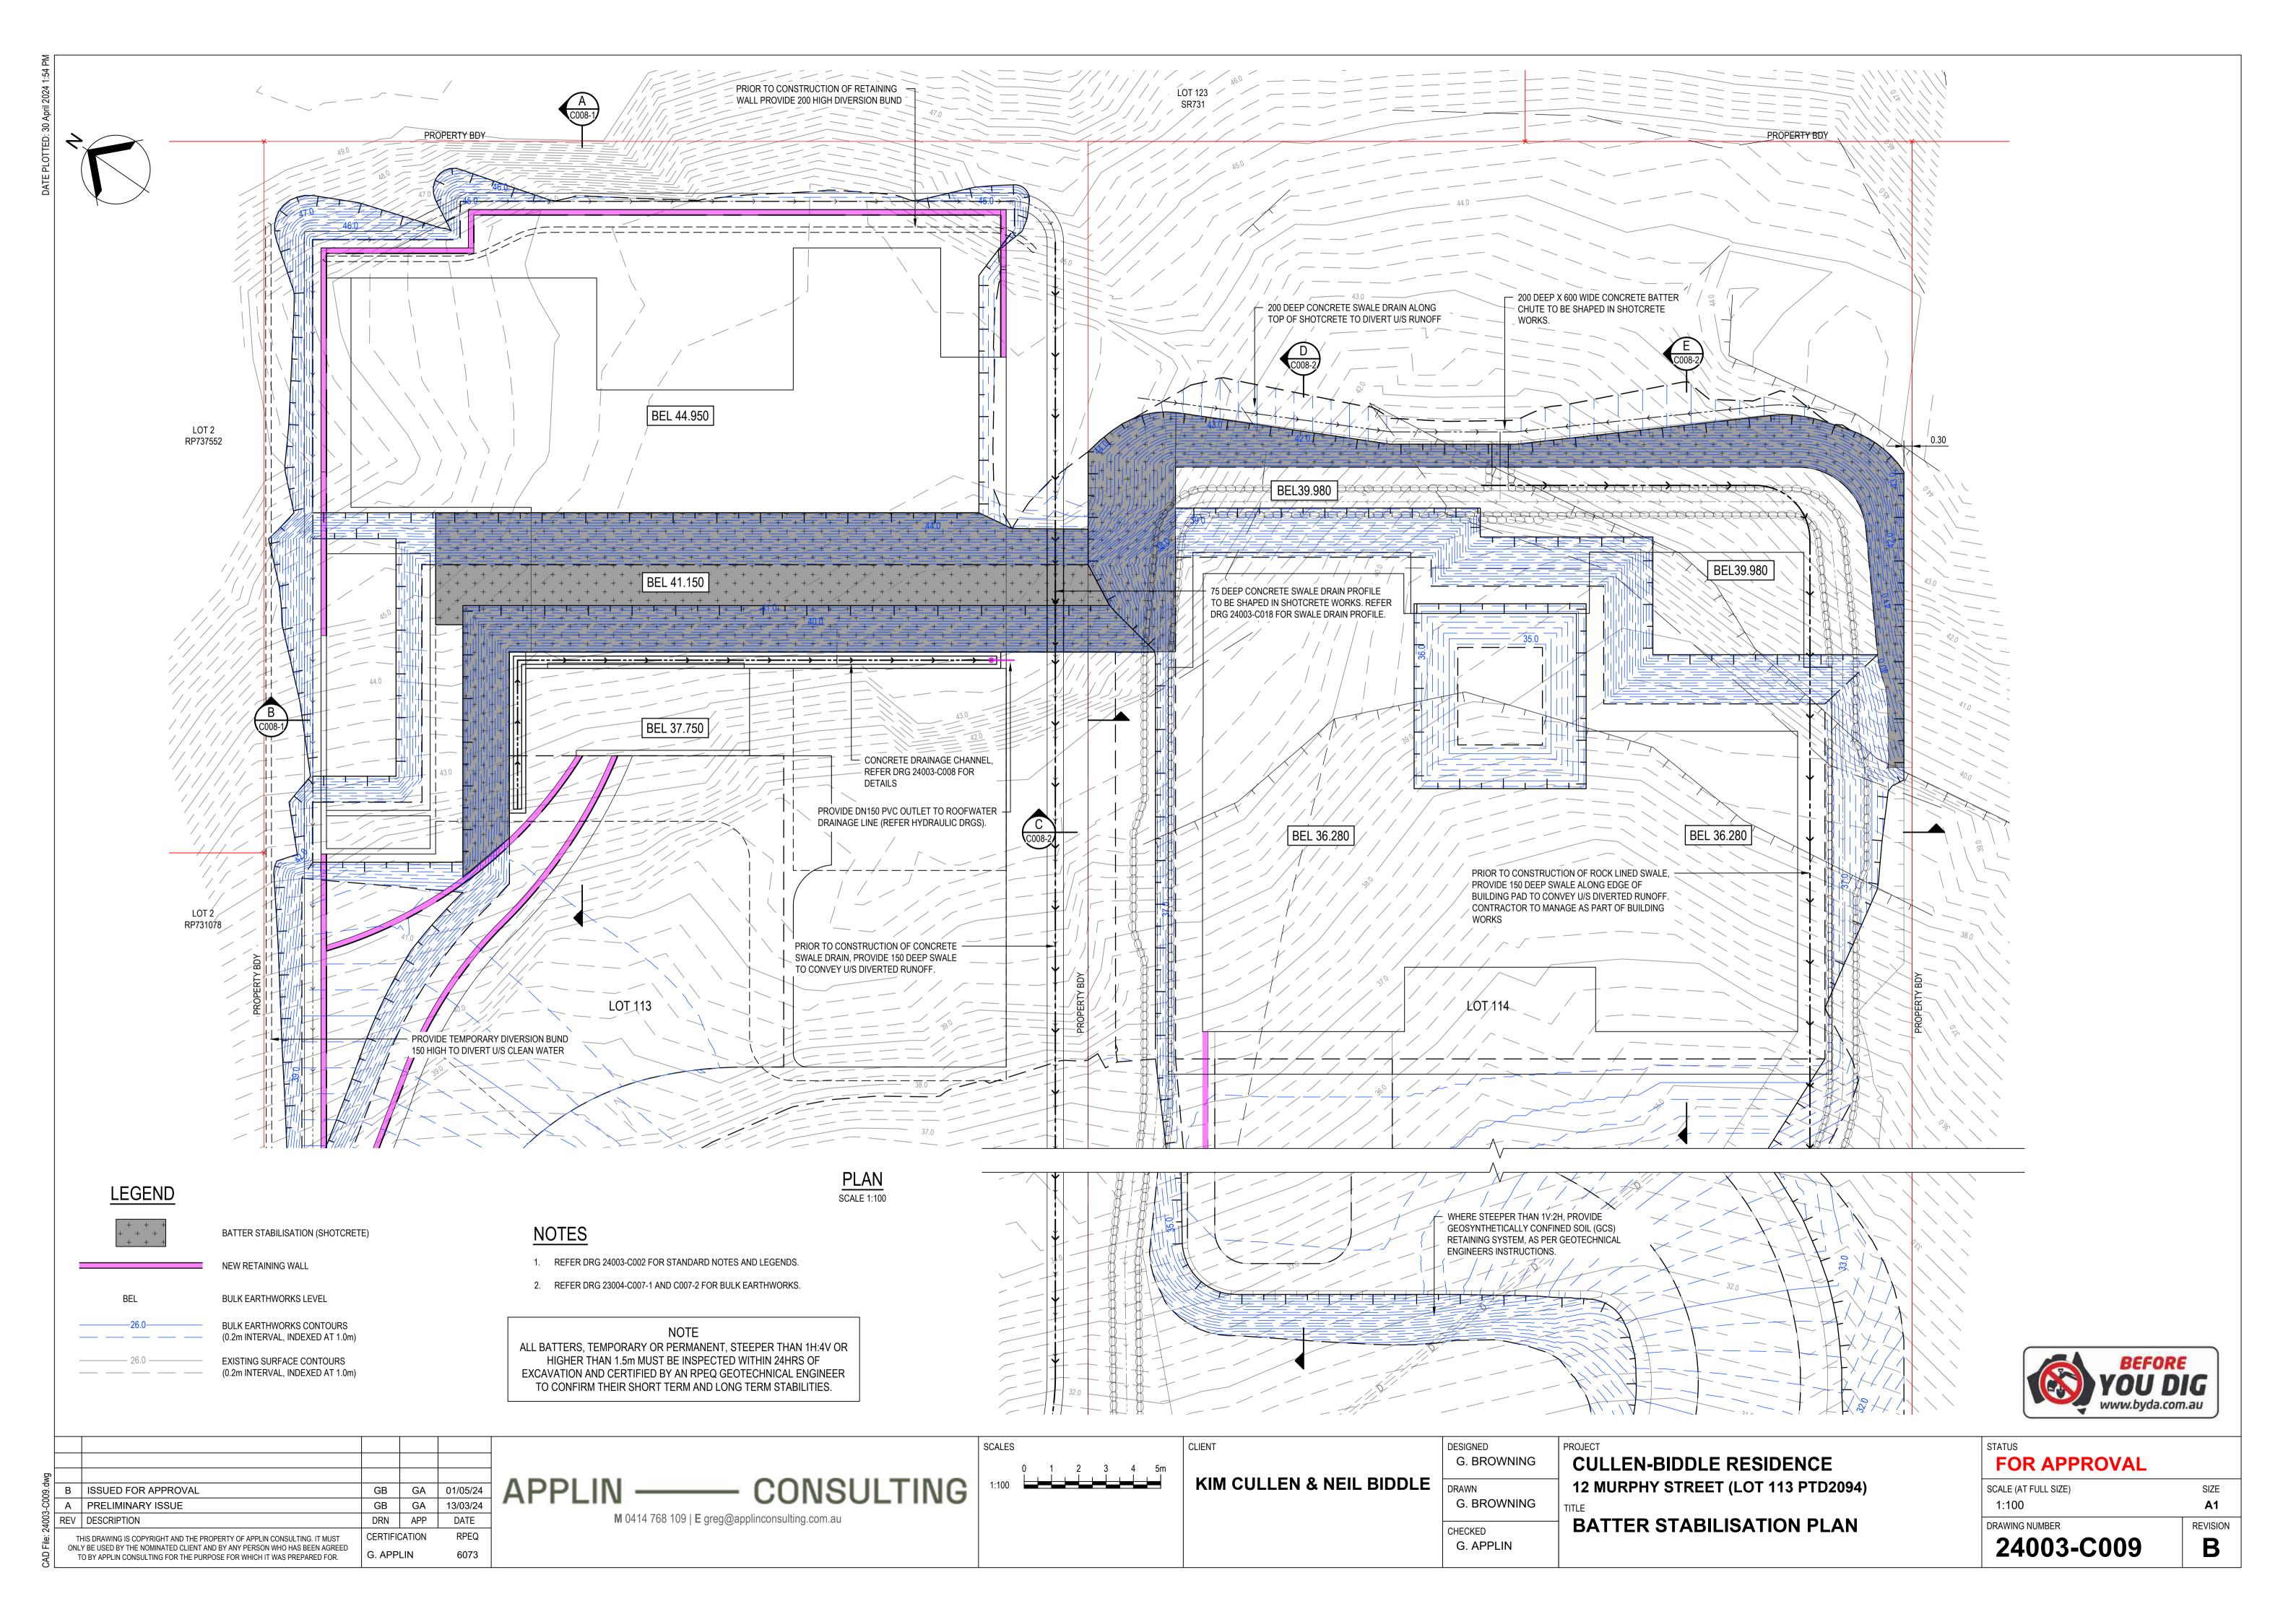

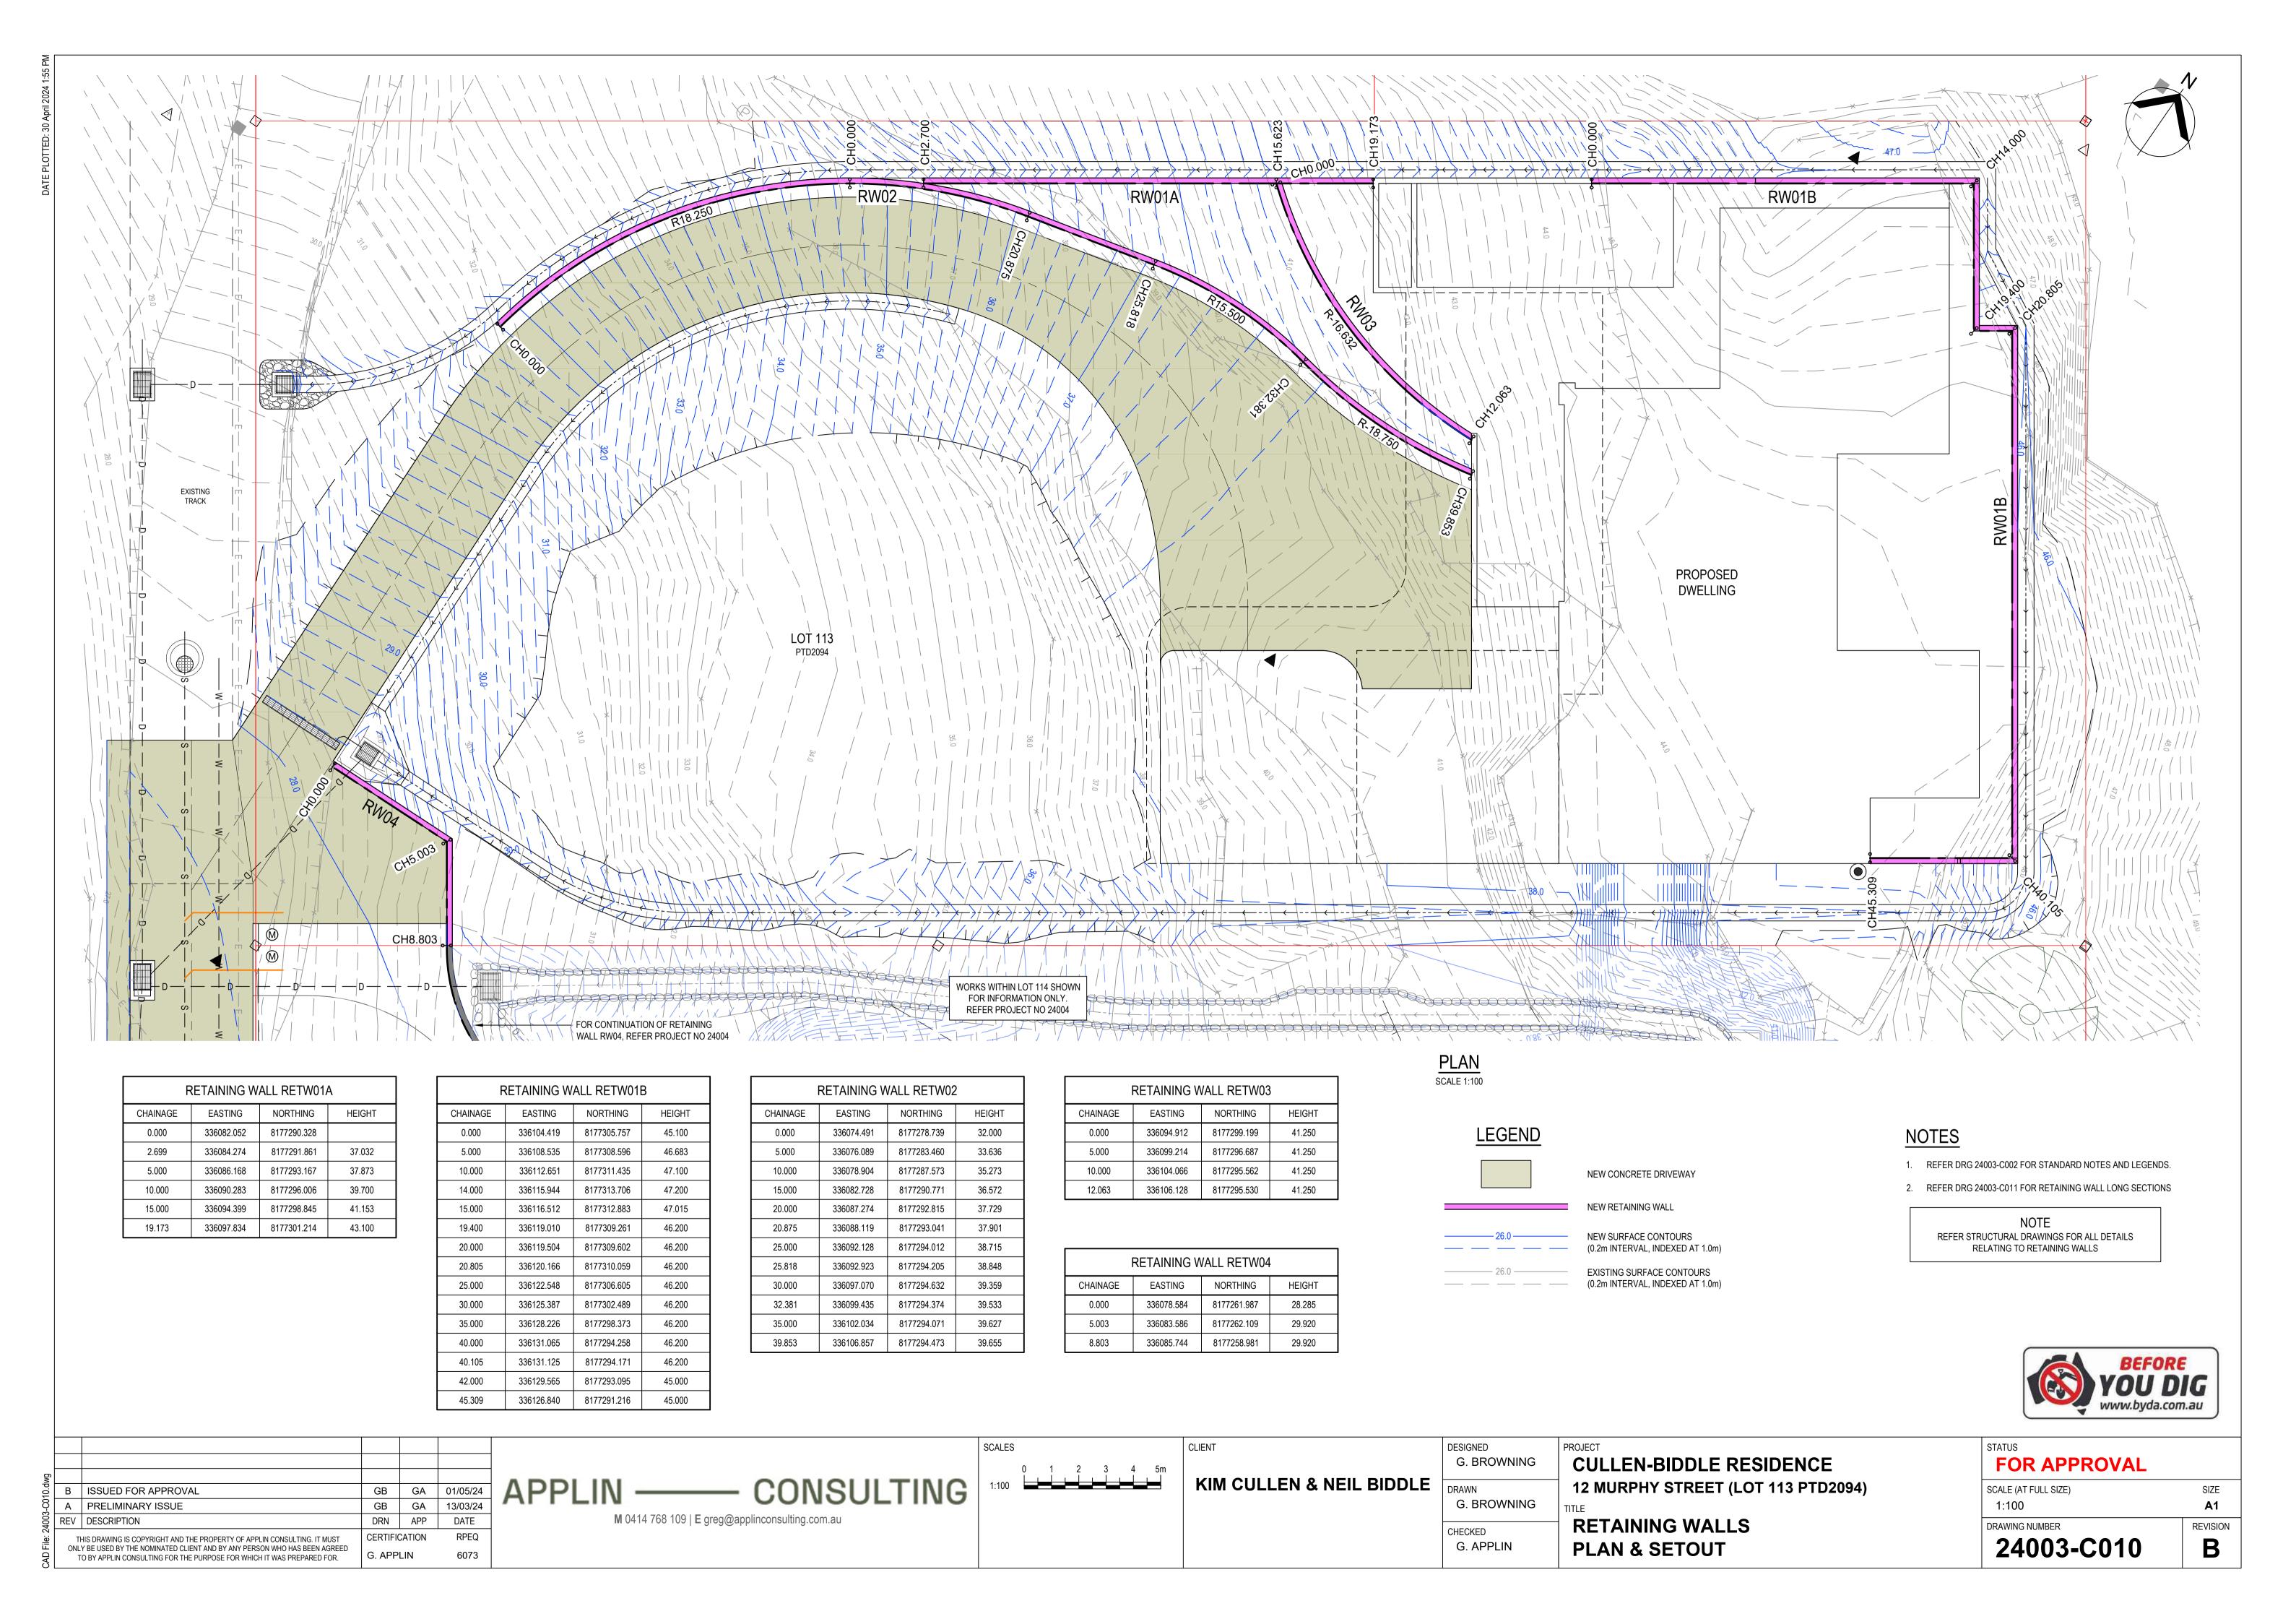


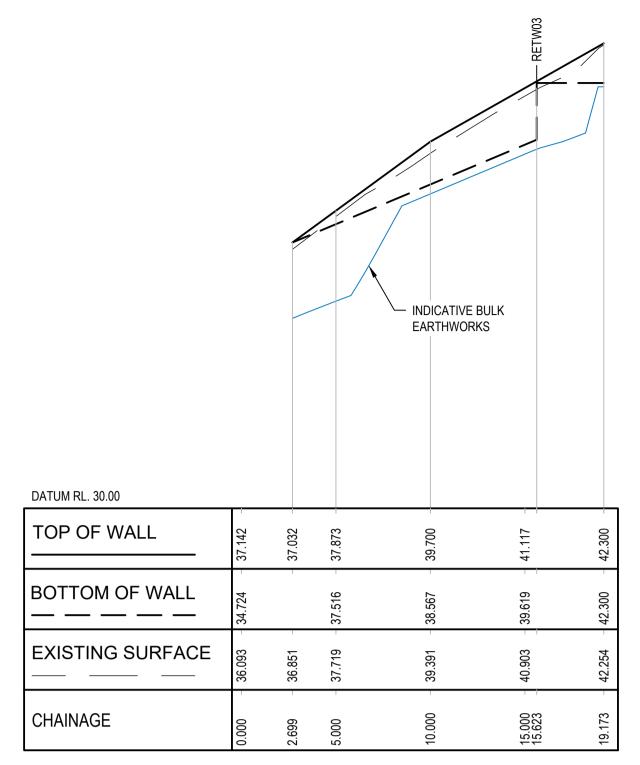


RETAINING WALL - RETW01A

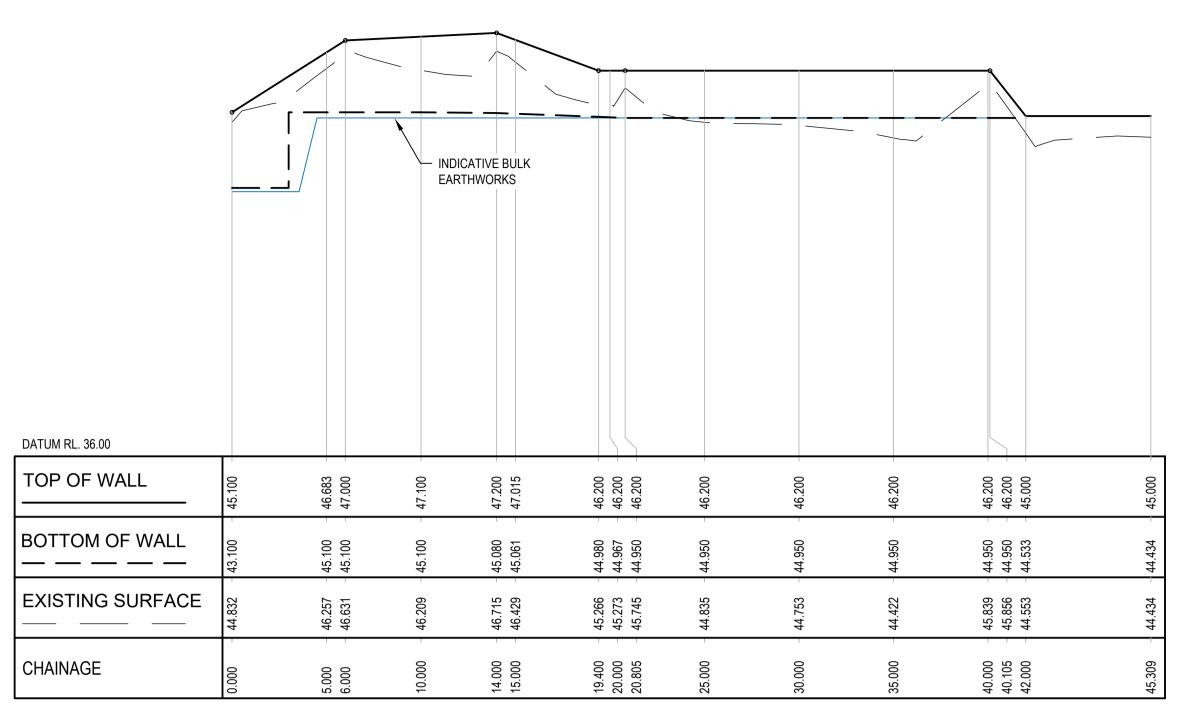


RETAINING WALL - RETW01B

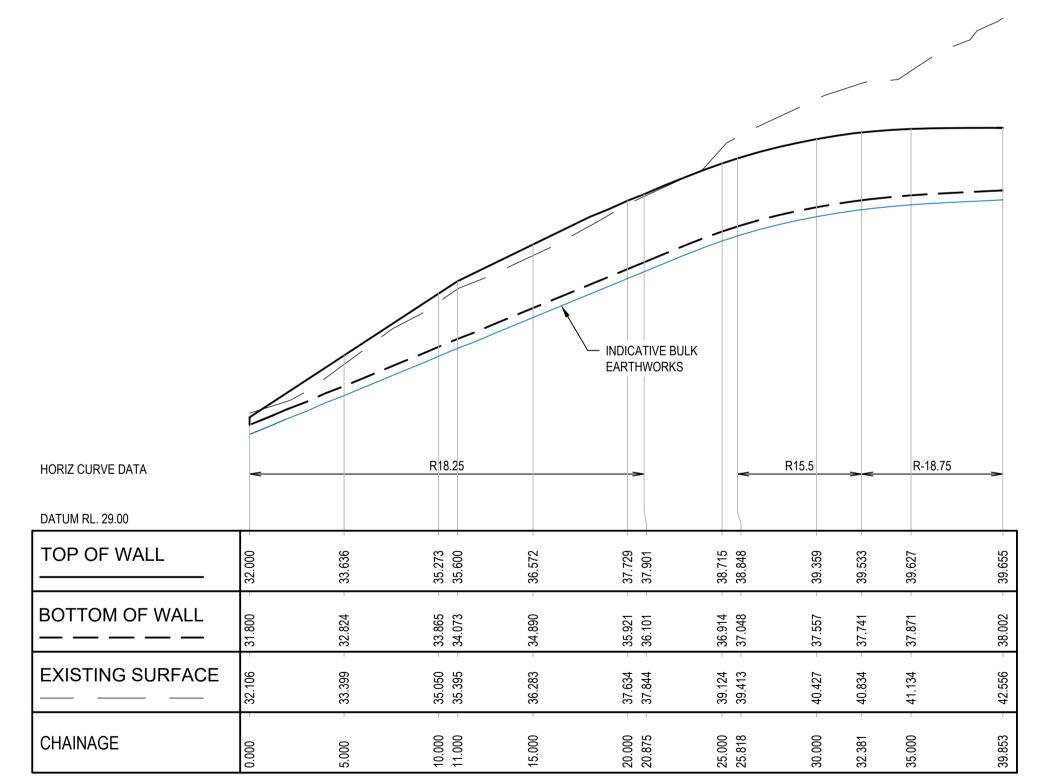

RETAINING WALL - RETW02

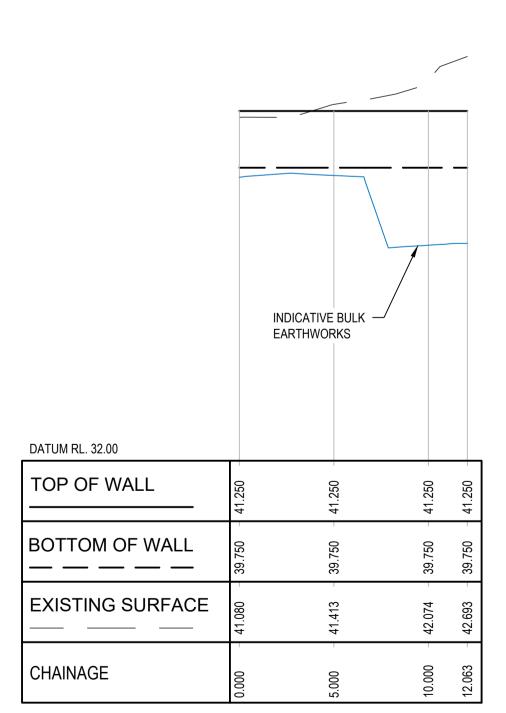

RETAINING WALL - RETW03

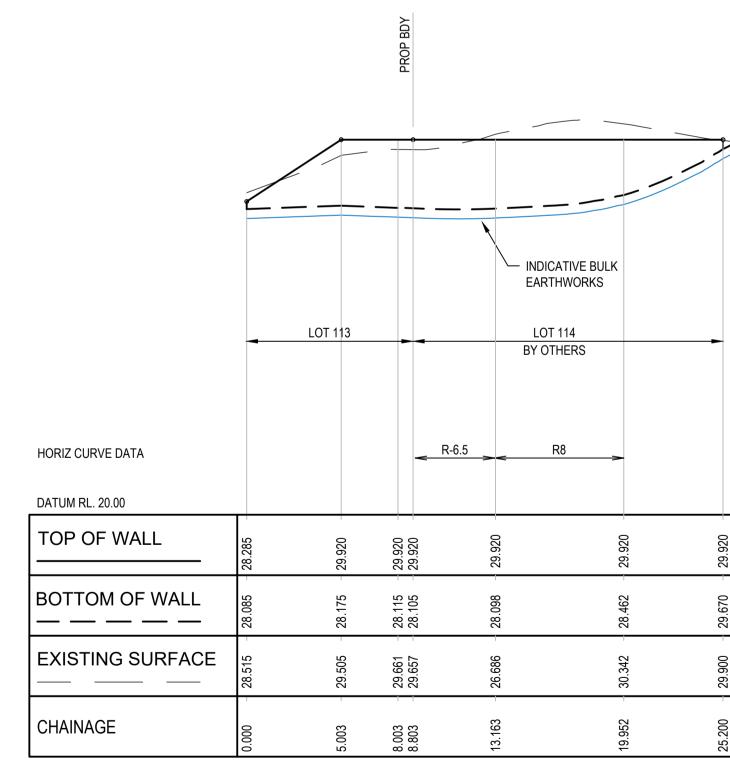


NOTE


REFER STRUCTURAL DRAWINGS FOR ALL DETAILS
RELATING TO RETAINING WALLS

RETAINING WALL - RETW04

			SCALES	CLIENT	DESIGNED	PROJECT	STATUS	
<u>σ</u>			V 1:100	1	G. BROWNING	CULLEN-BIDDLE RESIDENCE	FOR APPROVAL	
き B ISSUED FOR APPROVAL	GB G	A 01/05/24	APPLIN ——— CONSULTING H 1:200 0 2 4 6 8 1	KIM CULLEN & NEIL BIDDLE	Divivii	12 MURPHY STREET (LOT 113 PTD2094)	SCALE (AT FULL SIZE)	SIZE
်င္ကို A PRELIMINARY ISSUE	GB G	A 13/03/24		TI	G. BROWNING	TITLE	1:200H / 1:100V	A1
REV DESCRIPTION	DRN AF	PP DATE	M 0414 768 109 E greg@applinconsulting.com.au		CHECKED	RETAINING WALLS	DRAWING NUMBER	REVISION
THIS DRAWING IS COPYRIGHT AND THE PROPERTY OF APPLIN CONSULTING. IT MUST	CERTIFICATIO	N RPEQ			CHECKED		24002 0044	D
ONLY BE USED BY THE NOMINATED CLIENT AND BY ANY PERSON WHO HAS BEEN AGREED TO BY APPLIN CONSULTING FOR THE PURPOSE FOR WHICH IT WAS PREPARED FOR.	G. APPLIN	6073			G. APPLIN	LONGITUDINAL SECTION	24003-C011	B

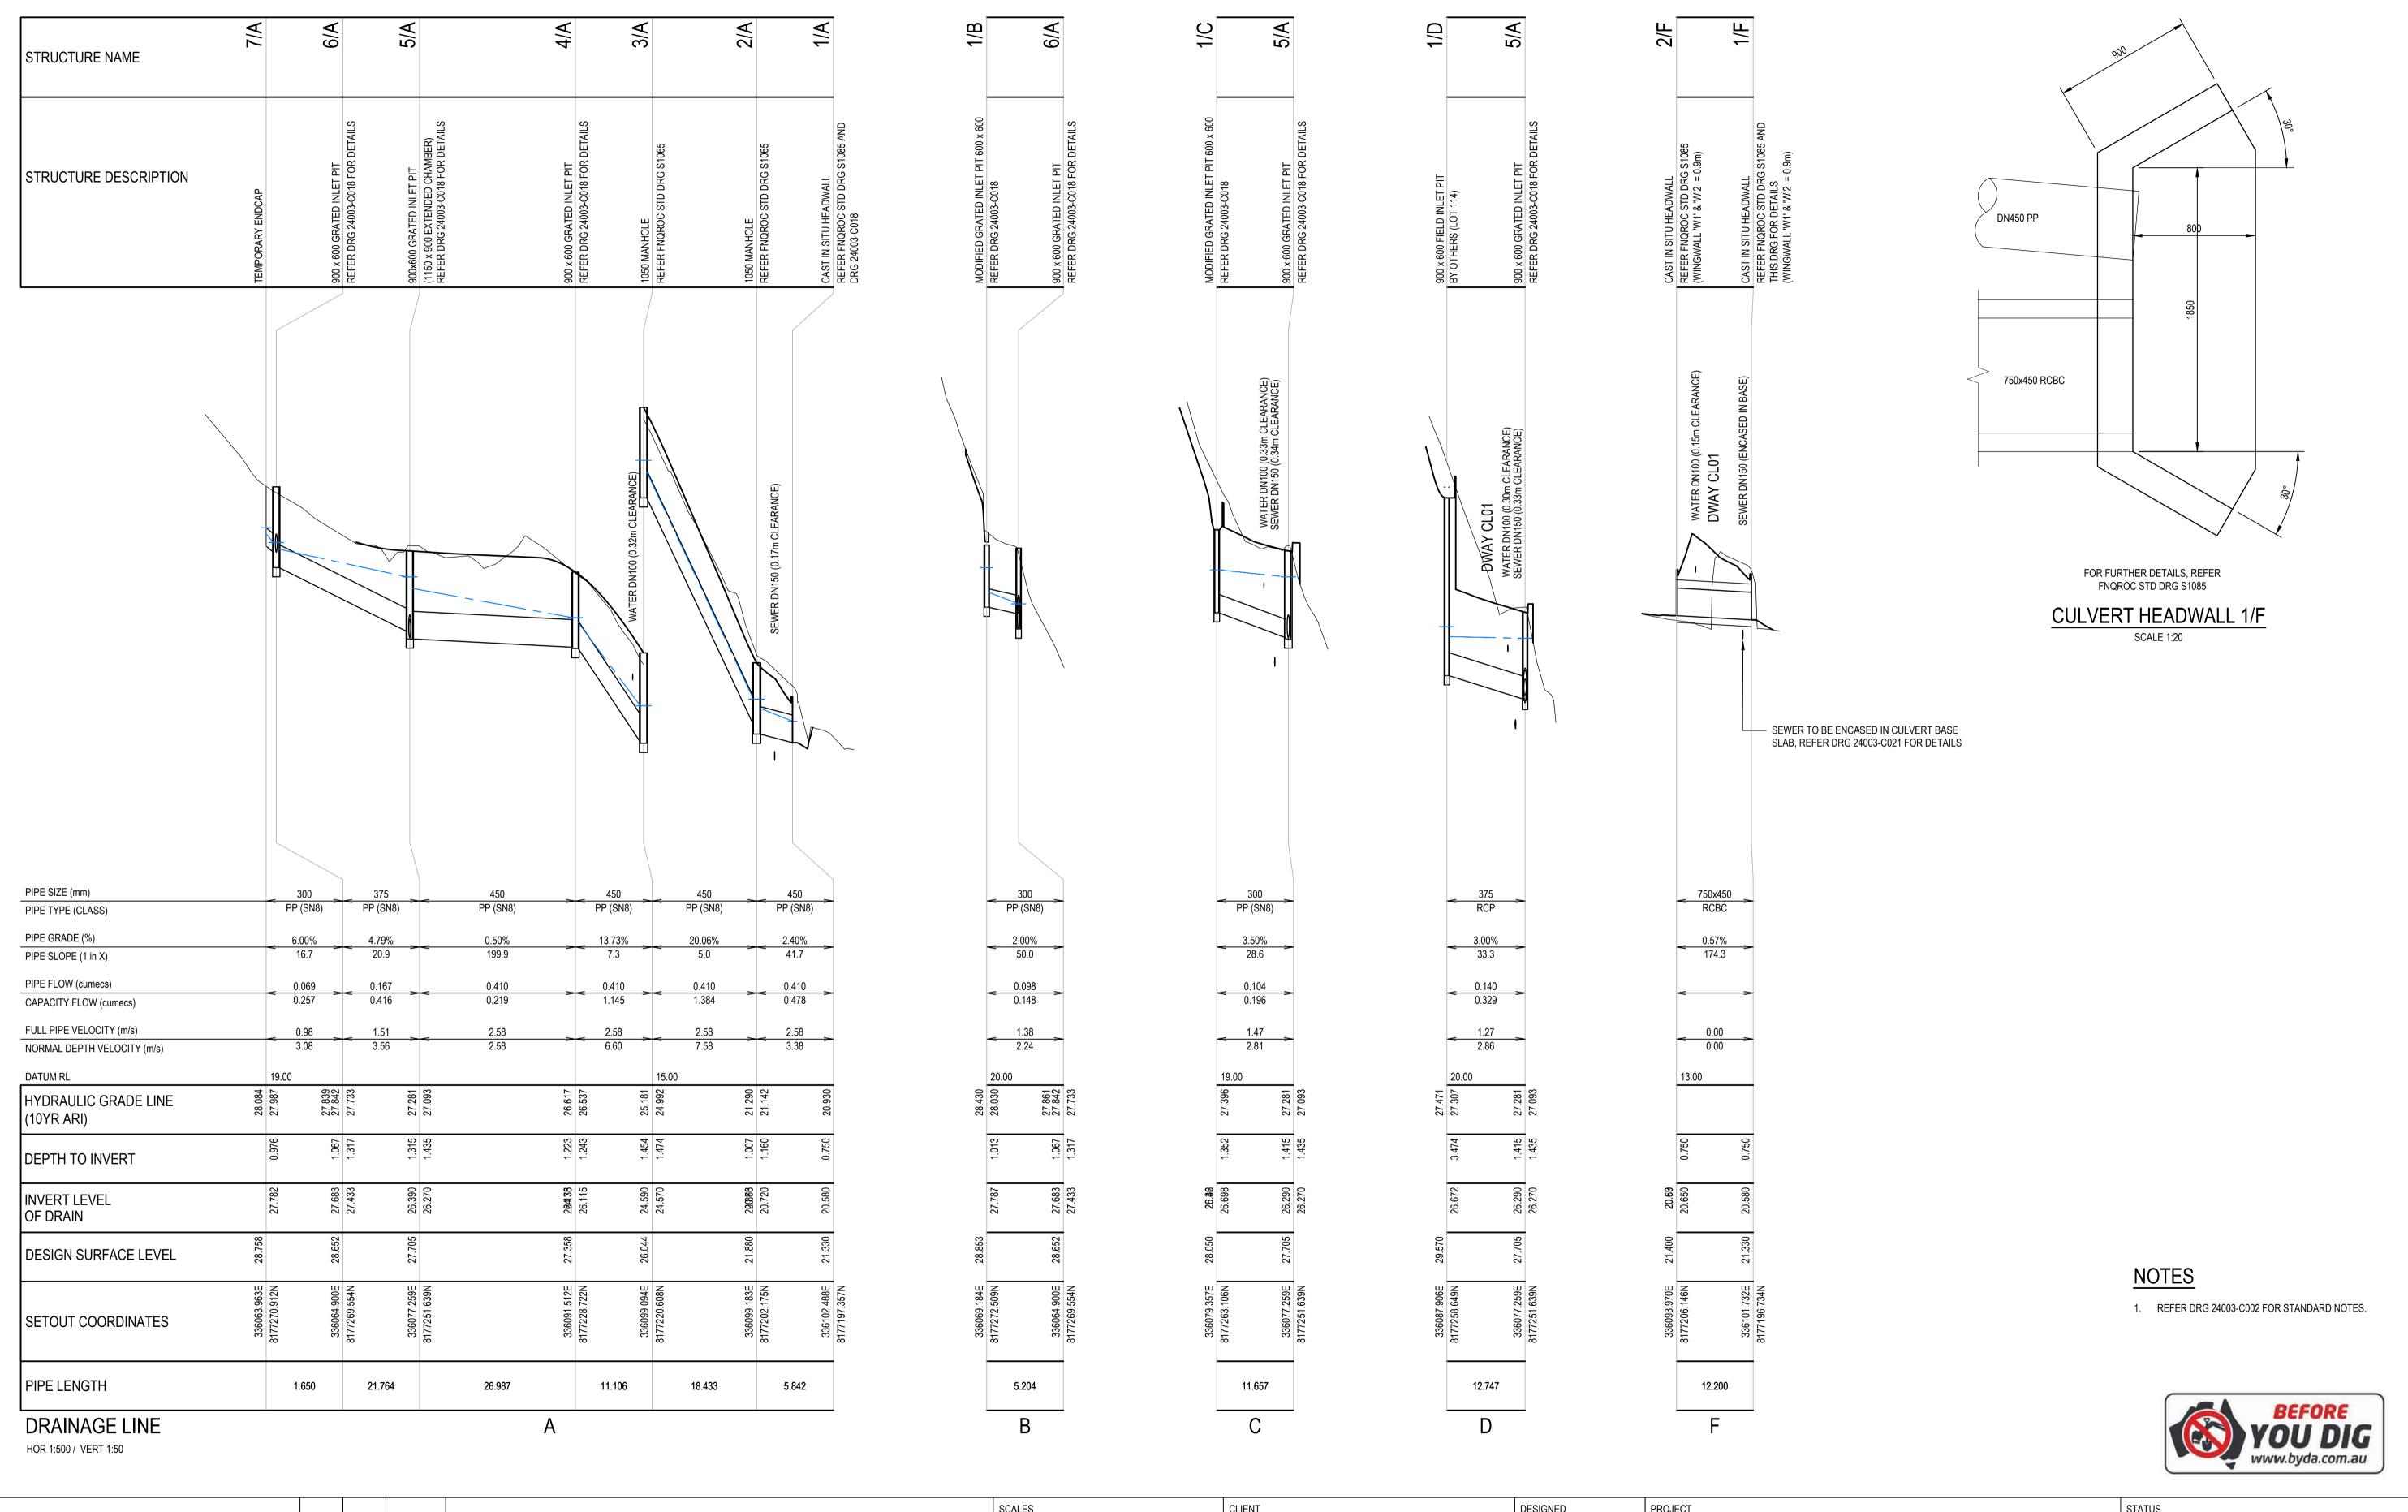


						V 1:50 0 0.5 1 1.5 2 2.5m	CLIENT	G. BROWNING	CULLEN-BIDDLE RESIDENCE	FOR APPROVAL	
3-C012.dw	ISSUED FOR APPROVAL PRELIMINARY ISSUE	GB GB	GA GA	01/05/24 13/03/24	APPLIN — CONSULTING	H 1:500 0 5 10 15 20 25m	KIM CULLEN & NEIL BIDDLE	DRAWN G. BROWNING	12 MURPHY STREET (LOT 113 PTD2094)	SCALE (AT FULL SIZE) 1:500H / 1:50V	SIZE A1
CAD File: 24003	THIS DRAWING IS COPYRIGHT AND THE PROPERTY OF APPLIN CONSULTING. IT MUST ONLY BE USED BY THE NOMINATED CLIENT AND BY ANY PERSON WHO HAS BEEN AGREED TO BY APPLIN CONSULTING FOR THE PURPOSE FOR WHICH IT WAS PREPARED FOR.	DRN CERTIFICA G. APPL		DATE RPEQ 6073	M 0414 768 109 E greg@applinconsulting.com.au			CHECKED G. APPLIN	STORMWATER LONGITUDINAL SECTIONS	DRAWING NUMBER 24003-C012	REVISION

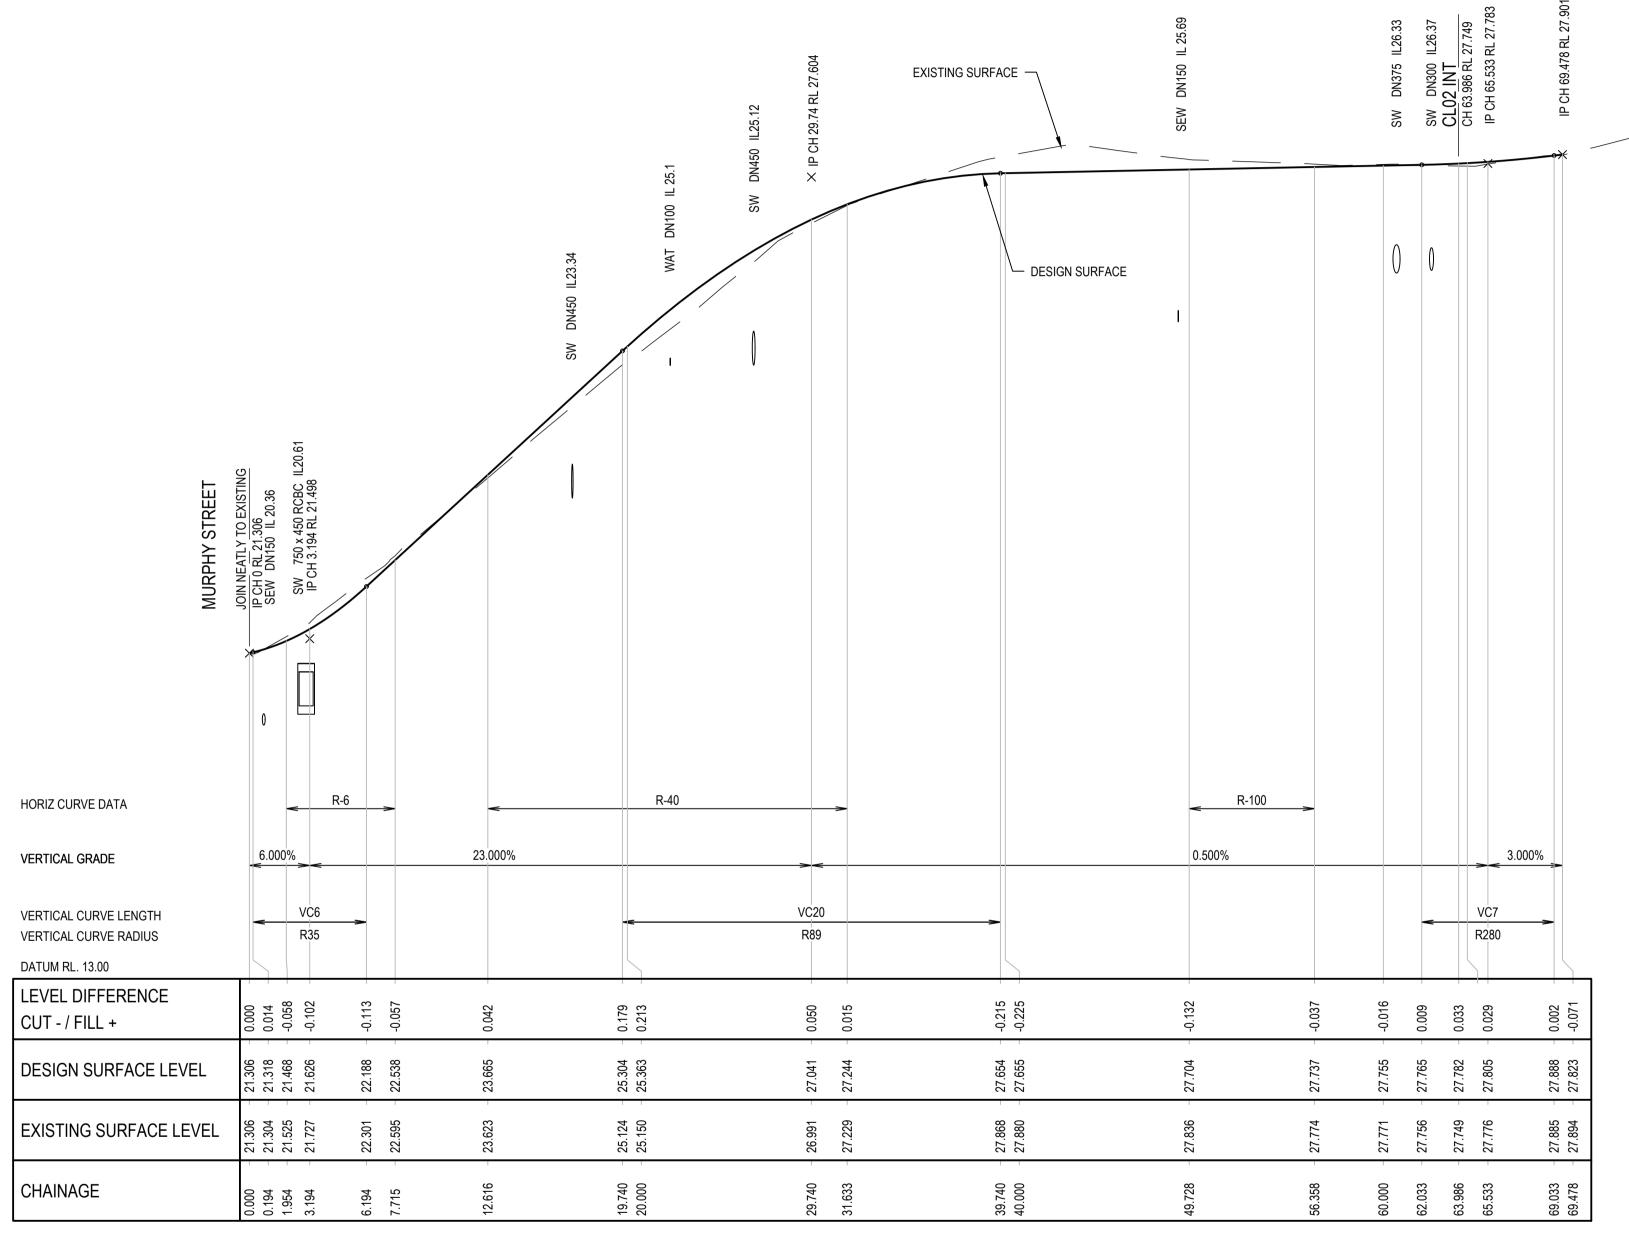


LONGITUDINAL SECTION - DRIVEWAY CL01

HORZ 1:200 / VERT 1:50

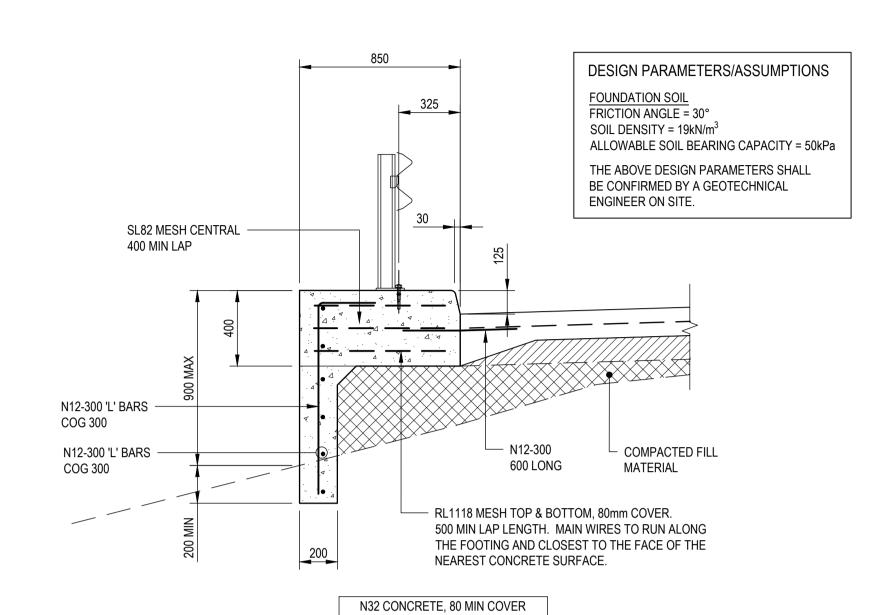

STRIP FOOTING DETAIL SCALE 1:20

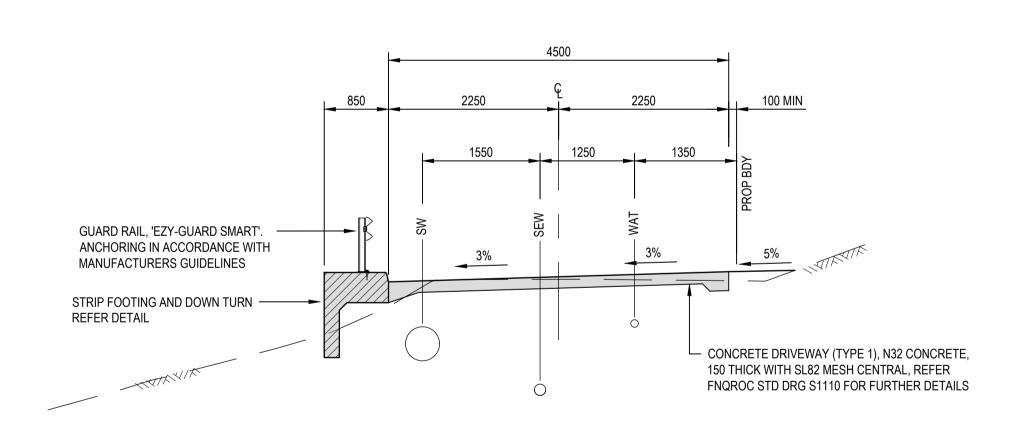


DRIVEWAY CL01 (SHARED ACCESS) TYPE SECTION SCALE 1:50

NOTES


- 1. REFER DRG 24003-C002 FOR STANDARD NOTES.
- 2. REFER DRG 24003-C015 FOR DRIVEWAY CROSS SECTIONS.



					SCALES 0 0.5 1.0 1.5 2.0 2.5m V 1:50	CLIENT	DESIGNED G. BROWNING	CULLEN-BIDDLE RESIDENCE	FOR APPROVAL	
3-C013.dw	ISSUED FOR APPROVAL A PRELIMINARY ISSUE	GB GA	01/05/24 13/03/24	APPLIN ——— CONSULTING	H 1:200 0 2 4 6 8 10m	KIM CULLEN & NEIL BIDDLE	DRAWN G. BROWNING	12 MURPHY STREET (LOT 113 PTD2094)	SCALE (AT FULL SIZE) AS SHOWN	SIZE A1
3AD File: 2400)	THIS DRAWING IS COPYRIGHT AND THE PROPERTY OF APPLIN CONSULTING. IT MUST ONLY BE USED BY THE NOMINATED CLIENT AND BY ANY PERSON WHO HAS BEEN AGREED TO BY APPLIN CONSULTING FOR THE PURPOSE FOR WHICH IT WAS PREPARED FOR.	DRN APP CERTIFICATION G. APPLIN	DATE RPEQ 6073	M 0414 768 109 E greg@applinconsulting.com.au	1:50 0 0.5 1.0 1.5 2.0 2.5m		CHECKED G. APPLIN	DRIVEWAY CL01 - LONGITUDINAL AND TYPE SECTION	DRAWING NUMBER 24003-C013	REVISION

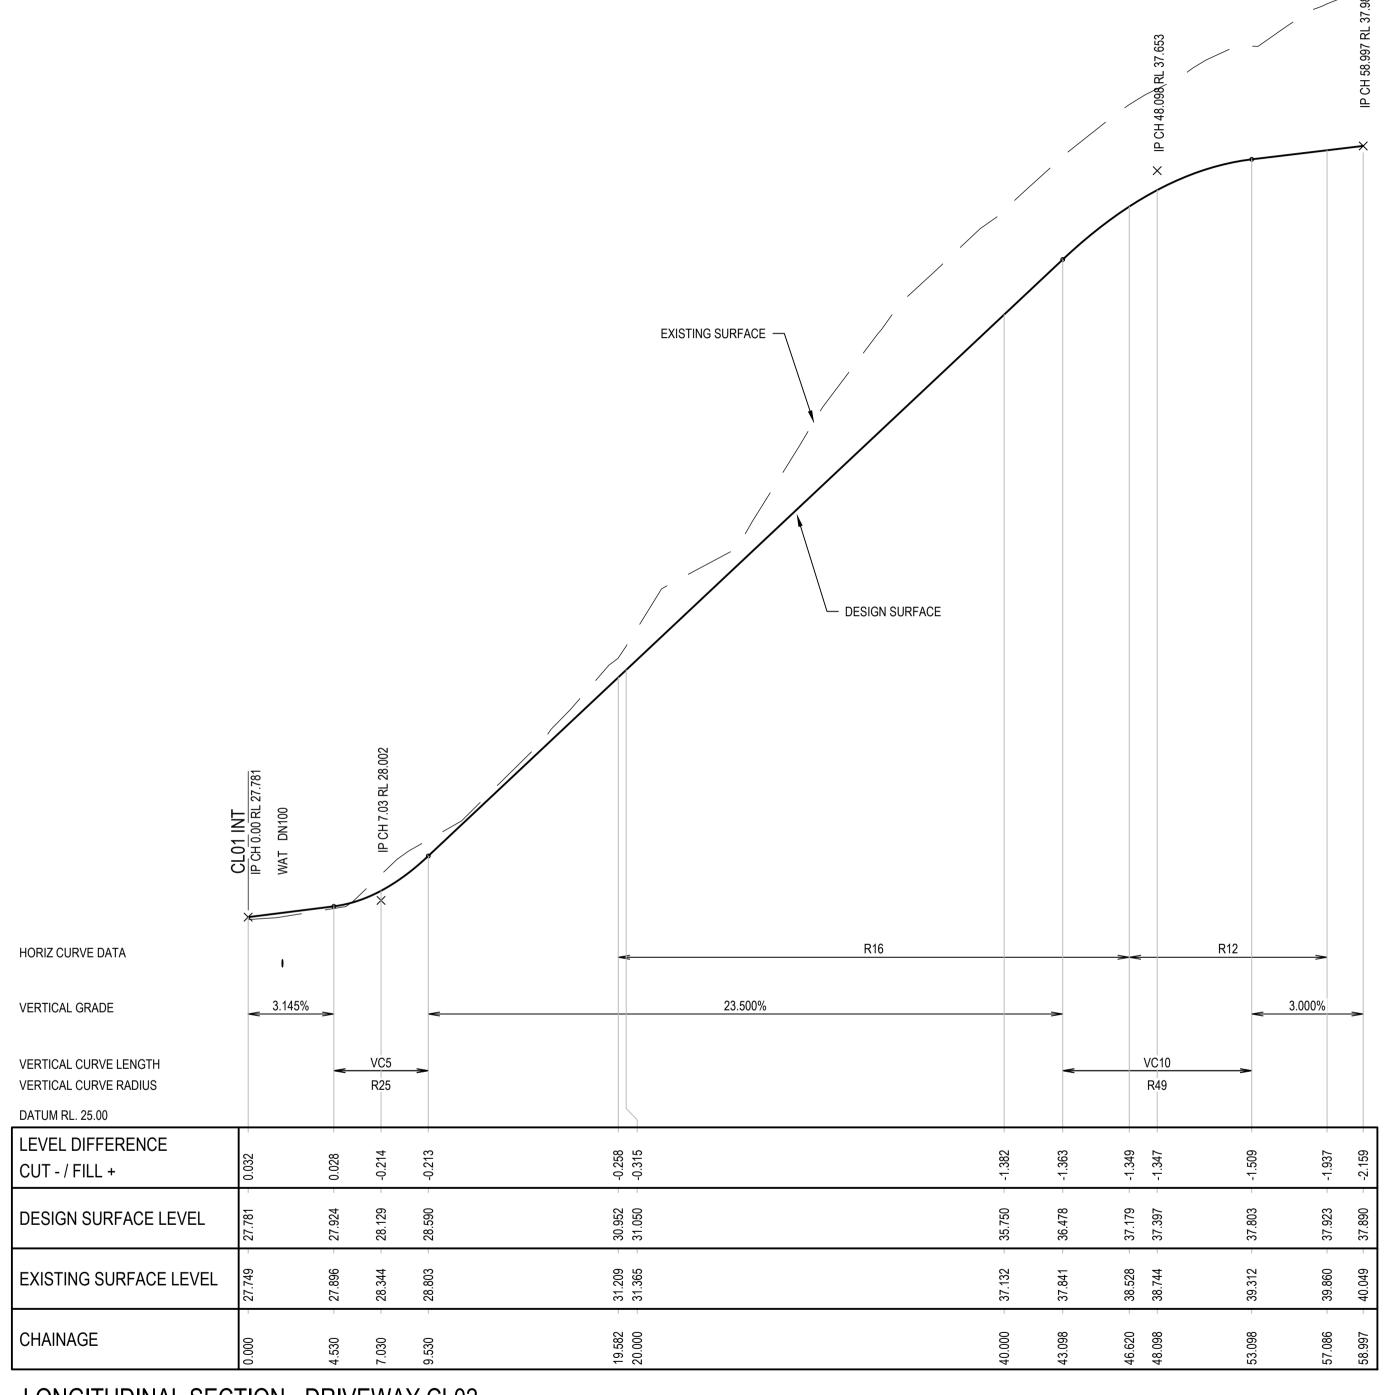

LONGITUDINAL SECTION - DRIVEWAY CL02
HORZ 1:200 / VERT 1:50

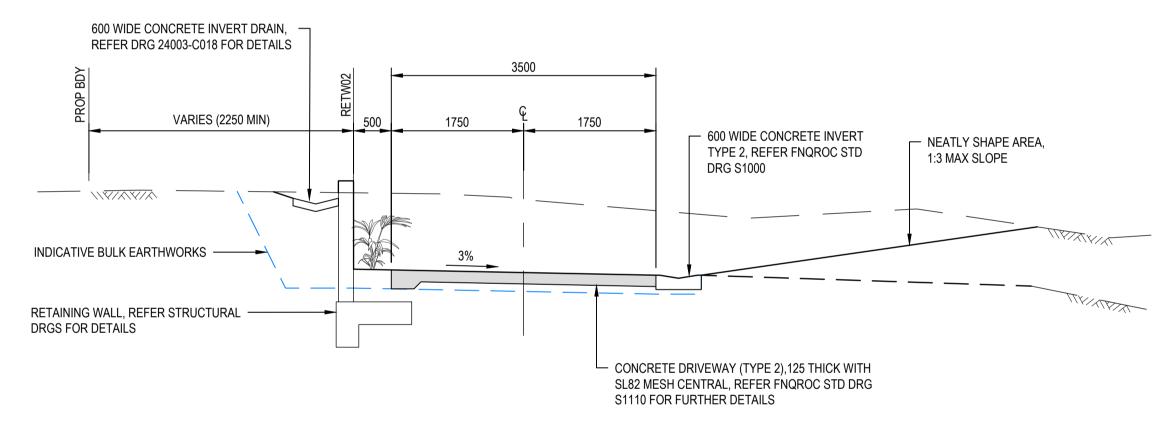


DRIVEWAY CL02 (LOT113) TYPE SECTION SCALE 1:50

NOTES


- 1. REFER DRG 24003-C002 FOR STANDARD NOTES.
- 2. REFER DRG 24003-C016 FOR DRIVEWAY CROSS SECTIONS.




					SCALES V 1:50 0 0.5 1.0 1.5 2.0 2.5m	CLIENT	DESIGNED G. BROWNING	PROJECT CULLEN-BIDDLE RESIDENCE	FOR APPROVAL	
B ISSUED FOR APPROVAL A PRELIMINARY ISSUE	GB GB	GA GA	01/05/24 13/03/24	APPLIN — CONSULTING	H 1:200 0 2 4 6 8 10m	KIM CULLEN & NEIL BIDDLE	DRAWN G. BROWNING	12 MURPHY STREET (LOT 113 PTD2094)	SCALE (AT FULL SIZE) AS SHOWN	SIZE A1
REV DESCRIPTION THIS DRAWING IS COPYRIGHT AND THE PROPERTY OF APPLIN CONSULTING. IT MUST ONLY BE USED BY THE NOMINATED CLIENT AND BY ANY PERSON WHO HAS BEEN AGREED TO BY APPLIN CONSULTING FOR THE PLIPPOSE FOR WHICH IT WAS PREPARED FOR	DRN CERTIFICA	APP TION	DATE RPEQ 6073	M 0414 768 109 E greg@applinconsulting.com.au	1:50 0 0.5 1.0 1.5 2.0 2.5m		CHECKED G. APPLIN	DRIVEWAY CL02 - LONGITUDINAL AND TYPE SECTION	DRAWING NUMBER 24003-C014	REVISION

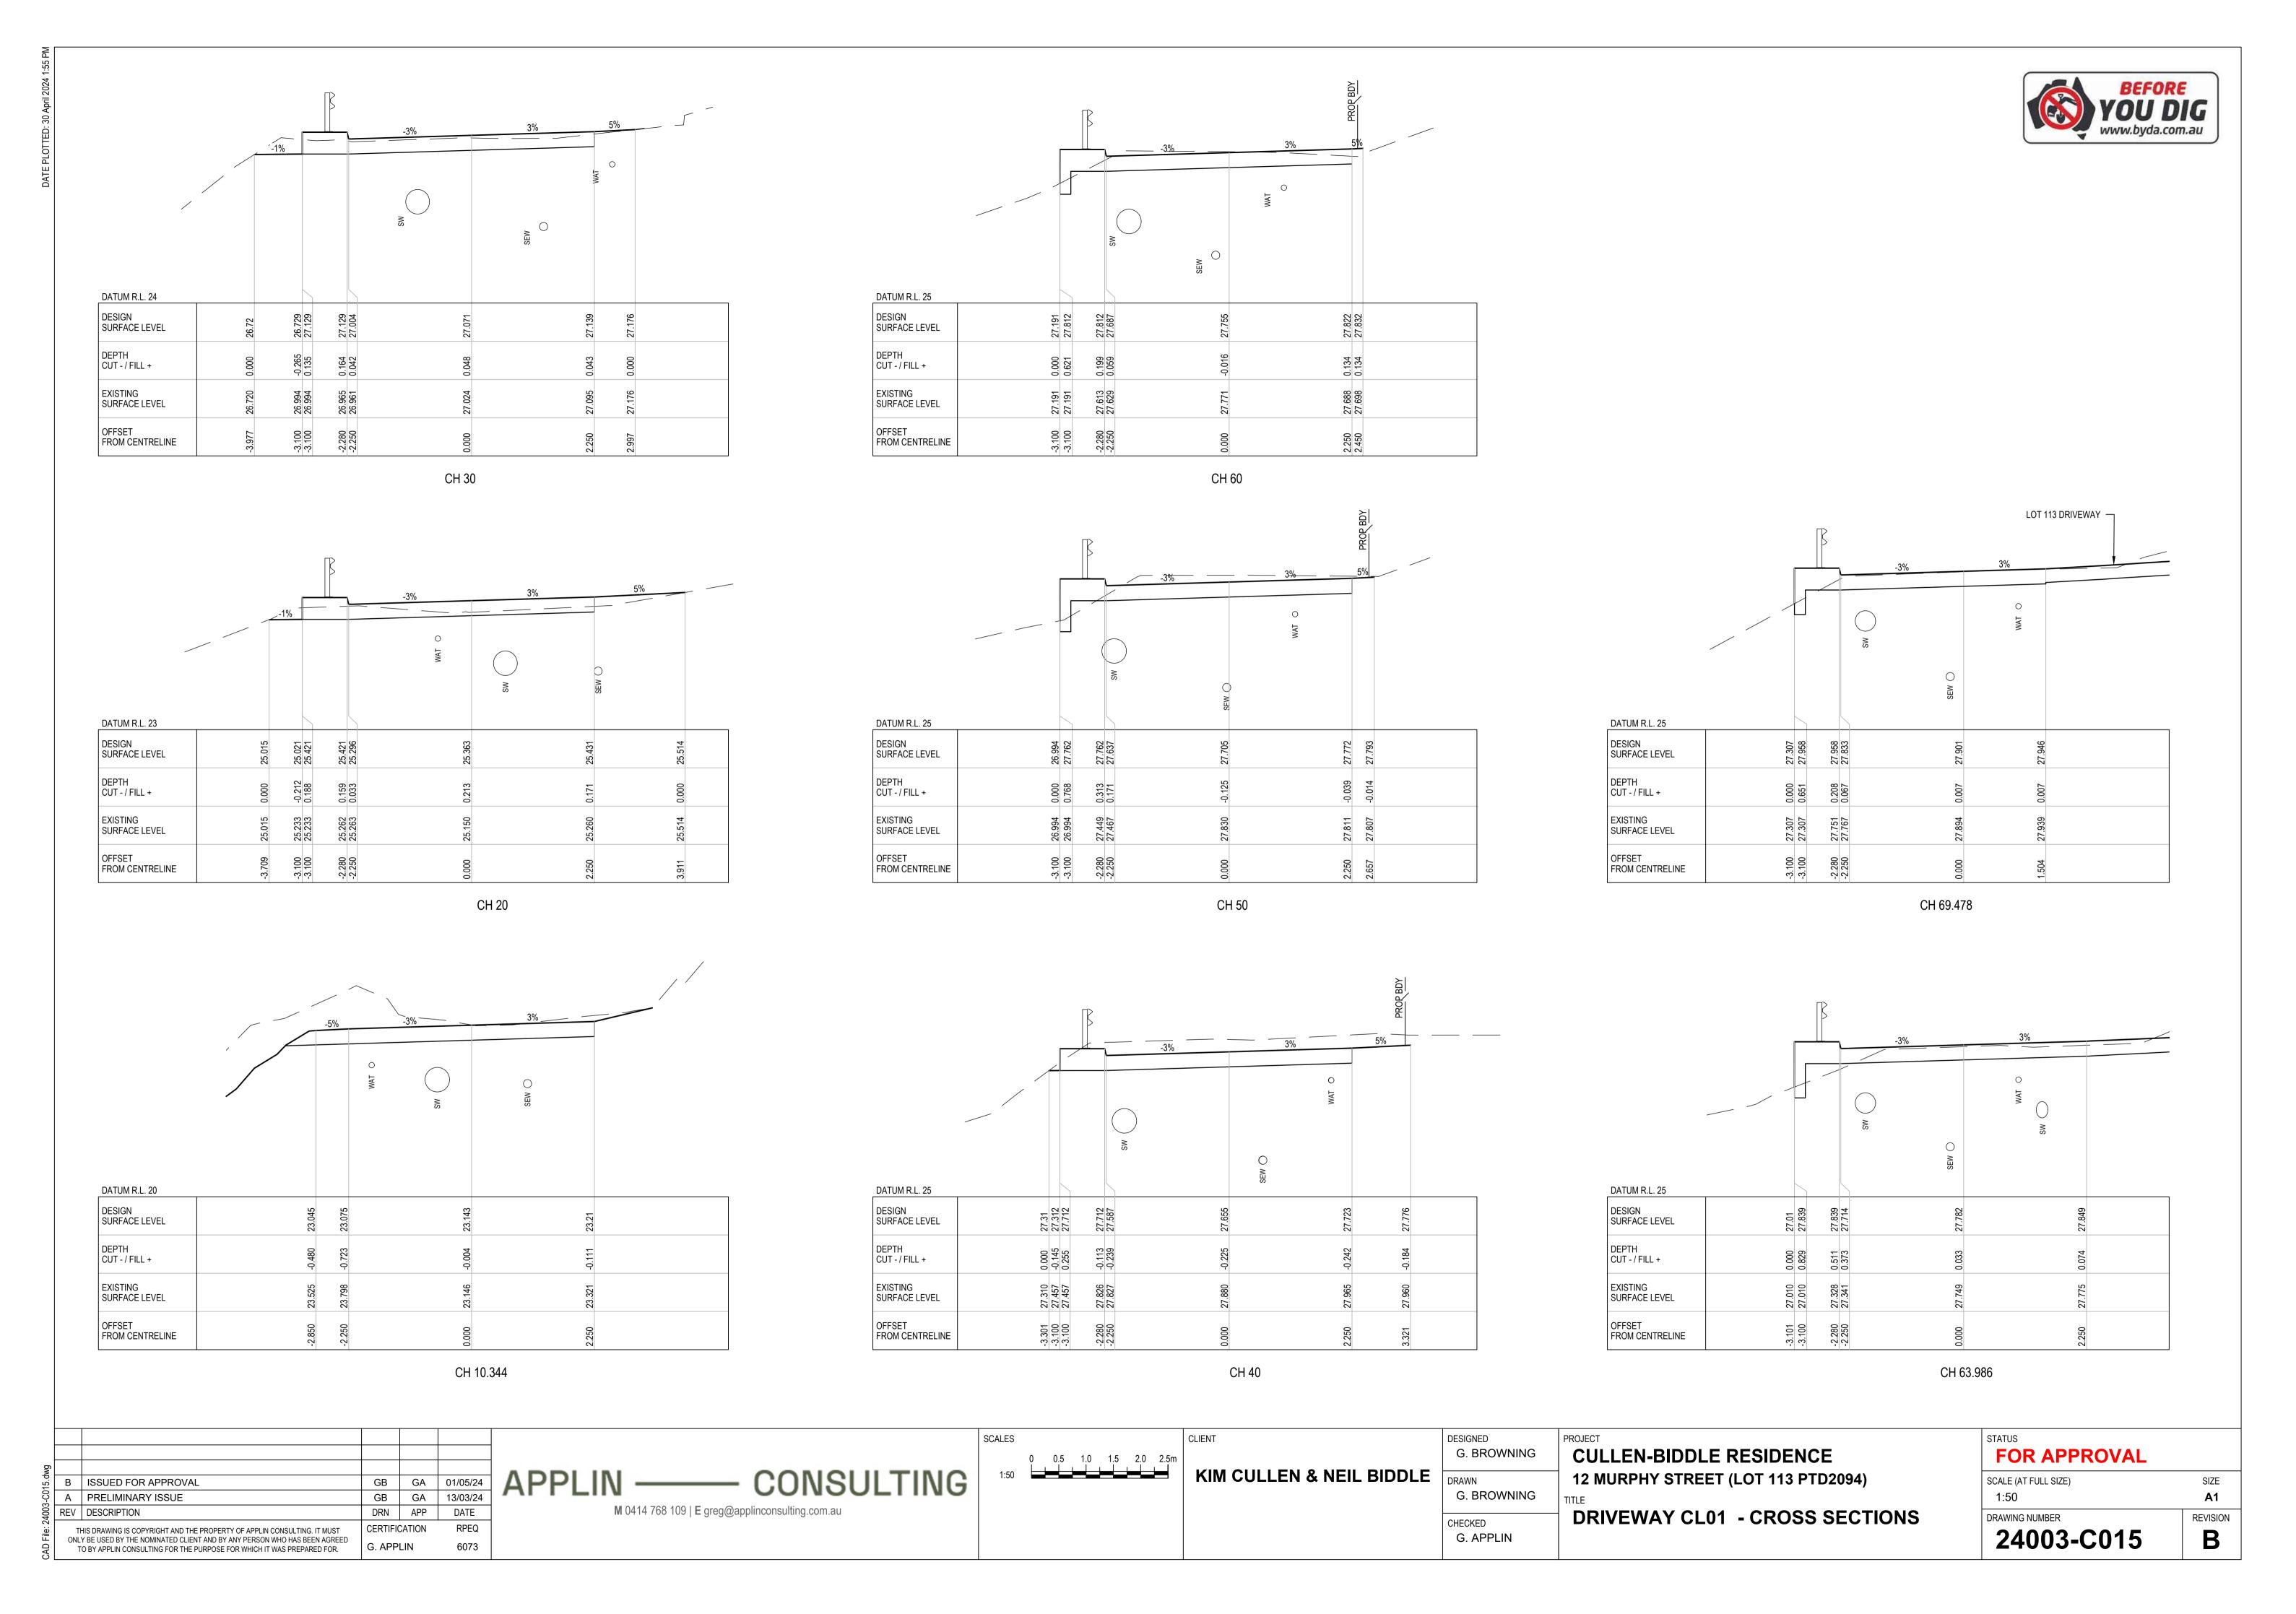



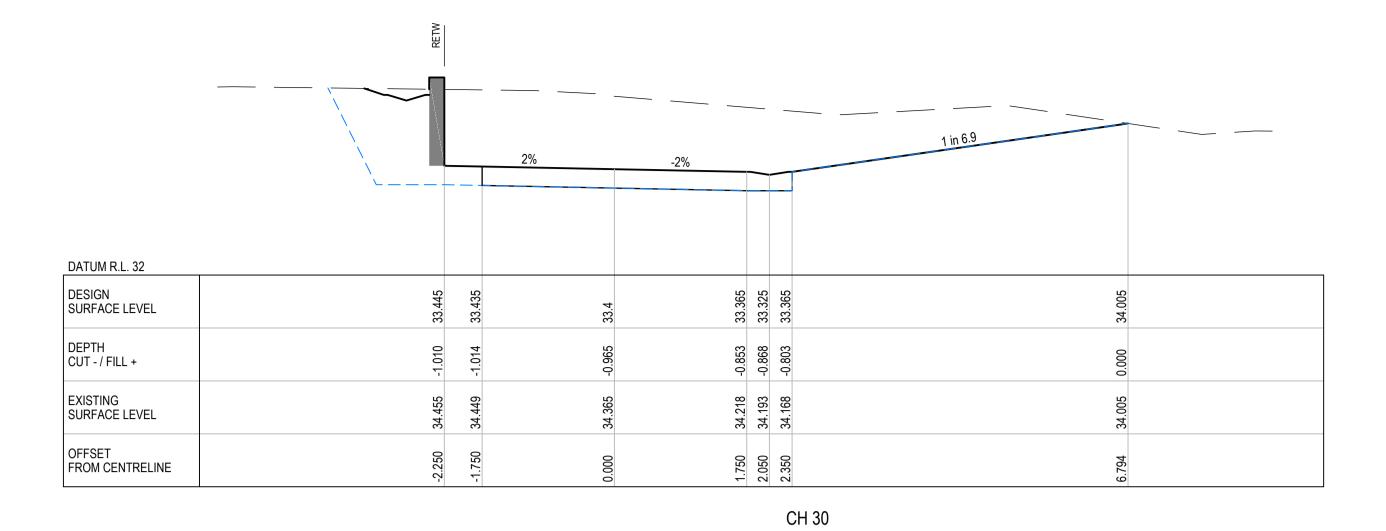


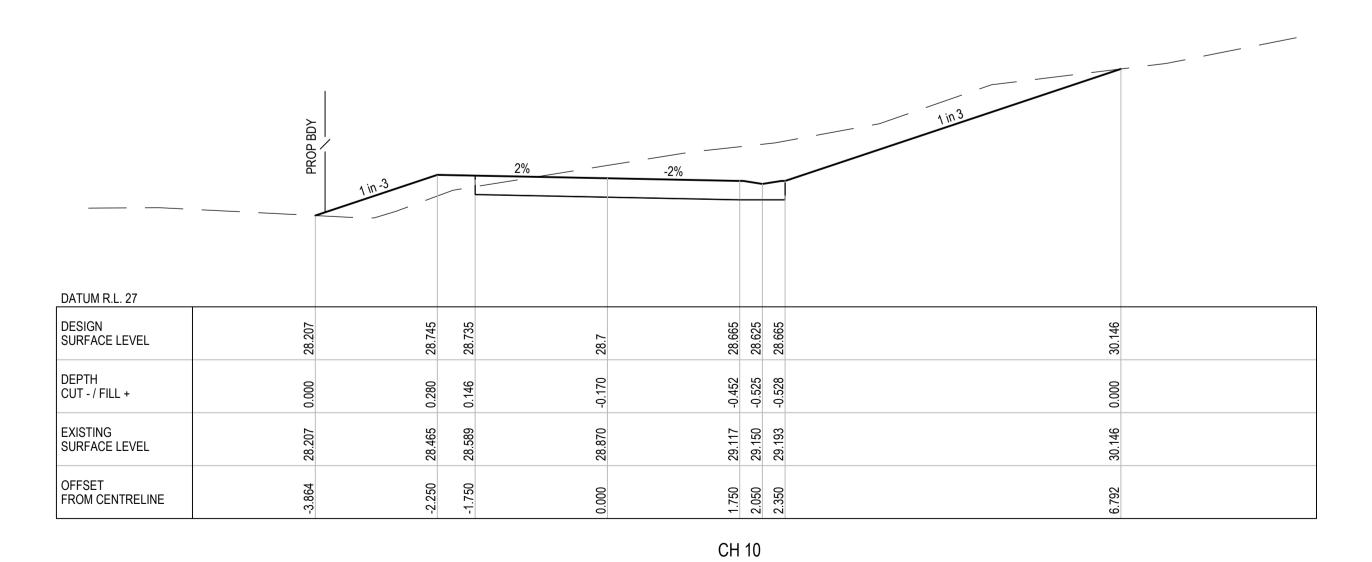

1.750 2.050 2.350

CH 20

	RETW		2%	-2%	-5%	
DATUM R.L. 35 DESIGN SURFACE LEVEL	86	88	1,2	829	x	
	37,698			37.558		
DEPTH CUT - / FILL +	-3.042	-2.874	-1.402	-1.060	0.000	
EXISTING SURFACE LEVEL	40.740	40.562	39.014	38.618	37.380	
OFFSET FROM CENTRELINE	4.337	-3.823	00000	2.675	6.248	

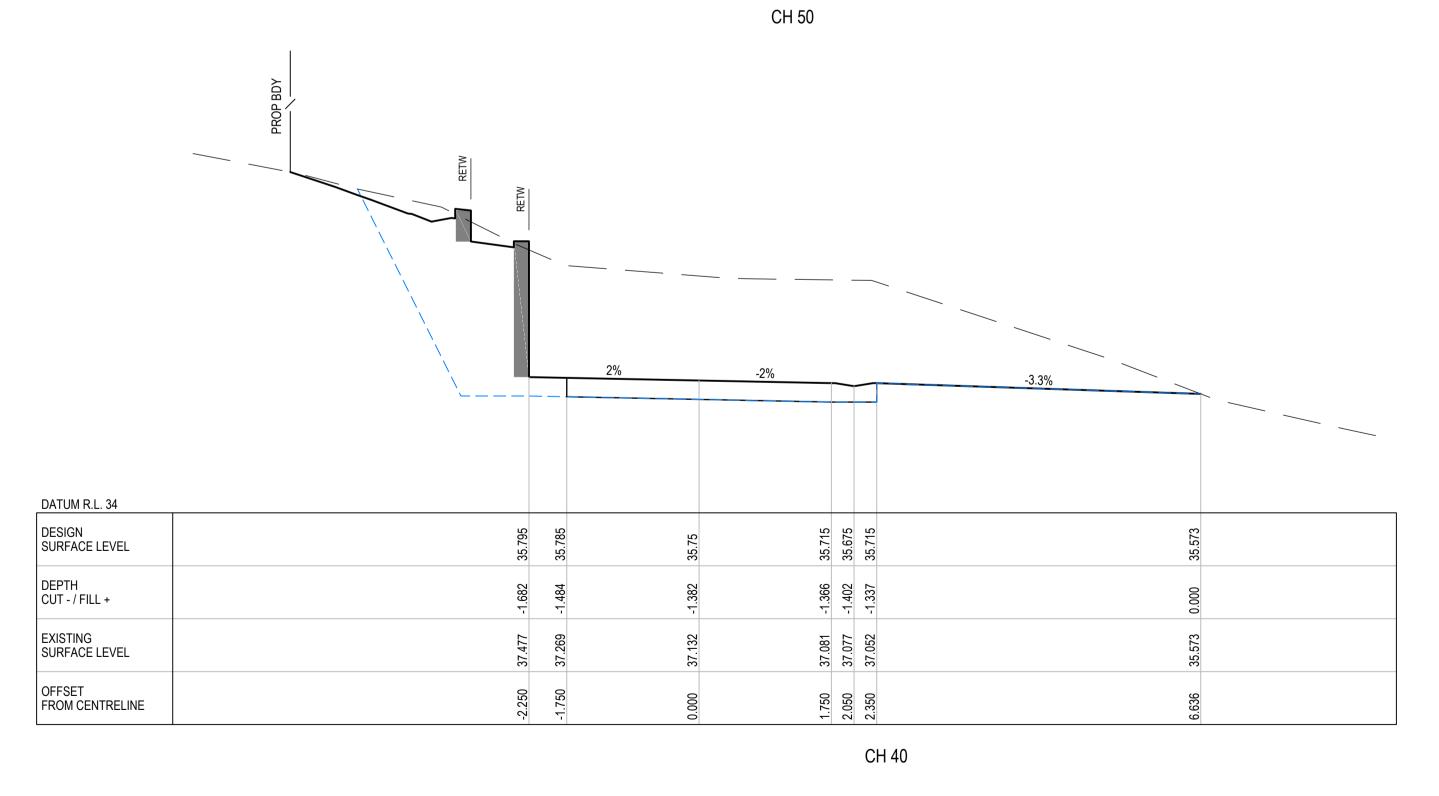


8w					
-C016.dwg	В	ISSUED FOR APPROVAL	GB	GA	01/05/24
File: 24003-C0	Α	PRELIMINARY ISSUE	GB	GA	13/03/24
	REV	DESCRIPTION	DRN	APP	DATE
		HIS DRAWING IS COPYRIGHT AND THE PROPERTY OF APPLIN CONSULTING. IT MUST	CERTIFIC	RPEQ	
9		Y BE USED BY THE NOMINATED CLIENT AND BY ANY PERSON WHO HAS BEEN AGREED O BY APPLIN CONSULTING FOR THE PURPOSE FOR WHICH IT WAS PREPARED FOR	G. APP	6073	

OFFSET FROM CENTRELINE

APPLIN — CONSULTING


M 0414 768 109 | E greg@applinconsulting.com.au

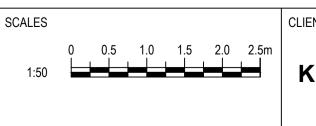


NT	DESIGNED G. BROWNING	PR
IM CULLEN & NEIL BIDDLE	DRAWN G. BROWNING	TIT
	CHECKED G. APPLIN	

PROJECT
CULLEN-BIDDLE RESIDENCE
12 MURPHY STREET (LOT 113 PTD2094)
TITLE
DRIVEWAY CL02 - CROSS SECTIONS

STATUS	
FOR APPROVAL	
SCALE (AT FULL SIZE)	SIZE
1:50	A1
DRAWING NUMBER	REVISION
24003-C016	В

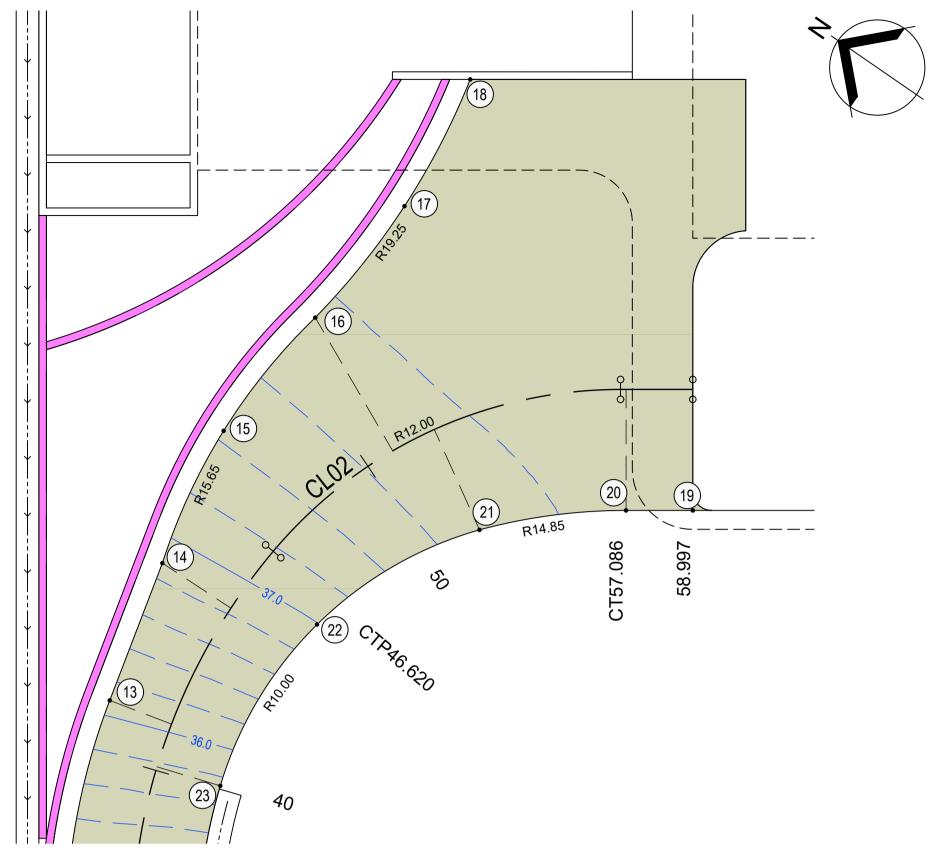


DRIVEWAY CL02 / CARPORT CONNECTION

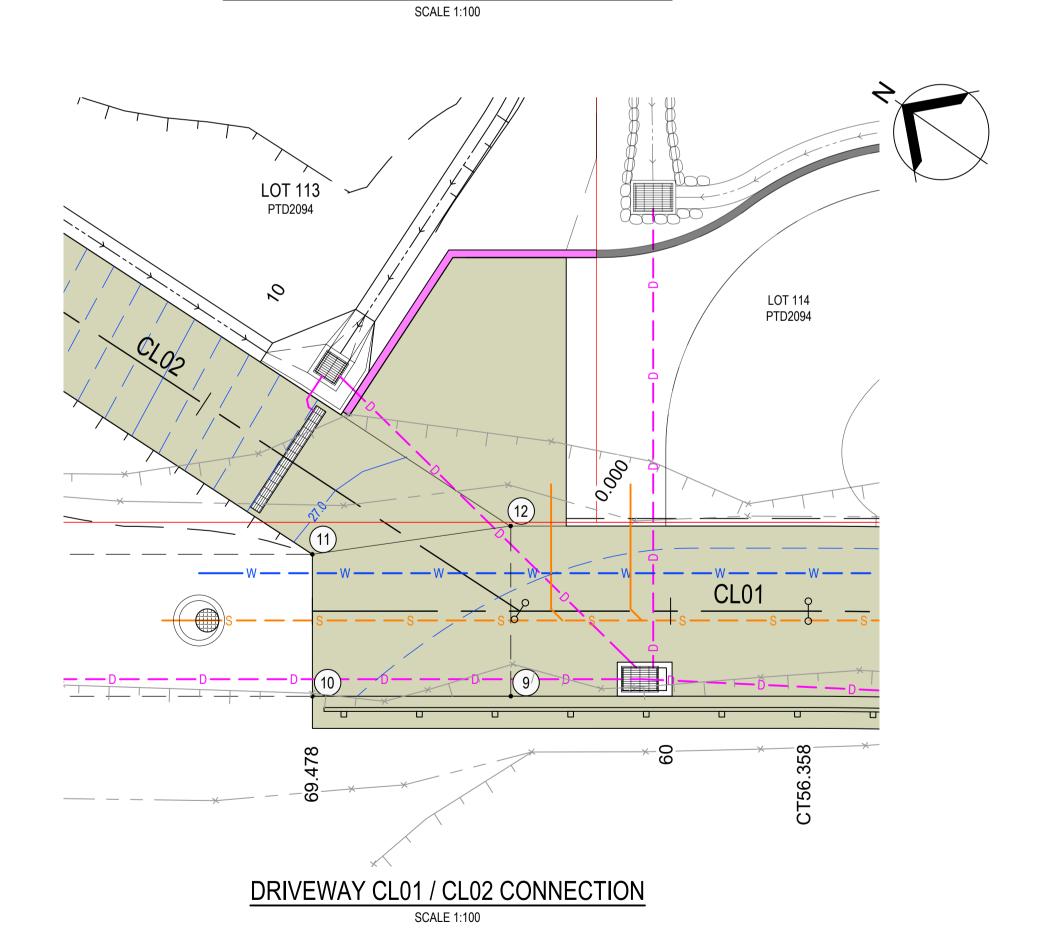

SETOUT POINTS

POINT	EASTING	NORTHING	
1	336091.343	8177205.088	21.347
2	336095.328	8177204.059	21.903
3	336097.536	8177207.532	23.075
4	336102.191	8177205.188	22.638
5	336101.789	8177201.695	21.969
6	336100.203	8177198.557	21.457
7	336099.502	8177196.375	21.264
8	336100.301	8177194.227	21.213
9	336074.906	8177254.258	27.717
10	336071.925	8177258.579	27.834
11	336075.014 8177260.710		27.946
12	336078.610	8177256.819	27.852
13	336088.228	8177292.553	36.089
14	336092.008	8177293.469	36.880
15	336095.807	8177294.122	37.431
16	336099.651	8177293.827	37.758
17	336103.417	8177293.558	37.913
18	336107.164	8177294.029	38.000
19	336101.098	8177282.709	37.978
20	336100.121	8177284.162	37.903
21	336097.496	8177287.063	37.702
22	336092.994	8177289.178	36.990
23	336088.030	8177288.863	35.738

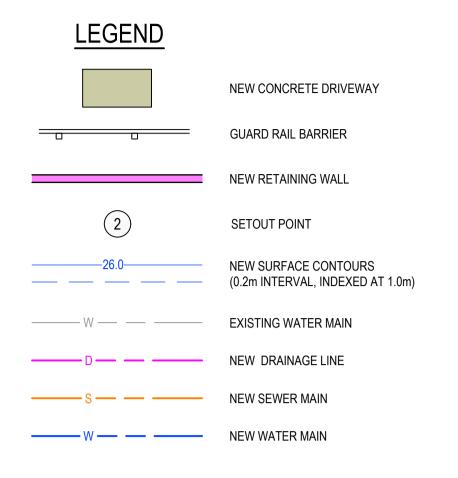

NOTES

- 1. REFER DRG 24003-C002 FOR STANDARD NOTES AND LEGENDS.
- 2. SETOUT POINTS ARE TO EDGE OF CONCRETE.







A	ISSUED FOR APPROVAL PRELIMINARY ISSUE	GB GB	GA GA	01/05/24 13/03/24	APPLIN — CONSULTING	SCALES 0 1 2 3 4 5m 1:100	KIM CULLEN & NEIL BIDDLE	DESIGNED G. BROWNING DRAWN G. BROWNING	CULLEN-BIDDLE RESIDENCE 12 MURPHY STREET (LOT 113 PTD2094) TITLE
REV	DESCRIPTION	DRN	APP	DATE	M 0414 768 109 E greg@applinconsulting.com.au				DRIVEWAY CONNECTIONS
T ONL	THIS DRAWING IS COPYRIGHT AND THE PROPERTY OF APPLIN CONSULTING. IT MUST LY BE USED BY THE NOMINATED CLIENT AND BY ANY PERSON WHO HAS BEEN AGREED TO BY APPLIN CONSULTING FOR THE PURPOSE FOR WHICH IT WAS PREPARED FOR	CERTIFIC G. APP		RPEQ 6073				G. APPLIN	BRIVEWAT CORRECTIONS

STATUS
FOR APPROVAL


SCALE (AT FULL SIZE)
1:100
A1


DRAWING NUMBER


REVISION


В

24003-C017

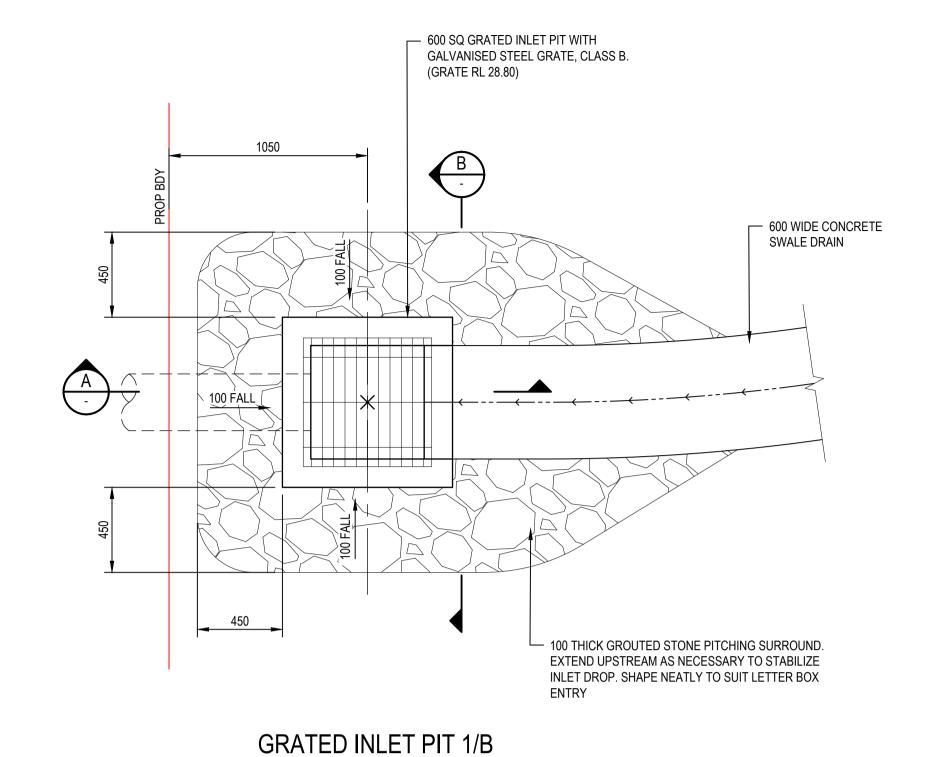


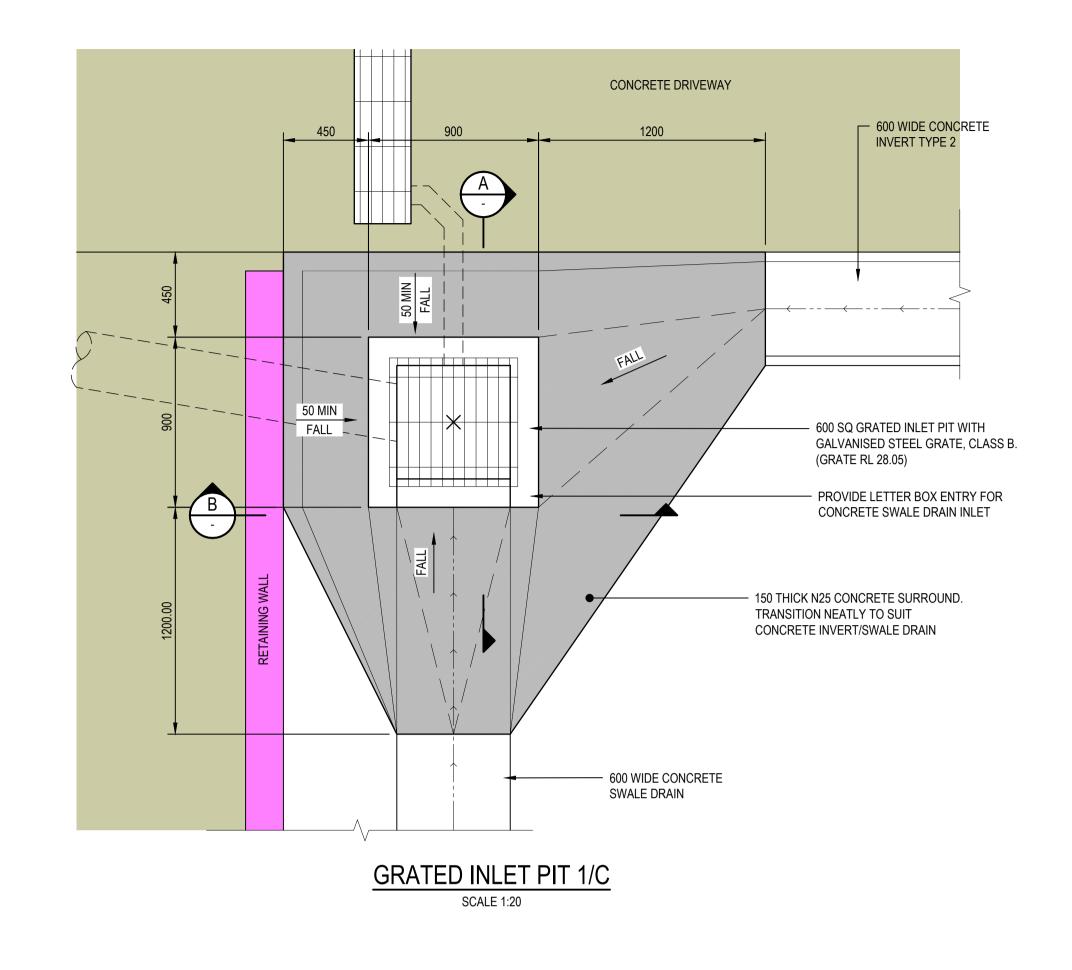

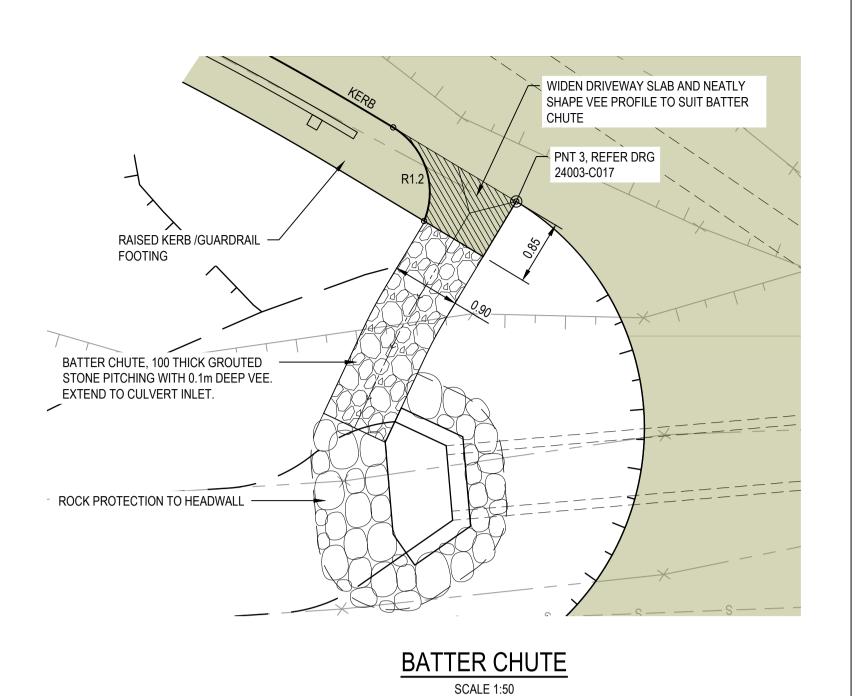

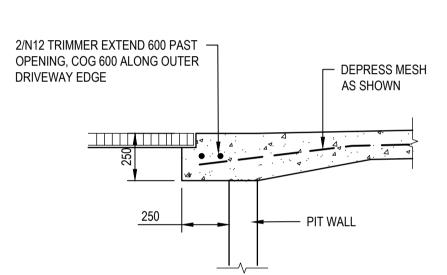


GRATED INLET PIT ROOF SLAB

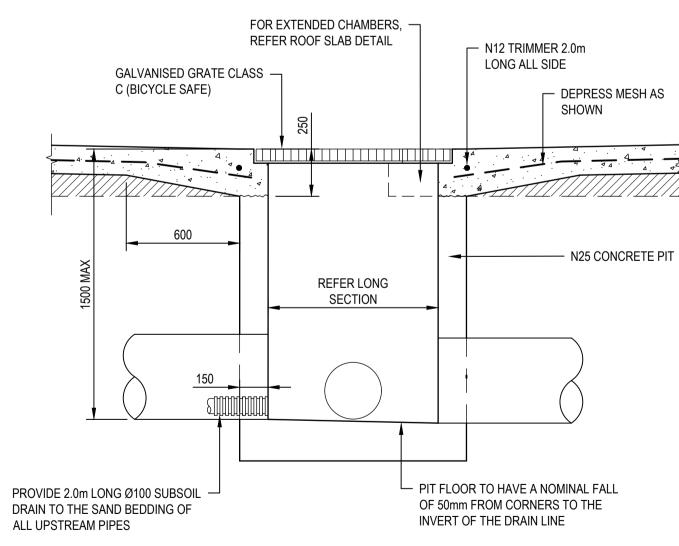



DRIVEWAY GRATED INLET PIT

SCALE 1:20

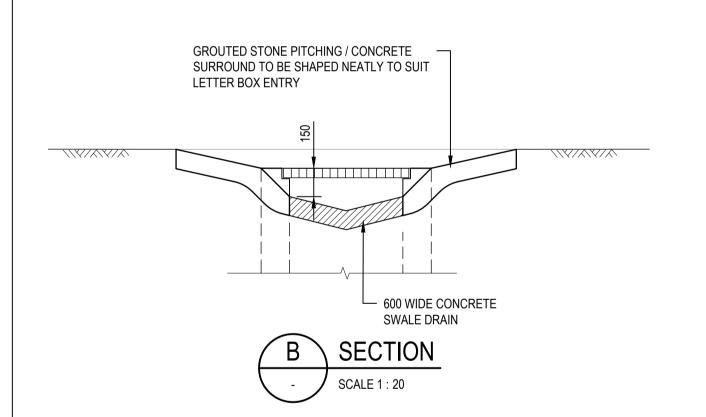

SCALE 1:20

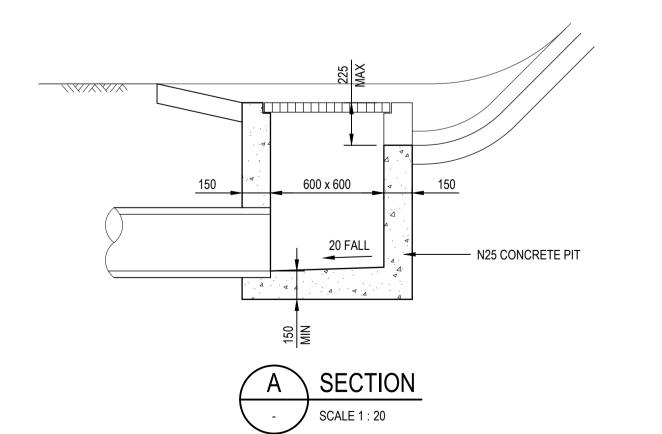

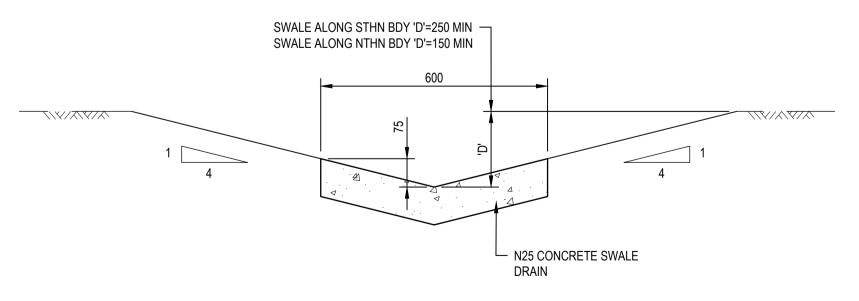


CONCRETE SWALE DRAIN
SCALE 1:10

wg					
-C018.dwg	В	ISSUED FOR APPROVAL	GB	GA	01/05/24
3-C0	Α	PRELIMINARY ISSUE	GB	GA	13/03/24
24003-	REV	DESCRIPTION	DRN	APP	DATE
File: 2	TI	HIS DRAWING IS COPYRIGHT AND THE PROPERTY OF APPLIN CONSULTING. IT MUST	CERTIFICATION		RPEQ
CAD Fi		Y BE USED BY THE NOMINATED CLIENT AND BY ANY PERSON WHO HAS BEEN AGREED O BY APPLIN CONSULTING FOR THE PURPOSE FOR WHICH IT WAS PREPARED FOR.	G. APP	LIN	6073

APPLIN — CONSULTING

M 0414 768 109 | E greg@applinconsulting.com.au

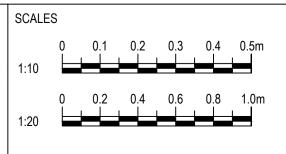

KIM CULLEN & NEIL BIDDLE

CLIENT

DESIGNED G. BROWNING	PRO
DRAWN G. BROWNING	1 TITL
CHECKED G. APPLIN	\

CULLEN-BIDDLE RESIDENCE
12 MURPHY STREET (LOT 113 PTD2094)
TLE

AS SHOWN DRAWING NUMBER		24003-C018
AS SHOWN	D	DRAWING NUMBER
		AS SHOWN
SCALE (AT FULL SIZE)	S	SCALE (AT FULL SIZE)

SIZE A1

REVISION


В


FOR APPROVAL


MISCELLANEOUS DETAILS

DRAWING NUMBER


24003-C018

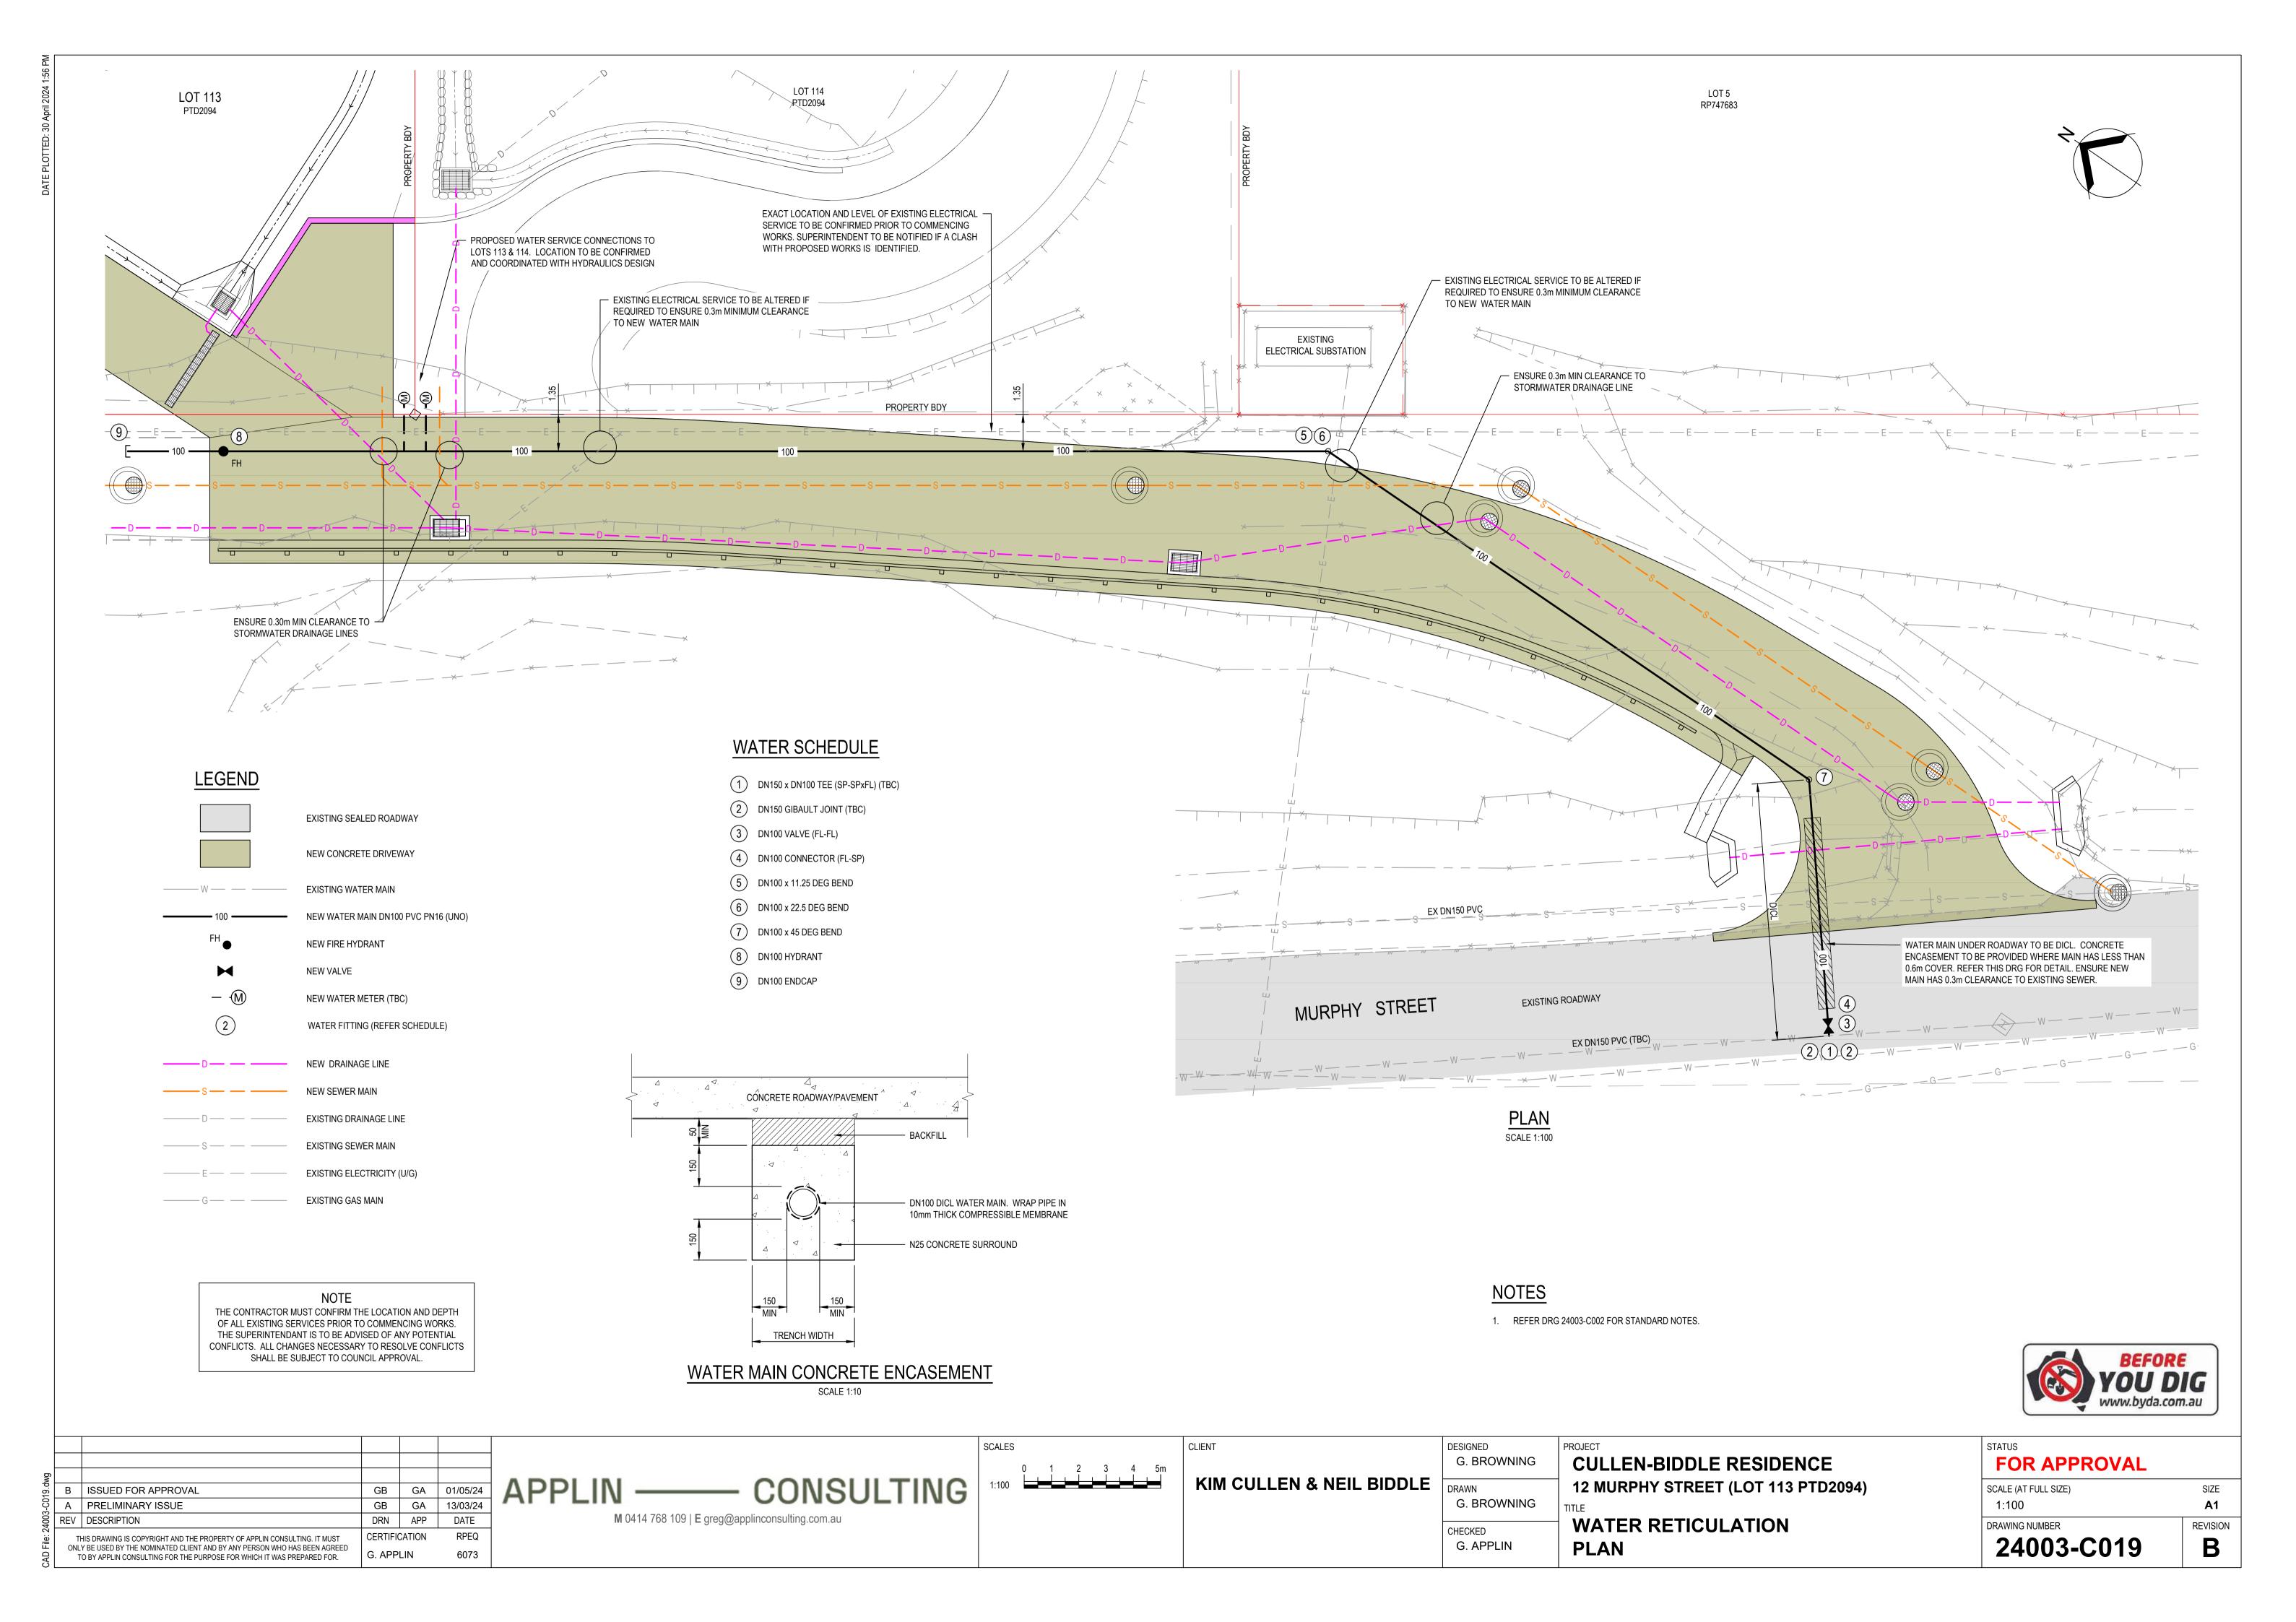

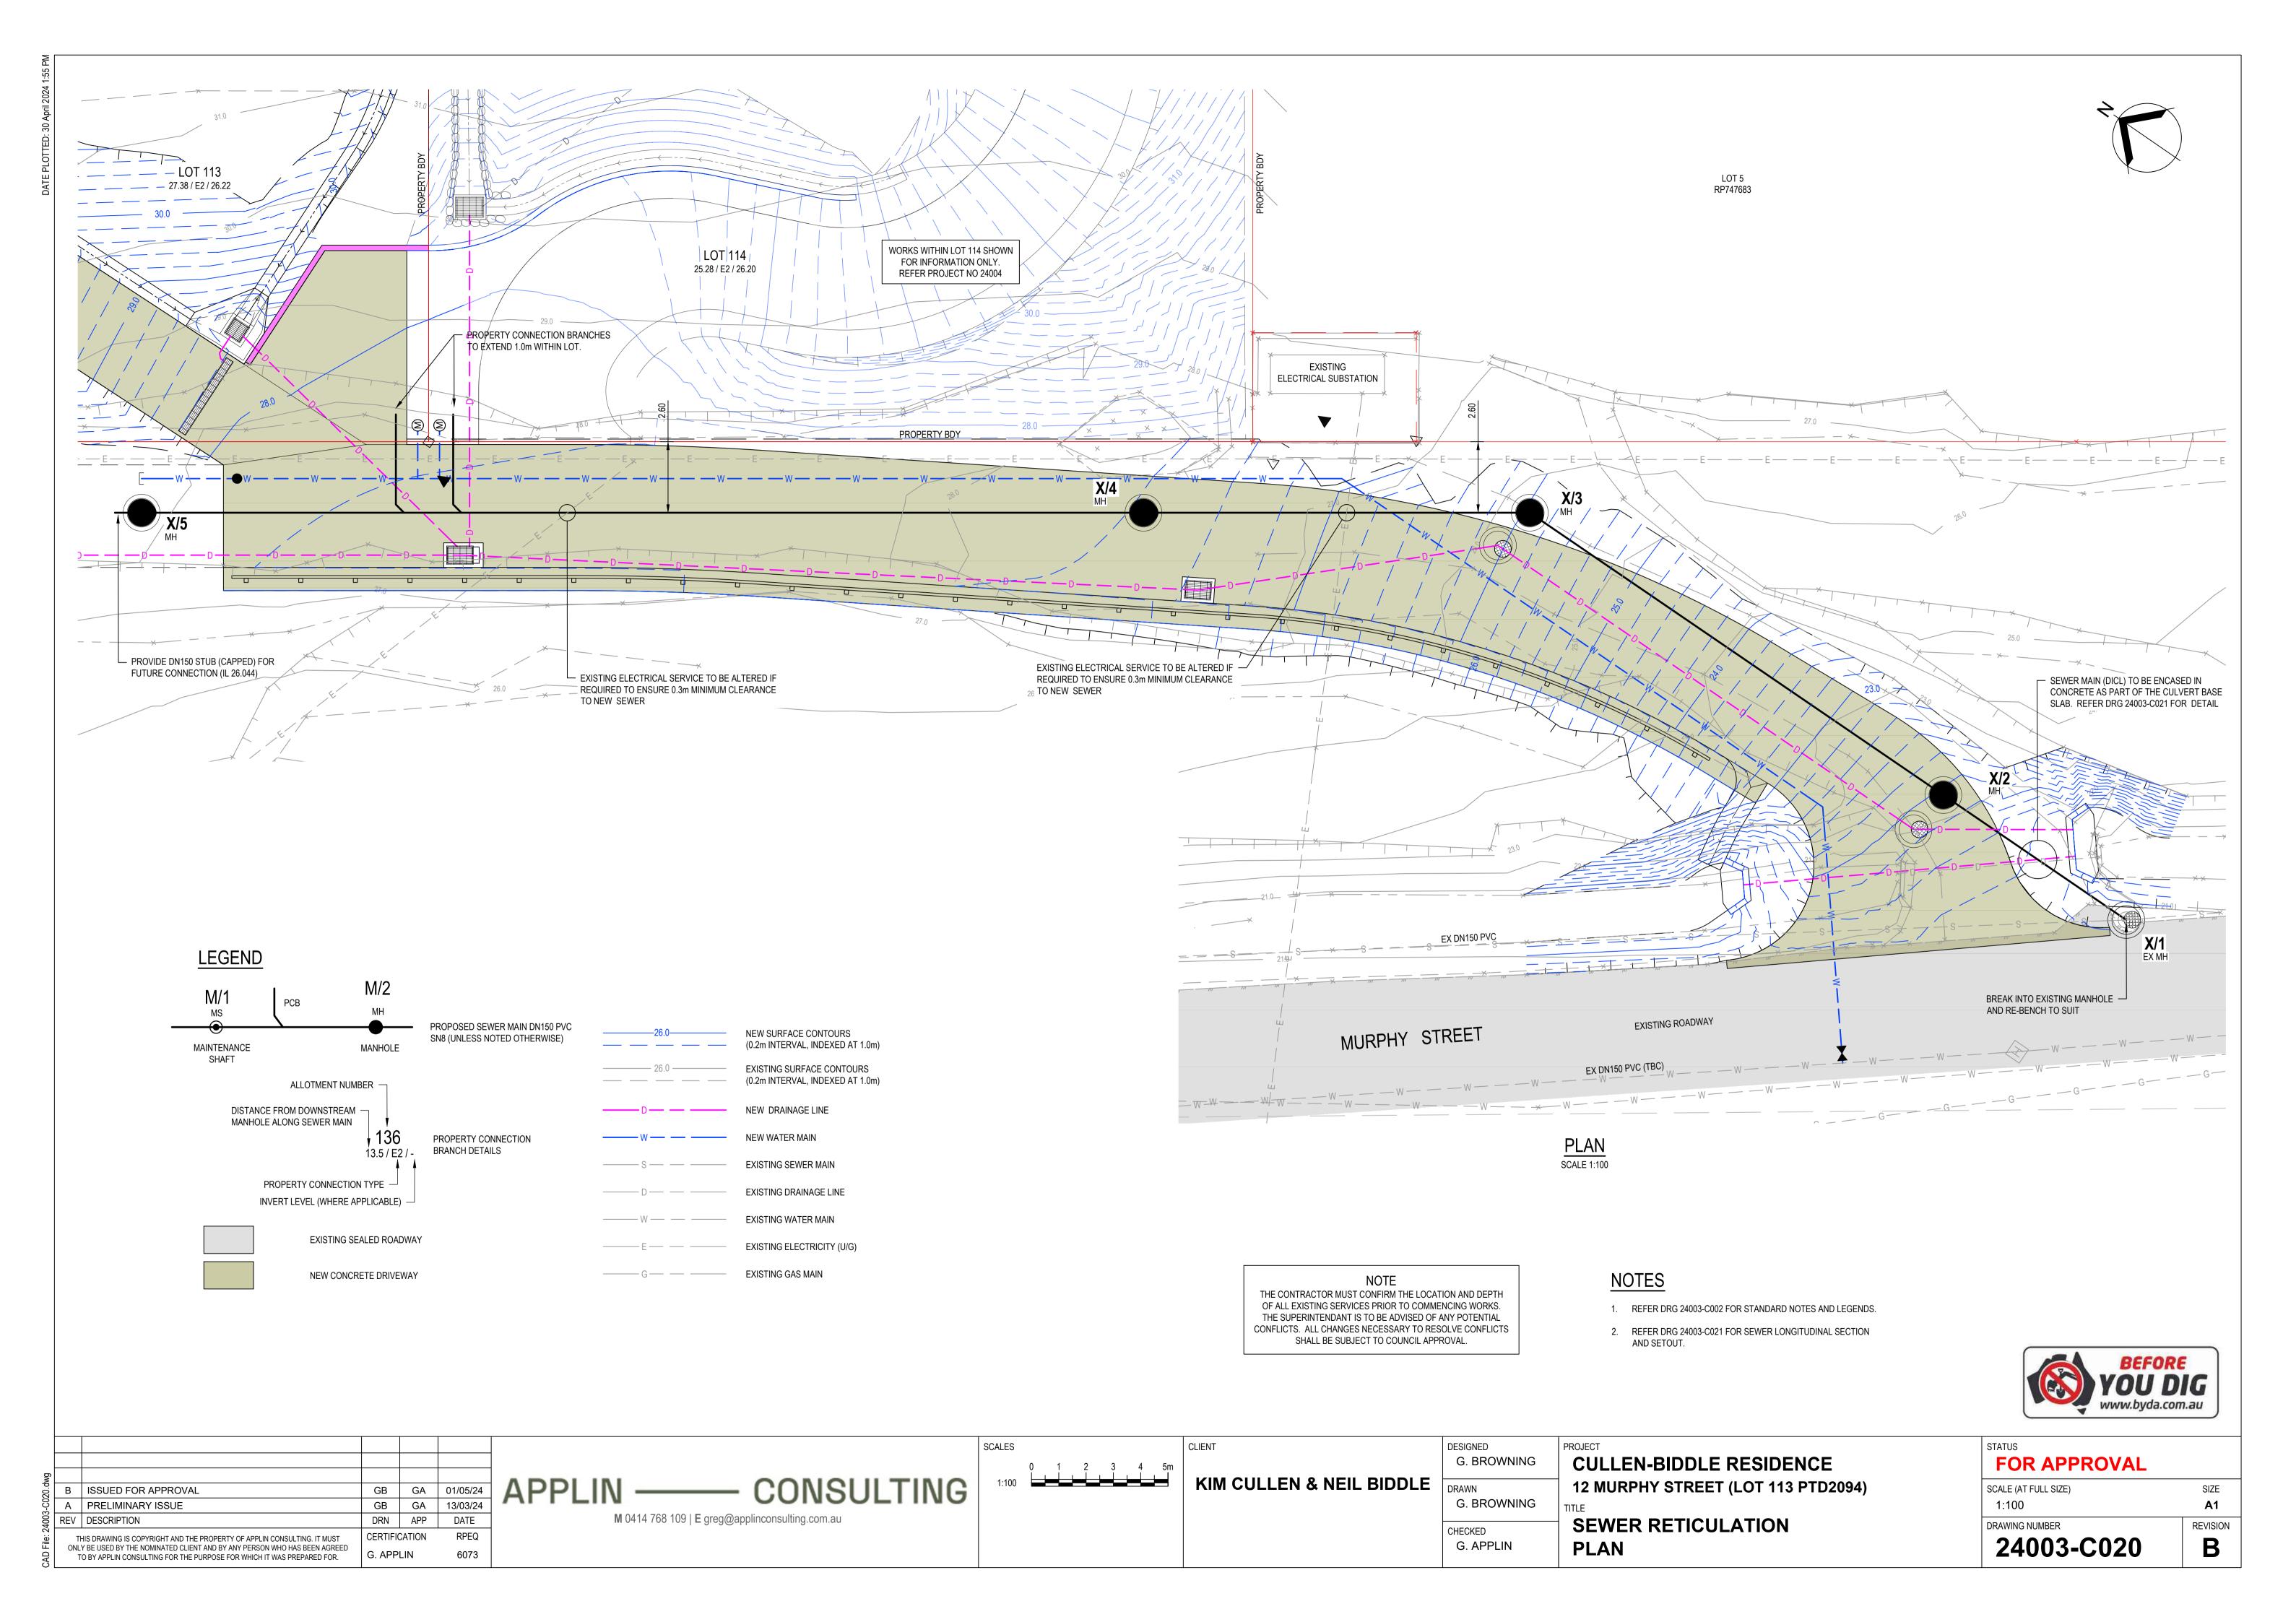

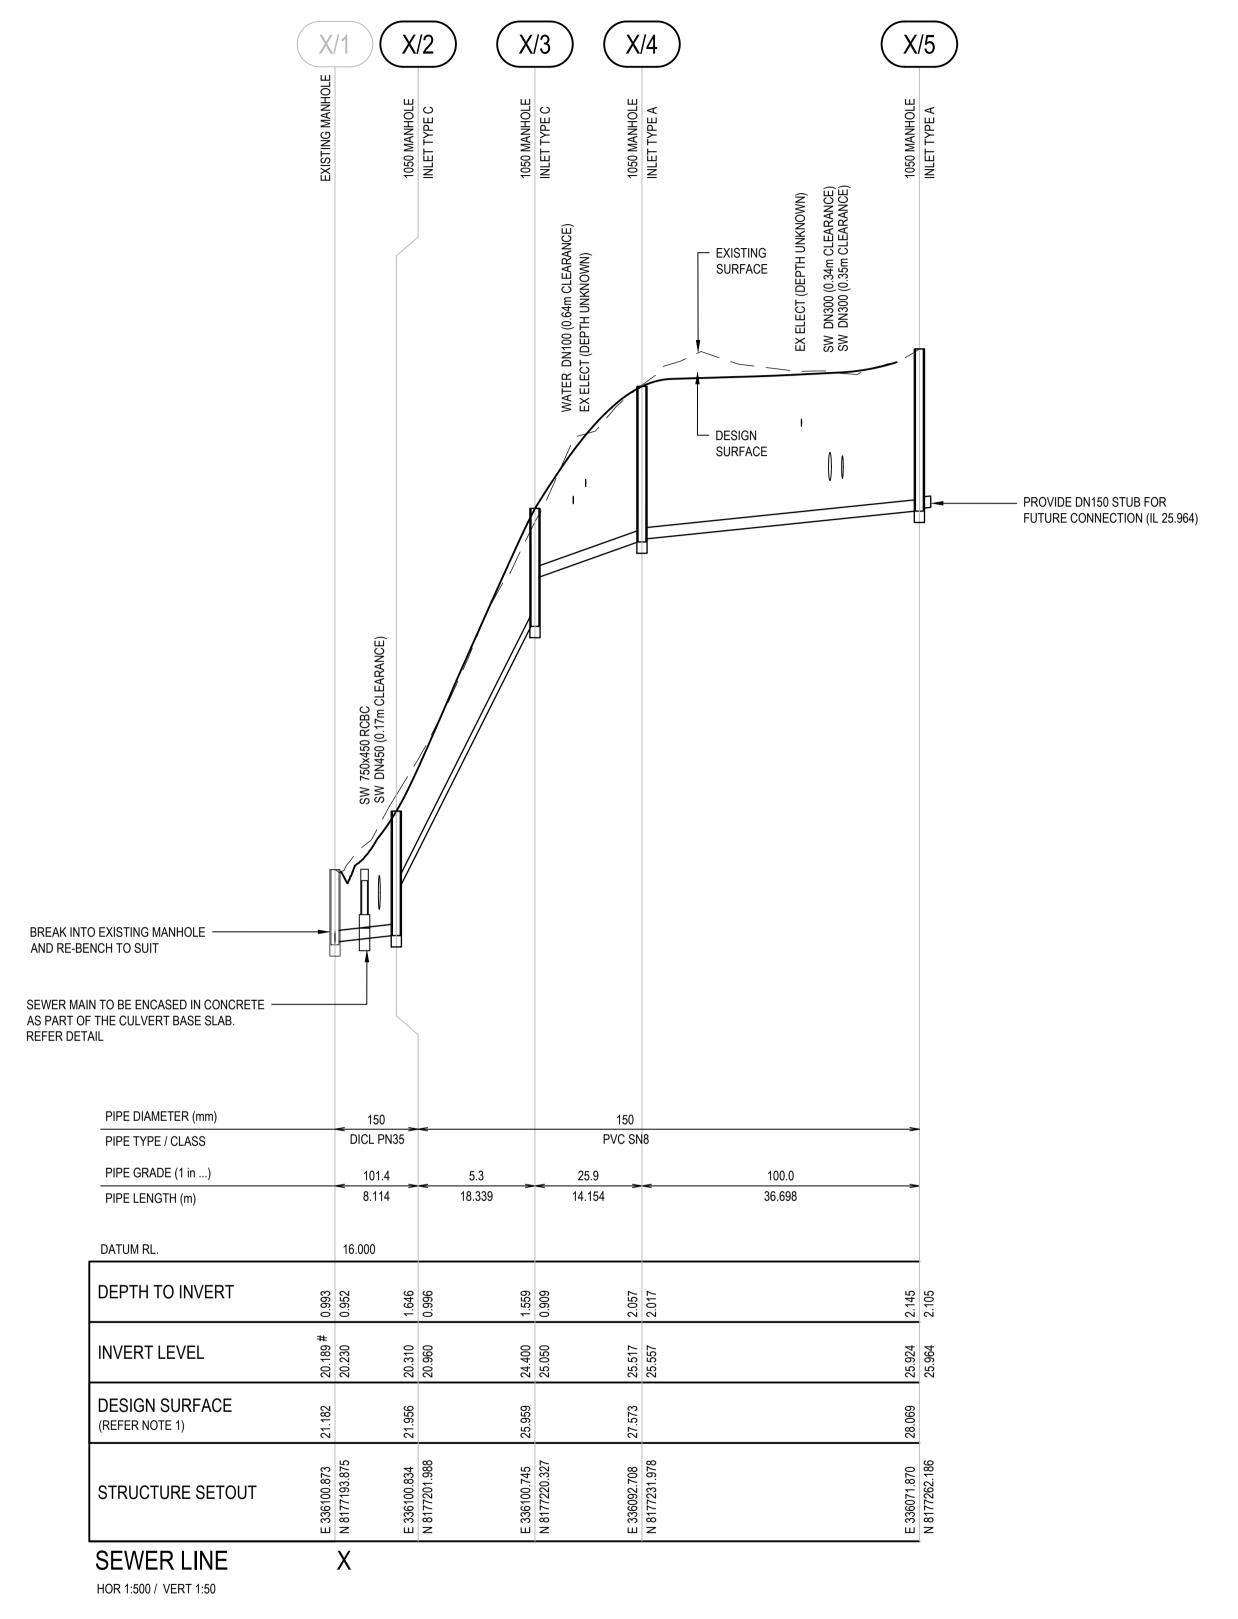

EXISTING SEWER LEVELS AT THE POINT OF CONNECTION HAVE BEEN DERIVED FROM COUNCIL RECORDS. THE CONTRACTOR MUST CONFIRM THIS LEVEL PRIOR TO COMMENCING WORKS AND ADVISE THE SUPERINTENDENT IF IT DIFFERS FROM WHAT IS SHOWN.

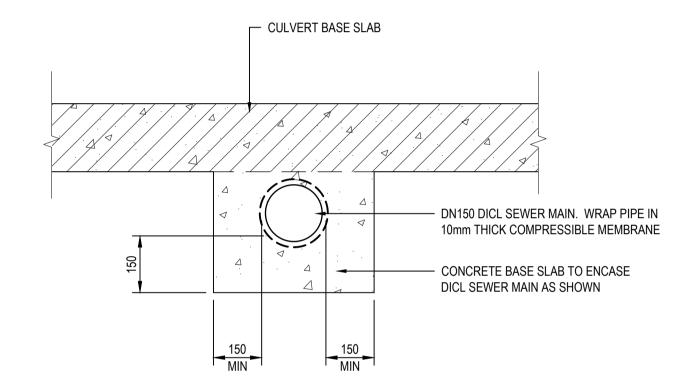


SEWER MAIN CONCRETE ENCASEMENT SCALE 1:10

NOTES

- DESIGN SURFACE LEVELS SHOWN RELATE TO FINISHED SURFACE AT THE MANHOLE AND NOT THE MANHOLE COVER LEVEL. IN ROADWAYS THE COVER LEVEL SHALL BE FLUSH WITH THE FINISHED SURFACE. OUTSIDE ROADWAYS THE MANHOLE COVER SHALL BE 50mm ABOVE THE FINISHED SURFACE LEVEL.
- 2. REFER DRG 24003-C002 FOR STANDARD NOTES AND LEGENDS.



					SCALES	CLIENT	DESIGNED	PROJECT	STATUS	
					V 1.50 0 0.5 1 1.5 2 2.5m		G. BROWNING	CULLEN-BIDDLE RESIDENCE	FOR APPROVAL	
21.dwg	B ISSUED FOR APPROVAL	GB G	6A 01/05/24	APPLIN — CONSULTING	H 1:500	KIM CULLEN & NEIL BIDDLE	DRAWN	12 MURPHY STREET (LOT 113 PTD2094)	SCALE (AT FULL SIZE)	SIZE
3,00	A PRELIMINARY ISSUE	GB G	GA 13/03/24		0 5 10 15 20 25m		G. BROWNING	TITLE	1:500H / 1:50V	A 1
24003	REV DESCRIPTION	DRN AF	PP DATE	M 0414 768 109 E greg@applinconsulting.com.au	0 0.1 0.2 0.3 0.4 0.5m		CHECKED	SEWER RETICULATION	DRAWING NUMBER	REVISION
<u>=</u>	THIS DRAWING IS COPYRIGHT AND THE PROPERTY OF APPLIN CONSULTING. IT MUST	CERTIFICATIO	ON RPEQ		1:10		CHECKED G. APPLIN		24003-C021	D
AP	TO BY APPLIN CONSULTING FOR THE PURPOSE FOR WHICH IT WAS PREPARED FOR.	G. APPLIN	6073				O. Al I LIIV	LONGITUDINAL SECTION AND DETAILS	24003-C021	D

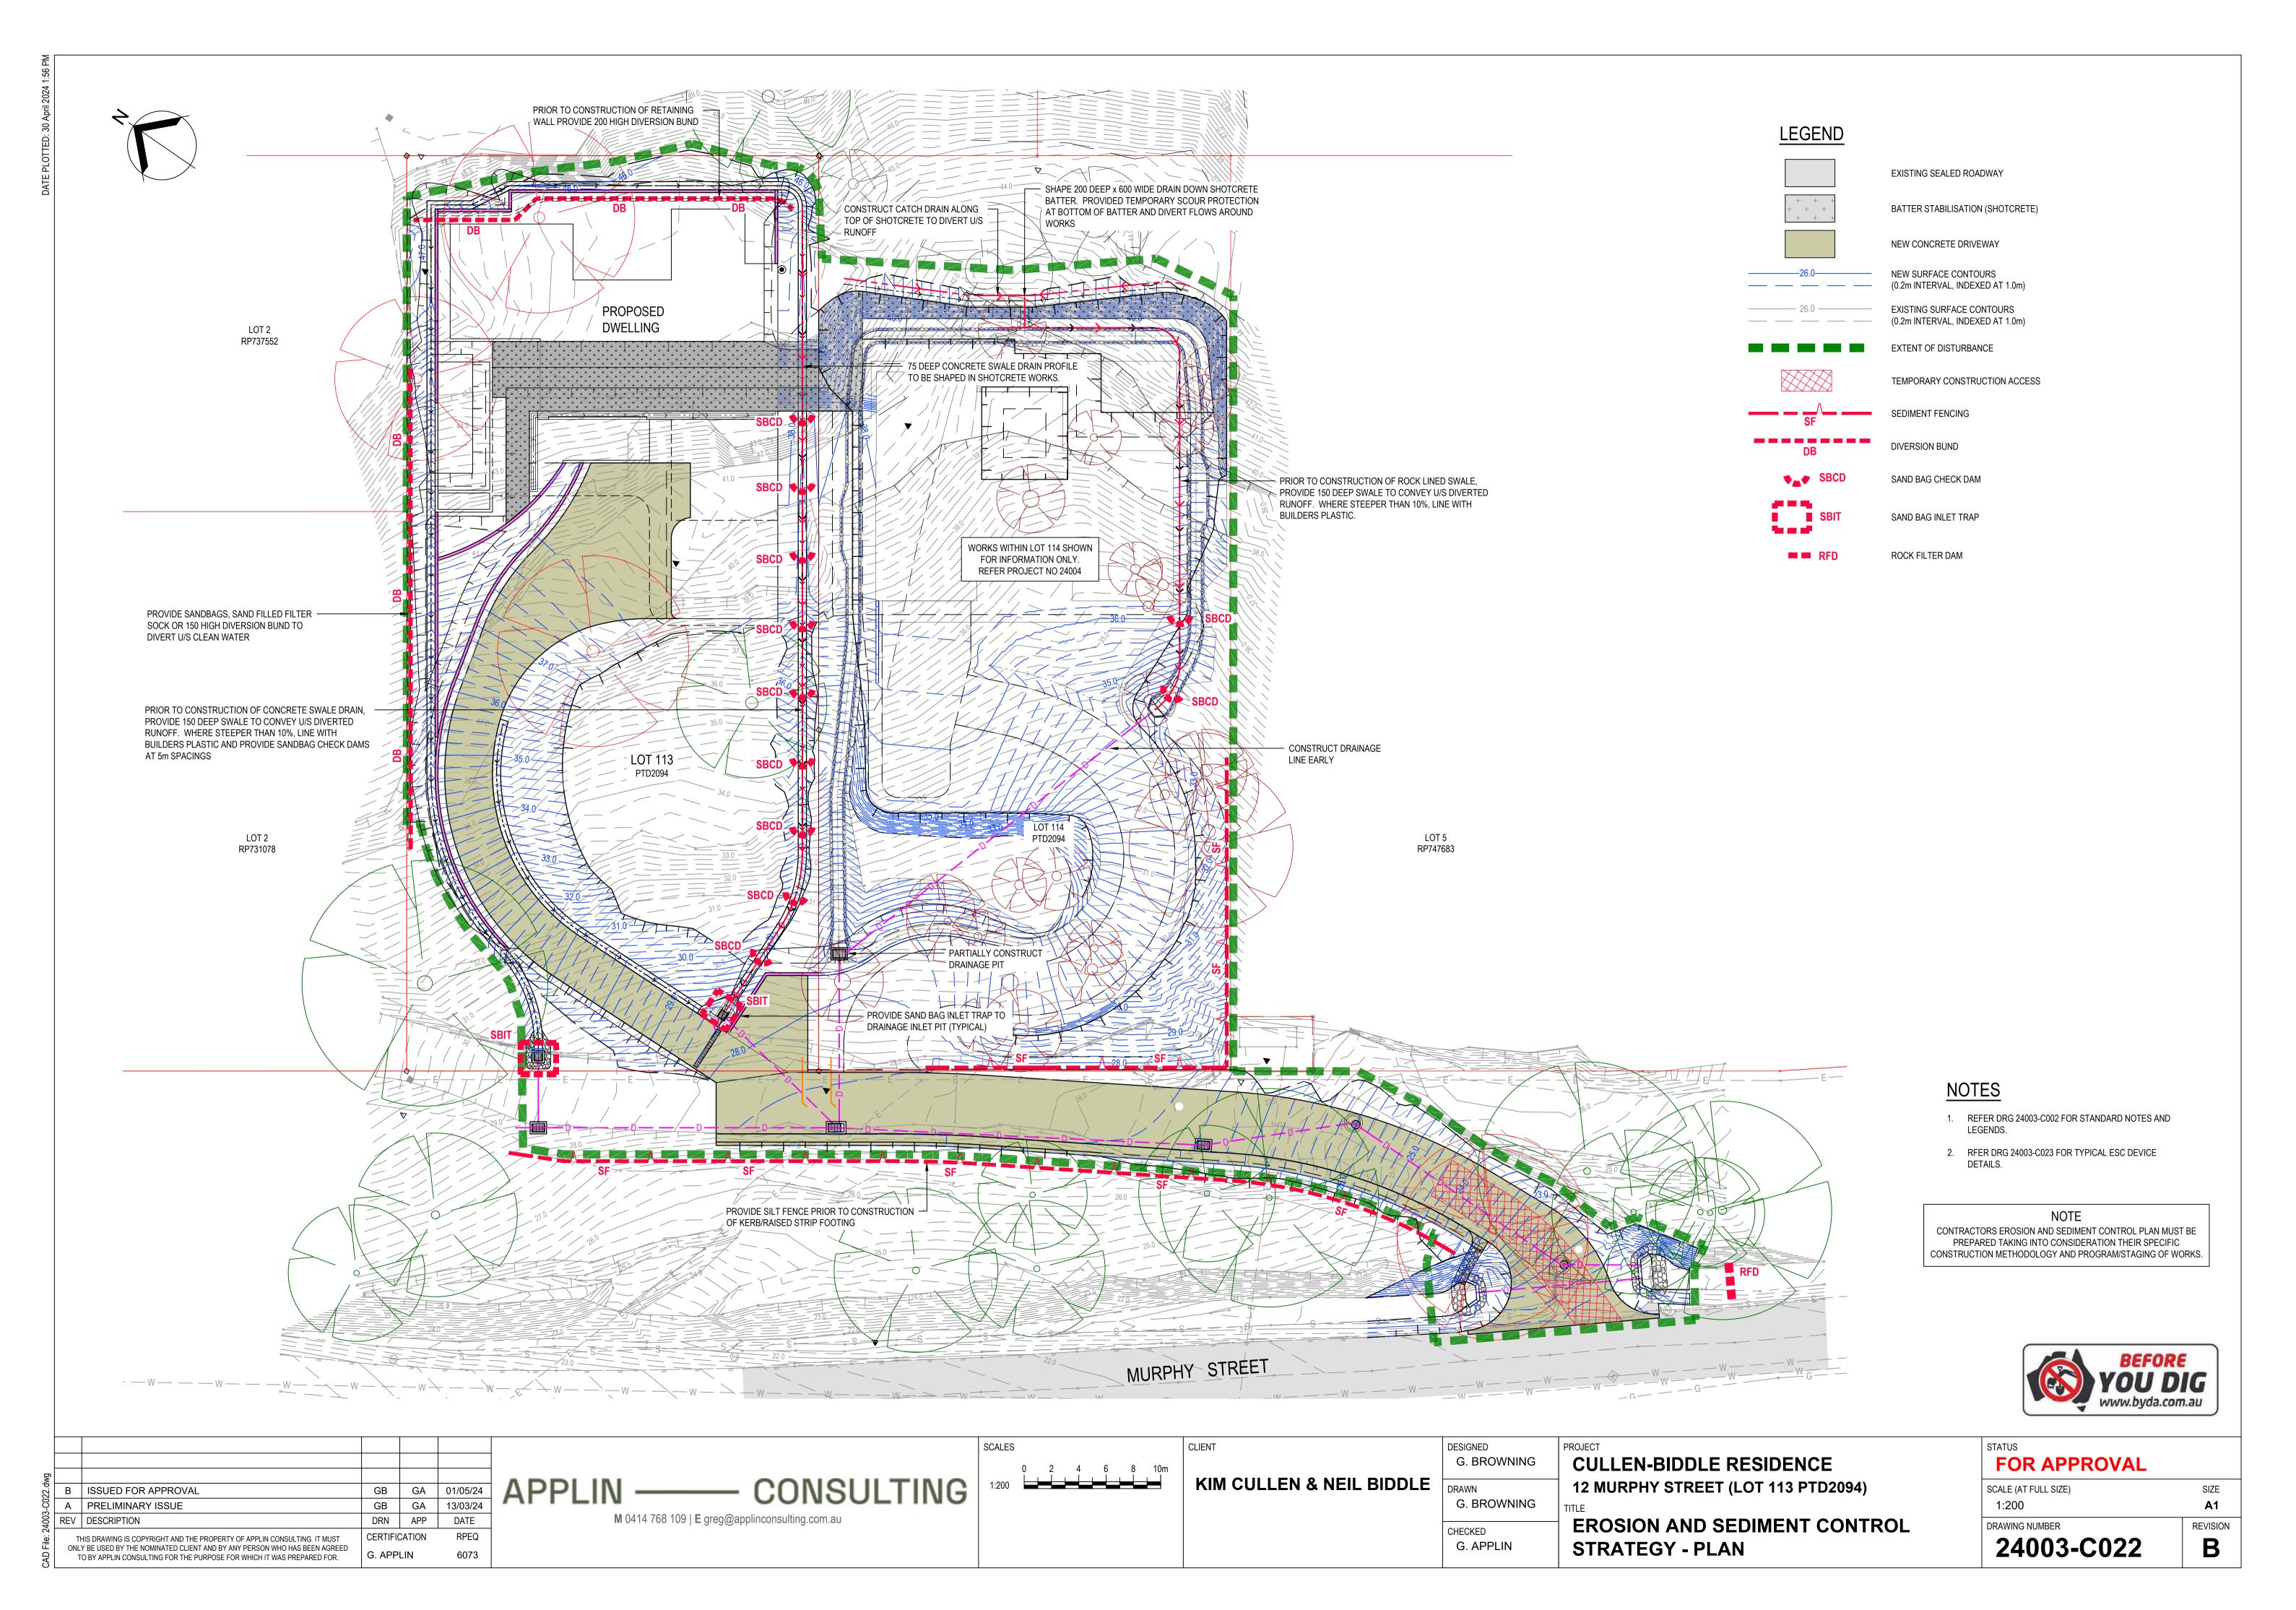

SEDIMENT FENCE

MATERIAL

POLYPROPYLENE, POLYAMIDE, NYLON, POLYESTER, OR POLYETHYLENE WOVEN OR NON-WOVEN FABRIC, AT LEAST 700mm IN WIDTH AND A MINIMUM UNIT WEIGHT OF 140GSM. ALL FABRICS TO CONTAIN ULTRAVIOLET INHIBITORS AND STABILISERS TO PROVIDE A MINIMUM OF 6 MONTHS OF USEABLE CONSTRUCTION LIFE (ULTRAVIOLET STABILITY EXCEEDING 70%).

WIRE OR STEEL MESH MINIMUM 14-GAUGE WITH A MAXIMUM MESH SPACING OF 200mm.

1500mm² (MIN) HARDWOOD, 2500mm² (MIN) SOFTWOOD, OR 1.5kg/m (MIN) STEEL STAR PICKETS SUITABLE

INSTALLATION

FOR ATTACHING FABRIC.

- REFER TO APPROVED PLANS FOR LOCATION, EXTENT AND REQUIRED TYPE OF FABRIC (IF SPECIFIED). IF THERE ARE QUESTIONS OR PROBLEMS WITH THE LOCATION, EXTENT, FABRIC TYPE, OR METHOD OF INSTALLATION CONTACT THE ENGINEER OR RESPONSIBLE ON-SITE OFFICER FOR
- 2. TO THE MAXIMUM DEGREE PRACTICAL, AND WHERE THE PLANS ALLOW, ENSURE THE FENCE IS LOCATED:
 - TOTALLY WITHIN THE PROPERTY BOUNDARIES;
- ii. ALONG A LINE OF CONSTANT ELEVATION WHEREVER PRACTICAL;
- iii. AT LEAST 2m FROM THE TOE OF ANY FILLING OPERATIONS THAT MAY RESULT IN SHIFTING SOIL/FILL DAMAGING THE FENCE.
- 3. INSTALL RETURNS WITHIN THE FENCE AT MAXIMUM 20m INTERVALS IF THE FENCE IS INSTALLED ALONG THE CONTOUR, OR 5 TO 10m MAXIMUM SPACING (DEPENDING ON SLOPE) IF THE FENCE IS INSTALLED AT AN ANGLE TO THE CONTOUR. THE 'RETURNS' SHALL CONSIST OF EITHER: . V-SHAPED SECTION EXTENDING AT LEAST 1.5m UP THE SLOPE; OR
 - SANDBAG OR ROCK/AGGREGATE CHECK DAM A MINIMUM 1/3 AND MAXIMUM 1/2 FENCE HEIGHT, AND EXTENDING AT LEAST 1.5m UP THE SLOPE.
- 4. ENSURE THE EXTREME ENDS OF THE FENCE ARE TURNED UP THE SLOPE AT LEAST 1.5m, OR AS NECESSARY, TO MINIMISE WATER BYPASSING AROUND THE FENCE.
- 5. ENSURE THE SEDIMENT FENCE IS INSTALLED IN A MANNER THAT AVOIDS THE CONCENTRATION OF FLOW ALONG THE FENCE, AND THE UNDESIRABLE DISCHARGE OF WATER AROUND THE ENDS OF
- 6. IF THE SEDIMENT FENCE IS TO BE INSTALLED ALONG THE EDGE OF EXISTING TREES, ENSURE CARE IS TAKEN TO PROTECT THE TREES AND THEIR ROOT SYSTEMS DURING INSTALLATION OF THE FENCE. DO NOT ATTACH THE FABRIC TO THE TREES.
- 7. UNLESS DIRECTED BY THE SITE SUPERVISOR OR THE APPROVED PLANS, EXCAVATE A 200mm WIDE BY 200mm DEEP TRENCH ALONG THE PROPOSED FENCE LINE, PLACING THE EXCAVATED MATERIAL ON THE UP-SLOPE SIDE OF THE TRENCH.
- 8. ALONG THE LOWER SIDE OF THE TRENCH, APPROPRIATELY SECURE THE STAKES INTO THE GROUND SPACED NO GREATER THAN 3m IF SUPPORTED BY A TOP SUPPORT WIRE OR WEIR MESH BACKING, OTHERWISE NO GREATER THAN 2m.
- 9. IF SPECIFIED, SECURELY ATTACH THE SUPPORT WIRE OR MESH TO THE UP-SLOPE SIDE OF THE STAKES WITH THE MESH EXTENDING AT LEAST 200mm INTO THE EXCAVATED TRENCH, ENSURE THE MESH AND FABRIC IS ATTACHED TO THE UP-SLOPE SIDE OF THE STAKES EVEN WHEN DIRECTING A FENCE AROUND A CORNER OR SHARP CHANGE OF DIRECTION.

RETURNS TO BE PROVIDED AT MAXIMUM 20m

SPACING WHEN INSTALLED ALONG CONTOUR,

OTHERWISE 5-10m MAX DEPENDING UPON SLOPE

- WHEREVER POSSIBLE, CONSTRUCT THE SEDIMENT FENCE FROM A CONTINUOUS ROLL OF FABRIC. TO JOIN FABRIC EITHER:
- i. ATTACH EACH END TO TWO OVERLAPPING STAKES WITH THE FABRIC FOLDING AROUND THE ASSOCIATED STAKE ONE TURN, AND WITH THE TWO STAKES TIED TOGETHER WITH WIRE; OR ii. OVERLAP THE FABRIC TO THE NEXT ADJACENT SUPPORT POST.
- 11. SECURELY ATTACH THE FABRIC TO THE SUPPORT POSTS USING 25 X 12.5mm STAPLES, OR TIE WIRE AT MAXIMUM 150mm SPACING.
- 12. SECURELY ATTACH THE FABRIC TO THE SUPPORT WIRE/MESH (IF ANY) AT A MAXIMUM SPACING OF
- 13. ENSURE THE COMPLETED SEDIMENT FENCE IS AT 450mm, BUT NOT MORE THAN 700mm HIGH. IF A SPILL-THOUGH WEIR IS INSTALLED, ENSURE THE CREST OF THE WEIR IS AT LEAST 300mm ABOVE GROUND LEVEL
- 14. BACKFILL THE TRENCH AND TAMP THE FILL TO FIRMLY ANCHOR THE BOTTOM OF THE FABRIC AND MESH TO PREVENT WATER FROM FLOWING UNDER THE FENCE.

ADDITIONAL REQUIREMENTS FOR THE INSTALLATION OF SPILL-THROUGH

- 15. LOCATE THE SPILL -THROUGH WEIR SUCH THAT THE WEIR CREST WILL BE LOWER THAN THE GROUND LEVEL AT EACH END OF THE FENCE.
- 16. ENSURE THE CREST OF THE SPILL-THROUGH WEIR IS AT LEAST 300mm THE GROUND ELEVATION. 17. SECURELY TIE A HORIZONTAL CROSS MEMBER (WEIR) TO THE SUPPORT POSTS/STAKES EACH SIDE OF THE WEIR. CUT THE FABRIC DOWN THE SIDE OF EACH POST AND FOLD THE FABRIC OVER THE CROSS MEMBER AND APPROPRIATELY SECURE THE FABRIC.
- 18. INSTALL A SUITABLE SPLASH PAD AND/OR CHUTE IMMEDIATELY DOWN-SLOPE OF THE SPILL-THROUGH WEIR TO CONTROL SOIL EROSION AND APPROPRIATELY DISCHARGE THE CONCENTRATED FLOW PASSING OVER THE WEIR.

MAINTENANCE


- 19. INSPECT THE SEDIMENT FENCE AT LEAST WEEKLY AND AFTER ANY SIGNIFICANT RAIN. MAKE NECESSARY REPAIRS IMMEDIATELY.
- 20. REPAIR ANY TORN SECTIONS WITH A CONTINUOUS PIECE OF FABRIC FROM POST TO POST.
- 21. WHEN MAKING REPAIRS, ALWAYS RESTORE THE SYSTEM TO ITS ORIGINAL CONFIGURATION UNLESS AN AMENDED LAYOUT IS REQUIRED OR SPECIFIED.
- 22. IF THE FENCE IS SAGGING BETWEEN STAKES, INSTALL ADDITIONAL SUPPORT POSTS.
- 23. REMOVE ACCUMULATED SEDIMENT IF THE SEDIMENT DEPOSIT EXCEEDS A DEPTH OF 1/3 THE HEIGHT OF THE FENCE.
- 24. DISPOSE OF SEDIMENT IN A SUITABLE MANNER THAT WILL NOT CAUSE AN EROSION OR POLLUTION
- 25. REPLACE THE FABRIC IS THE SERVICE LIFE OF THE EXISTING FABRIC EXCEEDS 6 MONTHS.

ALL SUPPORT POSTS TO BE 50x50 HW STAKE OR 1.5KG/m STEEL STAR PICKET 1200 MIN. LONG, WITH

SAFETY CAP PLACED DOWN-SLOPE OF FABRIC

- 1.5m (MIN)

- 26. WHEN DISTURBED AREAS UP-SLOPE OF THE SEDIMENT FENCE ARE SUFFICIENTLY STABILISED TO RESTRAIN EROSION, THE FENCE MUST BE REMOVED.
- 27. REMOVE MATERIALS AND COLLECTED SEDIMENT AND DISPOSE OF IN A SUITABLE MANNER THAT WILL NOT CAUSE AN EROSION OR POLLUTION HAZARD.
- 28. REHABILITATE/REVEGETATE THE DISTURBED GROUND AS NECESSARY TO MINIMISE THE EROSION

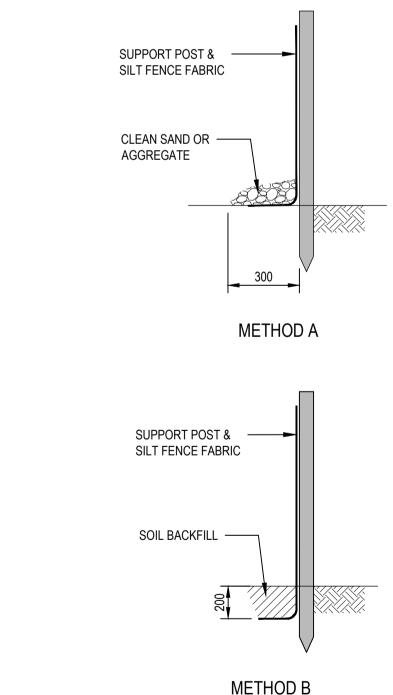




SILT FENCE FABRIC (NOT FILTER

CLOTH OR SHADE CLOTH)



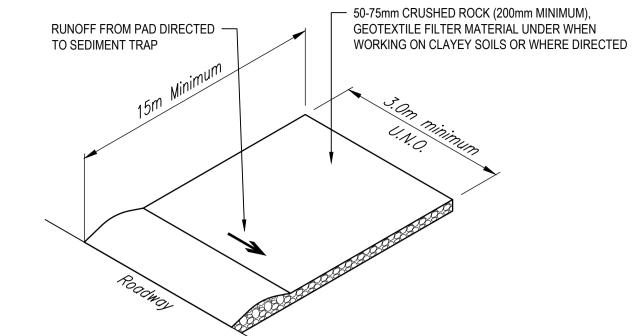

TEMPORARY CONSTRUCTION ACCESS (ENTRY/EXIT)

NOT TO SCALE

TEMPORARY CONSTRUCTION ACCESS

MATERIAL

WELL GRADED, HARD, ANGULAR, EROSION RESISTANT ROCK, NOMINAL DIAMETER OF 50mm TO 75mm (SMALL DISTURBANCES) OR 100mm TO 150mm (LARGE DISTURBANCES). ALL REASONABLE MEASURES MUST BE TAKEN TO OBTAIN ROCK OF NEAR UNIFORM SIZE.

FOOTPATH STABILISING AGGREGATE (WHERE REQUIRED):

25mm TO 50mm GRAVEL OR AGGREGATE.

HEAVY-DUTY, NEEDLE-PUNCHES, NON-WOVEN FILTER CLOTH ('BIDIM" A24 OR EQUIVALENT).

- 1. REFER TO APPROVED PLANS FOR LOCATION AND DIMENSIONAL DETAILS. IF THERE ARE QUESTIONS OR PROBLEMS WITH THE LOCATION, DIMENSIONS, OR METHOD OF INSTALLATION, CONTACT THE ENGINEER OR RESPONSIBLE ON-SITE OFFICER FOR ASSISTANCE.
- 2. CLEAR THE LOCATION OF THE ROCK PAD, REMOVING STUMPS, ROOTS AND OTHER VEGETATION TO PROVIDE A FIRM FOUNDATION SO THAT THE ROCK IS NOT PRESSED INTO SOFT GROUND. CLEAR SUFFICIENT WIDTH TO ALLOW PASSAGE OF LARGE VEHICLES, BUT CLEAR ONLY THAT NECESSARY FOR THE EXIT. DO NOT CLEAR ADJACENT AREAS UNTIL THE REQUIRED EROSION AND SEDIMENT CONTROL DEVICES ARE IN PLACE.
- 3. IF THE EXPOSED SOIL IS SOFT, PLASTIC OR CLAYEY, PLACE A SUB-BASE OF CRUSHED ROCK OR A LAYER OF HEAVY-DUTY FILTER CLOTH TO PROVIDE A FIRM FOUNDATION.
- 4. PLACE THE ROCK PAD FORMING A MINIMUM 200mm THICK LAYER OF CLEAN, OPEN-VOID ROCK. 5. IF THE ASSOCIATED CONSTRUCTION SITE IS UP-SLOPE OF THE ROCK PAD, THUS CAUSING STORMWATER RUNOFF TO FLOW TOWARDS THE ROCK PAD, THEN FORM A MINIMUM 300mm HIGH FLOW CONTROL BERM ACROSS THE ROCK PAD TO DIVERT SUCH RUNOFF TO A SUITABLE
- 6. THE LENGTH OF THE ROCK PAD SHOULD BE AT LEAST 15m WHERE PRACTICABLE, AND AS WIDE AS THE FULL WIDTH OF THE ENTRY OR EXIT AND AT LEAST 3m. THE ROCK PAD SHOULD
- COMMENCE AT THE EDGE OF THE OFF-SITE SEALED ROAD OR PAVEMENT. FLARE THE END OF THE ROCK PAD, IF NECESSARY, WHERE IT MEETS THE PAVEMENT TO
- ENSURE THE WHEELS OF TURNING VEHICLES DO NOT TRAVEL OVER UNPROTECTED SOIL 8. IF THE FOOTPATH IS OPEN TO PEDESTRIAN MOVEMENT, THE COARSE ROCK SHALL BE COVERED WITH FINE AGGREGATE OR GRAVEL, OR OTHER SUITABLE MEASURES NECESSARY TO MAKE THE AREA SAFE.


MAINTENANCE

- 9. INSPECT ALL SITE ENTRY AND EXIT POINTS PRIOR TO FORECAST RAIN, DAILY DURING EXTENDED PERIODS OF RAINFALL, AFTER RUNNOFF-PRODUCING RAINFALL, OR OTHERWISE AT FORTNIGHTLY INTERVALS.
- 10. IF SAND, SOIL, SEDIMENT OR MUD IS TRACKED OR WASHED ONTO THE ADJACENT SEALED ROADWAY, THEN SUCH MATERIAL MUST BE PHYSICALLY REMOVED, FIRST USING A SQUARE-EDGED SHOVEL, AND THEN A STIFF-BRISTLED BROOM, AND THEN BY A MECHANICAL VACUUM UNIT. IF AVAILABLE.
- 11. IF NECESSARY FOR SAFETY REASONS, THE ROADWAY SHALL ONLY BE WASHED CLEAN AFTER ALL REASONABLE EFFORTS HAVE BEEN TAKEN TO SHOVEL AND SWEEP THE MATERIAL FROM THE ROADWAY.
- 12. WHEN THE VOIDS BETWEEN THE ROCK BECOME FILLED WITH MATERIAL AND THE EFFECTIVENESS OF THE ROCK PAD IS REDUCED TO A POINT WHERE SEDIMENT IS BEING TRACKED OFF THE SITE. A NEW 100mm LAYER OF ROCK MUST BE ADDED AND/OR THE ROCK PAD MUST BE EXTENDED.
- 13. ENSURE ANY ASSOCIATED DRAINAGE CONTROL MEASURES (e.g. FLOW CONTROL BERM) ARE MAINTAINED IN ACCORDANCE WITH THEIR DESIRED OPERATIONAL CONDITIONS.
- 14. DISPOSE OF SEDIMENT AND DEBRIS IN A MANNER THAT WILL NOT CREATE AN EROSION OR POLLUTION HAZARD.

REMOVAL

CLIENT

- 1. THE ROCK PAD SHOULD BE REMOVED ONLY AFTER IT IS NO LONGER NEEDED AS A SEDIMENT
- REMOVE MATERIALS AND COLLECTED SEDIMENT AND DISPOSE OF IN A SUITABLE MANNER THAT WILL NOT CAUSE AN EROSION OR POLLUTION HAZARD.
- RE-GRADE AND STABILISE THE DISTURBED GROUND AS NECESSARY TO MINIMISE THE EROSION HAZARD.

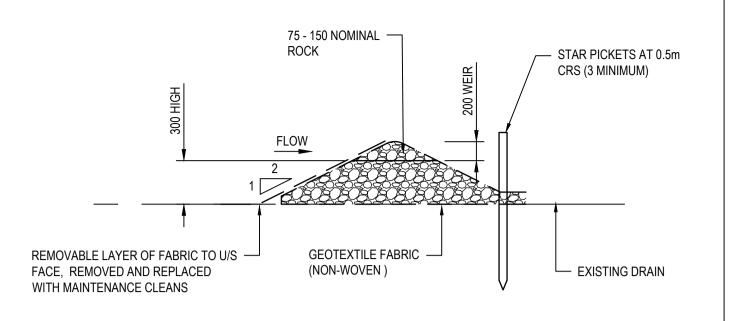

ROCK FILTER DAM NOT TO SCALE

ROCK FILTER DAM

75 TO 100mm NOMINAL DIAMETER, HARD, EROSION RESISTANT ROCK.

HEAVY-DUTY, NEEDLE-PUNCHES, NON-WOVEN FILTER CLOTH ('BIDIM' A24 OR EQUIVALENT).

INSTALLATION

- 1. REFER TO APPROVED PLANS FOR LOCATION AND INSTALLATION DETAILS. IF THERE ARE QUESTIONS OR PROBLEMS WITH THE LOCATION OR METHOD OF INSTALLATION, CONTACT THE ENGINEER OR RESPONSIBLE ON-SITE OFFICER FOR ASSISTANCE.
- PRIOR TO PLACEMENT OF THE FILTER DAM, ENSURE THE TYPE AND SIZE OF EACH CHECK DAMS WILL NOT CAUSE A SAFETY HAZARD OR CAUSE WATER TO SPILL OUT OF THE
- CONSTRUCT THE FILTER DAM TO THE DIMENSIONS AND PROFILE SHOWN WITHIN THE APPROVED PLAN.
- 4. WHERE SPECIFIED, THE FILTER DAM SHALL BE CONSTRUCTED ON A SHEET OF GEOTEXTILE FABRIC USED AS A DOWNSTREAM SPLASH PAD.

MAINTENANCE

1. INSPECT EACH FILTER DAM AND THE DRAINAGE CHANNEL AT LEAST WEEKLY AND AFTER RUNOFF-PRODUCING RAINFALL.

CHECK FOR DISPLACEMENT OF THE FILTER DAM

- CHECK FOR SOIL SCOUR AROUND THE ENDS OF THE FILTER DAM. IF SUCH EROSION IS OCCURRING, CONSIDER EXTENDING THE WIDTH OF THE FILTER DAM TO AVOID SUCH
- 4. IF SEVERE SOIL EROSION OCCURS EITHER UNDER OR AROUND THE FILTER DAM, THEN SEEK EXPERT ADVICE ON AN ALTERNATIVE TREATMENT MEASURE.
- REMOVE AND SEDIMENT ACCUMULATED BY THE FILTER DAM, UNLESS IT IS INTENDED THAT THIS SEDIMENT WILL REMAIN WITHIN THE CHANNEL.
- DISPOSE OF COLLECTED SEDIMENT IN A SUITABLE MANNER THAT WILL NOT CAUSE AN EROSION OR POLLUTION HAZARD.

REPLACE GEOFABRIC LAYER ON UPSTREAM FACE WITH A CLEAN LAYER AS REQUIRED

REMOVAL

- 1. WHEN CONSTRUCTION WORK WITHIN THE DRAINAGE AREA ABOVE THE FILTER DAM HAS BEEN COMPLETED. AND THE DISTURBED AREAS AND THE DRAINAGE CHANNEL ARE SUFFICIENTLY STABILISED TO RESTRAIN EROSION, ALL TEMPORARY CHECK DAMS MUST
- REMOVE THE FILTER DAM AND ASSOCIATED SEDIMENT AND DISPOSE OF IN A SUITABLE MANNER THAT WILL NOT CAUSE AN EROSION OR POLLUTION HAZARD.

wg					
23.d	В	ISSUED FOR APPROVAL	GB	GA	01/05/24
3-C0	Α	PRELIMINARY ISSUE	GB	GA	13/03/24
4003	REV	DESCRIPTION	DRN	APP	DATE
File: 24003-C023.dwg	TI	HIS DRAWING IS COPYRIGHT AND THE PROPERTY OF APPLIN CONSULTING. IT MUST	CERTIFIC	CATION	RPEQ
CAD F		Y BE USED BY THE NOMINATED CLIENT AND BY ANY PERSON WHO HAS BEEN AGREED O BY APPLIN CONSULTING FOR THE PURPOSE FOR WHICH IT WAS PREPARED FOR.	G. APPLIN		6073

3000 MAX WITH A TOP WIRE -

OTHERWISE 2000 MAX

FLOW

FABRIC BURIED 200mm

APPLIN ——— CONSULTING

M 0414 768 109 | E greg@applinconsulting.com.au

SCALES

KIM CULLEN & NEIL BIDDLE

DESIGNED G. BROWNING G. BROWNING CHECKED

G. APPLIN

CULLEN-BIDDLE RESIDENCE 12 MURPHY STREET (LOT 113 PTD2094)

EROSION AND SEDIMENT CONTROL STRATEGY - DETAILS


FOR APPROVAL
SCALE (AT FULL SIZE) AS SHOWN
DRAWING NUMBER

SIZE

A1 REVISION 24003-C023 B

KYRENIA RESIDENCE

14 MURPHY STREET (LOT114 PTD2094), PORT DOUGLAS CIVIL WORKS

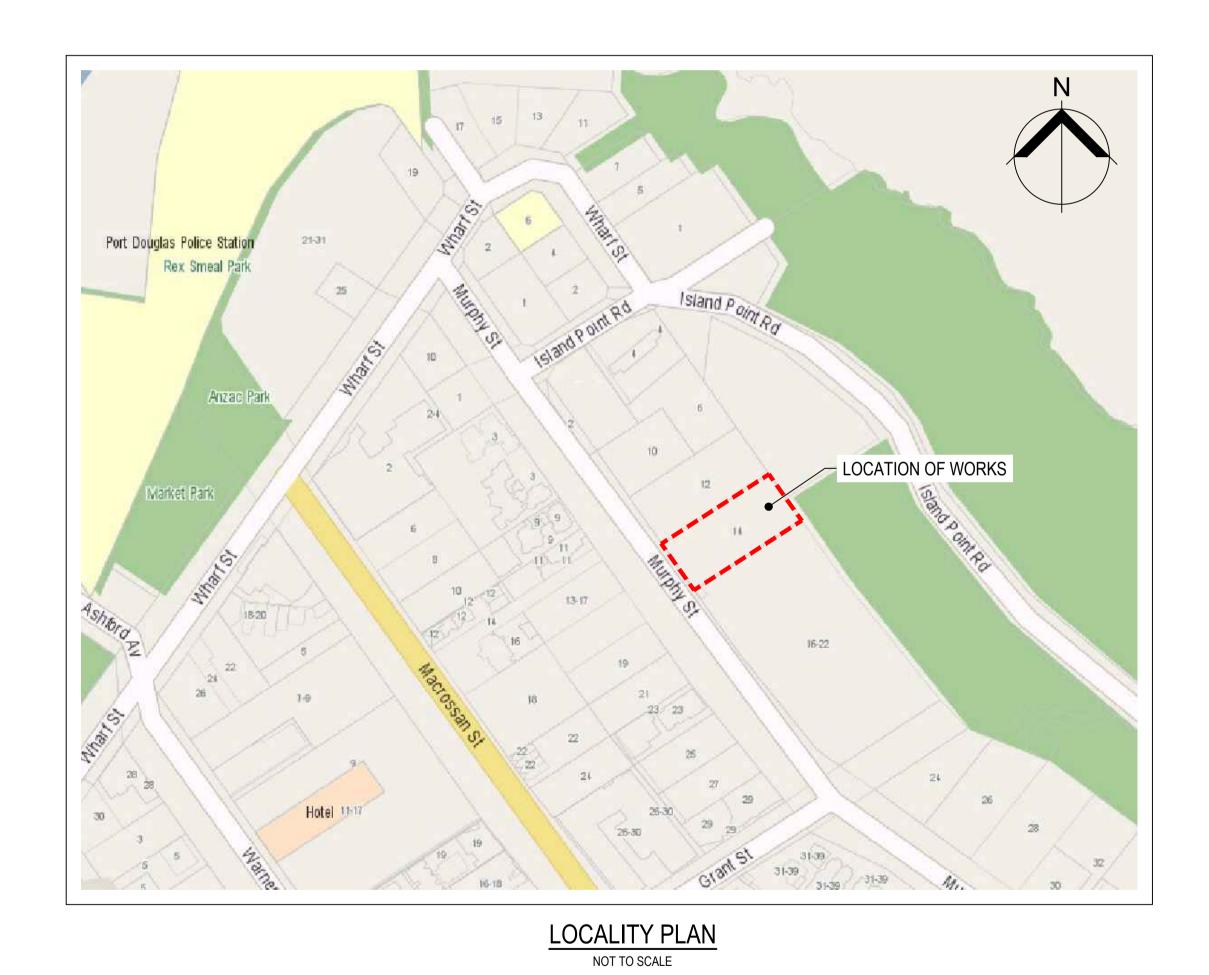

DRAWING LIST					
DRG No.	DRAWING TITLE				
24004-C001	COVER SHEET, LOCALITY PLAN AND DRAWING INDEX				
24004-C002	STANDARD NOTES				
24004-C003	OVERALL SITE PLAN				
24004-C004	GENERAL ARRANGEMENT PLAN				
24004-C005	SETOUT PLAN				
24004-C006	SITE SECTIONS				
24004-C007	TYPE SECTIONS AND DETAILS				
24004-C008	MISCELLANEOUS DETAILS				
24004-C009	LONGITUDINAL SECTIONS				
24004-C010	CROSS SECTIONS - DRIVEWAY CL03 - SHEET 1 OF 2				
24004-C011	CROSS SECTIONS - DRIVEWAY CL03 - SHEET 2 OF 2				

				SCALES	CLIENT	DESIGNED G. BROWNING	KYRENIA RESIDENCE	FOR APPROVAL	
04-C001.dw	A ISSUED FOR APPROVAL	GB GA 01/05/24	APPLIN — CONSULTING M 0414 768 109 E greg@applinconsulting.com.au		GEORGE ARGYROU	DRAWN G. BROWNING	14 MURPHY STREET (LOT 114 PTD2094) TITLE	SCALE (AT FULL SIZE)	SIZE A1
CAD File: 240	THIS DRAWING IS COPYRIGHT AND THE PROPERTY OF APPLIN CONSULTING. IT MUST ONLY BE USED BY THE NOMINATED CLIENT AND BY ANY PERSON WHO HAS BEEN AGREED TO BY APPLIN CONSULTING FOR THE PURPOSE FOR WHICH IT WAS PREPARED FOR.	DRN APP DATE CERTIFICATION RPEQ G. APPLIN 6073	W 04 14 700 109 E greg@applinconsulting.com.au			CHECKED G. APPLIN	COVER SHEET, LOCALITY PLAN AND	24004-C001	REVISION

SURVEY CONTROL NOTES

SURVEY ORIGIN

LEVEL DATUM: AHD
ORIGIN OF LEVELS: PM 500028 RL 4.241
MERIDIAN: GDA94 ZONE 55
ORIGIN OF COORDINATES: PM 500028
E 335870.890

2. THE CONTRACTOR MUST LIAISE DIRECT WITH RPS SURVEYORS (PORT DOUGLAS) TO CONFIRM COORDINATES AND LEVELS OF SUITABLE SITE BENCHMARKS.

GENERAL NOTES

- 1. DO NOT SCALE FROM THE PROJECT DRAWINGS.
- 2. ALL LEVELS AND DIMENSIONS ARE IN METERS, UNLESS NOTED OTHERWISE.
- ALL WORKS MUST BE CARRIED OUT IN ACCORDANCE WITH THE RELEVANT FNQROC DEVELOPMENT MANUAL SPECIFICATIONS. WHERE DIFFERENCES EXIST BETWEEN THE PLANS AND THE DEVELOPMENT MANUAL, THESE PLANS SHALL TAKE PRECEDENCE
- 4. THE CONTRACTOR IS TO ENSURE A COPY OF THE OPERATIONAL WORKS APPROVAL IS AVAILABLE ON SITE. THE SITE FOREMAN IS TO ENSURE ALL WORKS ARE UNDERTAKEN IN ACCORDANCE WITH THE APPROVAL.
- THE LOCATIONS OF UNDERGROUND SERVICES HAVE BEEN APPROXIMATED FROM THE KNOWN POSITIONS OF VALVES, MANHOLES, ETC. PRIOR TO ANY DEMOLITION, EXCAVATION OR CONSTRUCTION ON SITE, THE CONTRACTOR MUST CONTACT RELEVANT AUTHORITIES FOR POSSIBLE LOCATION OF FURTHER SERVICES AND DETAILED LOCATIONS OF ALL SERVICES.
- 6. EXISTING SERVICES ARE TO BE PROTECTED FROM DAMAGE DURING CONSTRUCTION. WHERE NECESSARY THE CONTRACTOR SHALL CONFIRM THE DEPTH TO EXISTING SERVICES BY POTHOLING BEFORE COMMENCING WORKS. THE SUPERINTENDENT SHALL BE CONSULTED WHERE THE CONTRACTOR CONSIDERS SPECIFIC PROTECTION WORKS NECESSARY TO PROTECT THE SERVICE.
- 7. WHERE REFERENCE IS MADE TO THE STANDARD DRAWINGS, THE CONTRACTOR SHALL ENSURE THAT THE LATEST VERSION ISSUED BY THE RELEVANT AUTHORITY, AT THE TIME OF CONSTRUCTION, IS USED.

EROSION AND SEDIMENT CONTROL NOTES

- 1. PRIOR TO CONSTRUCTION COMMENCING, THE CONTRACTOR MUST PREPARE AN EROSION & SEDIMENT CONTROL PLAN (ESCP) TO MANAGE THE SITE DURING CONSTRUCTION AND THE DEFECT LIABILITY PERIOD.
- 2. NO EARTHWORKS SHALL COMMENCE ON ANY PART OF THE SITE PRIOR TO APPROPRIATE EROSION AND SEDIMENT CONTROL MEASURES BEING INSTALLED DOWNSTREAM OF THE SITE AND IN ACCORDANCE WITH THE APPROVED ESCP.
- 3. AT ALL TIMES THE CONTRACTOR SHALL MONITOR THE PREVAILING WEATHER CONDITIONS AND TAKE ALL NECESSARY PRECAUTIONS TO CONTROL EROSION AND DOWNSTREAM SEDIMENTATION DURING ALL STAGES OF CONSTRUCTION.
- 4. THE IMPACT ON THE ENVIRONMENT SHALL BE MINIMISED BY OBSERVING THE FOLLOWING CONSTRUCTION PRACTICES:
 - AREAS DISTURBED BY CONSTRUCTION TRAFFIC AND PROCEDURES SHALL BE MINIMISED.
 - MINIMISE TRAFFIC MOVEMENTS AND SPEEDS ON EXPOSED SURFACES.
 - REVEGETATION OF DISTURBED AREAS SHALL BE CARRIED OUT SOON AFTER THE COMPLETION OF TOPSOIL PLACEMENT.
 - FLOW DIVERSION SHALL BE CARRIED OUT BY EARLY INSTALLATION OF DRAINS ALONG TOPS OF BATTERS WITH APPROPRIATE SILTATION CONTROL DEVICES.
 - SEDIMENT INTERCEPTION BY THE PLACEMENT OF SUITABLE RETENTION SYSTEMS ACROSS DRAINAGE LINES AND AT INTERCEPTION POINTS FOR BOTH THE CONSTRUCTION AND STOCKPILE AREAS.
- 7. STOCKPILES SHALL ONLY BE LOCATED IN AREAS NOMINATED ON THE PROJECT DRAWINGS OR APPROVED BY THE SUPERINTENDENT. ALL STOCKPILES MUST HAVE APPROPRIATE ESC MEASURES INSTALLED TO PREVENT SEDIMENT TRANSPORT. THE MAXIMUM HEIGHT OF ALL STOCKPILES MUST BE LIMITED TO 2.0m
- 8. ALL PERMANENT AND TEMPORARY UNLINED SWALES AND DRAINS MUST HAVE APPROPRIATE TEMPORARY EROSION PROTECTION.
- ALL PARTIALLY CONSTRUCTED DRAINAGE STRUCTURES MUST BE PROTECTED AGAINST SEDIMENT INFILTRATION DURING CONSTRUCTION.
- 10. ALL COMPLETED DRAINAGE STRUCTURES MUST BE PROTECTED AGAINST SEDIMENT INFILTRATION UNTIL GRASSING IS ESTABLISHED.
- 11. THE CONTRACTOR IS RESPONSIBLE FOR THE CONTROL OF DUST EMANATING FROM THE SITE AT ALL TIMES FOR THE DURATION OF CONSTRUCTION. WET SUPPRESSION METHODS TO BE USED.
- 12. ALL EROSION AND SEDIMENT CONTROL MEASURES MUST BE CHECKED FOR DAMAGE, CLEANED OUT AND FULLY REINSTATED AFTER EACH RAINFALL EVENT RESULTING IN RUNOFF.
- 13. IF EROSION AND SEDIMENT CONTROL DEVICES HAVE BEEN FOUND TO BE DEFICIENT OR FAILED IN SERVICE, DUE TO UNFORESEEN CIRCUMSTANCES, CORRECTIVE ACTION IS TO BE UNDERTAKEN IMMEDIATELY WHICH MAY INCLUDE AMENDMENTS/ADDITIONS TO THE CONTROL MEASURES.
- 14. THE INSTALLATION, REMOVAL, RELOCATION OR MODIFICATION TO EROSION AND SEDIMENT CONTROL DEVICES MAY BE MADE BY COUNCIL IF DEEMED NECESSARY AND RELEVANT.
- 15. EROSION AND SEDIMENT CONTROL DEVICES SHALL REMAIN IN PLACE UNTIL THE TREATMENT AREA IS SUITABLY STABILISED/VEGETATED.

EARTHWORKS NOTES

- ALL EARTHWORKS MUST BE CARRIED OUT IN ACCORDANCE WITH THE CURRENT FNQROC DEVELOPMENT MANUAL SPECIFICATION - S1 'EARTHWORKS'.
- 2. FNQROC SPECIFICALLY REFERENCES AS3798 'GUIDELINES ON EARTHWORKS FOR COMMERCIAL AND RESIDENTIAL DEVELOPMENTS' IN RELATION TO ALL EARTHWORKS INCLUDING APPROPRIATE METHODS OF TESTING, FREQUENCY OF TESTING AND REPORTING PROCEDURES. GEOTECHNICAL TESTING SERVICES SHALL BE AS DETERMINED BY LEVEL 1 IN ACCORDANCE WITH AS 3798. ALL CERTIFICATION AND TEST RESULTS ARE TO BE COMPILED AND PROVIDED TO THE SUPERINTENDENT PRIOR TO WORKS ACCEPTANCE.
- 3. DRY DENSITY RATIO AS REFERRED TO IN THESE NOTES IS THE RATIO DETERMINED IN ACCORDANCE WITH AS1289.5.4.1 OF COMPACTED DRY DENSITY IN ACCORDANCE WITH AS1289.5.3.1 OR AS1289.5.8.1 TO THE STANDARD MAXIMUM DRY DENSITY DETERMINED IN ACCORDANCE WITH AS1259.5.1.11 (STANDARD COMPACTION).
- 4. ALL BATTERS, TEMPORARY OR PERMANENT, STEEPER THAN 1H:4V OR HIGHER THAN 1.5m MUST BE INSPECTED WITHIN 24HRS OF EXCAVATION AND CERTIFIED BY AN RPEQ GEOTECHNICAL ENGINEER TO CONFIRM THEIR SHORT TERM AND LONG TERM STABILITIES.
- 5. FINISHED SURFACE LEVELS SHOWN ON PROJECT DRAWINGS ARE AFTER ALL EARTHWORKS ARE COMPLETE INCLUDING TOPSOILING. ALL AREAS ARE TO BE GRADED EVENLY BETWEEN FINISHED SURFACE LEVELS UNLESS NOTED OTHERWISE.
- 6. NO VEGETATION SHALL BE REMOVED WITHOUT PRIOR APPROVAL OF THE SUPERINTENDENT UNLESS NOTED ON THE PROJECT DRAWINGS.
- ALL VEGETAL MATTER, TOPSOIL AND OTHER UNSUITABLE MATERIAL SHALL BE STRIPPED/REMOVED FROM AREAS TO BE EXCAVATED OR FILLED. ALL VEGETAL MATTER AND UNSUITABLE MATERIAL SHALL BE DISPOSE OF OFF-SITE UNLESS ADVISED OTHERWISE BY THE SUPERINTENDENT. TOPSOIL SHALL BE STOCKPILED ON-SITE FOR REUSE. SURPLUS TOPSOIL SHALL BE DISPOSED OF OFF-SITE.
- 8. SHOULD ANY SOFT OR UNSUITABLE MATERIAL BE IDENTIFIED, THE CONTRACTOR SHALL INFORM THE SUPERINTENDENT IMMEDIATELY AND SEEK THE ADVICE OF THE SUPERINTENDENT OR GITA.
- 9. COMPACT FILL TO 95% DRY DENSITY RATIO IN LAYERS OF THICKNESS APPROPRIATE TO THE COMPACTION PLANT EMPLOYED BUT NOT EXCEEDING 300mm.
- 10. AL DISTURBED AREAS SHALL BE GRASS SEEDED, HYDROMULCHED OR LANDSCAPED.

CONCRETE NOTES

- 1. ALL CONCRETE BE IN ACCORDANCE WITH AS 3600 CONCRETE STRUCTURE CODE.
- 2. ALL REINFORCING SHALL BE IN ACCORDANCE WITH AS 4671.
- 3. ALL FORMWORK AND FALSE WORK SHALL CONFORM TO AS 3610.
- 4. CONCRETE SHALL BE CURED TO AS 3799 FOR NOP LESS THAN 7 DAYS.

DRAINAGE NOTES

- 1. POLYPROPYLENE PIPES SHALL BE CLASS SN8, UNLESS NOTED OTHERWISE.
- 2. INSTALLATION OF POLYPROPYLENE AND PVC PIPES SHALL BE CARRIED OUT IN ACCORDANCE WITH AS 2566 AND MANUFACTURERS SPECIFICATIONS.
- 3. ALL PIPES TO BE LAID AT 1% MINIMUM GRADE, UNLESS NOTED OTHERWISE.

SITE SPECIFIC NOTES

- 1. THESE PLANS ARE TO READ IN CONJUNCTION WITH THE GEOTECHNICAL REPORT PREPARED BY GEO DESIGN. IN PARTICULAR ALL BATTER TREATMENTS ARE TO BE AS PER GEO DESIGN RECOMMENDATIONS.
- 2. STRIPPED VEGETATION IS TO BE REMOVED FROM SITE AND NOT STOCKPILED.

SCALES

wg					
02.d					
응[Α	ISSUED FOR APPROVAL	GB	GA	01/05/24
24004-C002.dwg	REV	DESCRIPTION	DRN	APP	DATE
File: 2		HIS DRAWING IS COPYRIGHT AND THE PROPERTY OF APPLIN CONSULTING. IT MUST	CERTIFIC	CATION	RPEQ
SAD F		Y BE USED BY THE NOMINATED CLIENT AND BY ANY PERSON WHO HAS BEEN AGREED OBY APPLIN CONSULTING FOR THE PURPOSE FOR WHICH IT WAS PREPARED FOR.	G. APP	LIN	6073

APPLIN — CONSULTING

M 0414 768 109 | E greg@applinconsulting.com.au

CLIENT

GEORGE ARGYROU

DESIGNED
G. BROWNING

DRAWN
G. BROWNING

CHECKED
G. APPLIN

PROJECT
KYRENIA

14 MURPH
TITLE
STANDA

KYRENIA RESIDENCE

14 MURPHY STREET (LOT 114 PTD2094)

TITLE


STANDARD NOTES


STATUS
FOR APPROVAL


SCALE (AT FULL SIZE)
- A1


DRAWING NUMBER
24004-C002

A

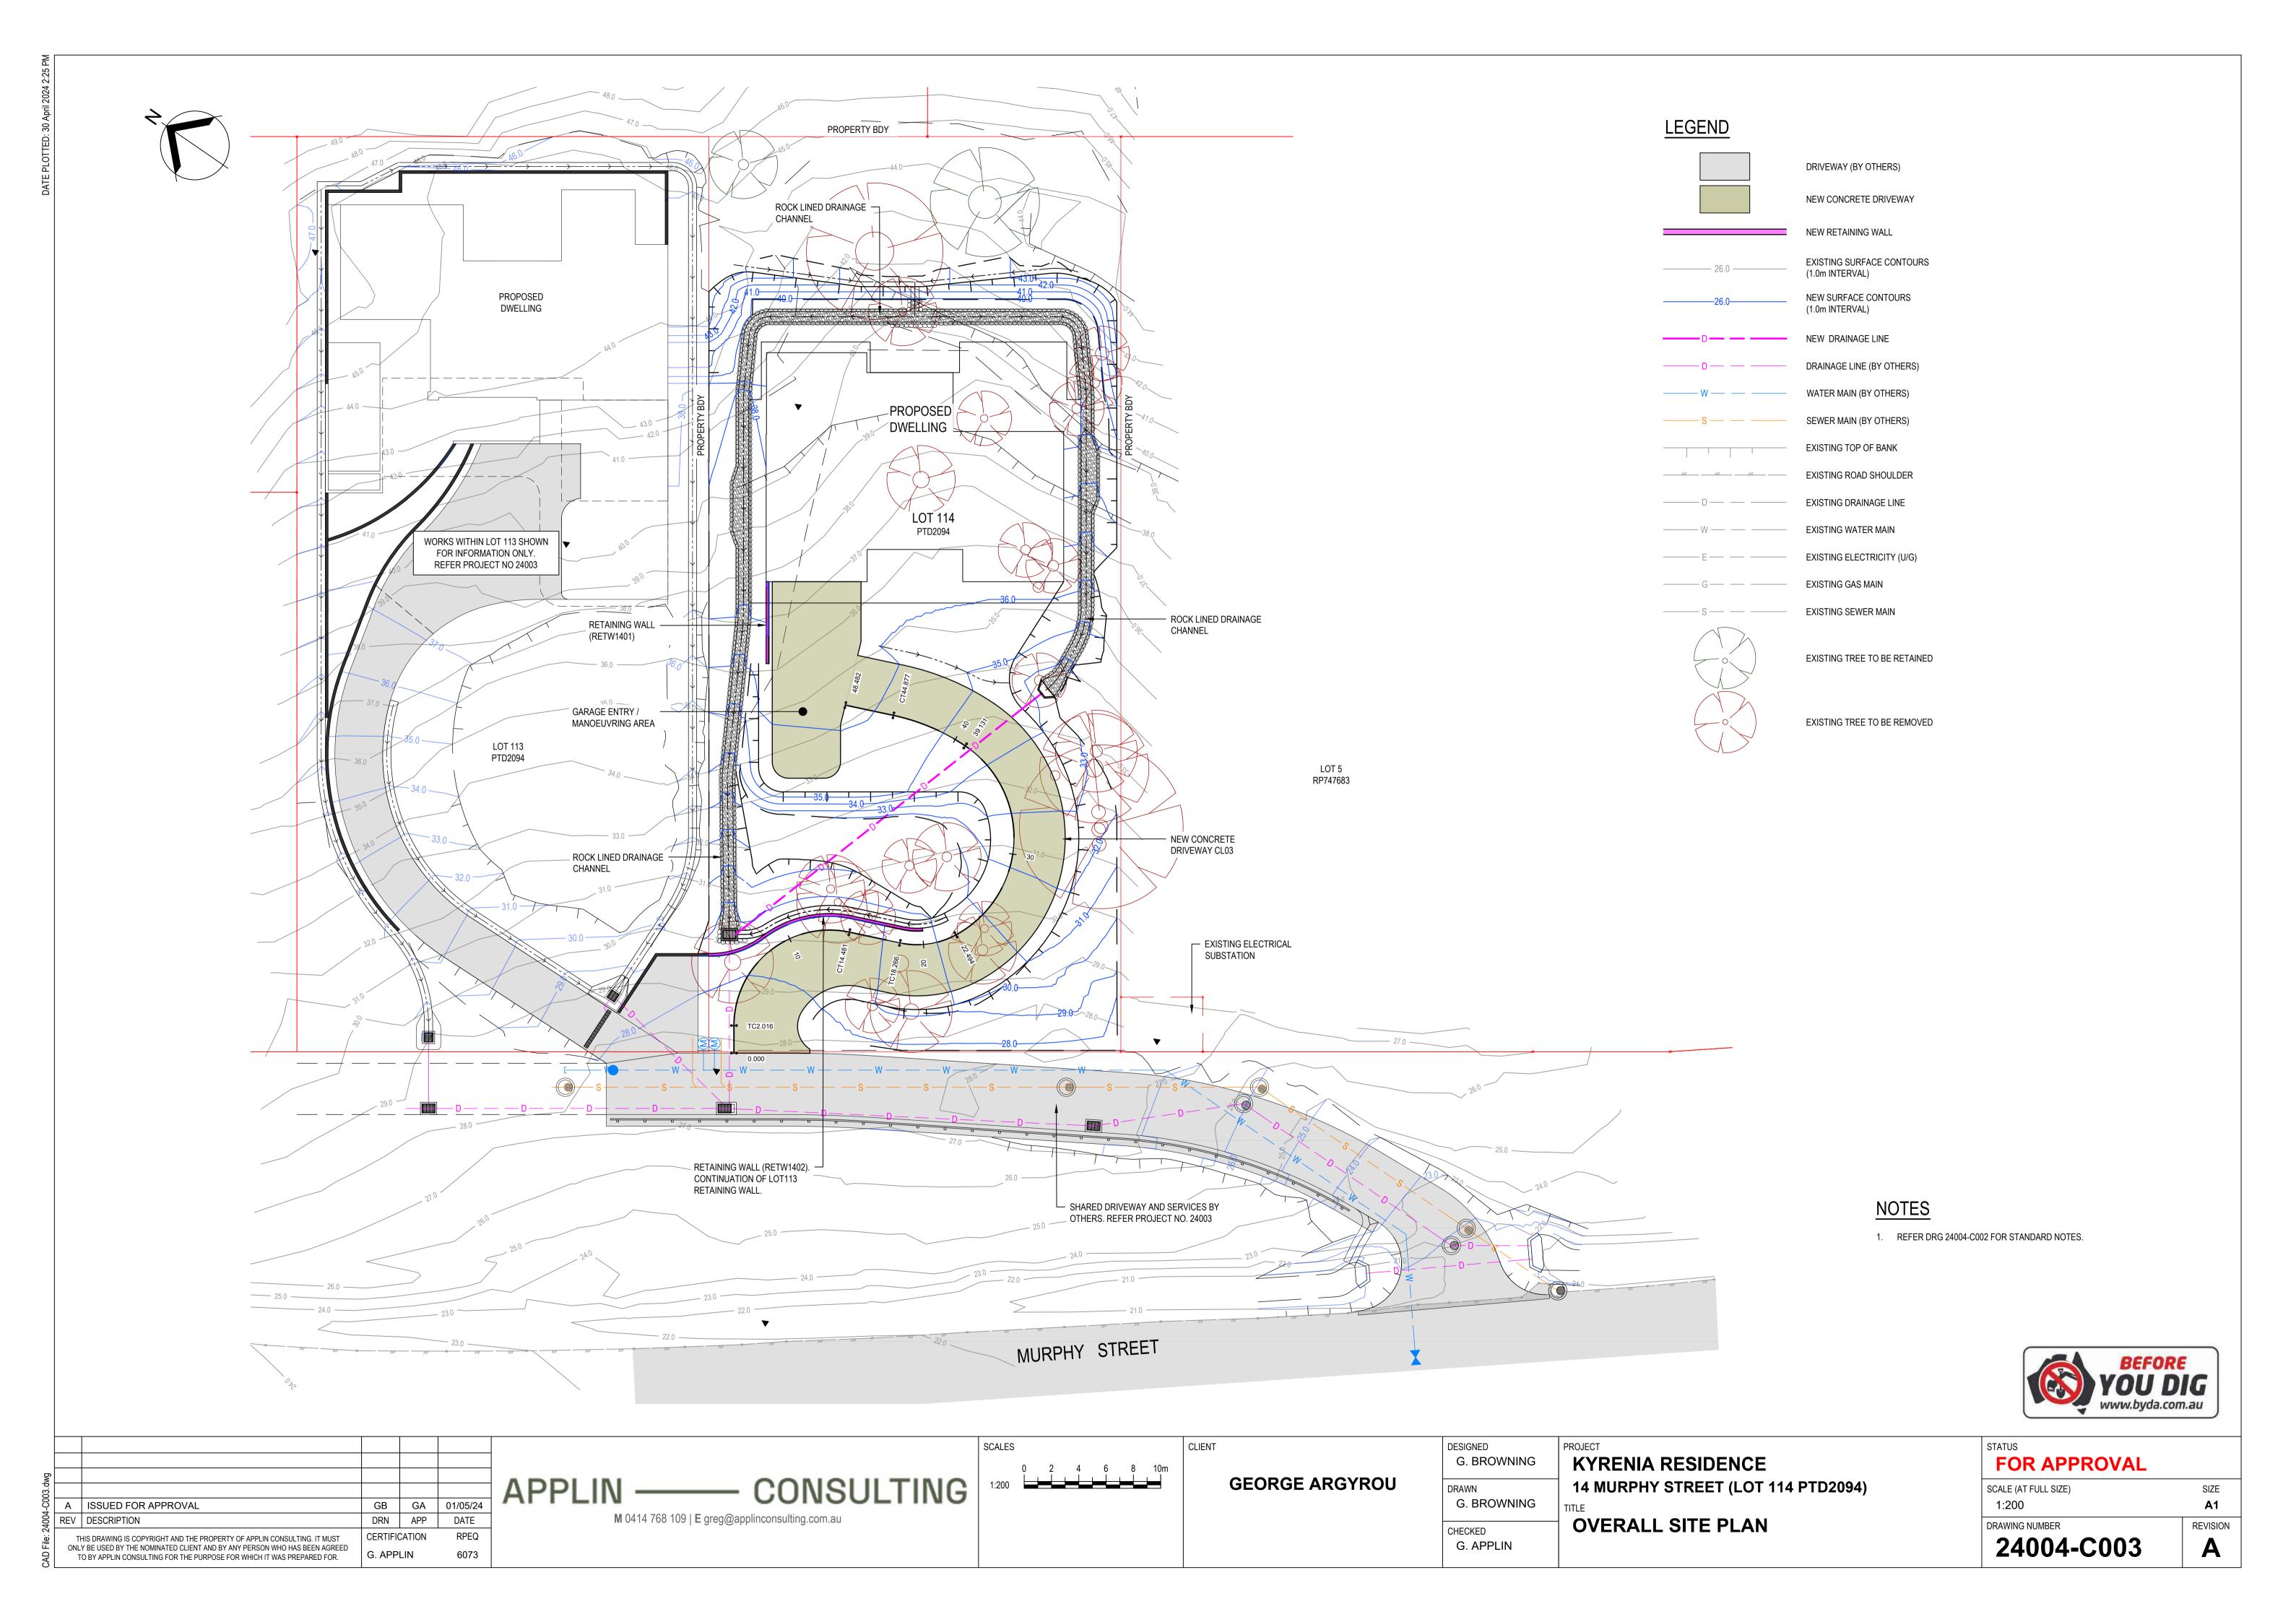


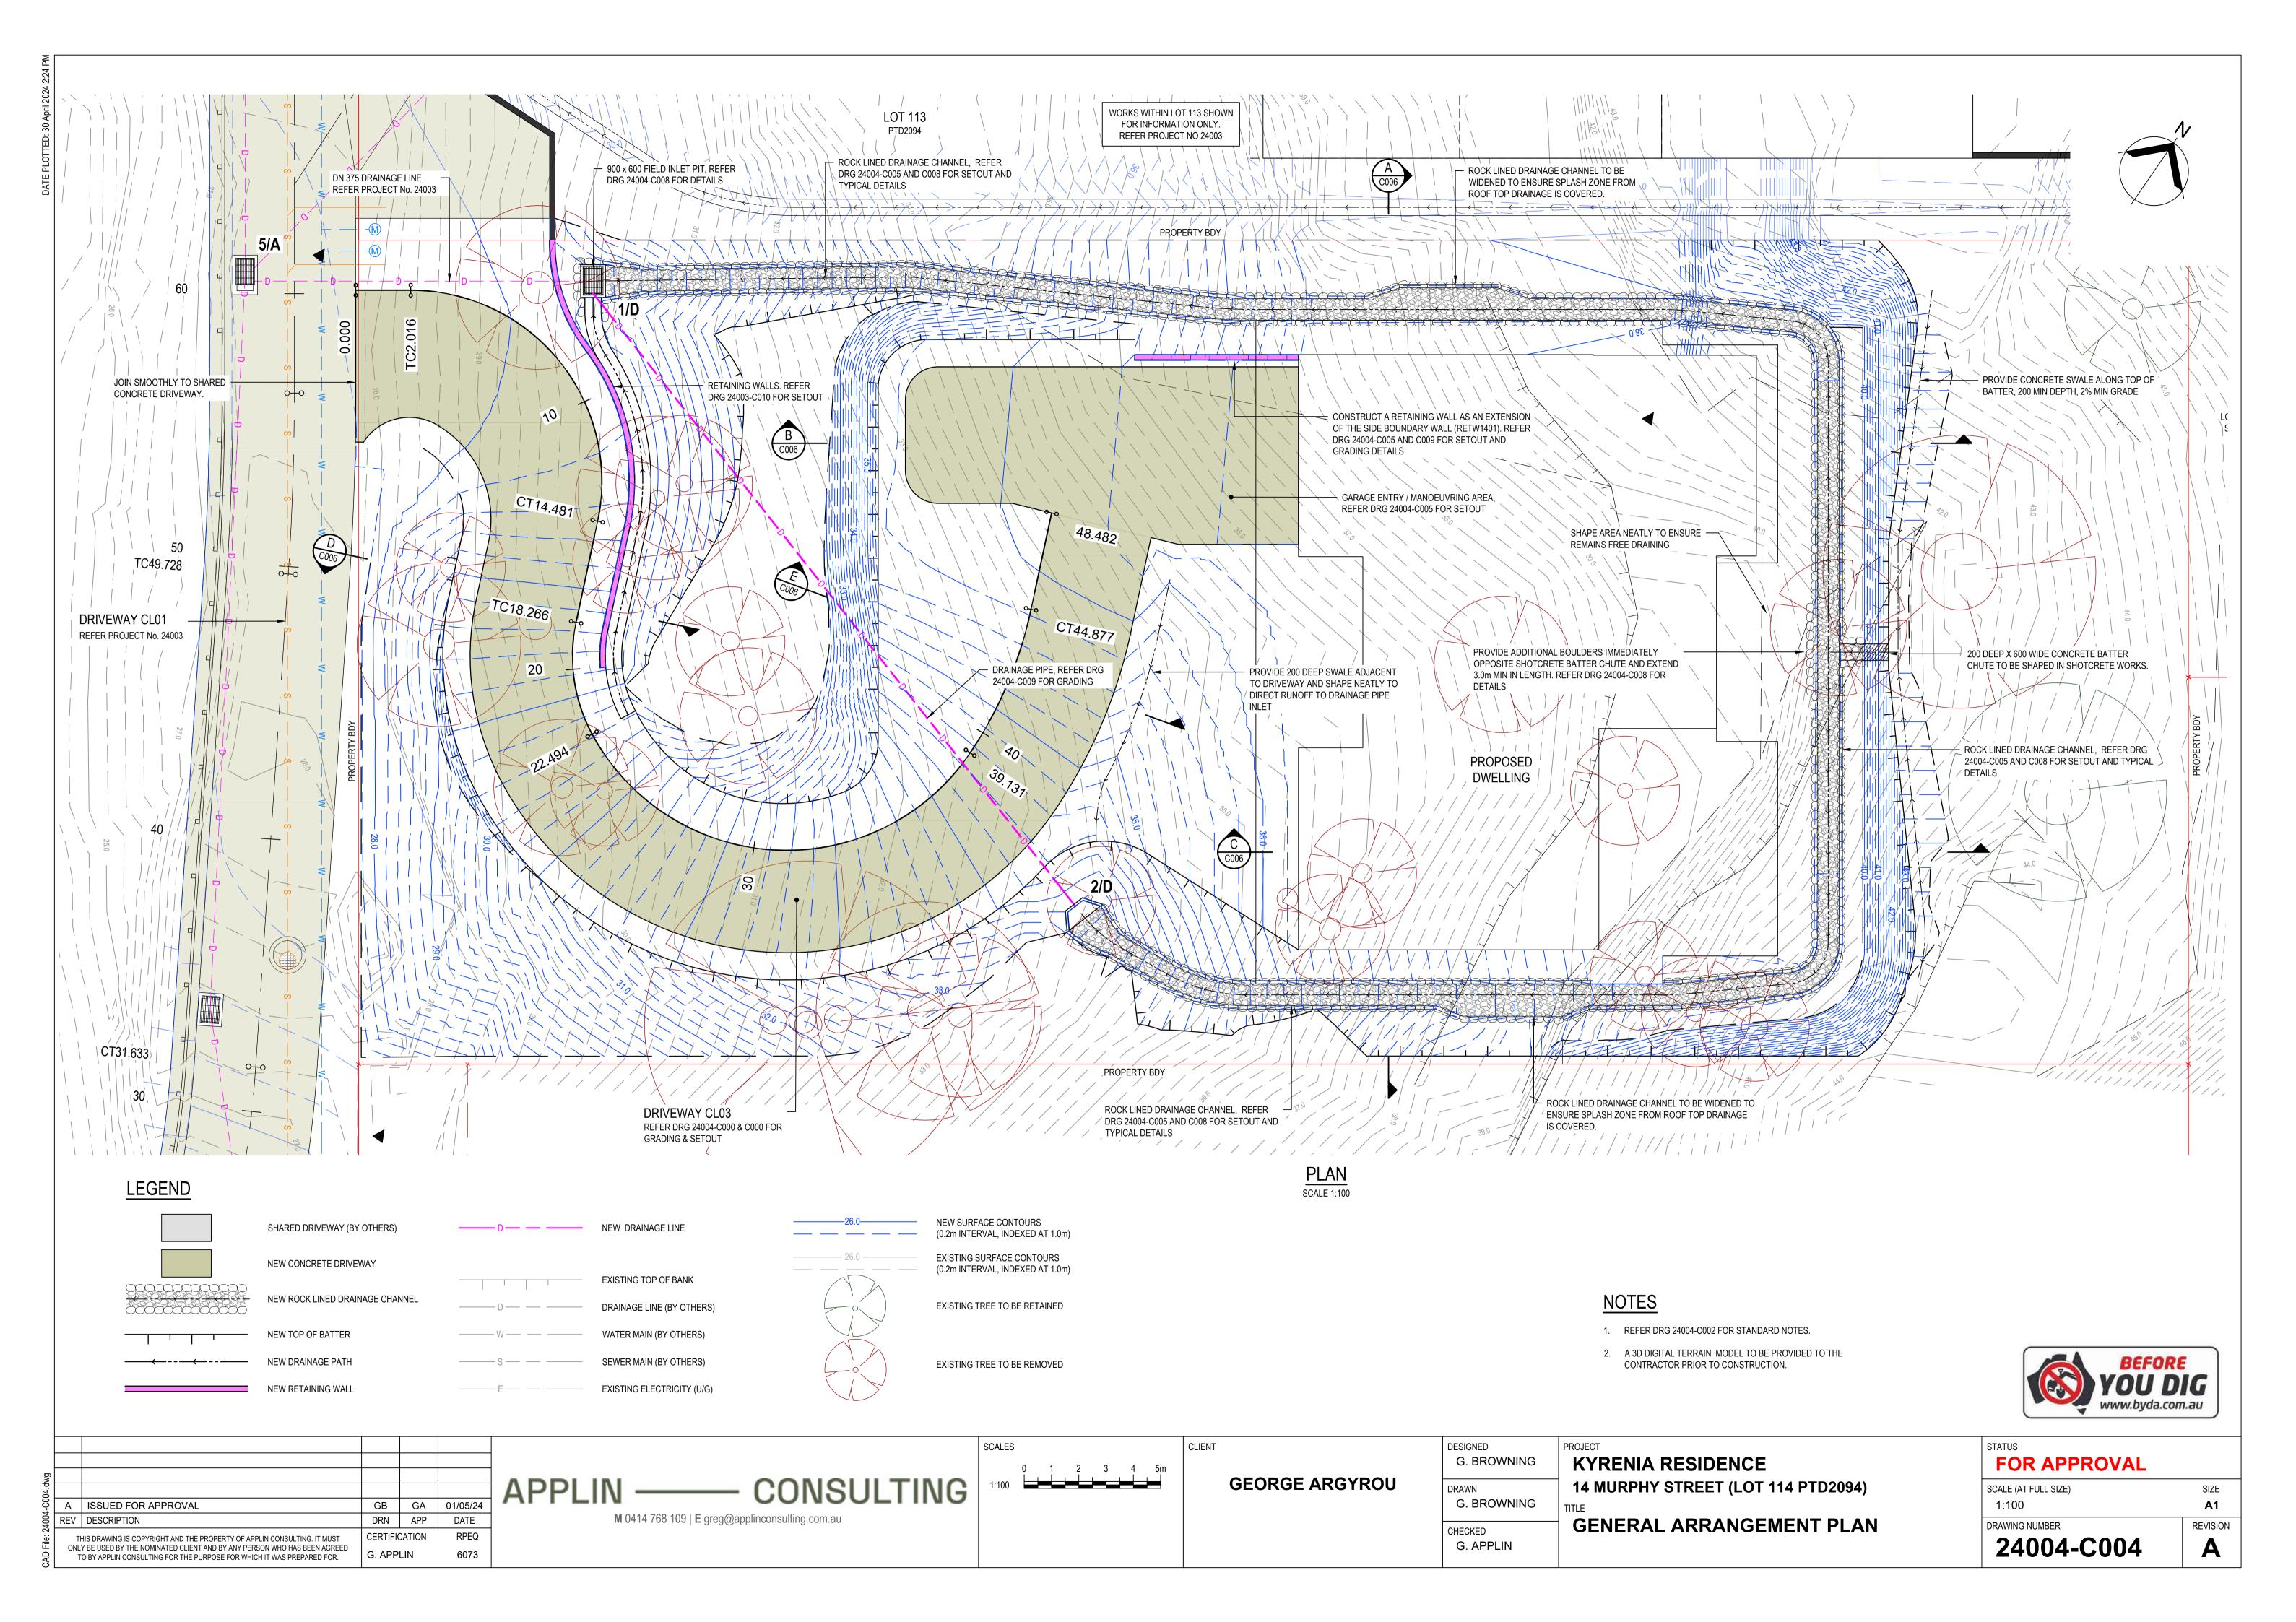


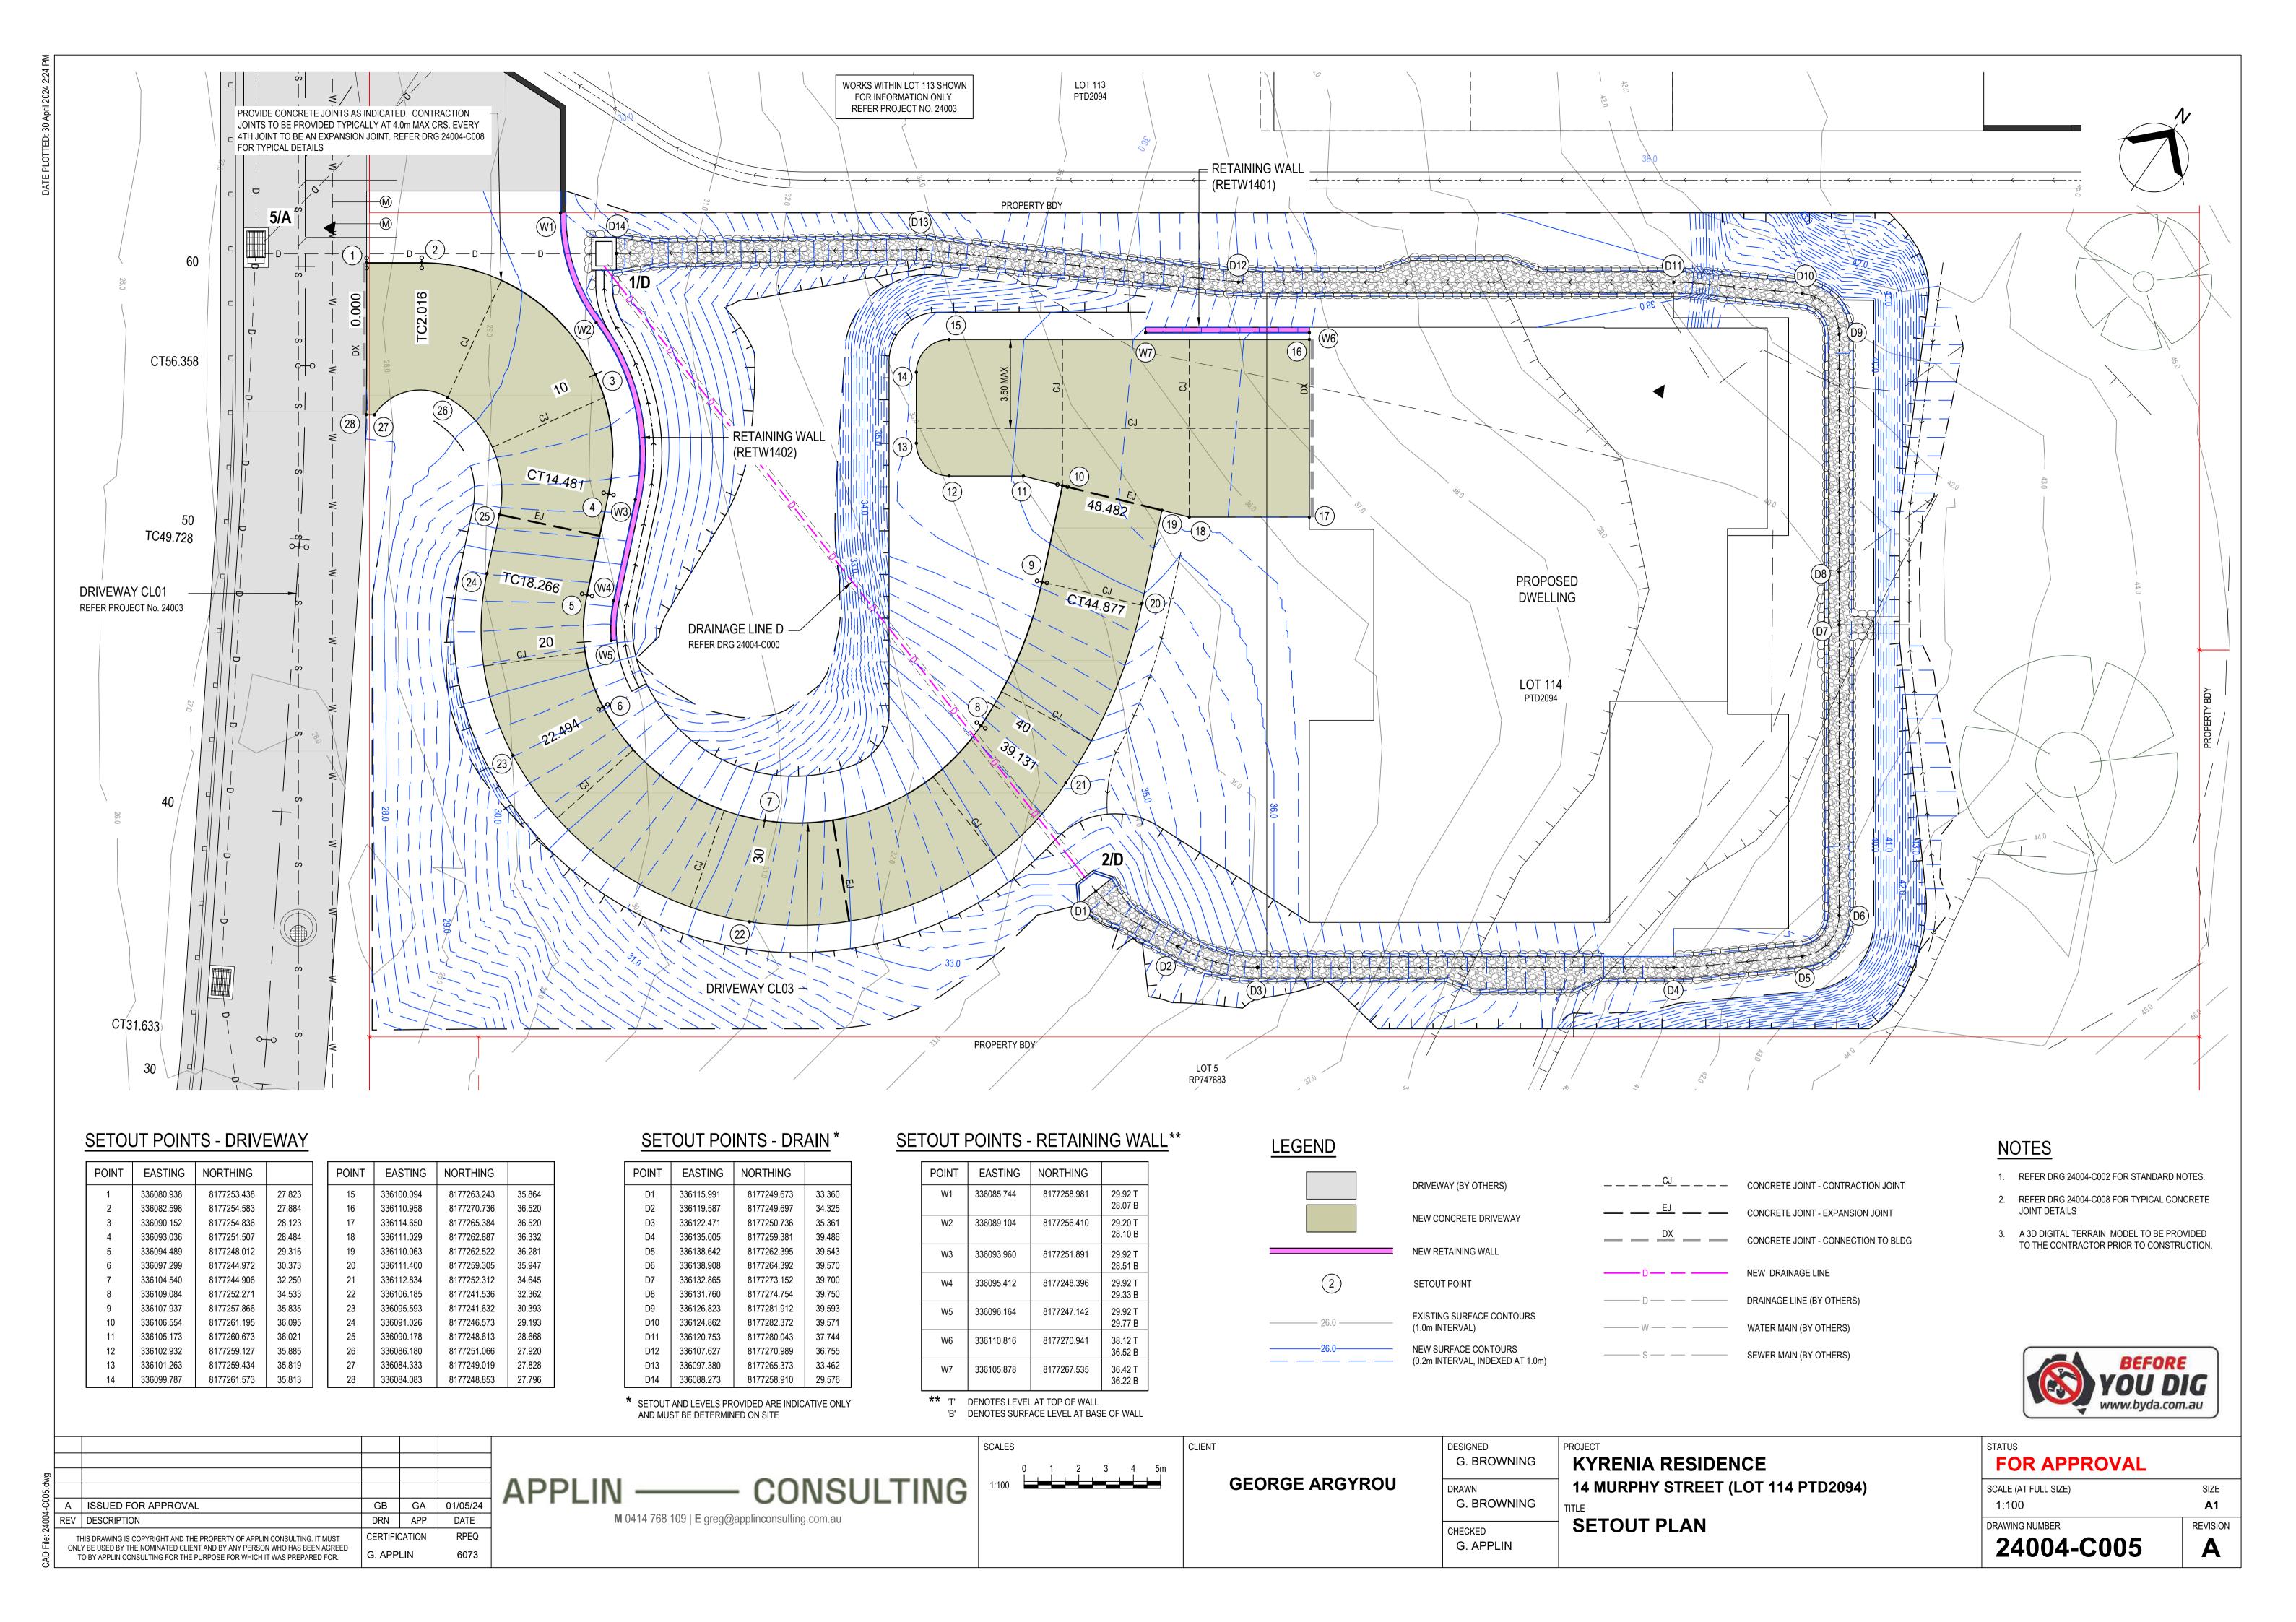


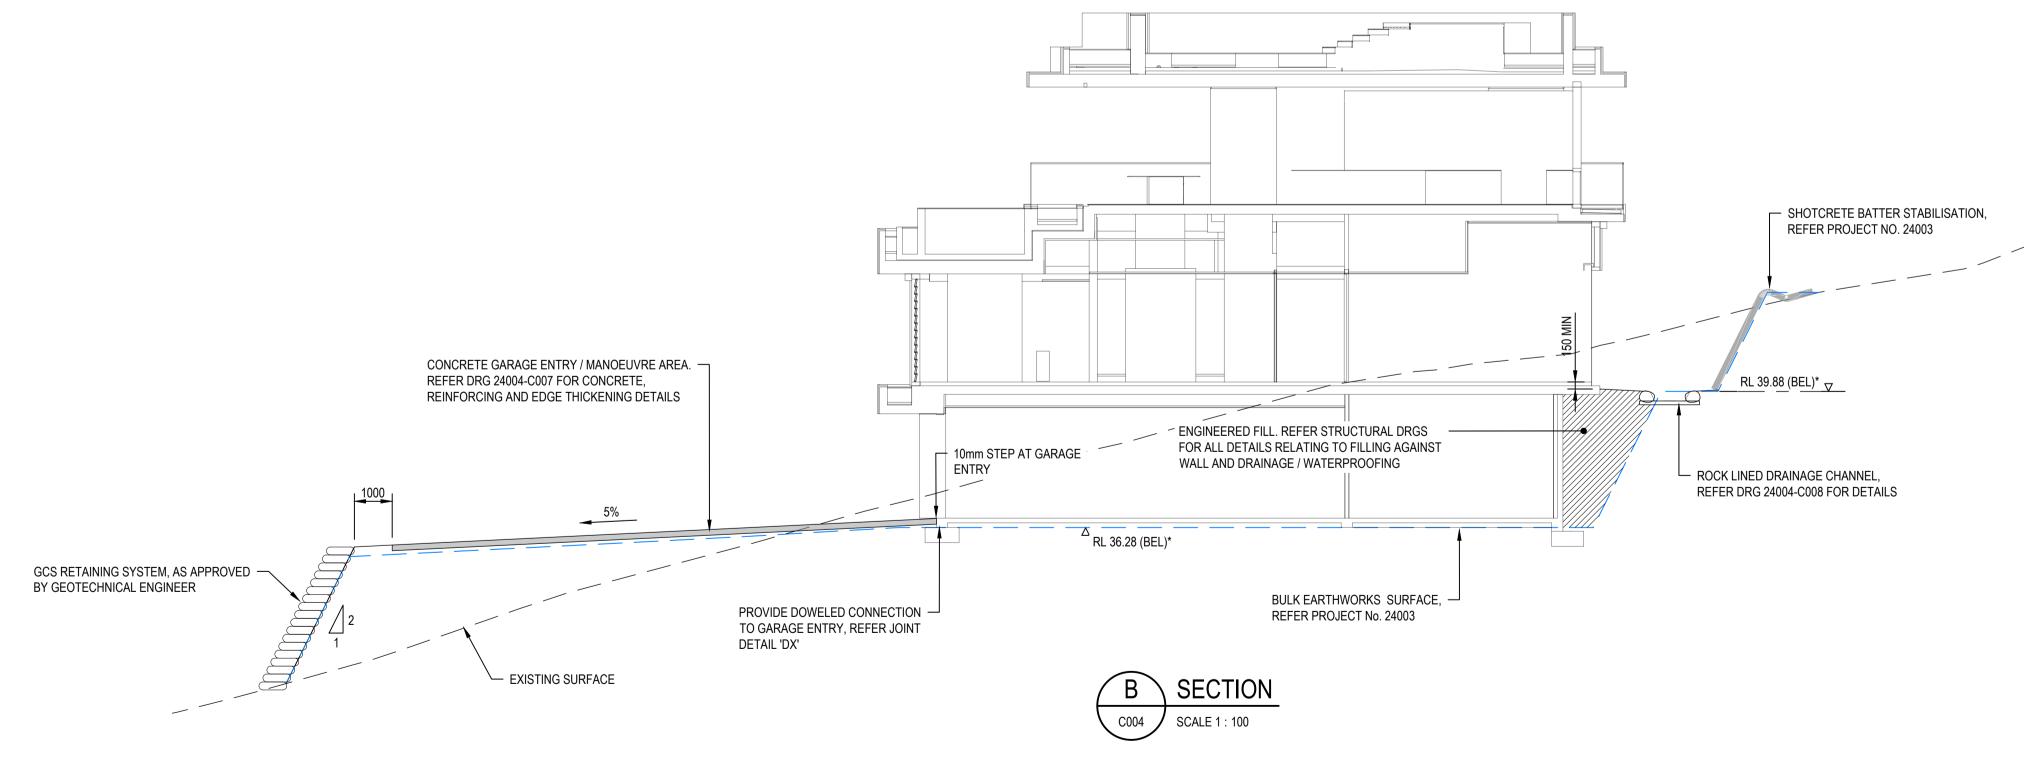

6 ₀					SCALES 0 1 2 3 4 5m	CLIENT	DESIGNED G. BROWNING	KYRENIA RESIDENCE	FOR APPROVAL	
24-C006.dv	ISSUED FOR APPROVAL	GB GA	01/05/24	APPLIN — CONSULTING	1:100	GEORGE ARGYROU	DRAWN G. BROWNING	14 MURPHY STREET (LOT 114 PTD2094) TITLE	SCALE (AT FULL SIZE) AS SHOWN	SIZE A1
CAD File: 2400	V DESCRIPTION THIS DRAWING IS COPYRIGHT AND THE PROPERTY OF APPLIN CONSULTING. IT MUST ONLY BE USED BY THE NOMINATED CLIENT AND BY ANY PERSON WHO HAS BEEN AGREED TO BY APPLIN CONSULTING FOR THE PURPOSE FOR WHICH IT WAS PREPARED FOR.	DRN APP CERTIFICATION G. APPLIN	DATE RPEQ 6073	M 0414 768 109 E greg@applinconsulting.com.au			CHECKED G. APPLIN	SITE SECTIONS	24004-C006	REVISION

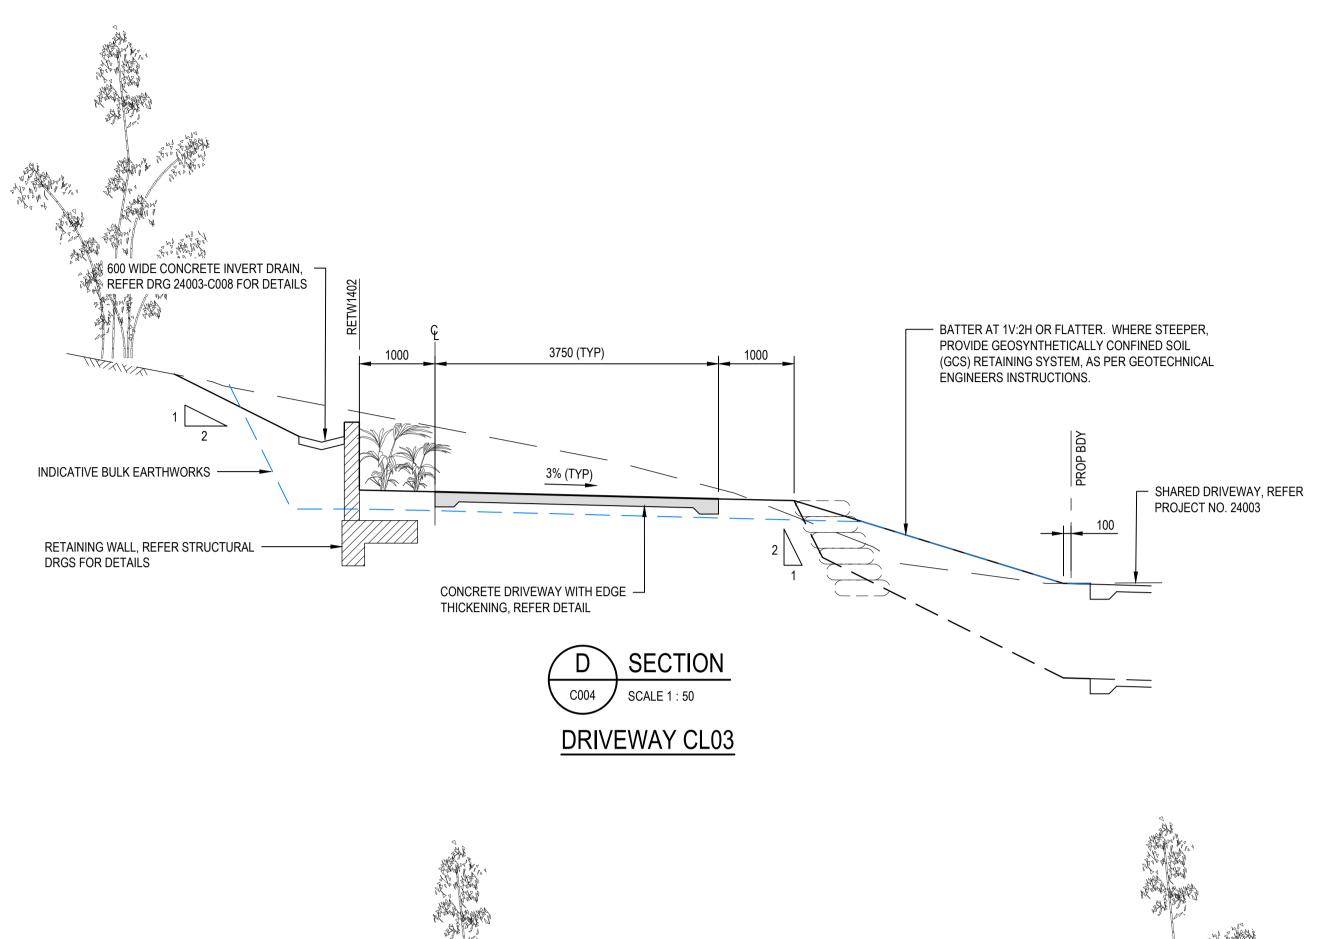


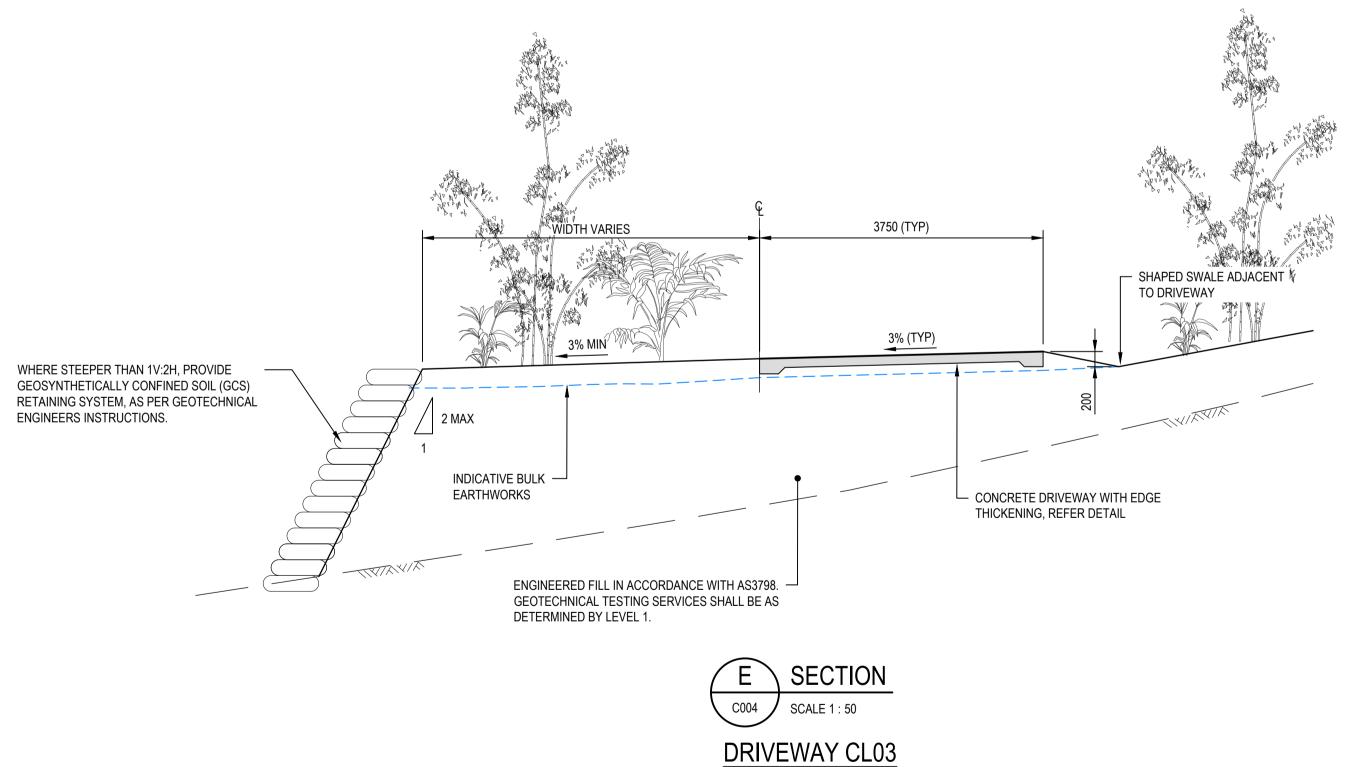

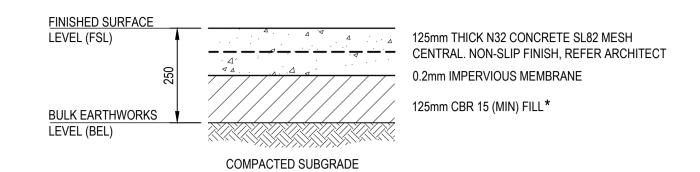


* ALTERNATIVE SUB BASE MATERIAL TYPES MAY BE CONSIDER AS A TEMPORARY RUNNING SURFACE


DRIVEWAY CL03

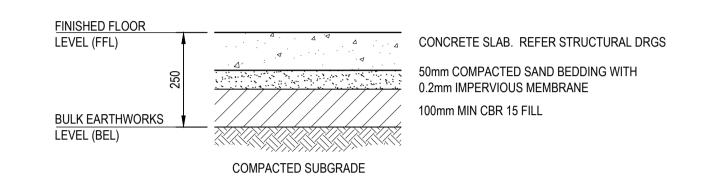

BUILDING PLATFORM

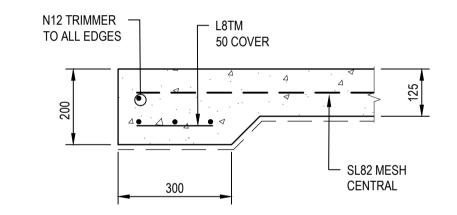

EDGE THICKENING
SCALE 1:10

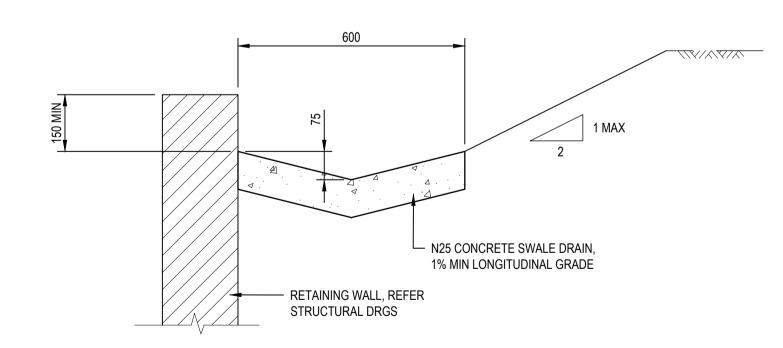


CONCRETE SWALE DRAIN

.dwg					
07.0					
4-C007	Α	ISSUED FOR APPROVAL	GB	GA	01/05/24
24004-	REV	DESCRIPTION	DRN	APP	DATE
File: 2	TH	HIS DRAWING IS COPYRIGHT AND THE PROPERTY OF APPLIN CONSULTING. IT MUST	CERTIFIC	CATION	RPEQ
CAD F		Y BE USED BY THE NOMINATED CLIENT AND BY ANY PERSON WHO HAS BEEN AGREED O BY APPLIN CONSULTING FOR THE PURPOSE FOR WHICH IT WAS PREPARED FOR.	G. APP	LIN	6073

APPLIN — CONSULTING


M 0414 768 109 | E greg@applinconsulting.com.au

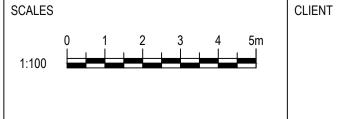



GEORGE ARGYROU


DESIGNED	PROJECT
G. BROWNING	KYRENIA RESIDENCE
DRAWN G. BROWNING	14 MURPHY STREET (LOT 114 PTD2094
CHECKED G. APPLIN	TYPE SECTIONS AND DETAILS

FOR APPROVAL	
SCALE (AT FULL SIZE) AS SHOWN	SIZE A1
DRAWING NUMBER	REVISION
24004-C007	Α

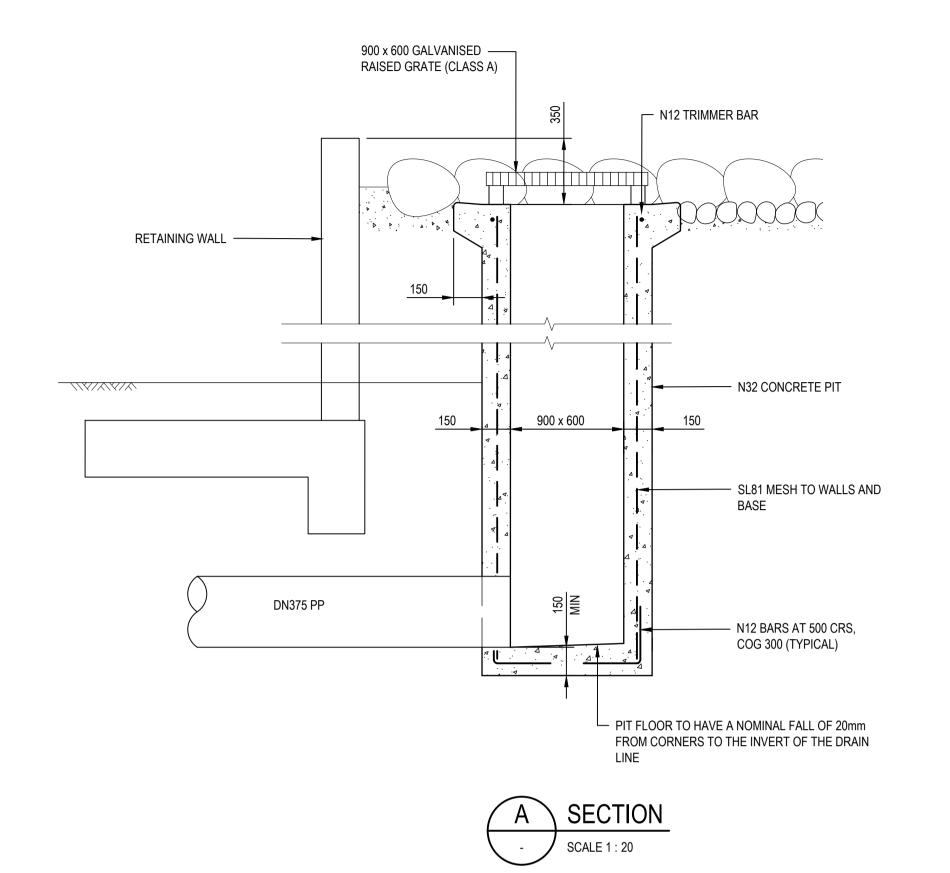

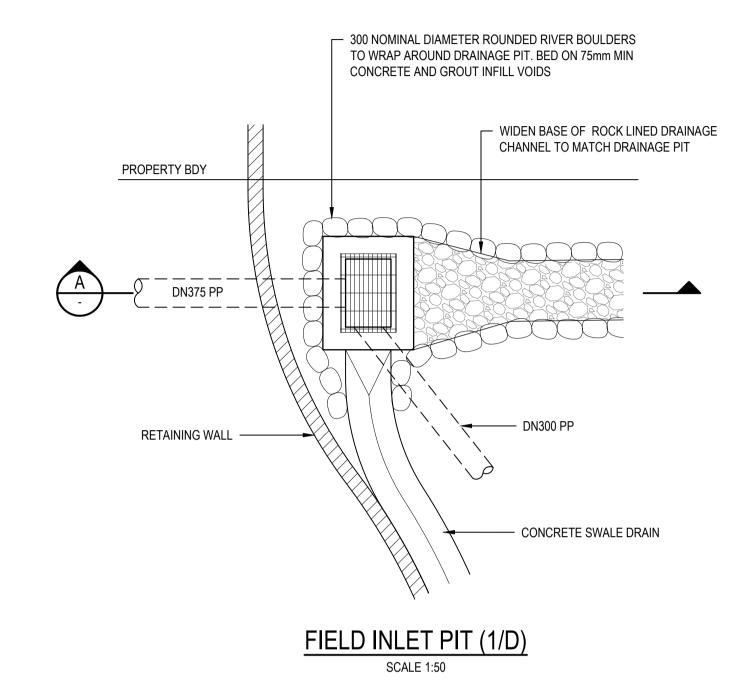


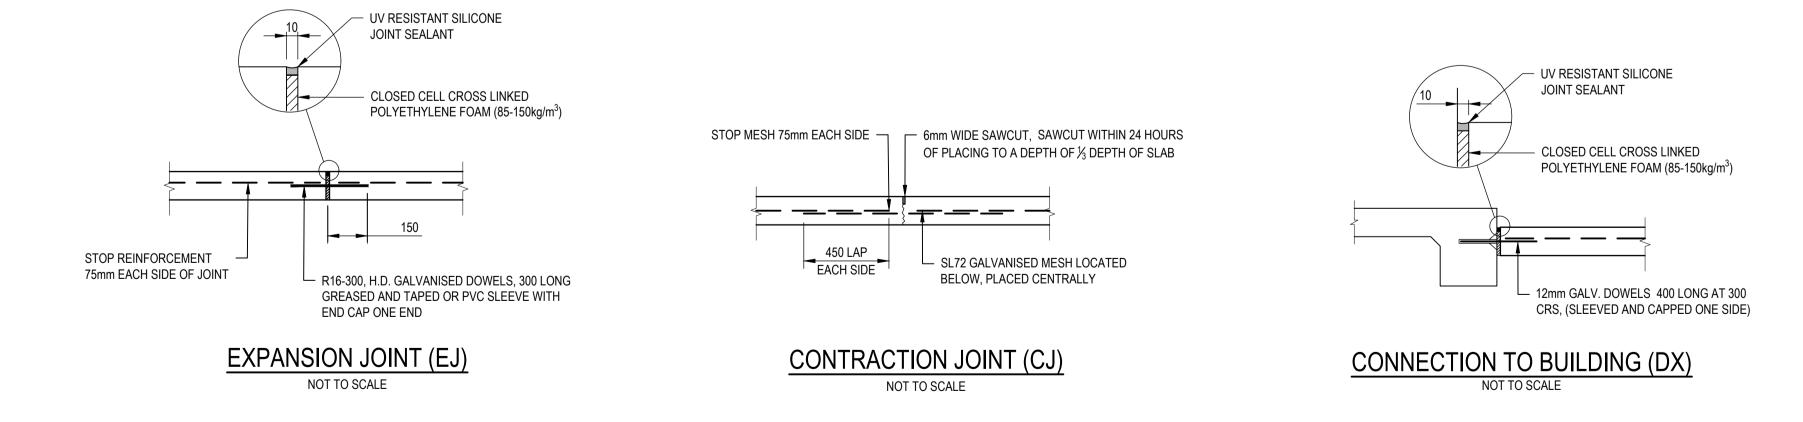

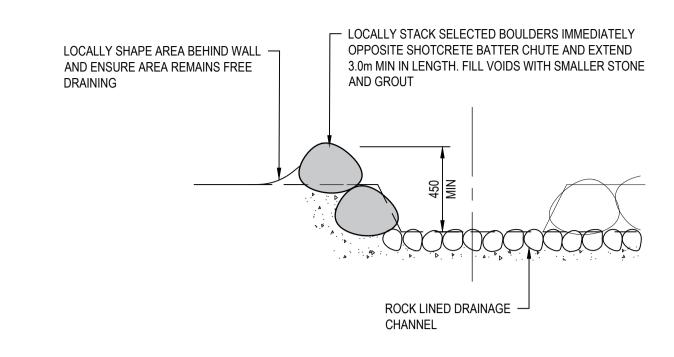

BATTER CHUTE PROTECTION

SCALE 1:20

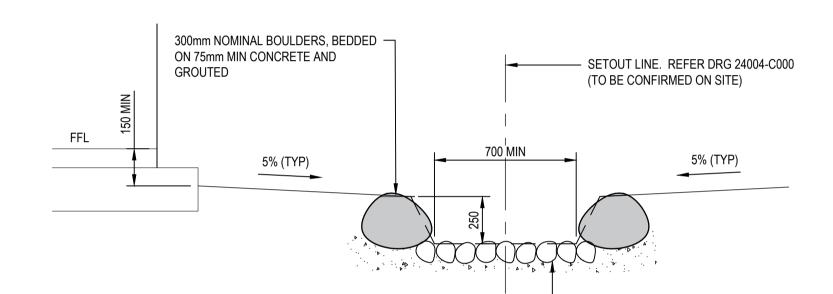


100mm ROUNDED RIVER ROCK STONE PITCHING BEDDED ON 75mm MIN THICK CONCRETE AND GROUTED

ROCK LINED DRAINAGE CHANNEL

SCALE 1:20

			SCALES 0 1 2 3 4 5m	CLIENT	DESIGNED G. BROWNING	KYRENIA RESIDENCE	FOR APPROVAL	
A ISSUED FOR APPROVAL	GB GA 01/05/24	APPLIN ——— CONSULTING	1:100	GEORGE ARGYROU	DRAWN G. BROWNING	14 MURPHY STREET (LOT 114 PTD2094)	SCALE (AT FULL SIZE) AS SHOWN	SIZE A1
THIS DRAWING IS COPYRIGHT AND THE PROPERTY OF APPLIN CONSULTING. IT MUST ONLY BE USED BY THE NOMINATED CLIENT AND BY ANY PERSON WHO HAS BEEN AGREED TO BY APPLIN CONSULTING FOR THE PURPOSE FOR WHICH IT WAS PREPARED FOR.	DRN APP DATE CERTIFICATION RPEQ G. APPLIN 6073	M 0414 768 109 E greg@applinconsulting.com.au			CHECKED G. APPLIN	MISCELLANEOUS DETAILS	24004-C008	REVISION

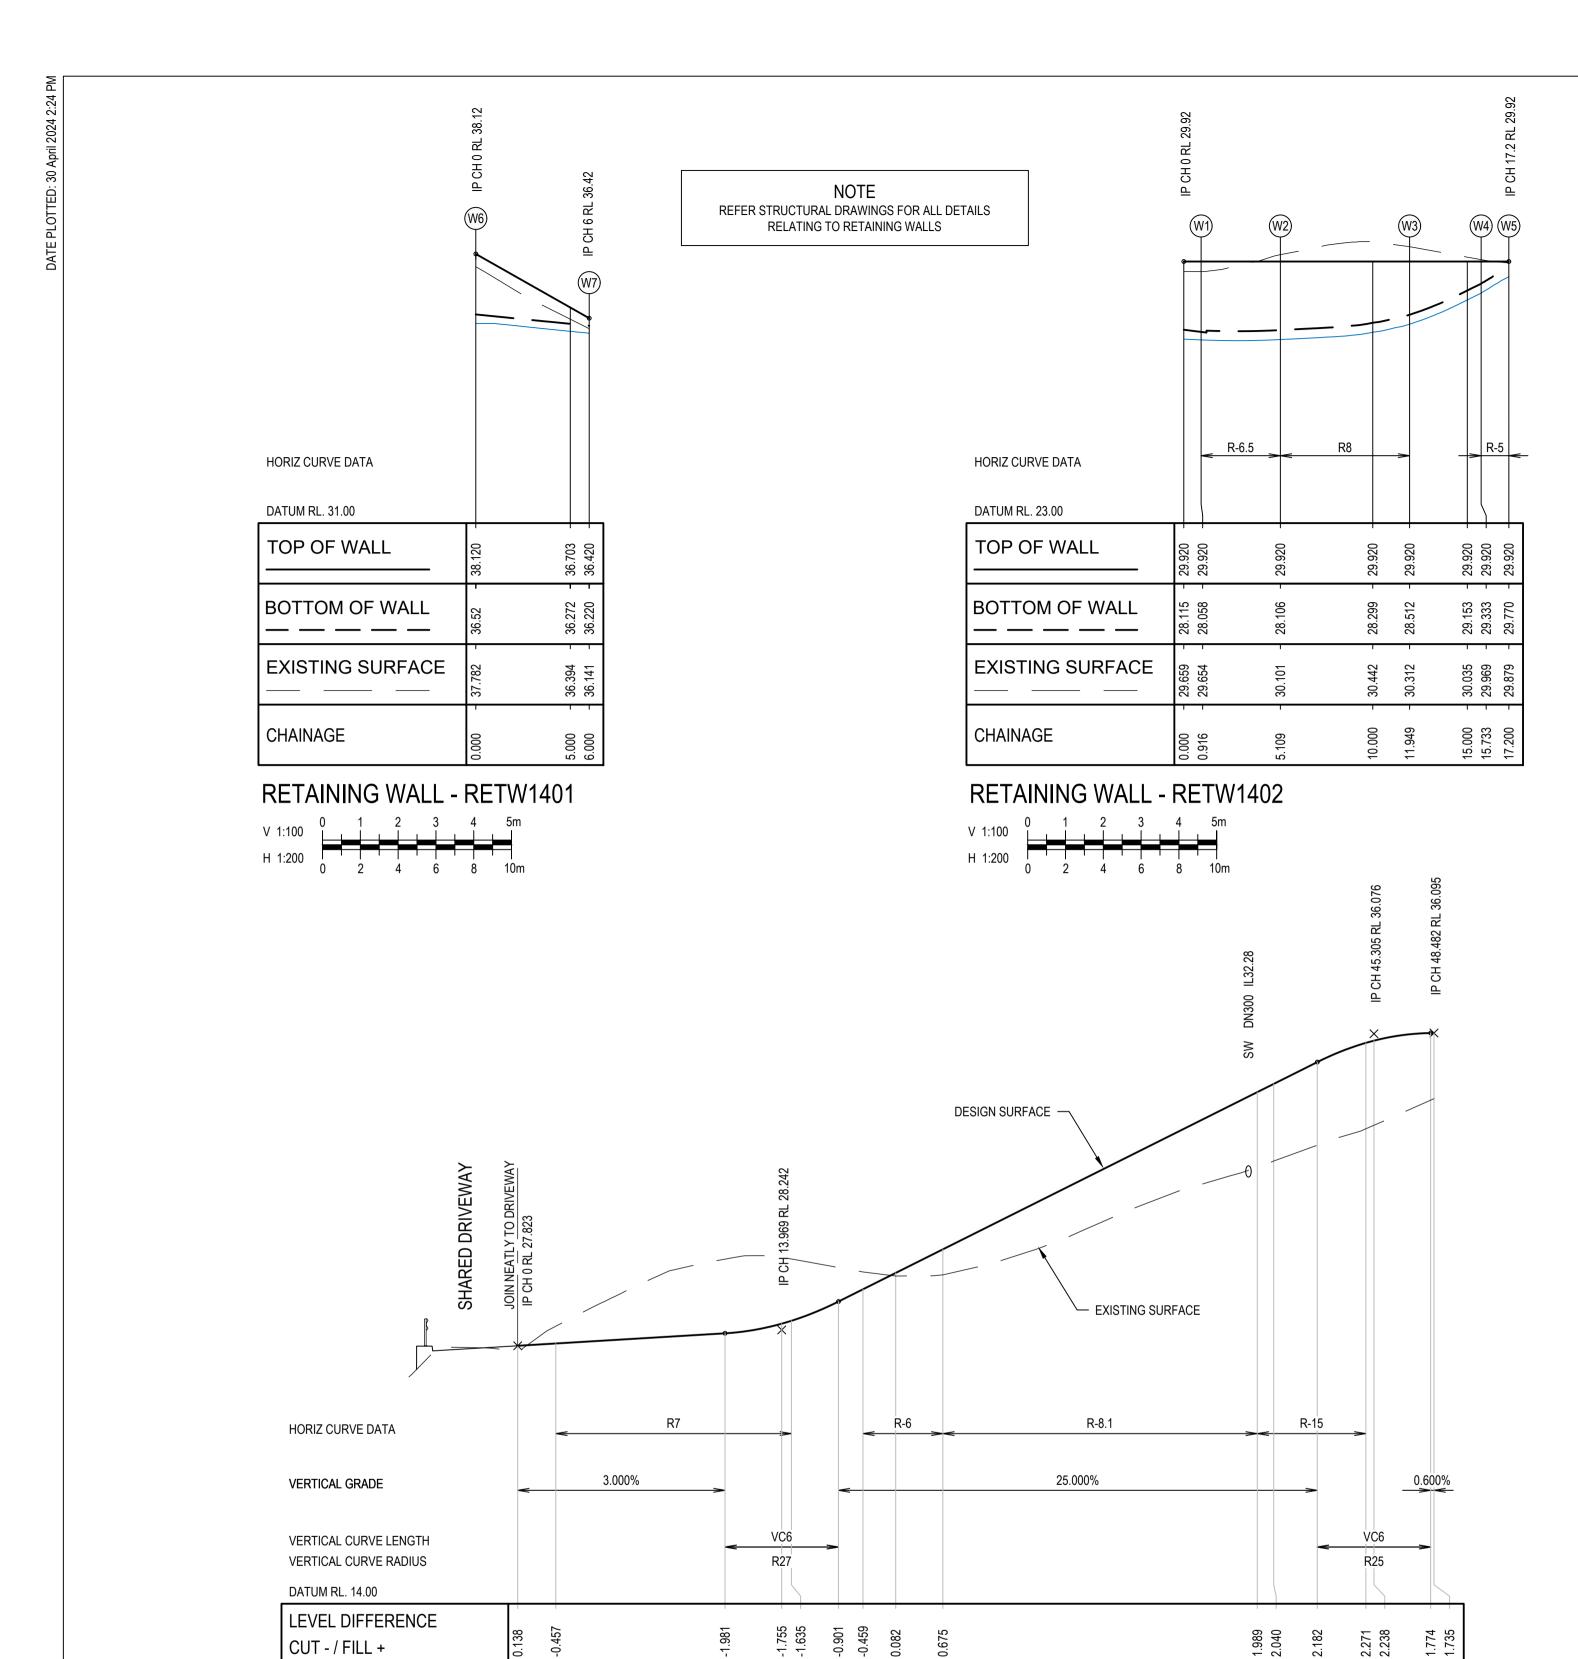

LONGITUDINAL SECTION - DRIVEWAY CL03

GB GA 01/05/24 A | ISSUED FOR APPROVAL DRN APP DATE REV DESCRIPTION **RPEQ** CERTIFICATION THIS DRAWING IS COPYRIGHT AND THE PROPERTY OF APPLIN CONSULTING. IT MUST ONLY BE USED BY THE NOMINATED CLIENT AND BY ANY PERSON WHO HAS BEEN AGREED 6073 G. APPLIN

TO BY APPLIN CONSULTING FOR THE PURPOSE FOR WHICH IT WAS PREPARED FOR.

CUT - / FILL +

CHAINAGE

DESIGN SURFACE LEVEL

EXISTING SURFACE LEVEL

APPLIN — CONSULTING M 0414 768 109 | E greg@applinconsulting.com.au

28.484 28.992 29.316 29.750 30.373

30.162 30.119 29.893 29.775 29.668 29.699

13.969 14.481 16.969 18.266 20.000 22.493

GEORGE ARGYROU

DESIGNED	PROJECT
G. BROWNING	KYF
DRAWN	14 M
G. BROWNING	TITLE
CHECKED	
G. APPLIN	

PIPE LENGTH

DRAINAGE LINE

RENIA RESIDENCE MURPHY STREET (LOT 114 PTD2094)

29.015

D

12.747

NGITUDINAL SECTIONS

FOR APPROVAL	
SCALE (AT FULL SIZE)	SIZE
AS SHOWN	A 1
DRAWING NUMBER	REVISION

A

STRUCTURE NAME STRUCTURE DESCRIPTION DN375, REFER PROJECT NO. 24003 PIPE SIZE (mm) PP (SN8) PIPE TYPE (CLASS) PIPE GRADE (%) PIPE SLOPE (1 in X) PIPE FLOW (cumecs) CAPACITY FLOW (cumecs) FULL PIPE VELOCITY (m/s) NORMAL DEPTH VELOCITY (m/s) RL 16.00 33.798 33.605 28.854 27.650 27.409 HYDRAULIC GRADE LINE (10YR ARI) 0.820 2.898 DEPTH TO INVERT 28.750 26.672 INVERT LEVEL OF DRAIN DESIGN SURFACE LEVEL SETOUT COORDINATES

NOTES

1. REFER DRG 24004-C002 FOR STANDARD NOTES.

BEFORE

CLIENT


35.835 35.893 36.094 36.095


33.564 33.656 34.321 34.360

39.130 40.000 42.305 44.877 45.305 48.305 48.482


SCALES


24004-C009

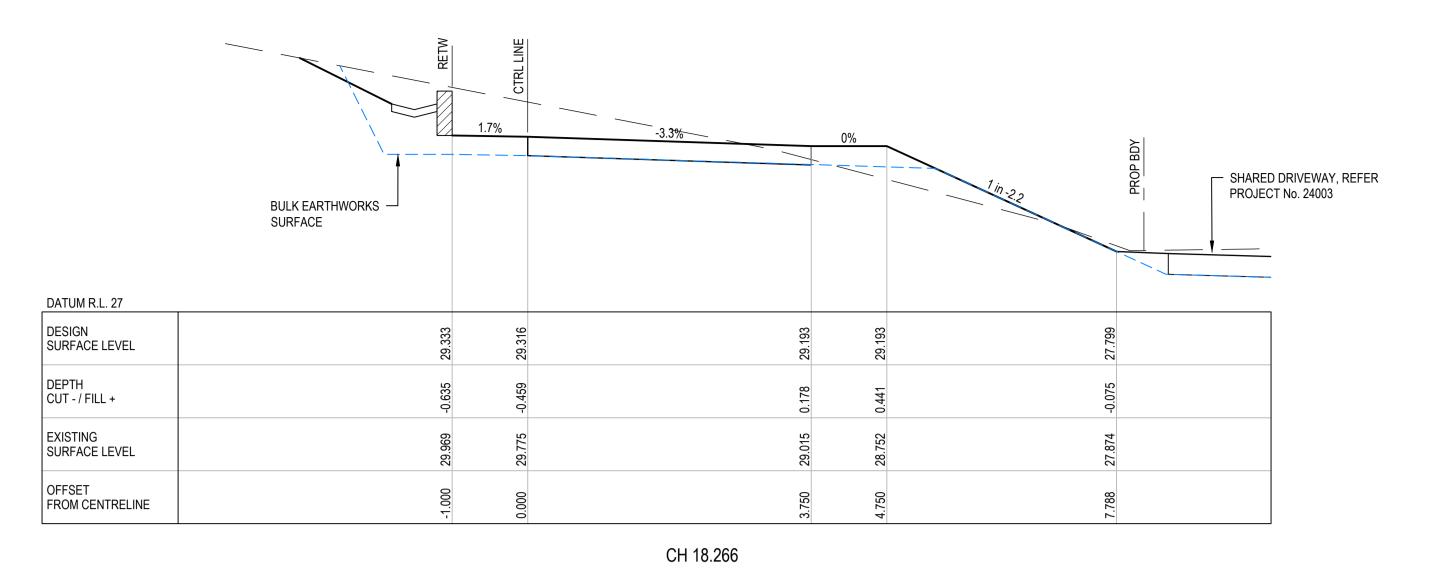


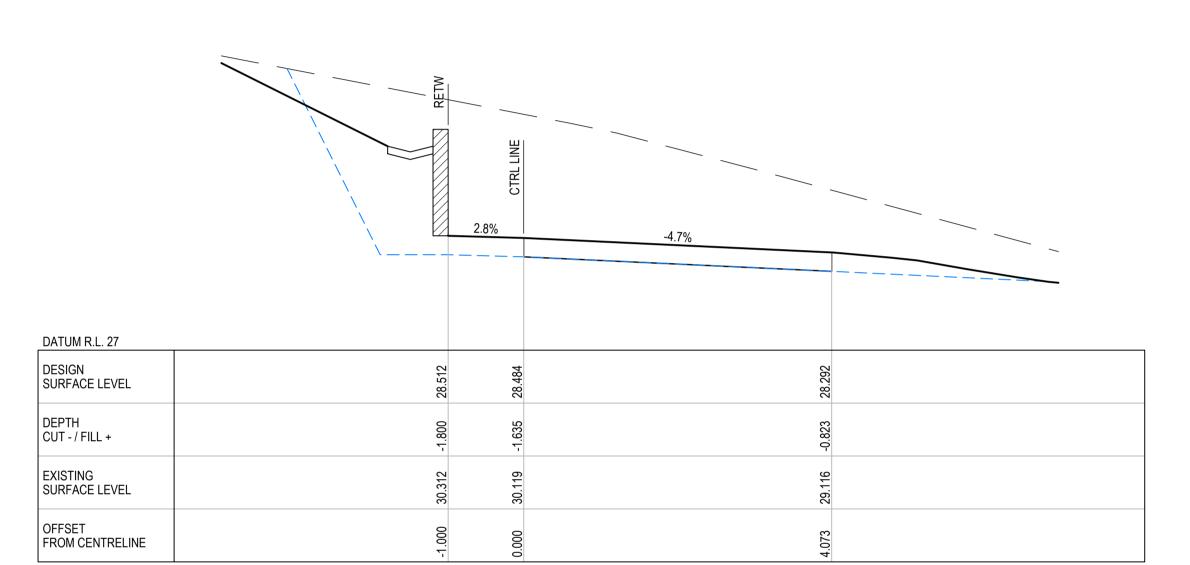


CH 14.481

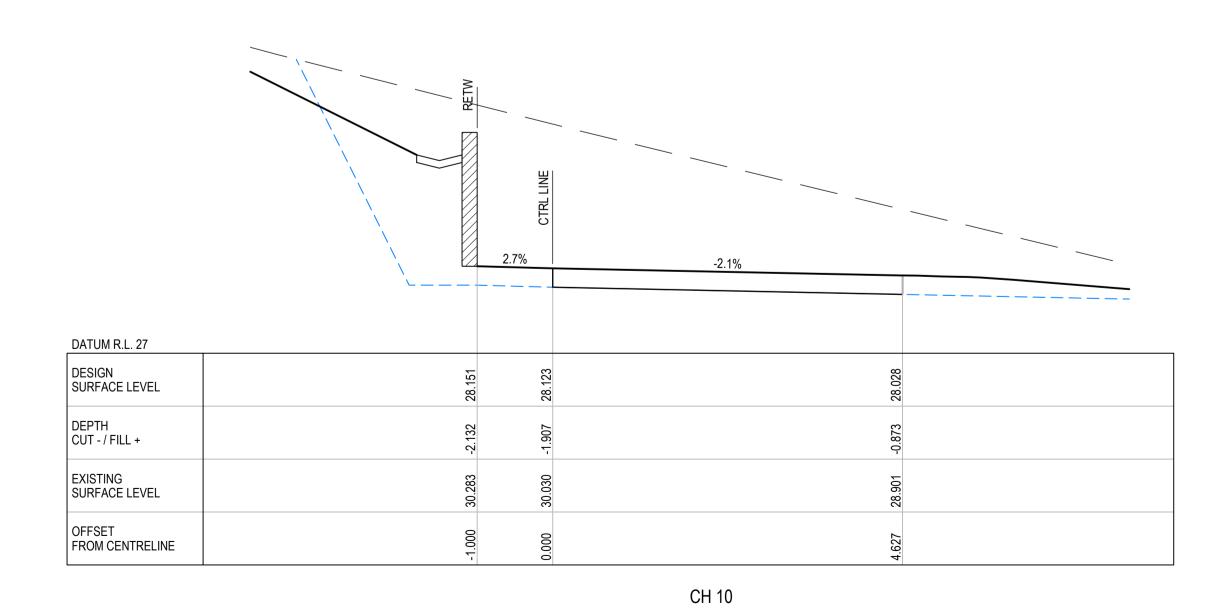

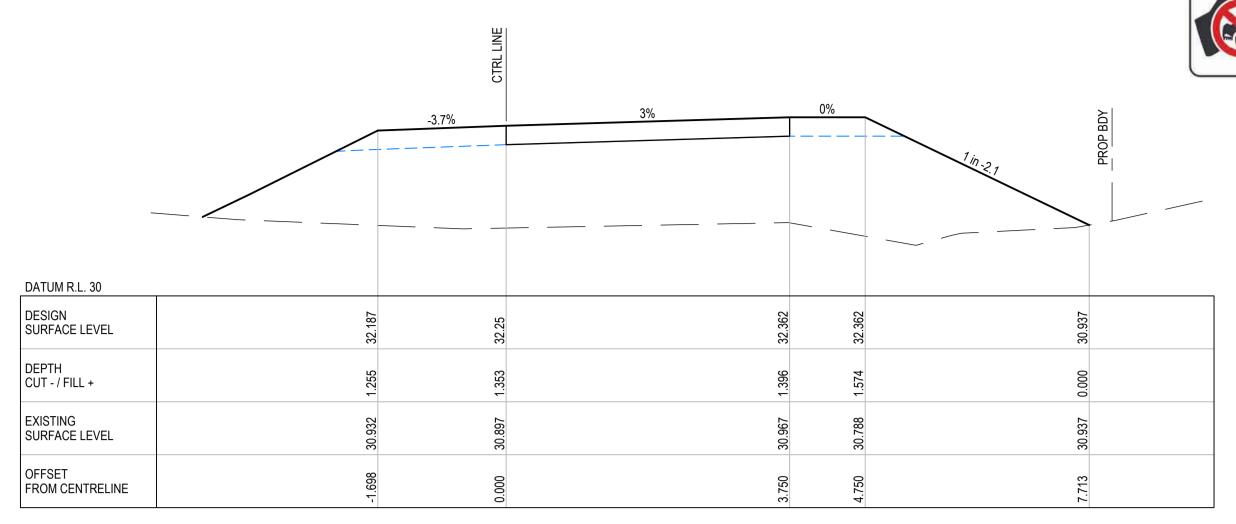

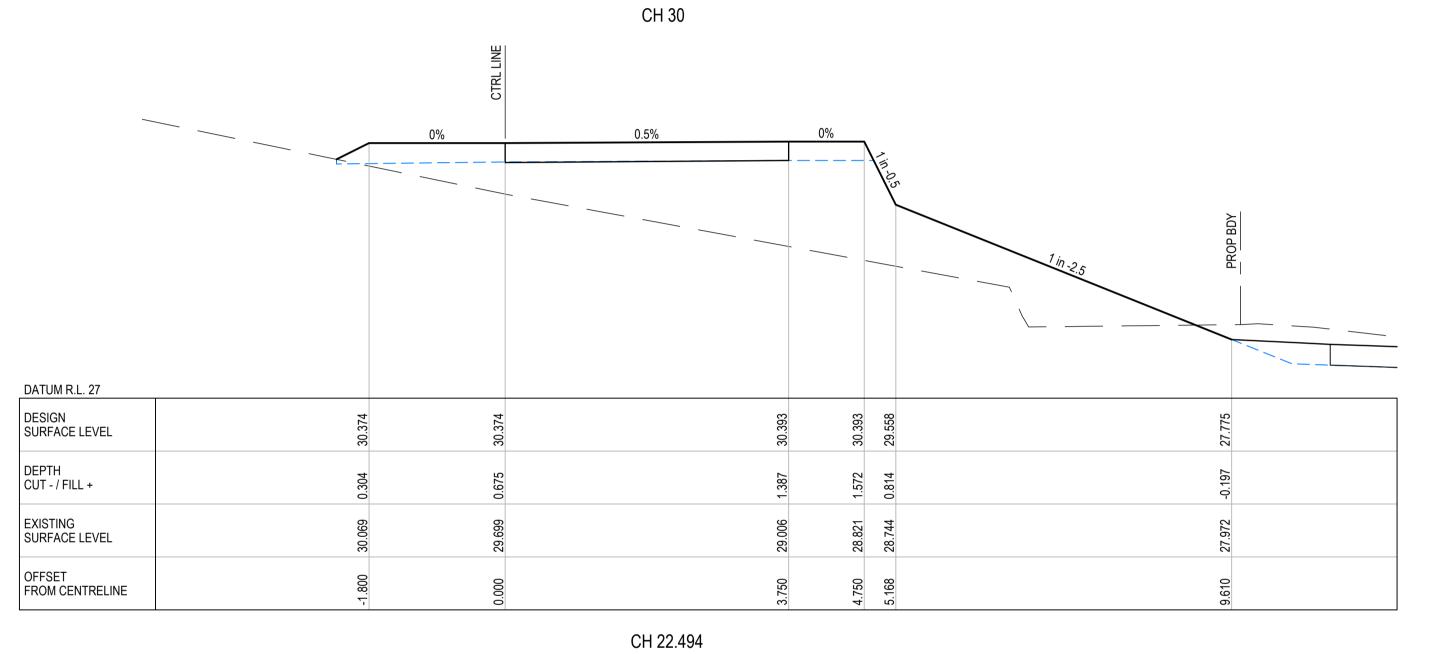


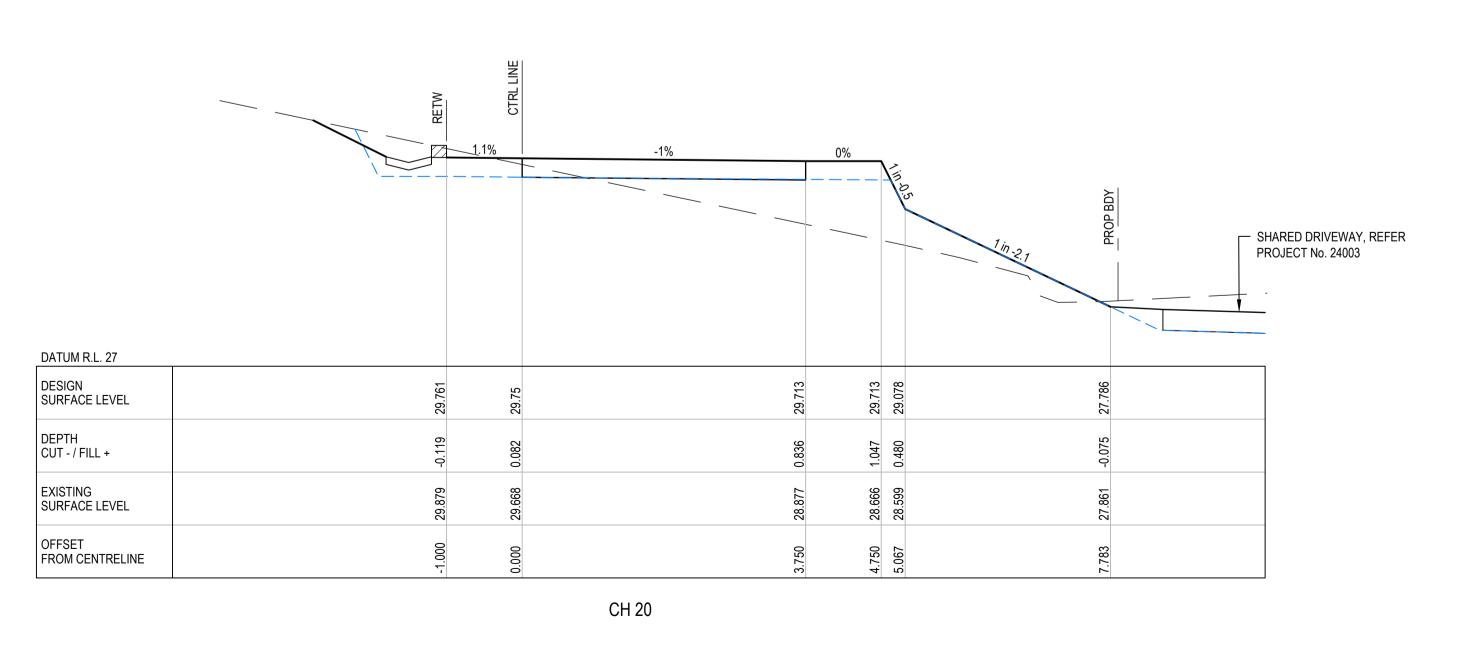

_					
.dwg					
C011					
1-C010	Α	ISSUED FOR APPROVAL	GB	GA	01/05/24
24004-	REV	DESCRIPTION	DRN	APP	DATE
File: 2		HIS DRAWING IS COPYRIGHT AND THE PROPERTY OF APPLIN CONSULTING. IT MUST	CERTIFIC	CATION	RPEQ
SAD F			G. APPLIN		6073

APPLIN — CONSULTING

M 0414 768 109 | E greg@applinconsulting.com.au

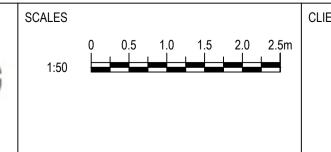



H		G. BROWNII
	GEORGE ARGYROU	DRAWN G. BROWNIN
		CHECKED G. APPLIN


IING	KYRENIA RESIDENCE
IING	14 MURPHY STREET (LOT 114 PTD2094)
	CROSS SECTIONS - DRIVEWAY CL03 SHEET 1 OF 2


STATUS	
FOR APPROVAL	
SCALE (AT FULL SIZE)	SIZE
1:50	A1
DRAWING NUMBER	REVISION
24004-C010	A



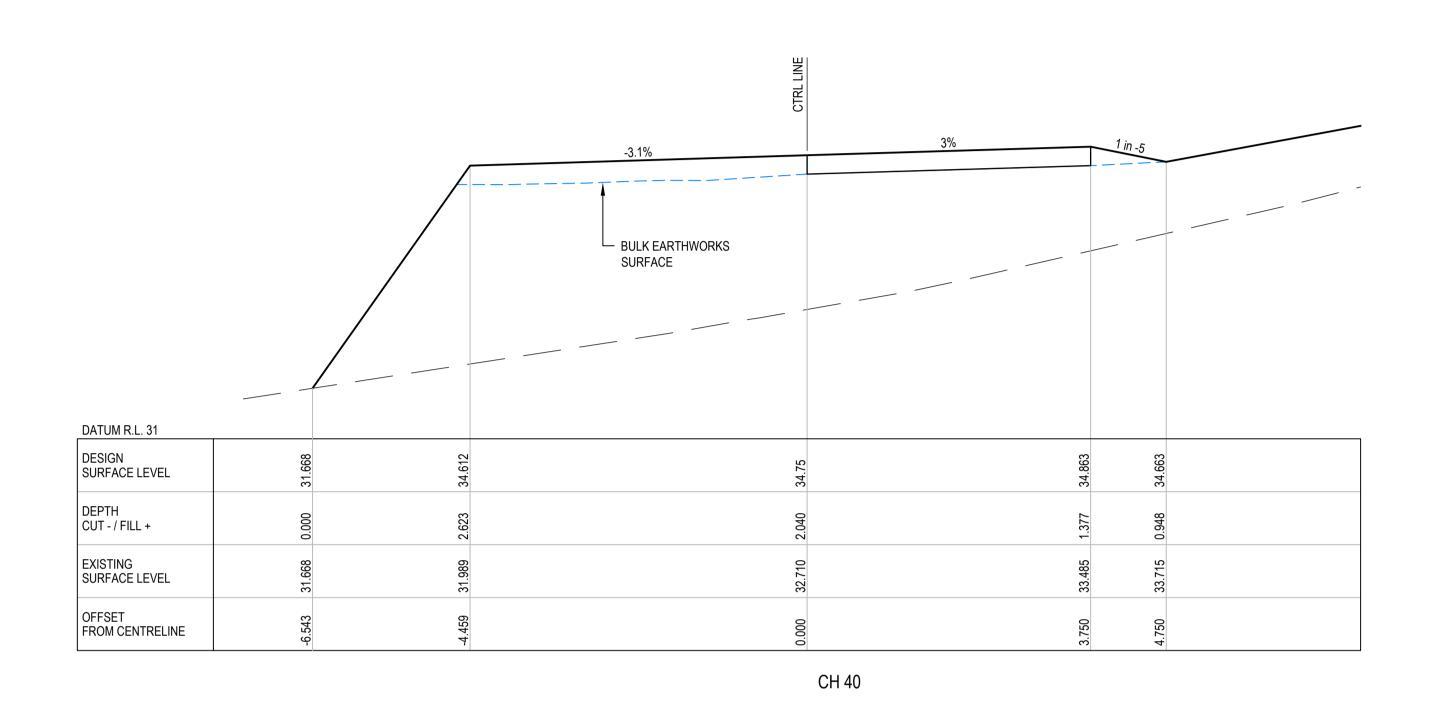

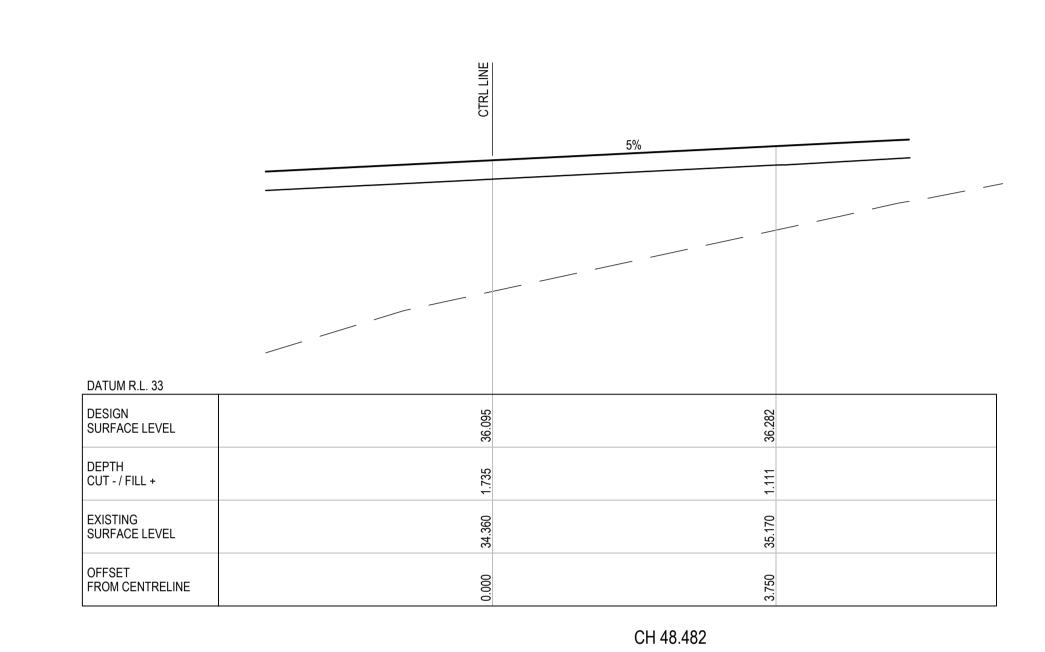

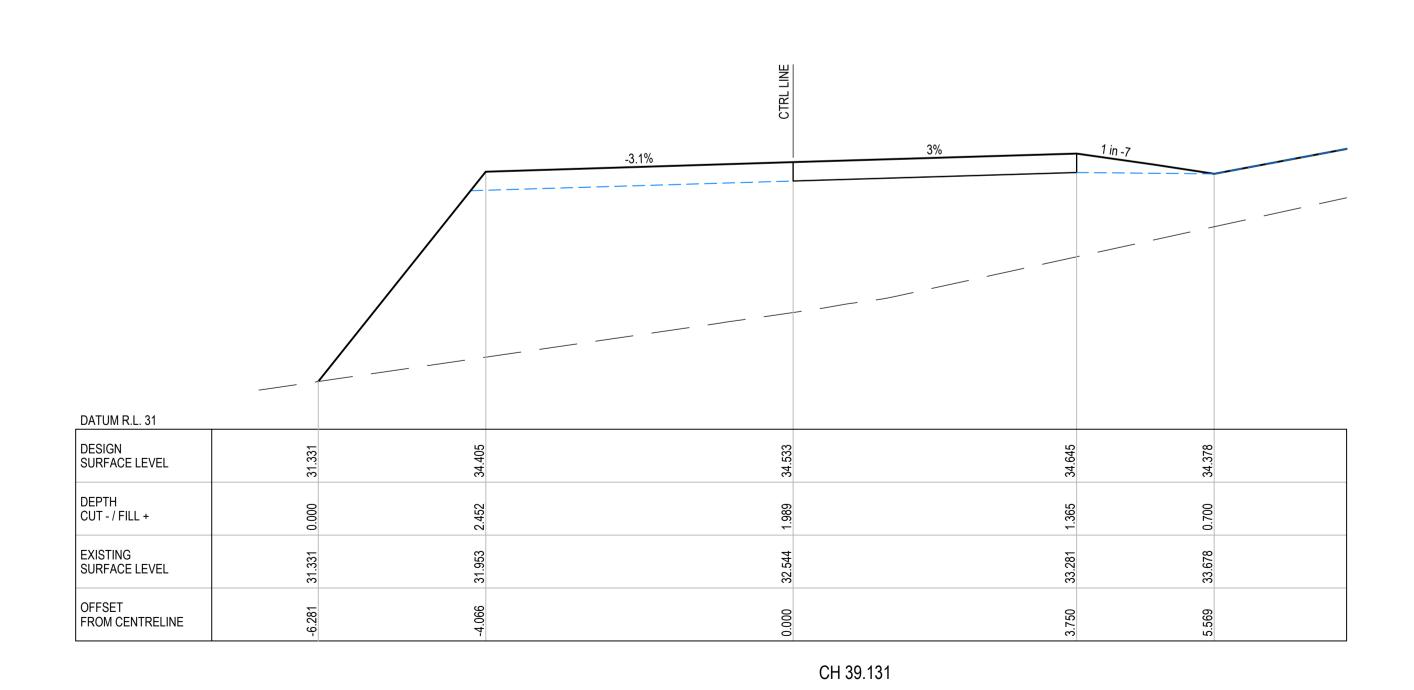


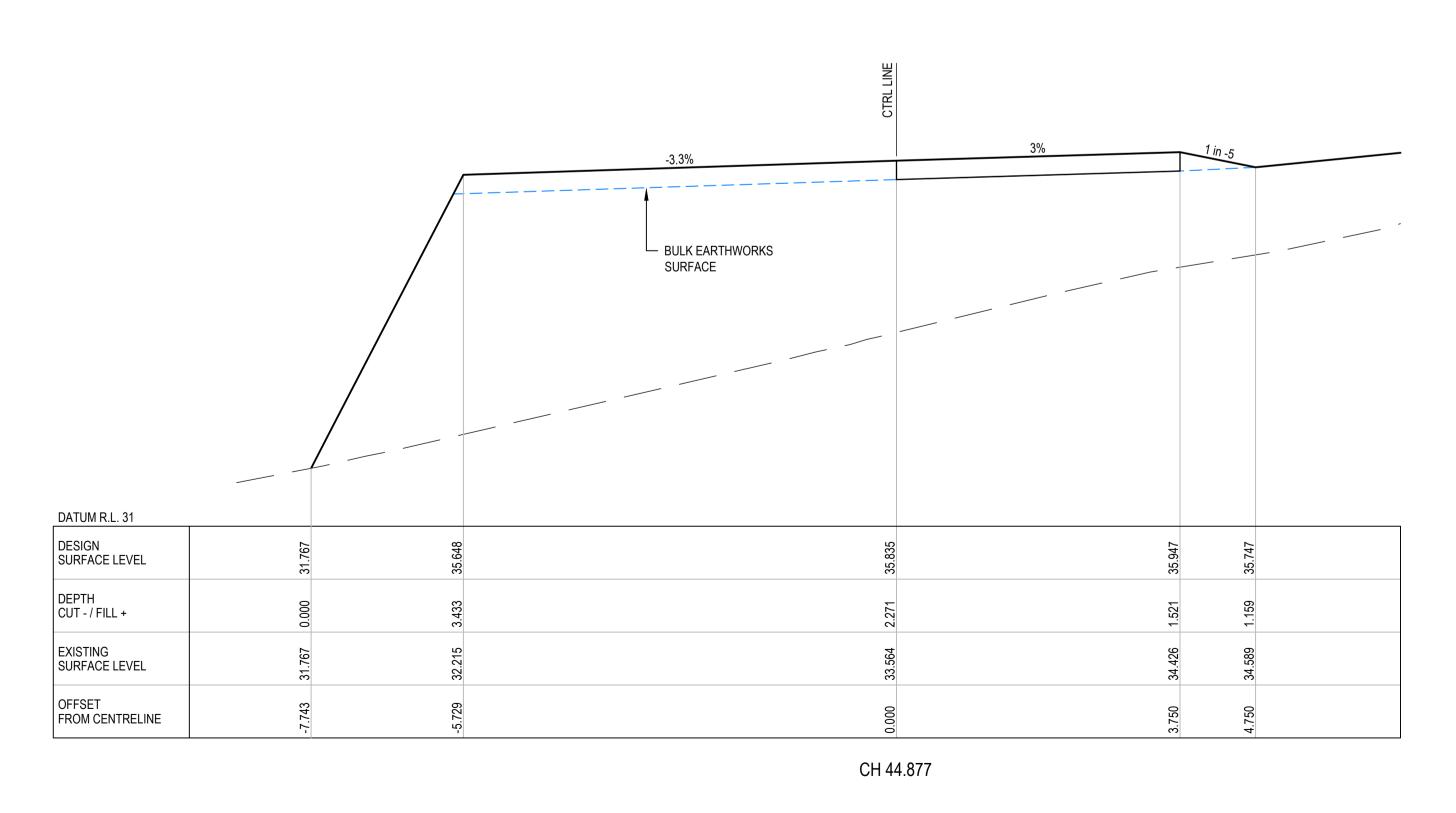

_					
dwg.					
C011.dwg					
10 (
0-1	Α	ISSUED FOR APPROVAL	GB	GA	01/05/24
24004-C010	REV	DESCRIPTION	DRN	APP	DATE
File: 2	THIS DRAWING IS COPYRIGHT AND THE PROPERTY OF APPLIN CONSULTING. IT MUST		CERTIFIC	CATION	RPEQ
CAD F			G. APP	LIN	6073

APPLIN — CONSULTING

M 0414 768 109 | E greg@applinconsulting.com.au

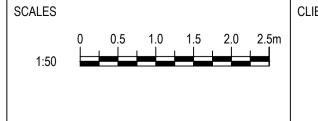

GEORGE ARGYROU

DESIGNED G. BROWNING	PROJECT KYRENIA RESIDENCE
DRAWN G. BROWNING	14 MURPHY STREET (LOT 114 PTD2094)
CHECKED G. APPLIN	CROSS SECTIONS - DRIVEWAY CL03 SHEET 2 OF 2

STATU	JS	
F	OR APPROVAL	
SCALE	E (AT FULL SIZE)	SIZE
1:5	0	A1
DRAW	ING NUMBER	REVISION
2	4004-C011	A



PO Box 723 Mossman Qld 4873 www.douglas.qld.gov.au enquiries@douglas.qld.gov.au ABN 71 241 237 800

> Administration Office 64 - 66 Front St Mossman P 07 4099 9444 F 07 4098 2902

24 April 2024

Enquiries:

Daniel Lamond

Our Ref: MCUC 2023_5563/1 (1223684)

Your Ref:

K P Cullen & N G Biddle C/- Urban Sync Pty Ltd PO Box 2970 CAIRNS QLD 4870

Dear Sir/Madam

Development Application for Material Change of Use (Dwelling house) At 12 Murphy Street PORT DOUGLAS On Land Described as Lot 113 on PTD2094 and Lot 114 on PTD2094

Please find attached the Decision Notice for the above-mentioned development application.

Please quote Council's application number: MCUC 2023_5563/1 in all subsequent correspondence relating to this development application.

Should you require any clarification regarding this, please contact Daniel Lamond on telephone 07 4099 9444.

Yours faithfully

For Paul Hoye

Manager Environment & Planning

- Decision Notice
 - Approved Drawing(s) and/or Document(s)
 - Reasons for Decision
- Advice For Making Representations and Appeals (Decision Notice)



Decision Notice

Approval (with conditions)

Given under s 63 of the Planning Act 2016

Applicant Details

Name: K P Cullen & N G Biddle

Postal Address: C/- Urban Sync Pty Ltd

PO Box 2970

CAIRNS QLD 4870

Email: admin@urbansync.com.au

Property Details

Street Address: 12 Murphy Street PORT DOUGLAS

Real Property Description: Lot 113 on PTD2094 and Lot 114 on PTD2094

Local Government Area: Douglas Shire Council

Details of Proposed Development

Development Permit - Material Change of Use (Dwelling house)

Decision

Date of Decision: 24 April 2024

Decision Details: Approved (subject to conditions)

Approved Drawing(s) and/or Document(s)

Copies of the following plans, specifications and/or drawings are enclosed.

Drawing or Document	Reference	Date
Site Plan	Balay Vandyke Drawing No. 02 of 50, job no. 231921.	18 March 2023
Diagrammatic Earthworks Model	Balay Vandyke Drawing No. 03 of 50, job no. 231921.	18 March 2023
Upper Floor Plan	Balay Vandyke Drawing No. 05 of 50, job no. 231921.	18 March 2023

Mid Floor Plan	Balay Vandyke Drawing No. 06 of 50, job no. 231921.	18 March 2023
Ground Floor Plan	Balay Vandyke Drawing No. 07 of 50, job No. 231921.	18 March 2023
Elevation 1	Balay Vandyke Drawing No. 08 of 50, job No. 231921.	18 March 2023
Elevation 2	Balay Vandyke Drawing No. 09 of 50, job No. 231921.	18 March 2023
Elevation 3	Balay Vandyke Drawing No. 10 of 50, job No. 231921.	18 March 2023
Elevation 4, elevation 5, Elevation 6	Balay Vandyke Drawing No. 11 of 50, job No. 231921.	18 March 2023

Assessment Manager Conditions & Advices

- 1. Carry out the approved development generally in accordance with the approved drawing(s) and/or document(s), and in accordance with:-
 - (a). The specifications, facts and circumstances as set out in the application submitted to Council;
 - (b). The following conditions of approval and the requirements of Council's Planning Scheme and the FNQROC Development Manual.

Except where modified by these conditions of approval

Timing of Effect

2. The conditions of the Development Permit must be effected prior to Commencement of use, except where specified otherwise in these conditions of approval.

Operational Works

3. The proposal triggers the need for an Operational Works Development Permit. The development application must include RPEQ certified 'for construction' plans for detailed design and the Operational Works application must be made over both 12 and 14 Murphy Street as one application.

Internal Access Driveway

4. Prior to Works Acceptance, provide access to the development site generally in accordance with Applin Consulting drawings 24003-C003 (A), C004 (A), C005 (A) and to the requirement of the FNQROC Regional Development Manual.

Shared Access Driveway

5. Amend the Shared Access Driveway to contain stormwater flows within the carriageway to Murphy Street. Unless otherwise agreed with Council, the shared access driveway must be amended to include:

- a. Drainage kerb along the downslope edge of the carriageway from Chainage 10.0m to Chainage 69.478m in accordance with FNQROC Standard Drawing S1110;
- A concrete batter chute or inlet pit must also be provided at approximate Chainage 10 to direct stormwater from the driveway into the existing Murphy Street roadside drain;
- 6. Revise the grade of the Shared Access Driveway to achieve a minimum grade of 0.3% between Chainage 40.0m to 64.444m to aid the conveyance of stormwater to Murphy Street. Amendment to the shared access driveway design must be provided to the satisfaction of the Chief Executive Officer prior to the issue of a Development Permit for Operational Works.
- 7. Prior to Works Acceptance, construct a 4.5m wide sealed shared access driveway connecting from the Murphy Street road carriageway to the property boundary generally in accordance with the location, alignment and grades detailed on Applin Consulting drawings 24003-C003 (A), C004 (A), C005 (A), except where amended by the conditions of this approval.

The shared driveway must include footings and earth retaining structures on the downslope side generally as detailed in Applin Consulting drawings 24003-C013 (A), C015 (A). Vehicle safety barriers as per the approved drawings must be constructed along the outer edge for the extent shown. The shared driveway must be constructed in accordance with Applin Consulting drawings and FNQROC Development Manual Standard Drawings S1015 and S1110 to the satisfaction of the Chief Executive Officer.

<u>Advice Note:</u> The water and sewer main augmentations in road reserve will be put on maintenance to become donated assets. The private driveway components of the design on road reserve, inclusive of drainage features will not become donated assets.

8. Ownership, operation and maintenance of the private shared access driveway infrastructure will vest at all times with the Murphy Street property owners for which the infrastructure services.

Earthworks & Retaining Walls

- 9. Prior to Works Acceptance, construct the earthworks generally in accordance with Applin Consulting drawings 24003-C006 (A), and C007 (A). All earthworks must be in accordance with the FNQROC Development Manual to the satisfaction of the Chief Executive Officer.
- 10. Prior to the issue of a Development Permit for Operational Works, provide a geotechnical report supporting the slope stability measures proposed for all temporary and permanent batters steeper than 1 in 2 or higher than 1.5 metres on the civil plans. The nominated slope stability measures must be endorsed by a suitably qualified and experienced RPEQ Geotechnical Engineer.
- 11. Prior to the pre-start meeting, all retaining walls or structures higher than 1 metre must be structurally certified by a suitably qualified RPEQ Structural Engineer. Where the profile or height of the wall is redesigned during structural certification, amended plan(s) must be endorsed by the Chief Executive Officer.

Stormwater

- 12. Revise the proposed stormwater design to achieve compliance with the requirements of Queensland Urban Drainage Manual (QUDM). In particular, revise the pipe grade and stormwater velocities between structure 2/A and 4/A.
 - <u>Advice Note:</u> The Applicant may consider adopting a 375mm diameter pipe graded at 15% to achieve compliance with QUDM and limit the invert level depth increase required.
- 13. Prior to Works Acceptance, construct the stormwater generally in accordance with civil plans by Applin Consulting drawing, except as modified by the conditions of this approval, to the requirements of the FNQROC Development Manual and satisfaction of the Chief Executive Officer.

Water Supply

14. Prior to Works Acceptance, complete the water supply connections generally in accordance with Applin Consulting drawing 24003-C019 (A), to the requirements of the FNQROC Development Manual and satisfaction of the Chief Executive Officer.

Sewerage Reticulation

15. Prior to Works Acceptance, complete the sewerage reticulation connections generally in accordance with Applin Consulting drawings 24003-C020 (A) and C021 (A), to the requirements of the FNQROC Development Manual and satisfaction of the Chief Executive Officer.

Exterior Finishes

16. The exterior finishes and colours of the house must be non-reflective and must blend with the natural colours of the surrounding environment. Shades of white including Dulux Lexicon and Dulux Mt Aspiring are not approved for use. The exterior finishes must be provided to Council for endorsement by the Chief Executive Officer prior to the issue of a Development Permit for Building Work.

Damage to Council Infrastructure

17. In the event that any part of Council's existing sewer, water or road infrastructure is damaged as a result of construction activities occurring on the site, the applicant/owner must notify Council immediately of the affected infrastructure and have it replaced at no cost to Council.

Vehicle Parking

18. The amount of vehicle parking must be as specified in Council's Planning Scheme which is a minimum of two (2) spaces located on site. In addition, all parking, driveway and vehicular manoeuvring areas must be imperviously sealed and drained.

Storage of Machinery and Plant

19. The storage of any machinery, material and vehicles must not cause a nuisance to surrounding properties, to the satisfaction of the Chief Executive Officer.

Landscaping Plan

- 20. The site must be landscaped in accordance with details included on a landscaping plan. The plan must detail;
 - a. compliance with Planning Scheme Policy SC6.7 Landscaping;
 - b. fencing details;
 - c. a detailed species list;
 - d. pot sizes;
 - e. species with high screening qualities and planting regime to effectively screen the property from view from the house at 14 Murphy Street.

The landscaping plan must be endorsed by the Chief Executive Officer prior to building work commencing and landscaping must be implemented prior to commencement of use.

Ponding and/or Concentration of Stormwater

21. The proposed development is not to create ponding nuisances and/or concentration of stormwater flows to adjoining properties.

Sediment and Erosion Control

22. All earthworks must be carried out in accordance with section CP1.13 and D5 of the FNQROC Development Manual and;

A copy of the contractors Erosion and Sediment Control Plan (ESCP) is to be submitted to Council prior to the issue of a Development Permit for Operational Work and;

Measures nominated in the ESCP must be implemented prior to commencement of any earthworks and:

The ESC Plan must address the Institution of Engineers' Australia Guidelines for Soil Erosion and Sediment Control and the Environment Protection (Water) Policy and Clauses CP1.06, CP1.13 and D5.10 of Council's FNQROC Development Manual.

Bushfire Hazard

23. The house must be developed in accordance with AS3959- 2009.

Further Development Permits

Please be advised that the following development permits are required to be obtained before the development can be carried out:

All Building Work

All Plumbing and Drainage Work must only be carried in compliance with the Queensland *Plumbing and Drainage Act 2018.*

Currency Period for the Approval


This approval, granted under the provisions of the *Planning Act 2016*, shall lapse six (6) years from the day the approval takes effect in accordance with the provisions of Section 85 of the *Planning Act 2016*.


Rights to make Representations & Rights of Appeal


The rights of applicants to make representations and rights to appeal to a Tribunal or the Planning and Environment Court against decisions about a development application are set out in Chapter 6, Part 1 of the *Planning Act 2016*.

A copy of the relevant appeal provisions is attached.


Approved Drawing(s) and/or Document(s)

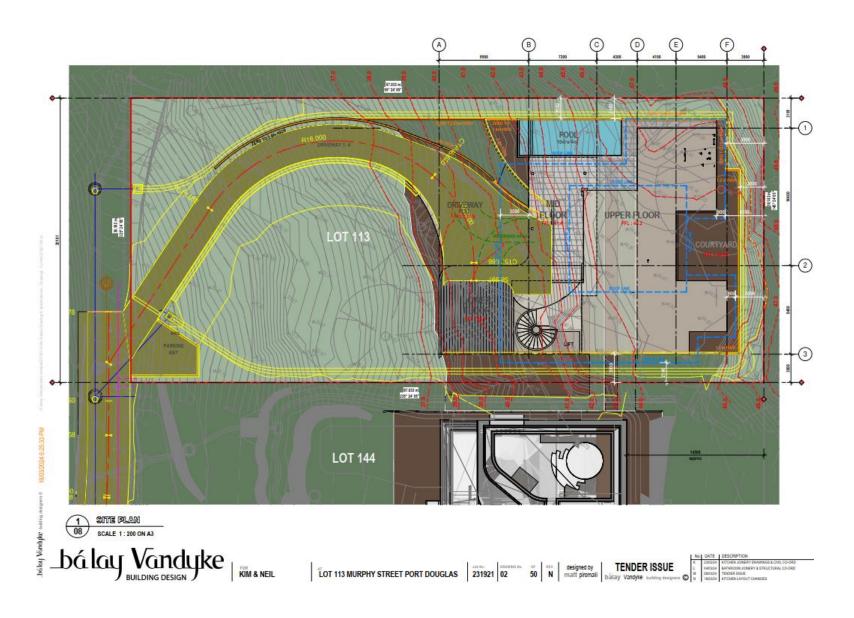


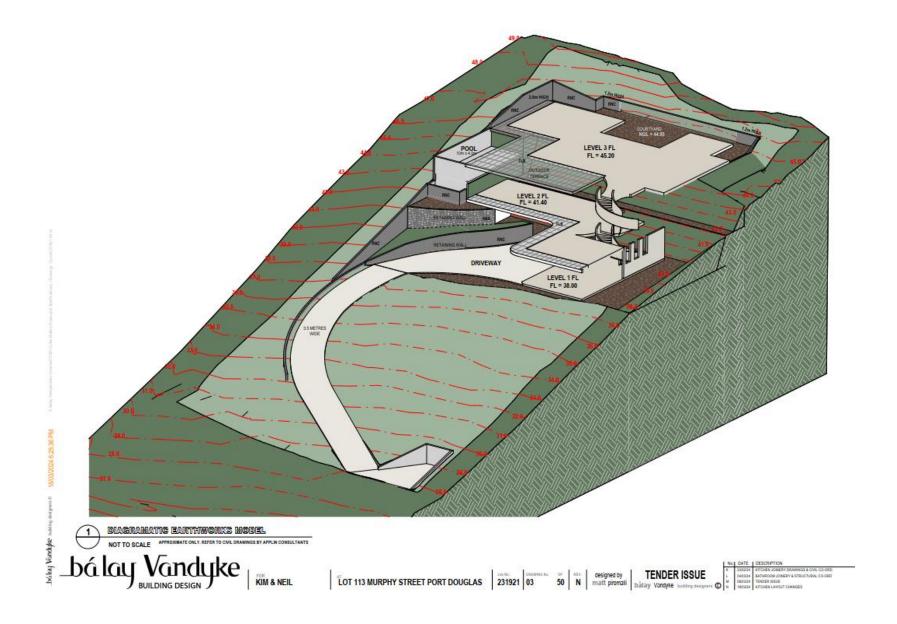


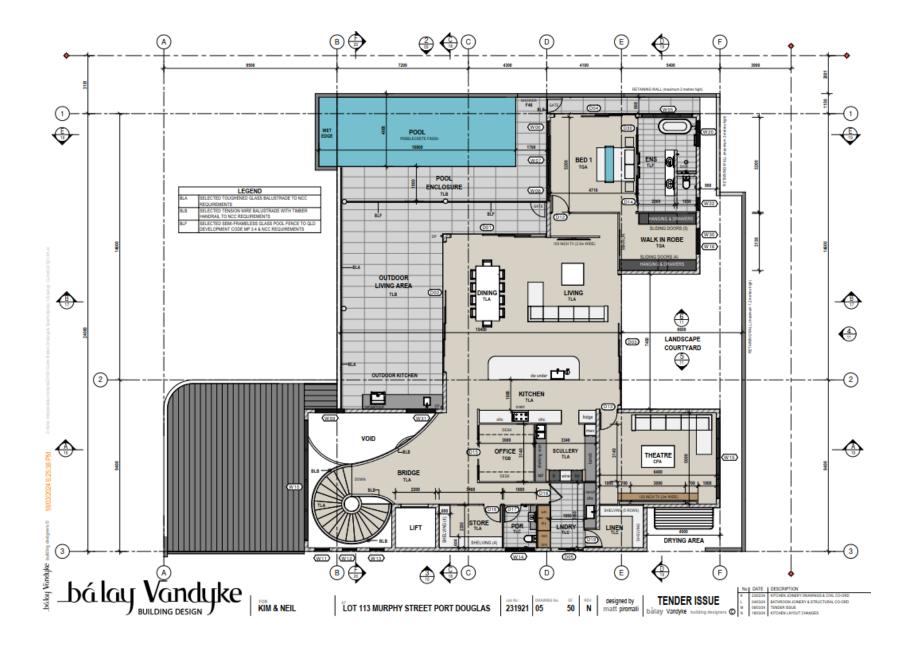

Doc ID: 1223684 MCUC 2023_5563/1 Page 10 of 25

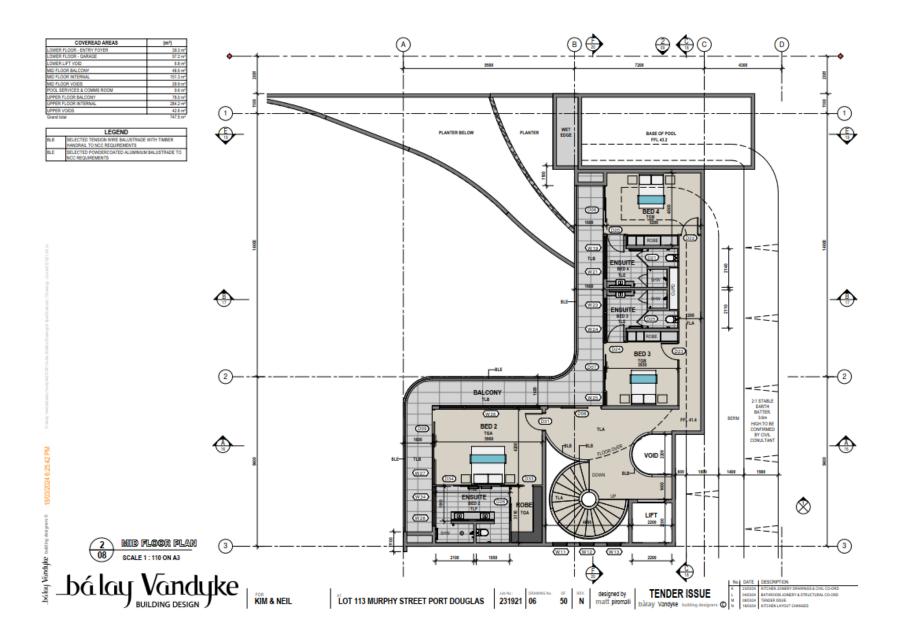

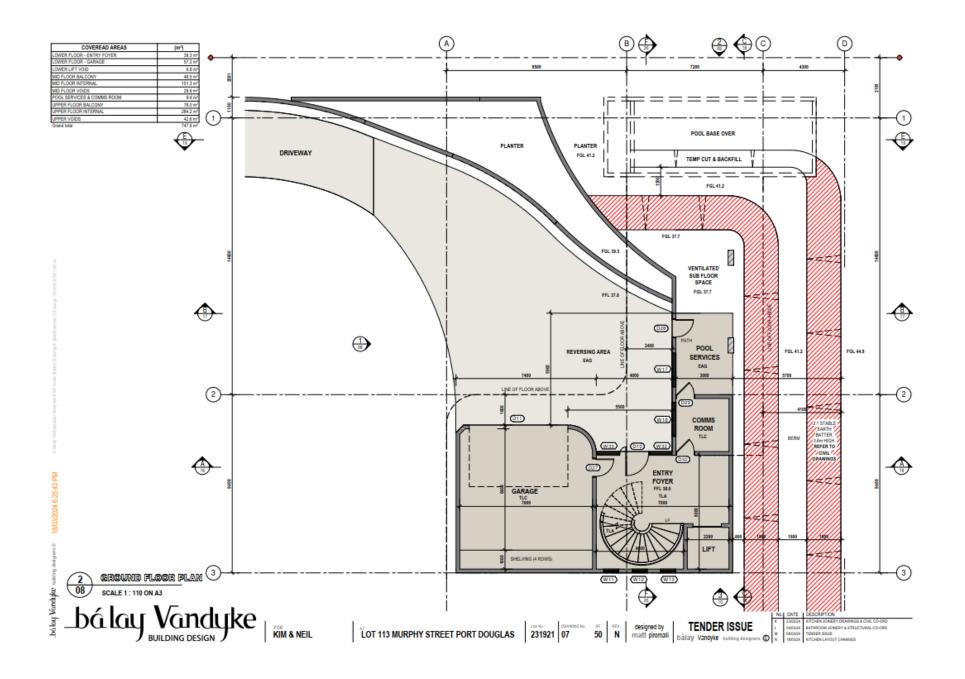

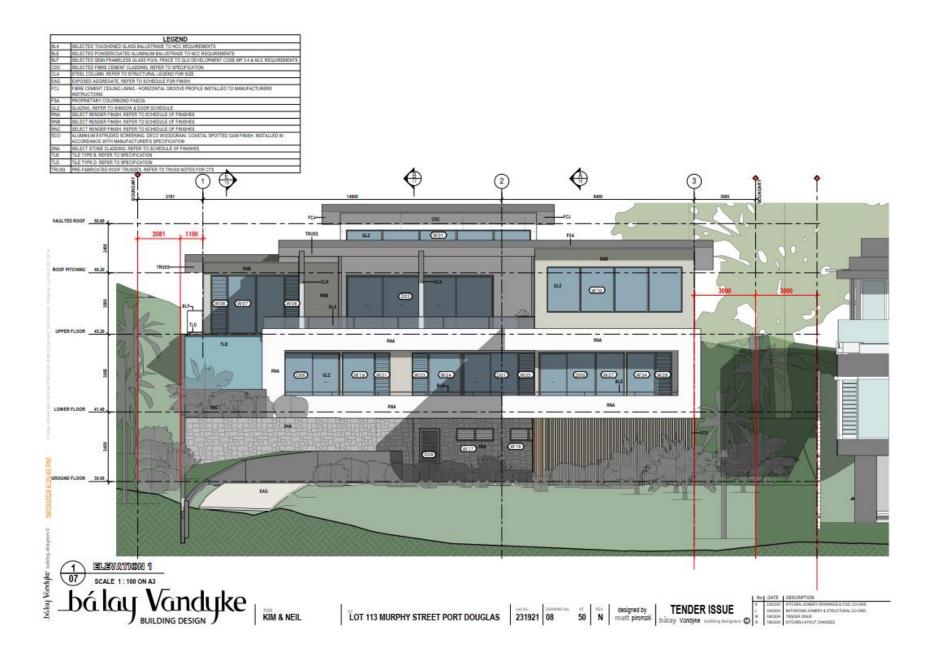


LEGEND		
BLE	SELECTED POWDERCOATED ALUMINIUM BALUSTRADE TO NCC REQUIREMENTS	
BLF	SELECTED SEMI-FRAMELESS GLASS POOL FENCE TO QLD DEVELOPMENT CODE MP 3.4 B MCC REQUIREMENTS	
CDC	SELECTED FIBRE CEMENT CLADONG, REFER TO SPECIFICATION.	
CLC	CONORETE COLUMN, REFER TO STRUCTURAL LEGEND FOR 82E	
PSA.	PROPRIETARY COLORBOND FASCIA	
RNA	SELECT RENDER FINISH. REFER TO SCHEDULE OF FINISHES	
RNB	SELECT RENDER FINISH, REFER TO SCHEDULE OF FINISHES	
BMC:	RELECT RENDER ENVISA REFER TO SCHEDULE OF ENVISHES -	




Doc ID: 1223684 MCUC 2023_5563/1 Page 14 of 25

LEGEND		
CDC	SELECTED FIBRE CEMENT CLADDING, REFER TO SPECIFICATION	
FSA	PROPRIETARY COLORBOND FASCIA	
GQB	150 COLORBOND QUAD GUTTER WITH MINIMUM CROSS SECTIONAL AREA OF 8500 sq.mm	
RFJ	COLORBOND KLIP-LOK ROOF SHEETING, CONCEALED FIXING SYSTEM TO PURLINS / BATTENS AS PER MANUFACTURERS INSTRUCTIONS	
RNA	SELECT RENDER FINISH. REFER TO SCHEDULE OF FINISHES	
RNB	SELECT RENDER FINISH. REFER TO SCHEDULE OF FINISHES	

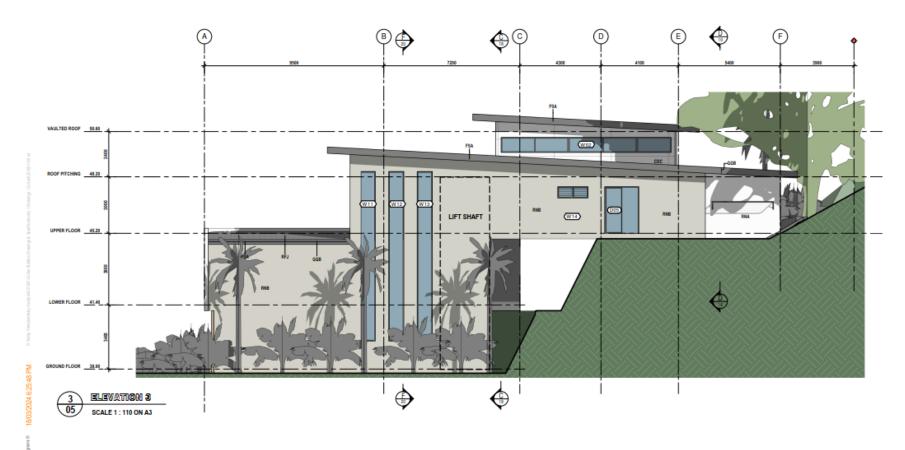

bálay Vandyke | KIM & NEIL

LOT 113 MURPHY STREET PORT DOUGLAS 231921 10

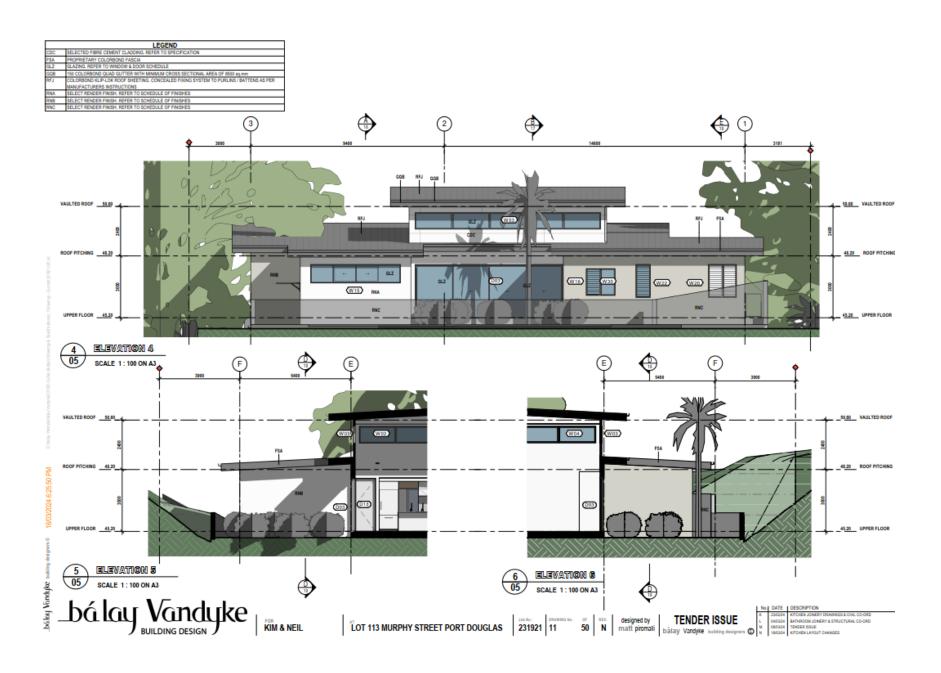

Reasons for Decision

- 1. The reasons for this decision are:
 - a. Sections 60, 62 and 63 of the *Planning Act 2016*:
 - b. to ensure the development satisfies the benchmarks of the 2018 Douglas Shire Planning Scheme Version 1.0; and
 - c. to ensure compliance with the *Planning Act 2016*.
- 2. Findings on material questions of fact:
 - a. the development application was properly lodged to the Douglas Shire Council 15/12/2023 under section 51 of the *Planning Act 2016* and Part 1 of the *Development Assessment Rules*:
 - b. the development application contained information from the applicant which Council reviewed together with Council's own assessment against the 2017 State Planning Policy and the 2018 Douglas Shire Planning Scheme Version 1.0 in making its assessment manager decision.
- 3. Evidence or other material on which findings were based:
 - a. the development triggered assessable development under the Assessment Table associated with the Environmental Management Zone Code;
 - b. Council undertook an assessment in accordance with the provisions of sections 60, 62 and 63 of the *Planning Act 2016*; and
 - c. the applicant's reasons have been considered and the following findings are made:
 - i. Subject to conditions, the development satisfactorily meets the Planning Scheme benchmarks.

Extracts from the Planning Act 2016 - Making Representations During Applicant's Appeal Period

Planning Act 2016 Chapter 3 Development assessment

s 74

Division 2 Changing development approvals

Subdivision 1 Changes during appeal period

74 What this subdivision is about

- This subdivision is about changing a development approval before the applicant's appeal period for the approval ends.
- (2) This subdivision also applies to an approval of a change application, other than a change application for a minor change to a development approval.
- (3) For subsection (2), sections 75 and 76 apply—
 - (a) as if a reference in section 75 to a development approval were a reference to an approval of a change application;
 and
 - (b) as if a reference in the sections to the assessment manager were a reference to the responsible entity; and
 - (c) as if a reference in section 76 to a development application were a reference to a change application;
 and
 - (d) as if the reference in section 76(3)(b) to section 63(2) and (3) were a reference to section 83(4); and
 - (e) with any other necessary changes.

75 Making change representations

- The applicant may make representations (change representations) to the assessment manager, during the applicant's appeal period for the development approval, about changing—
 - (a) a matter in the development approval, other than—
 - a matter stated because of a referral agency's response; or

Page 94

Current as at 10 June 2022

- (ii) a development condition imposed under a direction made by the Minister under chapter 3, part 6, division 2; or
- (b) if the development approval is a deemed approval—the standard conditions taken to be included in the deemed approval under section 64(8)(c).
- (2) If the applicant needs more time to make the change representations, the applicant may, during the applicant's appeal period for the approval, suspend the appeal period by a notice given to the assessment manager.
- (3) Only 1 notice may be given.
- (4) If a notice is given, the appeal period is suspended—
 - (a) if the change representations are not made within a period of 20 business days after the notice is given to the assessment manager—until the end of that period; or
 - (b) if the change representations are made within 20 business days after the notice is given to the assessment manager, until—
 - the applicant withdraws the notice, by giving another notice to the assessment manager; or
 - (ii) the applicant receives notice that the assessment manager does not agree with the change representations; or
 - (iii) the end of 20 business days after the change representations are made, or a longer period agreed in writing between the applicant and the assessment manager.
- (5) However, if the assessment manager gives the applicant a negotiated decision notice, the appeal period starts again on the day after the negotiated decision notice is given.

76 Deciding change representations

 The assessment manager must assess the change representations against and having regard to the matters that

Current as at 10 June 2022

Page 95

- must be considered when assessing a development application, to the extent those matters are relevant.
- (2) The assessment manager must, within 5 business days after deciding the change representations, give a decision notice to—
 - (a) the applicant; and
 - if the assessment manager agrees with any of the change representations—
 - (i) each principal submitter; and
 - (ii) each referral agency; and
 - (iii) if the assessment manager is not a local government and the development is in a local government area—the relevant local government; and
 - (iv) if the assessment manager is a chosen assessment manager—the prescribed assessment manager; and
 - (v) another person prescribed by regulation.
- (3) A decision notice (a negotiated decision notice) that states the assessment manager agrees with a change representation must—
 - (a) state the nature of the change agreed to; and
 - (b) comply with section 63(2) and (3).
- (4) A negotiated decision notice replaces the decision notice for the development application.
- (5) Only 1 negotiated decision notice may be given.
- (6) If a negotiated decision notice is given to an applicant, a local government may give a replacement infrastructure charges notice to the applicant.

Page 96

Current as at 10 June 2022

Planning Act 2016 Chapter 6 Dispute resolution

[s 229]

Chapter 6 Dispute resolution

Part 1 Appeal rights

229 Appeals to tribunal or P&E Court

- (1) Schedule 1 states—
 - (a) matters that may be appealed to-
 - (i) either a tribunal or the P&E Court; or
 - (ii) only a tribunal; or
 - (iii) only the P&E Court; and
 - (b) the person—
 - (i) who may appeal a matter (the appellant); and
 - (ii) who is a respondent in an appeal of the matter; and
 - (iii) who is a co-respondent in an appeal of the matter; and
 - (iv) who may elect to be a co-respondent in an appeal of the matter.
- (2) An appellant may start an appeal within the appeal period.
- (3) The appeal period is—
 - for an appeal by a building advisory agency—10 business days after a decision notice for the decision is given to the agency; or
 - (b) for an appeal against a deemed refusal—at any time after the deemed refusal happens; or
 - (c) for an appeal against a decision of the Minister, under chapter 7, part 4, to register premises or to renew the registration of premises—20 business days after a notice is published under section 269(3)(a) or (4); or

Current as at 10 June 2022

Page 213

- (d) for an appeal against an infrastructure charges notice—20 business days after the infrastructure charges notice is given to the person; or
- (e) for an appeal about a deemed approval of a development application for which a decision notice has not been given—30 business days after the applicant gives the deemed approval notice to the assessment manager; or
- (f) for an appeal relating to the Plumbing and Drainage Act 2018—
 - (i) for an appeal against an enforcement notice given because of a belief mentioned in the *Plumbing and Drainage Act 2018*, section 143(2)(a)(i), (b) or (c)—5 business days after the day the notice is given; or
 - (ii) for an appeal against a decision of a local government or an inspector to give an action notice under the *Plumbing and Drainage Act 2018*—5 business days after the notice is given; or
 - (iii) for an appeal against a failure to make a decision about an application or other matter under the Plumbing and Drainage Act 2018—at anytime after the period within which the application or matter was required to be decided ends; or
 - (iv) otherwise—20 business days after the day the notice is given; or
- (g) for any other appeal—20 business days after a notice of the decision for the matter, including an enforcement notice, is given to the person.

Note-

See the P&E Court Act for the court's power to extend the appeal period.

(4) Each respondent and co-respondent for an appeal may be heard in the appeal.

Page 214

Current as at 10 June 2022

- (5) If an appeal is only about a referral agency's response, the assessment manager may apply to the tribunal or P&E Court to withdraw from the appeal.
- (6) To remove any doubt, it is declared that an appeal against an infrastructure charges notice must not be about—
 - (a) the adopted charge itself; or
 - (b) for a decision about an offset or refund—
 - the establishment cost of trunk infrastructure identified in a LGIP; or
 - the cost of infrastructure decided using the method included in the local government's charges resolution.

230 Notice of appeal

- An appellant starts an appeal by lodging, with the registrar of the tribunal or P&E Court, a notice of appeal that—
 - (a) is in the approved form; and
 - (b) succinctly states the grounds of the appeal.
- (2) The notice of appeal must be accompanied by the required fee.
- (3) The appellant or, for an appeal to a tribunal, the registrar, must, within the service period, give a copy of the notice of appeal to—
 - (a) the respondent for the appeal; and
 - (b) each co-respondent for the appeal; and
 - (c) for an appeal about a development application under schedule 1, section 1, table 1, item 1—each principal submitter for the application whose submission has not been withdrawn; and
 - (d) for an appeal about a change application under schedule 1, section 1, table 1, item 2—each principal submitter for the application whose submission has not been withdrawn; and

Current as at 10 June 2022

Page 215

- (e) each person who may elect to be a co-respondent for the appeal other than an eligible submitter for a development application or change application the subject of the appeal; and
- (f) for an appeal to the P&E Court—the chief executive;
 and
- (g) for an appeal to a tribunal under another Act—any other person who the registrar considers appropriate.

(4) The service period is-

- (a) if a submitter or advice agency started the appeal in the P&E Court—2 business days after the appeal is started; or
- (b) otherwise—10 business days after the appeal is started.
- (5) A notice of appeal given to a person who may elect to be a co-respondent must state the effect of subsection (6).
- (6) A person elects to be a co-respondent to an appeal by filing a notice of election in the approved form—
 - (a) if a copy of the notice of appeal is given to the person—within 10 business days after the copy is given to the person; or
 - (b) otherwise—within 15 business days after the notice of appeal is lodged with the registrar of the tribunal or the P&E Court.
- (7) Despite any other Act or rules of court to the contrary, a copy of a notice of appeal may be given to the chief executive by emailing the copy to the chief executive at the email address stated on the department's website for this purpose.

231 Non-appealable decisions and matters

 Subject to this chapter, section 316(2), schedule 1 and the P&E Court Act, unless the Supreme Court decides a decision or other matter under this Act is affected by jurisdictional error, the decision or matter is non-appealable.

Page 216 Current as at 10 June 2022

- (2) The Judicial Review Act 1991, part 5 applies to the decision or matter to the extent it is affected by jurisdictional error.
- (3) A person who, but for subsection (1) could have made an application under the *Judicial Review Act 1991* in relation to the decision or matter, may apply under part 4 of that Act for a statement of reasons in relation to the decision or matter.
- (4) In this section—

decision includes—

- (a) conduct engaged in for the purpose of making a decision; and
- (b) other conduct that relates to the making of a decision;
 and
- (c) the making of a decision or the failure to make a decision; and
- (d) a purported decision; and
- (e) a deemed refusal.

non-appealable, for a decision or matter, means the decision or matter—

- (a) is final and conclusive; and
- (b) may not be challenged, appealed against, reviewed, quashed, set aside or called into question in any other way under the *Judicial Review Act 1991* or otherwise, whether by the Supreme Court, another court, any tribunal or another entity; and
- (c) is not subject to any declaratory, injunctive or other order of the Supreme Court, another court, any tribunal or another entity on any ground.

232 Rules of the P&E Court

- A person who is appealing to the P&E Court must comply with the rules of the court that apply to the appeal.
- (2) However, the P&E Court may hear and decide an appeal even if the person has not complied with rules of the P&E Court.

Current as at 10 June 2022

Page 217



PO Box 723 Mossman Qld 4873 www.douglas.qld.gov.au enquiries@douglas.qld.gov.au ABN 71 241 237 800

> Administration Office 64 - 66 Front St Mossman P 07 4099 9444 F 07 4098 2902

7 October 2022

Enquiries: Jenny Elphinstone

Our Ref: MCUC 2022_4732/1 (Doc ID 1114104)

Your Ref: 22-04

Mr George Argyrou C/- Planning Plus PO Box 399 REDLYNCH QLD 4870

Email: Evan@planningplusqld.com.au

Attention Mr Evan Yelavich

Dear Sir

Development Application for Material Change of Use (Dwelling house) At 14 Murphy Street Port Douglas On Land Described as Lot 114 on PTD 2094

Please find attached the Decision Notice for the above-mentioned development application.

Please quote Council's application number: MCUC 2022_4732/1 in all subsequent correspondence relating to this development application.

Should you require any clarification regarding this, please contact Jenny Elphinstone on telephone 07 4099 9444.

Yours faithfully

For

Sara Roberts

A/Manager Environment & Planning

encl.

- Decision Notice
 - Approved Drawing(s) and/or Document(s)
 - o Reasons for Decision
- Advice For Making Representations and Appeals (Decision Notice)



Decision Notice

Approval (with conditions)

Given under s 63 of the Planning Act 2016

Applicant Details

Name: Mr George Argyrou

Postal Address: C/- Planning Plus

PO Box 399

Redlynch Qld 4870

Email: evan@planningplusqld.com.au

Property Details

Street Address: 14 Murphy Street Port Douglas

Real Property Description: Lot 114 on PTD2094

Local Government Area: Douglas Shire Council

Details of Proposed Development

Development Permit for Material Change of Use for a Dwelling house.

Decision

Date of Decision: 7 October 2022

Decision Details: Approved (subject to conditions)

Approved Drawing(s) and/or Document(s)

Copies of the following plans, specifications and/or drawings are enclosed.

The term 'approved drawing(s) and/or document(s) or other similar expressions means:

Drawing or Document	Reference	Date
Site and Environs Plan	Hunt Design Drawing No. 02.1, Revision 01.	2 June 2022
Access Road- Sections	Hunt Design Drawing No. 02.2 Revision 01, 02.3 Revision 01 and 02.4 Revision 01.	2 June 2022

Drawing or Document	Reference	Date
Site Plan	Generally in accordance with Bayley Ward Architects Project 1789 Drawing TP021 Revision 2 dated 16 June 2022 and as amended by Conditions of the approval.	To be determined.
GA Plan - Lower Ground FI	Generally in accordance with Bayley Ward Architects Project 1789 Drawing TP101 Revision 2 dated 16 June 2022 and as amended by Conditions of the approval.	To be determined
GA Plan - Ground FI	Generally in accordance with Bayley Ward Architects Project 1789 Drawing TP102 Revision 2 dated 16 June 2022 and as amended by Conditions of the approval.	To be determined
GA Plan - Upper Level	Generally in accordance with Bayley Ward Architects Project 1789 Drawing TP103 Revision 2 dated 16 June 2022 and as amended by Conditions of the approval.	To be determined
GA Plan - Roof Plan	Generally in accordance with Bayley Ward Architects Project 1789 Drawing TP104 Revision 2 dated 16 June 2022 and as amended by Conditions of the approval.	To be determined
South West And North East Elevations	Generally in accordance with Bayley Ward Architects Project 1789 Drawing TP201 Revision 2 dated 16 June 2022 and as amended by Conditions of the approval.	To be determined
North West Elevation	Generally in accordance with Bayley Ward Architects Project 1789 Drawing TP202 Revision 2 dated 16 June 2022 and as amended by Conditions of the approval.	To be determined
South East Elevation	Generally in accordance with Bayley Ward Architects Project 1789 Drawing TP203 Revision 2 dated 16 June 2022 and as amended by Conditions of the approval.	To be determined

Drawing or Document	Reference	Date
Building Section A-A	Generally in accordance with Bayley Ward Architects Project 1789 Drawing TP301 Revision 2 dated 16 June 2022 and as amended by Conditions of the approval.	To be determined
Building Section B-B	Generally in accordance with Bayley Ward Architects Project 1789 Drawing TP302 Revision 2 dated 16 June 2022 and as amended by Conditions of the approval.	To be determined
Building Section C-C & D-D	Generally in accordance with Bayley Ward Architects Project 1789 Drawing TP303 Revision 2 dated 16 June 2022 and as amended by Conditions of the approval.	To be determined
Vegetation Amenity report and Vegetation Survey	Generally in accordance with Hortulus Australia (Council document 11004736) dated 30 June 2022, including: Landscape Concept Plan, Drawing No. 1, Revision A, dated 22 July 2022; Drawing NO.2, dated 14 March 2022; Schematic Elevation, Drawing No.6 Revision A dated 22 July 2022; landscape Concept Plan, Drawing No.3 dated 14 March 2022; and Planting Plan Drawing no.5 dated 22 July 2022, and as amended by the Conditions of the approval.	To be determined
Retaining Wall Design and Certification	Report prepared by Stephen Ford RPEQ 25762 for Geo Design Reference 22058AA-D-L01-v1.	21 July 2022
Preliminary Earthworks Plan	Generally in accordance with Edge Project 220614, Drawing CSK002Revision P1, dated 3 June 2022 and as amended by the conditions of the approval.	To be determined.
Preliminary Earthworks Sections	Generally in accordance with Edge Project 220614, Drawing CSK003 Revision P1, dated 3 June 2022 and as amended by the conditions of the approval.	To be determined.
Typical Sections, Sheet 1. Proposed Retaining Wall, 14 Murphy Street, Port Douglas	Geo Design Project 22010AA-D, drawing C01, Revision A	14 July 2022

Drawing or Document	Reference	Date
Typical Sections, Sheet 2, Proposed Retaining Wall, 14 Murphy Street, Port Douglas	Geo Design Project 22010AA-D, drawing C02, Revision A	14 July 2022
Typical Sections, Sheet 3 Proposed Retaining Wall, 14 Murphy Street, Port Douglas	Geo Design Project 22010AA-D, drawing C03, Revision A	14 July 2022

Note – The plans referenced above will require amending in order to comply with conditions of this Decision Notice.

Assessment Manager Conditions & Advices

Conditions

- 1. Carry out the approved development generally in accordance with the approved drawing(s) and/or document(s), and in accordance with:
 - a. The specifications, facts and circumstances as set out in the application submitted to Council;
 - b. The following conditions of approval and the requirements of Council's Planning Scheme and the FNQROC Development Manual.

Except where modified by these conditions of approval

Timing of Effect

2. The conditions of the Development Permit must be effected prior to Commencement of Use, except where specified otherwise in these conditions of approval.

Amendment to Design

- 3. The proposed development must be amended to accommodate the following changes:
 - a. Setback and design the geotechnical earthworks at the rear of the house so as to conserve and maintain the root systems and the ongoing health of the following two trees number as follows on the Hortulus Vegetation Survey Plan (Council document 1100473):
 - i. Tree No.39 Alstonia scholaris (Milky Pine); and
 - ii. Tree No.40. Eucalyptus tetericornis (Queensland Blue Gum).

The design of any earthworks, structures and buildings must be subservient to the geotechnical design for the dwelling and associated retaining walls;

- b. Setback and design the driveway to conserve and maintain the root systems and ongoing health of the following tree, numbered as follows on the Hortulus Vegetation Survey Plan (Council document 1100473:
 - i. Tree No.25 Ficus sp (possibly ficus ubignosa) (Fig Tree); and
 - ii. All other trees within the proximity of the driveway that are identified as "retain" on the Vegetation Survey Plan.

Note – this may require redesign of the driveway.

The design of any earthworks, structures and buildings must be subservient to the geotechnical design for the dwelling, driveway and associated retaining walls;

- c. Setback all retaining walls (including any associated soil nailing) a minimum of 2000mm from the side boundaries, as measured in a horizontal distance from the property boundary to the inside of the retaining wall structure and any associated spoon drain. This setback is to be established with deep planting to achieve a dense vegetation screen of at least 6000m height within 3 years of growth. All retaining walls and hard landscaping elements, including rock work, paving and spoon drains must not be located within this setback areas from the property side boundaries;
- d. Where the retaining wall is positioned within 2000mm from the front boundary, it must be of a maximum height of 1200mm and be suitably landscaped to provide a dense vegetation buffer;
- e. All exposed retaining walls must be finished with a natural rock face with a range of dark colour finishes:
- f. Remove all proposed vegetation changes to the adjacent road verge. Any proposed removal of vegetation in the adjacent road verge must be discussed with and sought from Council;
- g. Only remove the trees within the land boundary as identified as "Removal Status" on the Hortulus Vegetation Survey Plan (Council document 1100473);
- h. Undertake measures to protect and conserve all other trees as numbered on the Hortulus Vegetation Survey Plan, other than those identified as "Removal Status" as per the Australian Standard Protection of Trees on Development Sites AS 4970-2009;
- i. Replace the Yukka rostrata plants with a more suitable species;
- j. All plants introduced to the site are to be local endemic species; and
- k. Reduce the total overall height of the dwelling house to be a maximum of 11.5 metres as measured as a vertical height, from any point above natural ground level. The overall height must include all roof areas including the parapet to the roof terrace:

Details of the above amendments must be endorsed by the Chief Executive Officer prior to issue of a Development Permit for Building Work.

Clearing Limitation

4. Clearing is limited to the vegetation within the land and those associated with the path of the private, external driveway, as detailed in the Hortulus Vegetation Survey Plan (Council document 1100473) and the Hunt Design Drawings Nos. 02.1, 02.2 and 0.23 all dated 2 June 2022 (Council document 1093290).

Prior to removal of any tree, an inspection must be carried out for any signs of protected wildlife including nests and animal habitat. Should any recent wildlife activity be identified, removal of the tree must not occur until the animal has vacated the area of immediate danger. If the animal does not move from the area of danger, the Queensland Parks and Wildlife Services must be contacted for advice. Important habitat trees should be retained wherever possible.

Council must be notified two (2) business days prior to the proposed date of commencement of any approved vegetation clearing.

Operational Works

5. An Operational Work Approval is required for the water, sewer, earthworks and driveway construction associated with the development. The application for Operational Works must include, but not be limited to, the following:

- a. Drainage work to deliver stormwater to Murphy Street being the lawful point of discharge;
- b. Earthworks internal and external to the site:
- Required internal and external work within the road reserve for the driveway and retaining walls; and
- d. Water and sewerage work required to service the site.
- e. Trees to be removed as per Condition 3h above with the remaining trees to be protected as per the Australian Standard Protection of Trees on Development Sites AS 4970-2009;
- f. All earthworks must be carried out in accordance with section CP1.13 and D5 of the FNQROC Development Manual. A copy of the contractors Erosion and Sediment Control Plan (ESCP) is to be submitted to Council prior to the issue of a Development Permit for Operational Work. Measures nominated in the ESCP must be implemented prior to commencement of any earthworks. The ESC Plan must address the Institution of Engineers' Australia Guidelines for Soil Erosion and Sediment Control and the Environment Protection (Water) Policy and Clauses CP1.06, CP1.13 and D5.10 of Council's FNQROC Development Manual; and
- g. All work must be carried out in accordance with the requirements and recommendations from the Geotechnical Report prepared by Geo Design, Reference 22058AA-D-L01-v1, dated 21 July 2022, prepared by Stephen Ford RPEQ 25762, and Geo Design Project 22010AA-D, Drawings C01, C02 and C03. In particular all works are to be carried out under the direction and supervision of Geo to confirm design and construction adequacy.

Such works must be completed to the satisfaction of the Chief Executive Officer prior to Commencement of Use.

Access Driveway

- 6. The access driveway must be developed in accordance with the latest version of AS2890-2004 with the following design parameters being met:
 - a. Retaining walls supporting the access driveway on road reserve must not exceed 1000mm in height.
 - b. Vehicle access to any other allotment must not be inhibited by the section of private access driveway in the Murphy Street road reserve.

The section of private access driveway within the road reserve of Murphy Street will not become a Council asset and will never be maintained by Council. The ongoing maintenance obligation of the driveway in the Murphy Street road reserve remains with the property owner at all times.

Water Supply and Sewerage Works External

- 7. Undertake the following water supply and sewerage works external to the site to connect the site to existing water supply and sewerage infrastructure:
 - Augment existing water supply infrastructure to the extent necessary such that the development does not adversely affect the water supply to adjacent properties and such that a water service connection can be provided at the lot frontage;
 - b. Construct new sewer to accommodate the development. Detailed plans are to be provided showing levels and alignment and must be designed in accordance with the FNQROC Development Manual.

All works must be carried out in accordance with the approved plans, to the requirements and satisfaction of the Chief Executive Officer prior to Commencement of Use.

Water Supply and Sewerage Works Internal

- 8. Undertake the following water supply and sewerage works internal to the subject land:
 - a. Provide a single internal sewer connection which must be clear of any buildings or structures;
 - b. Provide a single internal water connection.

All the above works must be designed and constructed in accordance with the FNQROC Development Manual.

All works must be carried out in accordance with the approved plans, to the requirements and satisfaction of the Chief Executive Officer prior to Commencement of Use.

Inspection of Sewers

9. Where altering existing sewer mains or construction of new sewer main, provide CCTV inspections of sewers both prior to commencement of works on site and at works completion where works have been undertaken over or to sewers. Defects must be rectified to the satisfaction of the Chief Executive Officer at no cost to Council prior to Commencement of Use.

Bushfire Hazard

10. The house must be developed in accordance with AS3959- 2009.

Landscaping

11. Prior to commencement of use provide a remediation and landscaping plan to be endorsed by the Chief Executive Officer. The plan must detail plant locations, plant size and must be in accordance with *Planning Scheme Policy SC6.7 Landscaping*. Landscaping must be established prior to the commencement of use and must be maintained thereafter to the satisfaction of the Chief executive Officer.

Building Colours

12. Prior to the issue of a Development Permit for Building Work, the external colours of the building must be submitted to Council for endorsement by the Chief Executive Officer. The external building colours must be reflective of the surrounding natural environment, must not be white or metallic. The building exterior finishes, including any exposed concrete, fixed / louvered and pool glazing, must be of suitably dark colours to marry into the natural vegetation. All glazing must be of a non-reflective finish.

Lawful Point of Discharge

13. All stormwater from the property must be directed to a lawful point of discharge such that it does not adversely affect surrounding properties or properties downstream from the development, all to the requirements and satisfaction of the Chief Executive Officer.

Note: the above works are not considered to be creditable or trunk related works in accordance with Section 145 of the *Planning Act 2016*.

Damage to Council Infrastructure

14. In the event that any part of Council's existing sewer / water or road infrastructure is damaged as a result of construction activities occurring on the site, including but not limited to; mobilisation of heavy construction equipment, stripping and grubbing, the applicant/owner must notify Council immediately of the affected infrastructure and have it repaired or replaced at the developer's/owners/builders cost, prior to the Commencement of Use.

Stockpiling and Transportation of Fill Material

15. Soil used for filling or spoil from the excavation is not to be stockpiled in locations that can be viewed from adjoining premises or a road frontage for any longer than one (1) month from the commencement of works.

Transportation of fill or spoil to and from the site must not occur within:

- a. peak traffic times;
- b. before 7:00 am or after 6:00 pm Monday to Friday;
- c. before 7:00 am or after 1:00 pm Saturdays; or
- d. on Sundays or Public Holidays.
- 16. Dust emissions or other air pollutants, including odours, must not extend beyond the boundary of the site and cause a nuisance to surrounding properties.

Details of Development Signage

- 17. The development must provide clear and legible signage incorporating the street number for the benefit of the public.
- 18. Noise from air-conditioning units, swimming and spa pool filters, service equipment or other mechanical equipment must not emanate from the subject land to a degree that would, in the opinion of the Chief Executive Officer, create an environmental nuisance having regard to the provisions of Chapter 8 Part 3B of the *Environmental Protection Act* 1994.

ADVICE

- 1. This approval, granted under the provisions of the *Planning Act 2016*, shall lapse six (6) years from the day the approval takes effect in accordance with the provisions of s85 of the *Planning Act 2016*.
- 2. All building site managers must take all action necessary to ensure building materials and / or machinery on construction sites are secured immediately following the first cyclone watch and that relevant emergency telephone contacts are provided to Council officers, prior to commencement of works.
- 3. This approval does not negate the requirement for compliance with all other relevant Local Laws and other statutory requirements.
- 4. Light emanating from the site must not cause a light nuisance to surrounding properties in accordance with the *Environmental Protection Act 1994*.
- 5. The development approval does not permit the landscaping beyond the property boundary. Any such work would be subject to achieving suitable tenure and approval under the Planning Scheme.
- 6. For information relating to the *Planning Act 2016* log on to www.dsdmip.qld.gov.au. To access the FNQROC Development Manual, Local Laws and other applicable Policies, log on to www.douglas.qld.gov.au.

Further Development Permits

Please be advised that the following development permits are required to be obtained before the development can be carried out:

- All Building Work; and
- All Operational Work for the driveway and land.

All Plumbing and Drainage Work must only be carried in compliance with the Queensland *Plumbing and Drainage Act 2018*.

Currency Period for the Approval


This approval, granted under the provisions of the *Planning Act 2016*, shall lapse six (6) years from the day the approval takes effect in accordance with the provisions of Section 85 of the *Planning Act 2016*.

Rights to make Representations & Rights of Appeal

The rights of applicants to make representations and rights to appeal to a Tribunal or the Planning and Environment Court against decisions about a development application are set out in Chapter 6, Part 1 of the *Planning Act 2016*.

A copy of the relevant appeal provisions is attached.

Approved Drawing (s) and / or Document(s) (Subject to Amendments as per the Conditions)

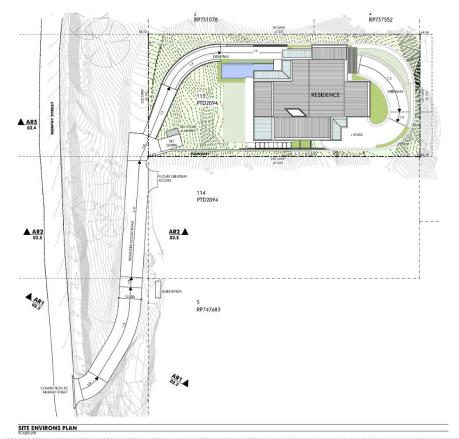

	2 023m2
SITE AREA	2.0251112
COVERED AREA	581m2
SITE COVERAGE:	29%
GROSS FLOOR AREA	701m2
PLOT RATIO:	0.35:1
SEE DRAWING NO. 08.1 FOR AREA CALCULATIONS	

READ IN CONJUNCTION WITH:
- LANDSCAPE PLANS
- CIVIL PLANS


MURPHY STREET RESIDENCE PROPOSED NEW RESIDENCE AT No 12 MURPHY STREET ON LOT 113 (PID2094) FOR: KIM CULLEN & NEIL BIDDLE

DEVELOPMENT APPLICATION SITE & ENVIRONS PLAN © COPFRIGHT HUNT DESIGN

LANDPLAN GEO DE LUCIO





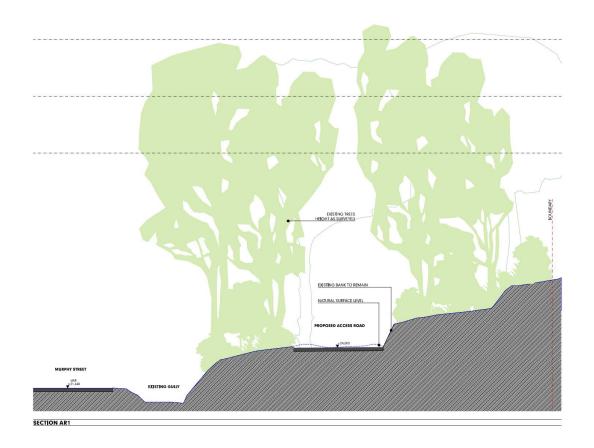

MURPHY STREET RESIDENCE
PROPOSED NEW RESIDENCE AT No 12 MURPHY STREET
ON LOT 113 (PTD2094)
FOR: KIM CULLEN & NEIL BIDDLE

DEVELOPMENT APPLICATION ACCESS ROAD - SECTIONS










MURPHY STREET RESIDENCE
PROPOSED NEW RESIDENCE AT No 12 MURPHY STREET
ON LOT 113 (PTD2094)
FOR: KIM CULLEN & NEIL BIDDLE

DEVELOPMENT APPLICATION ACCESS ROAD - SECTIONS







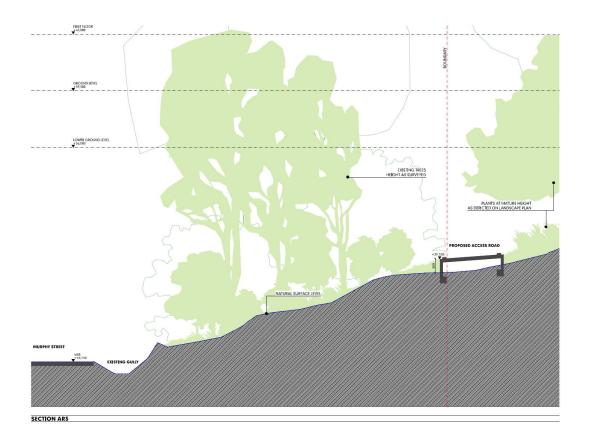


MURPHY STREET RESIDENCE
PROPOSED NEW RESIDENCE AT No 12 MURPHY STREET
ON LOT 113 (PTD2094)
FOR: KIM CULLEN & NEIL BIDDLE

DEVELOPMENT APPLICATION ACCESS ROAD - SECTIONS









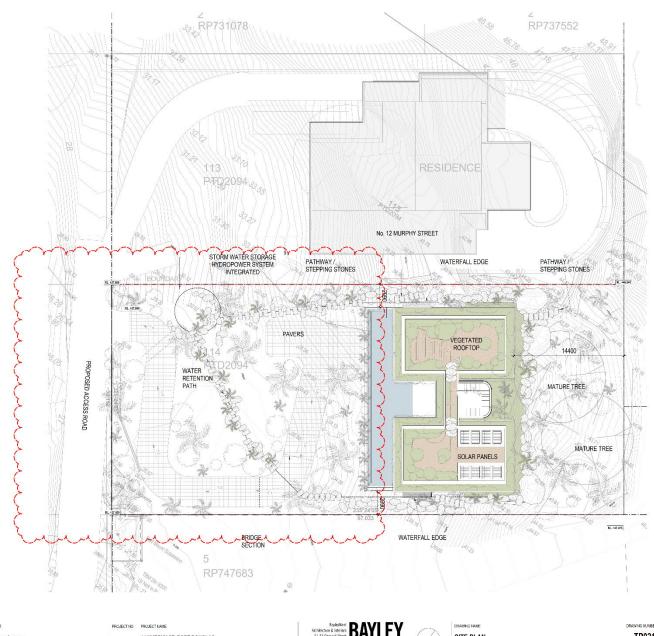



CRIEDRAL NOTES PROJECT TATUS


PROJEC

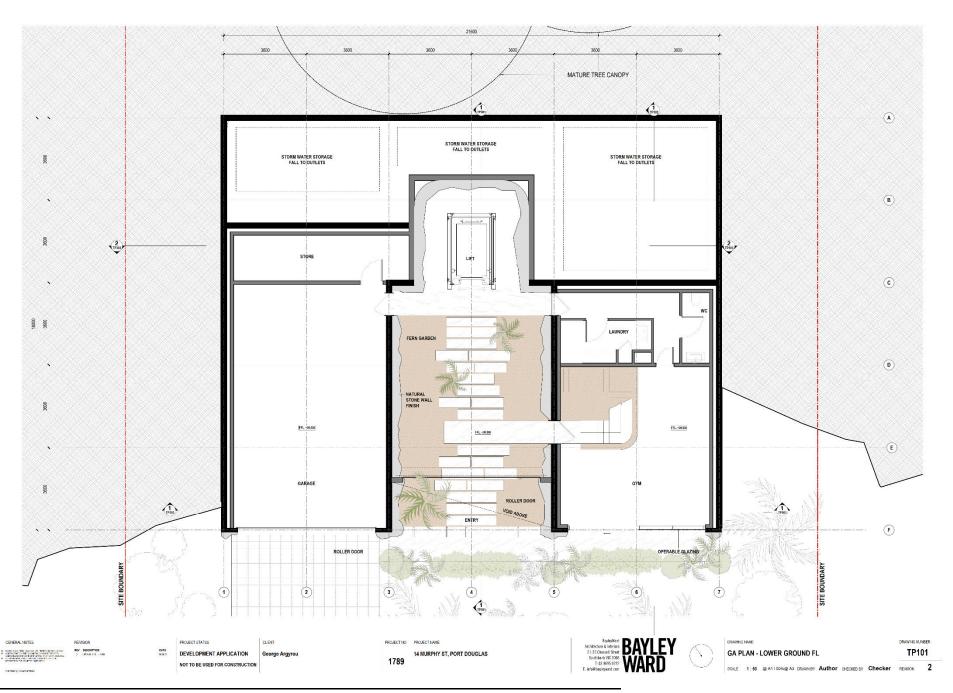


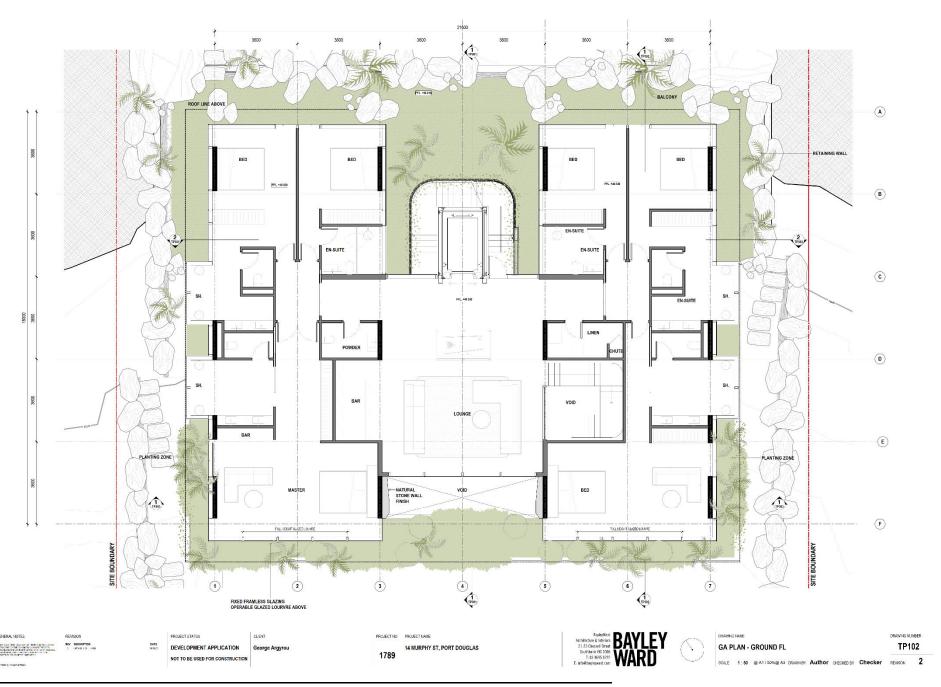


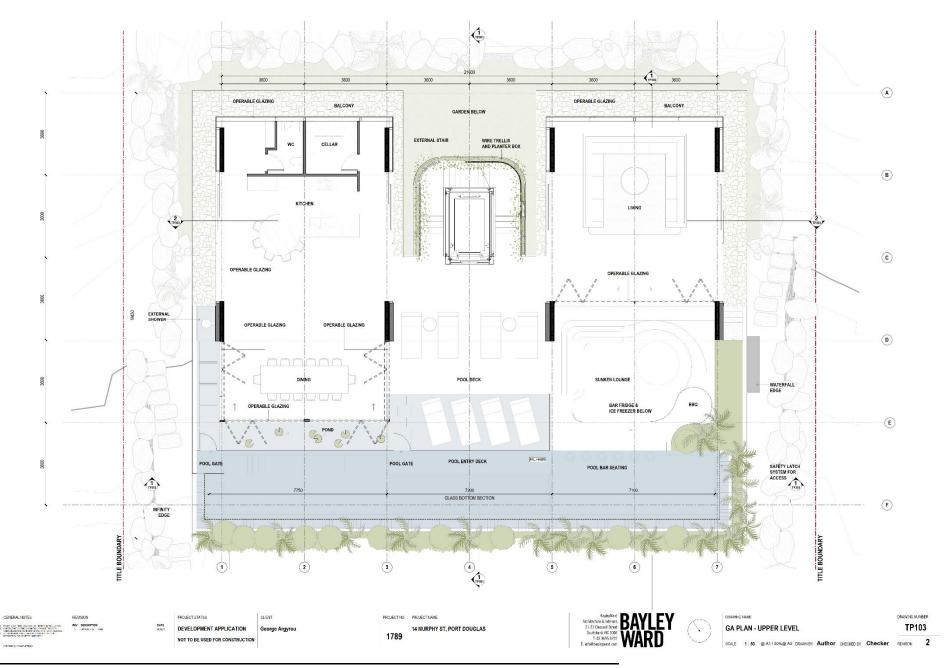


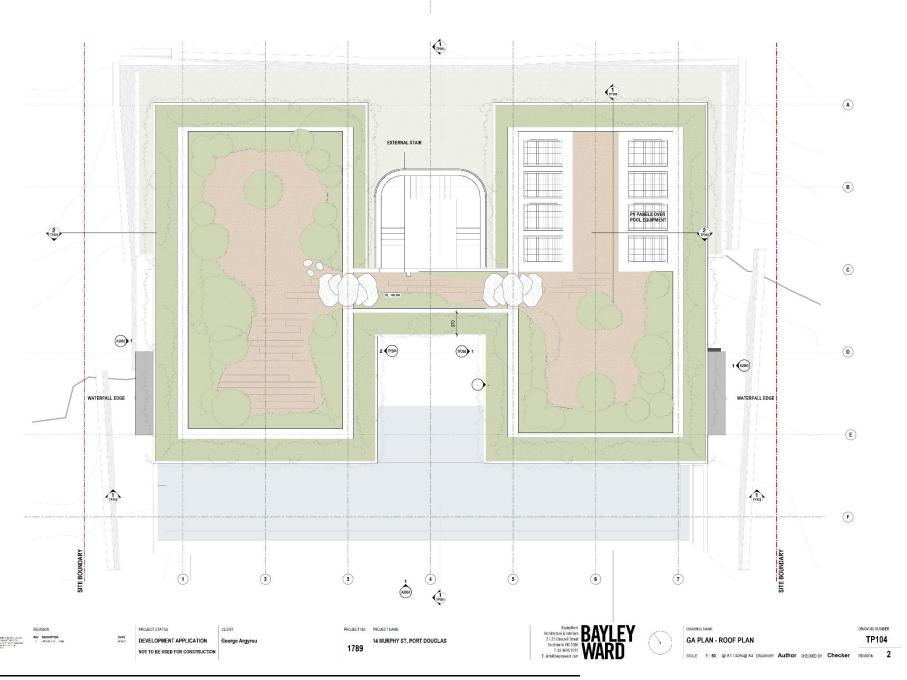


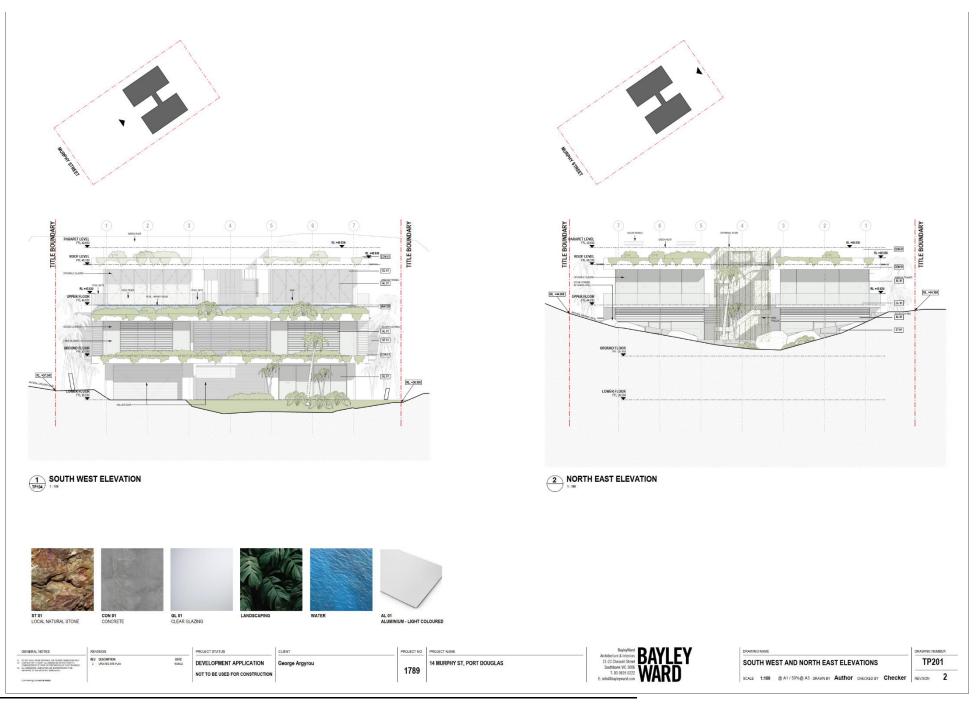


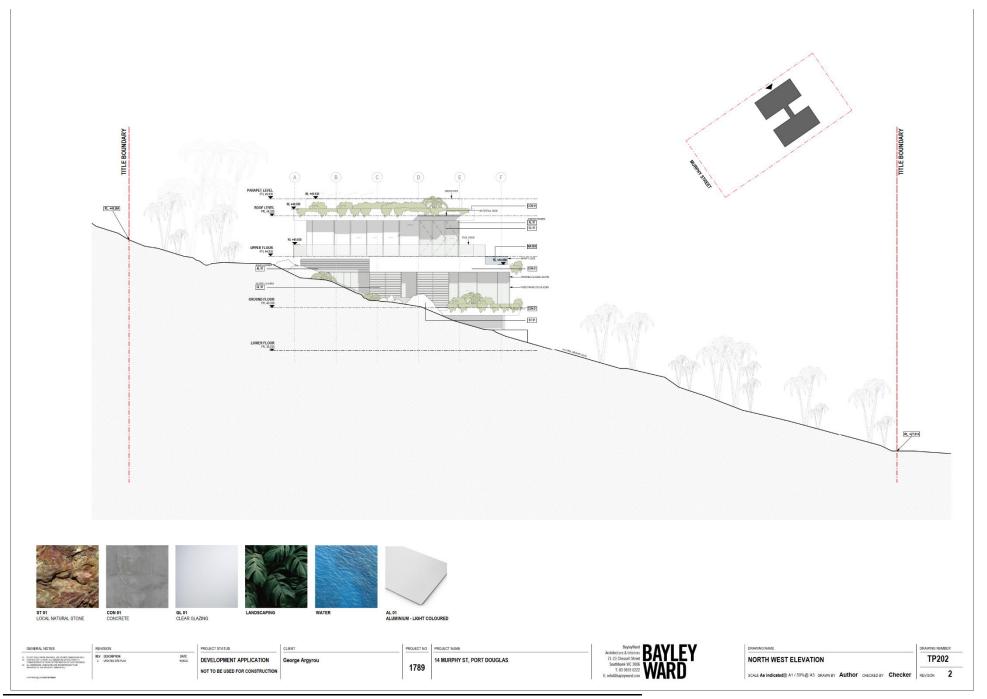

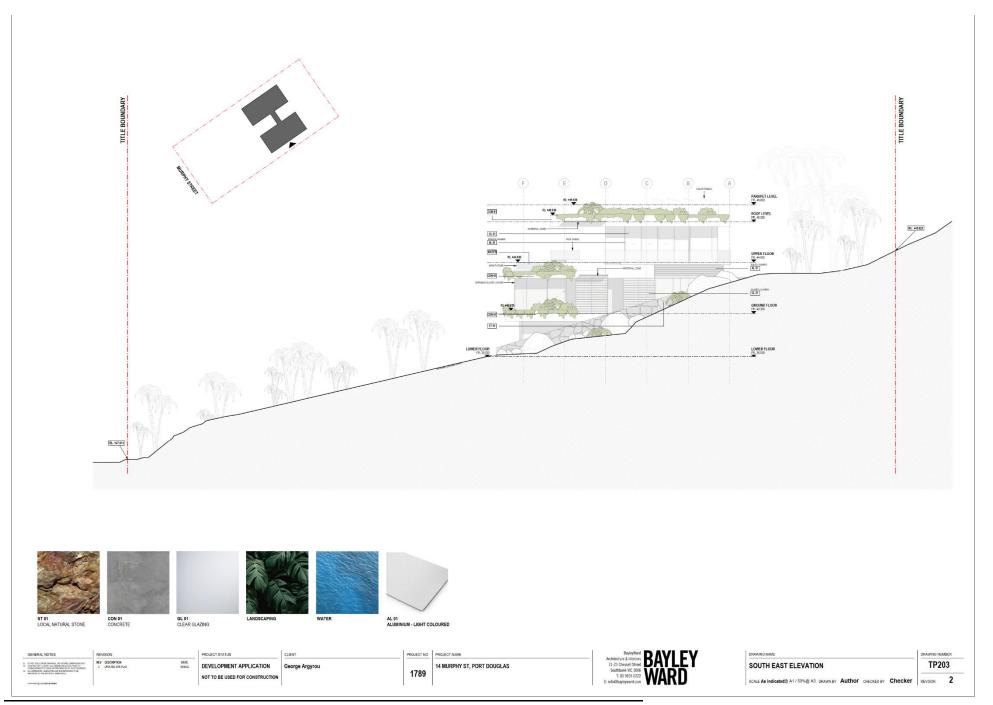


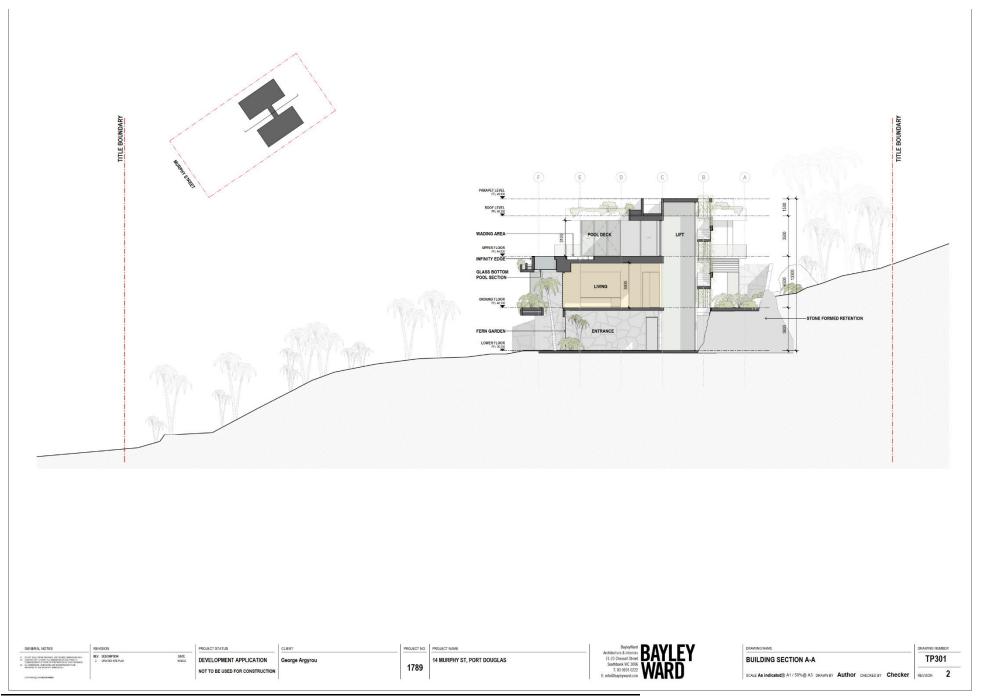


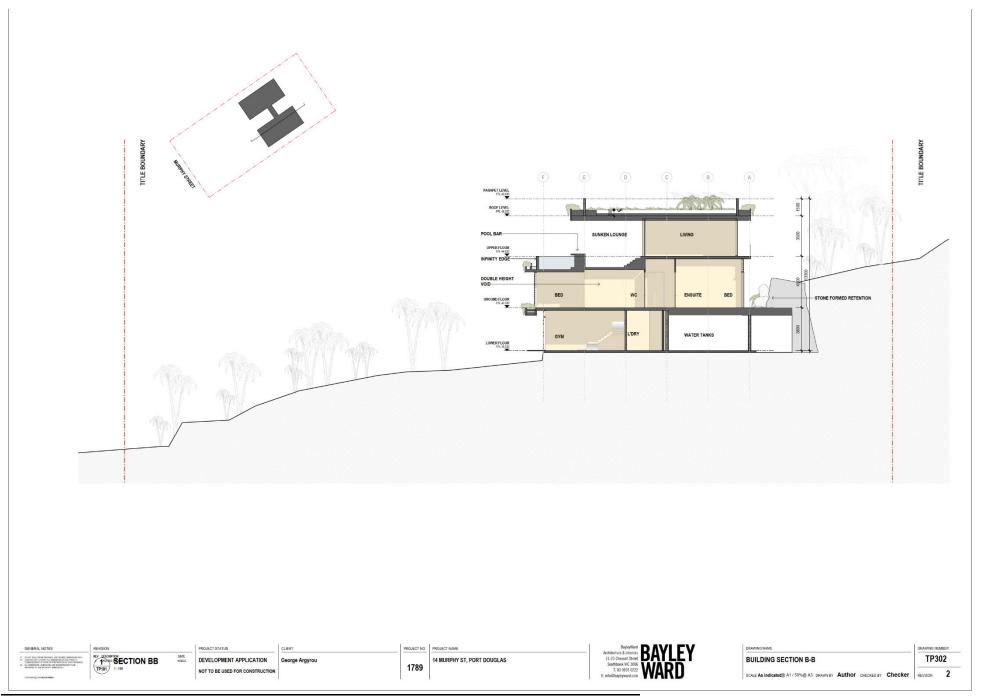


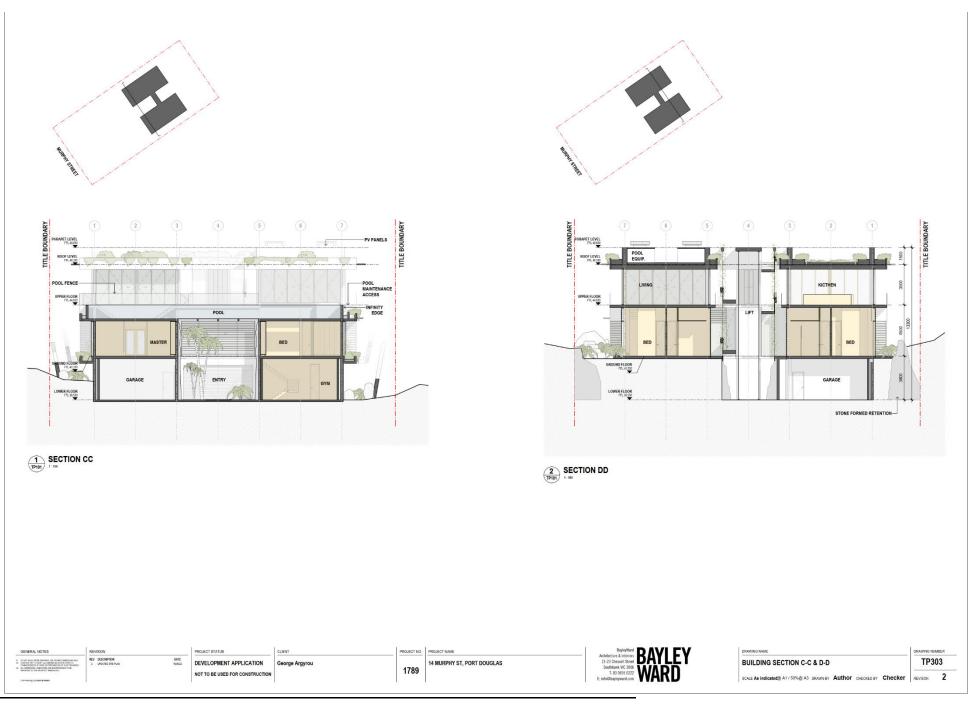



Doc ID: 1114104 MCUC 2022_4732/1 Page 25 of 55

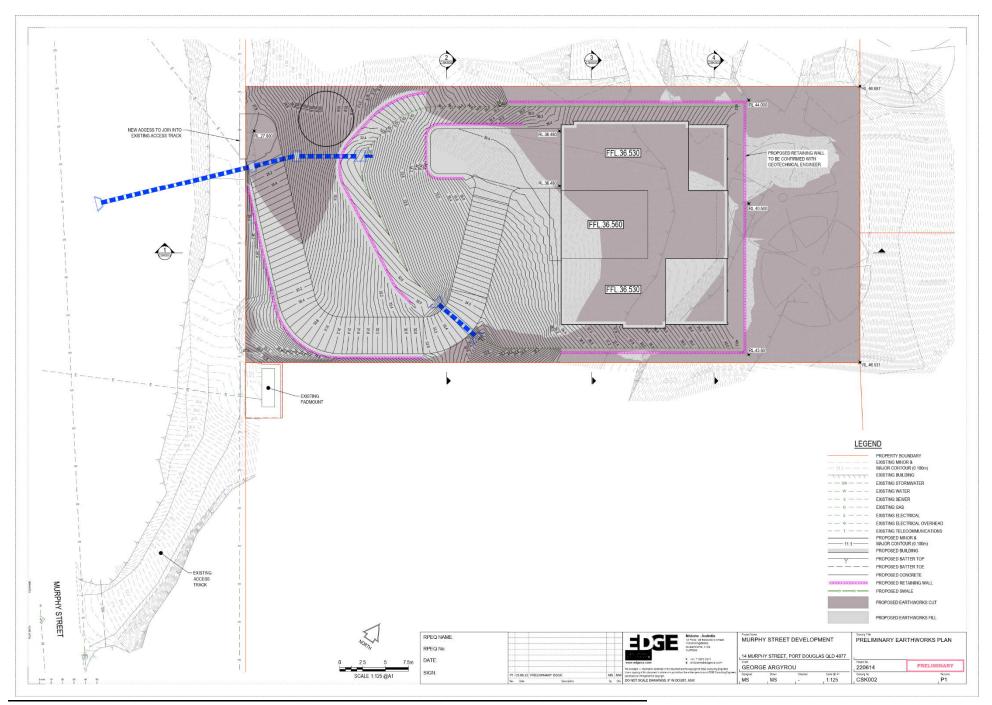

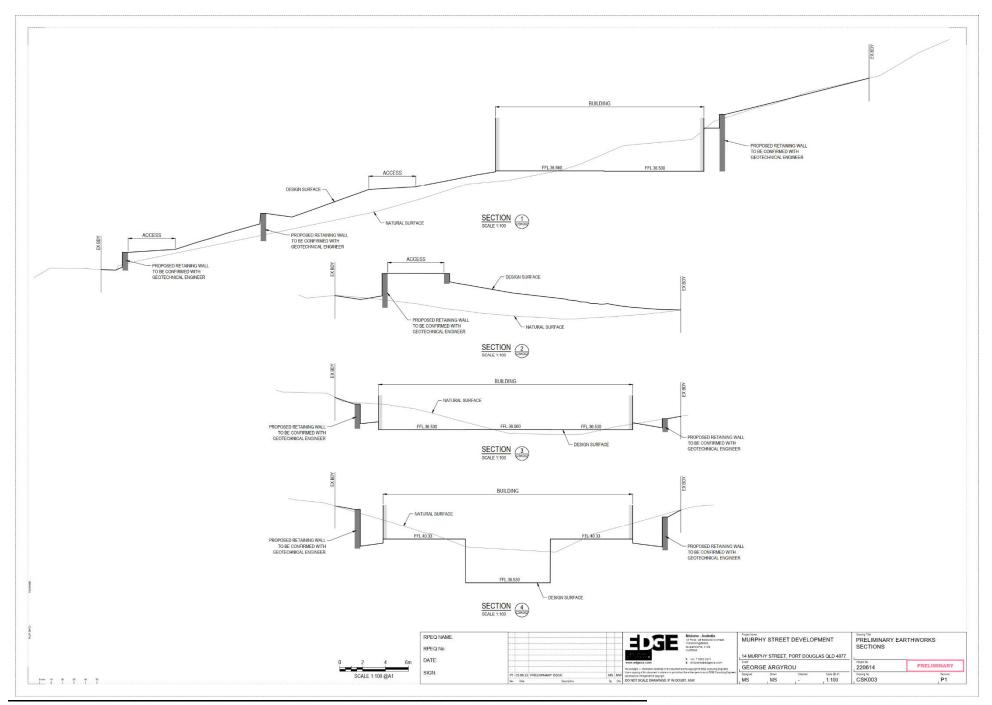

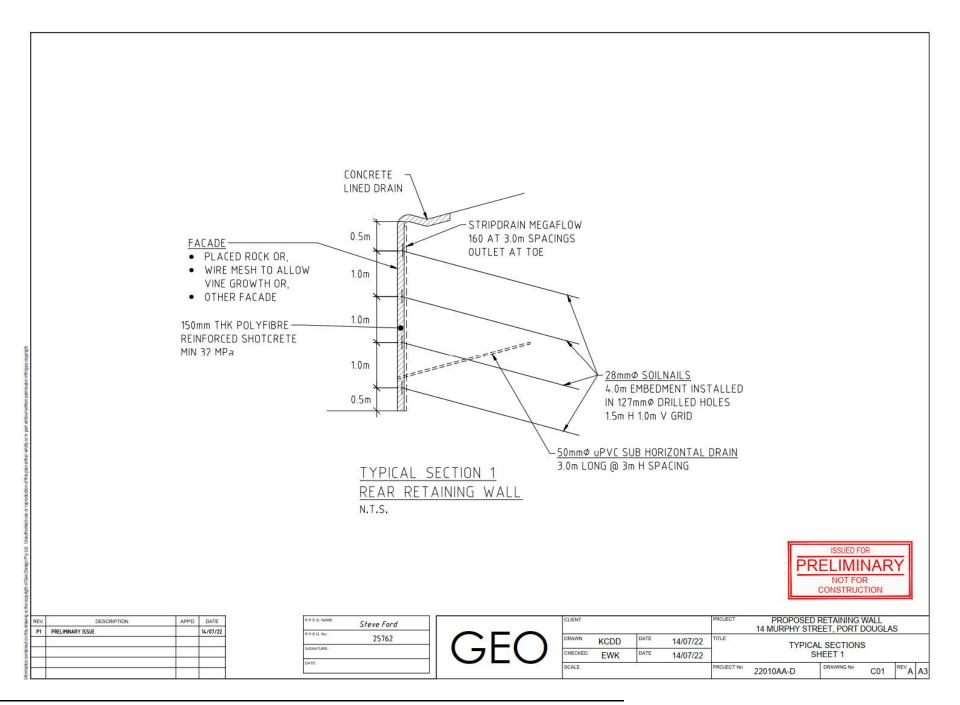

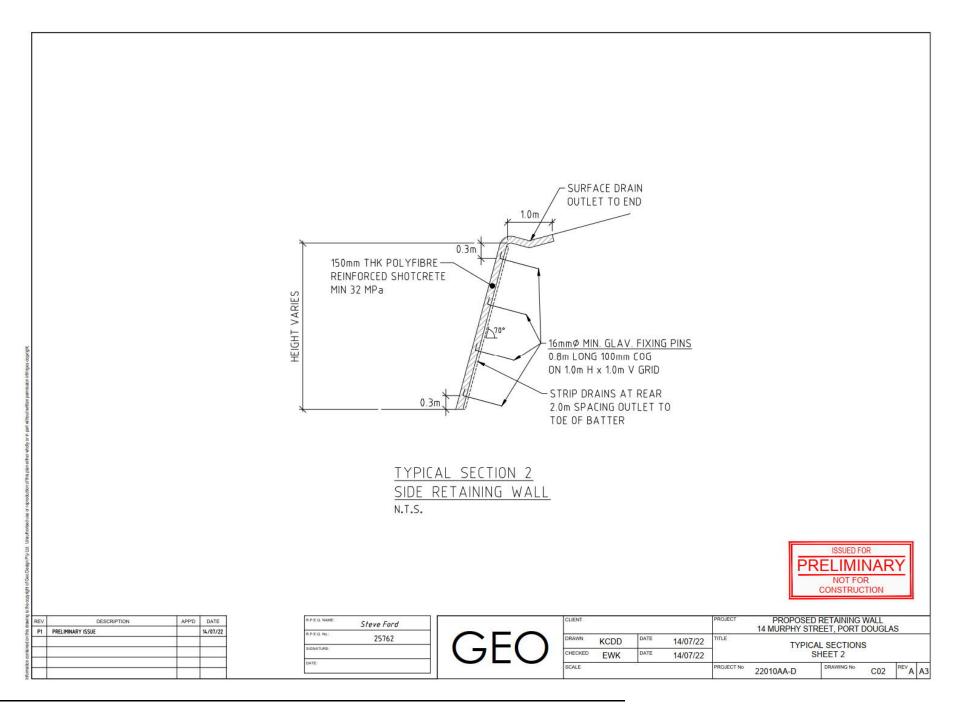

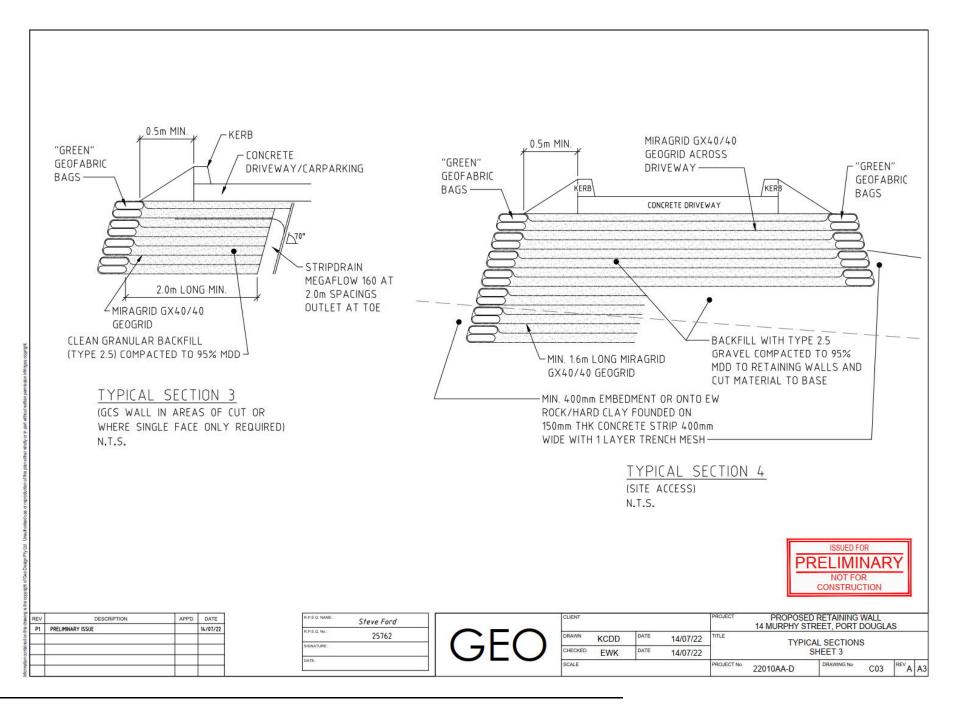

Visual Amenity Report & Vegetation Survey for 14 Murphy Street

Port Douglas (Lot 114 on PTD2094)

Prepared for Patagorang Holdings Pty Ltd

In relation to Information Request by Douglas Shire Council (ref. MCUC2022_4732/1)

by John Sullivan Bach.App.Sc.Hort.

Hortulus Australia Pty/Ltd

PO Box 798 Port Douglas Q. 4877

30th June 2022.



Figure 1 Alstonia scholaris (Tree 39) Canopy from base of tree.



Introduction

Hortulus Australia Pty Ltd has been asked to provide a tree survey of existing vegetation on 14 Murphy Street (Lot 114 PTD 2094) Port Douglas and the adjoining Murphy Street, road verge to the front of the site. In addition to this provide comment on the Visual Amenity of the Landscape with reference to privacy and views to the site over time. The survey is to include all trees with a trunk diameter of 500mm or more as measured from 1000mm above natural ground level. The survey is to include species name, approximate height, trunk girth, estimated age, extent of canopy, and estimated root zone.

The survey was conducted Thursday 30th June 2022.

The Site

The subject site currently exists largely as a derelict site with climaxed wattle trees to the south and west of the site. The central area is cleared land dominated by weed species, remnants of previous gardening. The land falls approximately 20m over the 67m length of the site, with areas evident of previous access tracks and embankments from earthworks. At the north of the site stands two majestic trees, a Queensland Blue Gum (Tree 40) & a Milky Pine (Tree 39).



Figure 2 Trees 39 & 40 viewed from Lot 113 north west boundary note cleared site with weed species.

The Murphy Street road easement on the southwest boundary, is approximately 30m wide with vegetation dominating 20m of this area adjoining the property, with drainage and bitumen carriageway the remaining. There is currently a cleared gravel track to the site, from the bitumen road.



Figure 3 South west corner boundary peg center of photo showing existing gravel access road to boundary.

Vegetation Survey

The site was surveyed on foot with transects along each boundary and locations of each tree measured or approximated in relation to existing survey marks, trees already located and topography. These locations have been noted on the current survey plan, with locations approximate and not shown for construction purposes at this stage.

Species have been identified from foliage, fruit, and trunk characteristics available at the time of survey.

Girth has been measured on each tree.

Height & Canopy has been estimated onsite.

Estimated age of the trees is approximate, and based on the known longevity of each species, their current condition, knowledge of fire regimes and previous tree surveys of the site publicly available.

Root zones of large trees vary greatly, with some having roots up to 2km away from their trunk. In providing an estimate of root zone, we have assumed an estimate of Structural Root Zone is required. This figure varies greatly, not only considering the distance from the trunk but also the percentage of Total Root System proposed to be damaged on any individual specimen. The Structural Root Zone is a mathematical formula determined by the girth of the tree and is only an indication of an area of roots to be protected to provide stability of the tree if excavation is required. The species & post excavation care of a tree/palm also influences its ability to cope with root disturbance on an individual basis.

Removal status has been determined on individual specimens being in a proposed construction zone (house, driveway or excavation/retaining) or being part of a climax community. The Wattle Trees (Acacia sp.) on the site, generally belong to a community of plants that are short lived (20 years) & regenerated by fire. Fire hasn't been present on the western side of Flagstaff Hill for over 40 years. Most of the Wattles are in senescence showing evidence of reduced canopies, rot, and collapse, rendering them dangerous to build around. Additional evidence of regenerating native species clearly indicates a shift to closed rainforest species with juvenile Solitaire Palms (*Ptycosperma elegans*), Flame Trees (*Brachychiton acerifolius*), Native Olive (*Chionanthus ramiflorus*), Umbrella

Tree (Schefflera actinophylla), Lime berry (Micromelum minutum) amongst others, occurring below the existing canopy.

Weed species

The site is dominated by shrubby weeds with most native tree species to the southwest boundaries of the site. A large percentage of the vine growth over trees is a deciduous Yam species (Dioscorea sp.) that maybe a cultivated form, based on other tropical food plants present on site. Many of the species present seem to be largely garden escapees, which should be managed through the construction process. The development of a predominantly native garden as per proposed landscape plan by Hortulus (14 March 2022), in accordance with requirements for the Special Area Flagstaff Hill Zoning, should produce better visual & habitat outcomes.

The Murphy Street road easement has predominantly native species however the access driveway has an infestation of Tree Lucerne (*Leucaena leucocephala*) and Singapore Daisy (*Sphagneticola trilobata*) with the latter being presents across the entire site. Notable weed species are listed below.


BOTANICAL NAME

COMMON NAME

Allamanda cathartica Climbing Allamanda Elaeis guineensis African oil Palm Heliconia stricta Bird of Paradise Leucaena leucocephala Tree Lucerne Manihot esculenta Cassava Megathyrsus maximus **Guinea Grass** Musa acuminata var. Sugar Banana Ravenala madagascariensis Travellers palm Sphagneticola trilobata Singapore Daisy Stachytarpheta cayennensis Blue Snake weed



Figure 4 view from Tree 20 looking up hill to Trees 39 & 40 at the top of the site. Note general weed growth.

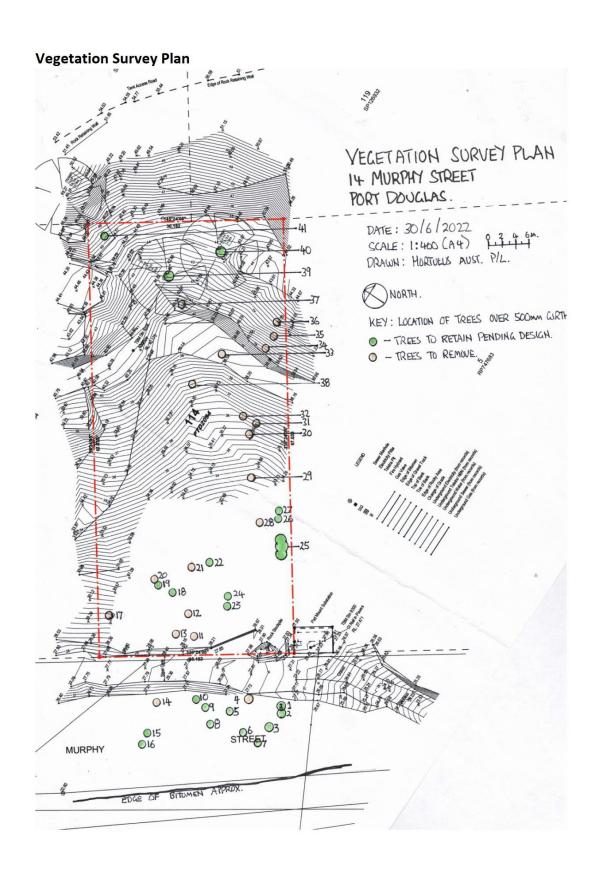

Tree Numbers refer to the accompanying Tree Survey Plan (Above).

TREE 1. Euroschinus falcata Pink Poplar

Height; 10m Girth; 860mm Age; 20 Canopy Diameter; 5m Structural Root Zone (radius from trunk); 2.9m Removal Status; Remain

TREE 2. Euroschinus falcata Pink Poplar

Height; 10m Girth; 760mm Age; 20 Canopy Diameter; 5m Structural Root Zone (radius from trunk); 2.8m Removal Status; Remain

TREE 3. Euroschinus falcata Pink Poplar

Height; 11m Girth; 875mm Age; 25 Canopy Diameter; 7m Structural Root Zone (radius from trunk); 2.9m Removal Status; Remain

TREE 4. Euroschinus falcata Pink Poplar

Height; 11m Girth; 850mm Age; 25 Canopy Diameter; 7m

Structural Root Zone (radius from trunk); 2.9m Removal Status; Remove for entry road

TREE 5. Chionanthus ramiflorus Native Olive

Height; 6m Girth; 560mm Age; 15 Canopy Diameter; 5m Structural Root Zone (radius from trunk); 2.5m Removal Status; Remain

TREE 6. Acacia crassicarpa Lancewood

Height; 7m Girth; 670mm Age; 30 Canopy Diameter; 5m Structural Root Zone (radius from trunk); 2.7m Removal Status; Remain

TREE 7. Acacia crassicarpa Lancewood

Height; 8m Girth; 780mm Age; 30 Canopy Diameter; 5m Structural Root Zone (radius from trunk); 2.8m Removal Status; Remain

TREE 8. Euroschinus falcata Pink Poplar

Height; 9m Girth; 1090mm Age; 30 Canopy Diameter; 8m Structural Root Zone (radius from trunk); 3.3m Removal Status; Remain

TREE 9. Buchanania arborescens Satinwood

Height; 11m Girth; 820mm Age; 40 Canopy Diameter; 6m Structural Root Zone (radius from trunk); 2.9m Removal Status; Remain

TREE 10. Terminalia sericocarpa Damson

Height; 14m Girth; 910mm Age; 20 Canopy Diameter; 8m Structural Root Zone (radius from trunk); 3m Removal Status; Remain

TREE 11. Acacia crassicarpa Lancewood

Height; 10m Girth; 1140mm Age; 40+ Canopy Diameter; 6m

Structural Root Zone (radius from trunk); 3.4m Removal Status; Remove due to age

TREE 12. Acacia crassicarpa Lancewood

Height; 4m Girth; 1200mm Age; 40+ Canopy Diameter; 0m

Structural Root Zone (radius from trunk); Om Removal Status; Remove Dead

TREE 13. Acacia crassicarpa Lancewood

Height; 6m Girth; 750mm Age; 30+ Canopy Diameter; 4m

Structural Root Zone (radius from trunk); 2.9m Removal Status; Remove due to age

TREE 14. Mangifera indica Mango Tree

Height; 9m Girth; 600mm Age; 20 Canopy Diameter; 5m

Structural Root Zone (radius from trunk); 2.7m Removal Status; Remove not native

TREE 15. Buchanania arborescens Satinwood

Height; 11m Girth; 740mm Age; 30+ Canopy Diameter; 6m Structural Root Zone (radius from trunk); 2.9m Removal Status; Remain

TREE 16. Euroschinus falcata Pink Poplar

Height; 10m Girth; 1460mm Age; 40+ Canopy Diameter; m Structural Root Zone (radius from trunk); 3.9m Removal Status; Remain

TREE 17. Acacia crassicarpa Lancewood

Height; 11m Girth; 1175mm Age; 40+ Canopy Diameter; 6m

Structural Root Zone (radius from trunk); 3.5m Removal Status; Remove due to age

TREE 18. Terminalia muelleri Mueller's Damson

Height; 7m Girth; 600mm Age; 15 Canopy Diameter; 4m

Structural Root Zone (radius from trunk); 2.5m Removal Status; Retain pending drive design

TREE 19. Chionanthus ramiflorus Native Olive

Height; 7m Girth; 540mm Age; 10 Canopy Diameter; 6m

Structural Root Zone (radius from trunk); 2.5m Removal Status; Retain pending drive design

TREE 20. Acacia crassicarpa Lancewood

Height; 6m Girth; 600mm Age; 30+ Canopy Diameter; 5m Structural Root Zone (radius from trunk); 2.7m Removal Status; Remove due to age

TREE 21. Acacia crassicarpa Lancewood

Height; 6m Girth; 690mm Age; 30+ Canopy Diameter; 4m covered in vine Structural Root Zone (radius from trunk); 2.9m Removal Status; Remove due to age

TREE 22. Terminalia muelleri Mueller's Damson

Height; 7m Girth; 700mm Age; 15 Canopy Diameter; 5m

Structural Root Zone (radius from trunk); 3m Removal Status; Retain pending drive design

TREE 23. Chionanthus ramiflorus Native Olive

Height; 7m Girth; 790mm Age; 10 Canopy Diameter; 5m

Structural Root Zone (radius from trunk); 3m Removal Status; Retain pending drive design

TREE 24. Chionanthus ramiflorus Native Olive

Height; 6m Girth; 580mm Age; 10 Canopy Diameter; 4m

Structural Root Zone (radius from trunk); 2.6m Removal Status; Retain pending drive design

TREE 25. Ficus sp. (possibly ficus rubignosa) Fig Tree This tree has 4 trunks

Height; 14m Girth; 4000mm Age;25+ Canopy Diameter; 12m

Structural Root Zone (radius from trunk); 4m (due to vigour) Removal Status; Retain

TREE 26. Euroschinus falcata Pink Poplar

Height; 13m Girth; 1300mm Age; 30+ Canopy Diameter; 8m Structural Root Zone (radius from trunk); 3.5m Removal Status; Retain

TREE 27. Euroschinus falcata Pink Poplar

Height; 12m Girth; 880mm Age; 20+ Canopy Diameter; 6m Structural Root Zone (radius from trunk); 3m Removal Status; Retain

TREE 28. DEAD TREE

Height; 4m Girth; 700mm Age; NA Canopy Diameter; 0m

Structural Root Zone (radius from trunk); NA Removal Status; Remove dangerous

TREE 29. Acacia crassicarpa Lancewood

Height; 7m Girth; 720mm Age; 30+ Canopy Diameter; 4m

Structural Root Zone (radius from trunk); 2.9m Removal Status; Remove due to age

TREE 30. DEAD TREE Acacia crassicarpa Lancewood

Height; 6m Girth; 760mm Age; NA Canopy Diameter; 0m Structural Root Zone (radius from trunk); NA Removal Status; Remove dangerous

TREE 31. Acacia crassicarpa Lancewood

Height; 7m Girth; 800mm Age; 30+ Canopy Diameter; 4m smothered in vine Structural Root Zone (radius from trunk); 3.1m Removal Status; Remove due to age

TREE 32. Acacia crassicarpa Lancewood

Height; 8m Girth; 720mm Age; 30+ Canopy Diameter; 4m Structural Root Zone (radius from trunk); 2.9m Removal Status; Remove due to age

TREE 33. Acacia crassicarpa Lancewood

Height; 7m Girth; 550mm Age; 25+ Canopy Diameter; 4m

Structural Root Zone (radius from trunk); 2.6m Removal Status; Remove due to age

TREE 34. Acacia crassicarpa Lancewood

Height; 8m Girth; 720mm Age; 30+ Canopy Diameter; 4m

Structural Root Zone (radius from trunk); 2.9m Removal Status; Remove due to age

TREE 35. Acacia crassicarpa Lancewood

Height; 8m Girth; 700mm Age; 30+ Canopy Diameter; 4m

Structural Root Zone (radius from trunk); 2.8m Removal Status; Remove due to age

TREE 36. Acacia crassicarpa Lancewood

Height; 8m Girth; 980mm Age; 30+ Canopy Diameter; 4m Structural Root Zone (radius from trunk); 3.1m Removal Status; Remove due to age

TREE 37. Polyscias elegans Celerywood

Height; 6m Girth; 580mm Age; 10+ Canopy Diameter; 5m

Structural Root Zone (radius from trunk); 2.7m Removal Status; Remove construct zone

TREE 38. Polyscias elegans Celerywood

Height; 8m Girth; 1200mm Age; 15+ Canopy Diameter; 5m

Structural Root Zone (radius from trunk); 3.5m Removal Status; Remove construct zone

TREE 39. Alstonia scholaris Milky Pine

Height; 20m Girth; 2800mm Age;40+ Canopy Diameter; 10m Structural Root Zone (radius from trunk); 5m Removal Status; Retain

TREE 40. Eucalyptus tetericornis Queensland Blue Gum

Height; 18m Girth; 2400mm Age; 40+ Canopy Diameter; 8m Structural Root Zone (radius from trunk); 4.8m Removal Status; Retain

TREE 41. Choinanthus ramiflorus Native Olive

Height; 8m Girth; 750mm Age; 10 Canopy Diameter; 5m Structural Root Zone (radius from trunk); 2.9m Removal Status; Retain

VISUAL AMENITY COMMENTS

The comments on visual Amenity of the site and its vegetation refer to.

- 1. The existing Vegetation Survey and proposed tree removal (within this report),
- 2. The proposed ground Planting Plan by Hortulus Australia P/L dated 20 July 2022 &,
- 3. The vegetation Schematic Elevations of existing trees to be retained and proposed planting at establishment, five years growth & 10 years growth.

Existing Trees

There are three significant trees on this site. Tree 25. Ficus sp., Tree 39. Milky Pine and Tree 40. the Queensland Blue Gum. They are all trees of good health, vigour and are young trees in relation to their species know longevity. Trees 39 & 40 have always intended to be retained, with the proposed building designed suitably. Tree 25 will require the driveway to be slightly adjusted in the Building Design process but can be easily retained as it sits close to the boundary and figs are known to cope well with root disturbance. This tree will become a major feature on the way up the driveway to the house.

Tree retention onsite will be based on the percentage of root disturbance being balanced with the Structural Root Zone, with protection areas to be excluded from all building site activity, debris, and waste. Supervision and required tree shaping will be undertaken by a qualified consulting arborist.

All Wattle Trees (Acacia sp.) are advised to be removed and replaced with native trees of better longevity, and better screening capabilities to provide neighbours privacy.

Many of the remainder of the trees are in suitable positions to remain with only a few requiring removals pending the location of the driveway when detail design occurs. The trees that remain will form part of the existing screening and ecosystem of Flagstaff Hill and will be enhanced through irrigation, horticultural practices & added native planting. Being predominantly to the Murphy Street portion of the site, these trees will provide some initial screening to the building site on the upper area.

Proposed Landscape Plan

The proposed Landscape plan provides for a predominantly dense native planting scheme (total site plants 1683), with 76.5% (1289 plants) of plants on the ground level to be native with 23.5% exotics (394 plants) generally located directly around the building. There are 176 existing & new native trees and palms on the plan that have a minimum mature height of at least six meters.

The landscape is intended to emulate the flow of water across the site into bioswales to allow the recharging of the water table and the excess to be captured to provide some irrigation over the Dry Season. This design allows for several microclimates to be created, utilising rainforest plants like Tree ferns, Daintree Gardenia, and Lilly Pilly. The top of the site allows for slightly dryer plantings with more honey flora for the creation of habitat, including the fast-growing Ulysses Butterfly Tree, Dwarf Golden Penda, and Dutchman's Pipe Vine for the Cairns Birdwing Butterfly.

Plant sizes have been recommended knowing that plants in smaller pot sizes, recover more quickly from transplanting and will initially outgrow larger plant stock in a shorter period, producing stronger and more stable plants.

Side Boundary Screening

The proposed building footprint leaves 4000mm on each side of the building to the property side boundaries. In this area it is intended to provide a 1000mm to 1500mm wide access pathway and steps including a naturalistic stormwater catchment swale. This will leave a 2500mm wide planting area, to provide screening to the neighbouring properties. It is assumed that adjoining properties would provide a similar area of planting in accordance with the requirements for special area Flagstaff Hill in the Douglas Shire Town plan. In total an area of screen would be achieved of 5000mm wide, adequate for screening between windows & balconies.

Planting density in this zone, has been specified to allow the selected species to provide dense foliage from the top of the plant all the way down. Heavily planted screening areas often end up shading out the lower foliage of the trees & palms allowing views in the understory. The *Syzygium australe* "Straight & narrow", *Ptycosperma macartherii*, and *Callistemon* "Slim", specifically have narrow forms with dense foliage provided they are not shaded out. Additional screen planting can be added as an understory as shade allows and as it is required.

Murphy Street Visibility


The lower half of the site provides for excellent screening of the built from Murphy Street, as the building is over 30m from the front of the site, with some existing trees remaining and additional screen planting provided.


From the southern edge of bitumen on the Murphy Street pavement, there will be a majority of existing trees left in the road easement and lower portion of the site with the additional planting as provided on the Planting Plan to screen any views to the proposed residence above.


As the driveway enters from the Southwest corner of the site there will be no visual access to the building from Murphy Street.


THE AUTHOR

John Sullivan Bach.App.Sc.Hort. has been specialising in tropical landscape in northern Australia since 1992 acting as a consultant in vegetation management in both natural and urban environments. He has designed & constructed many landscapes with several featuring in books & publications both in Australia & overseas. Sullivan has been a Director at the Mossman Botanic Gardens for 8 years.

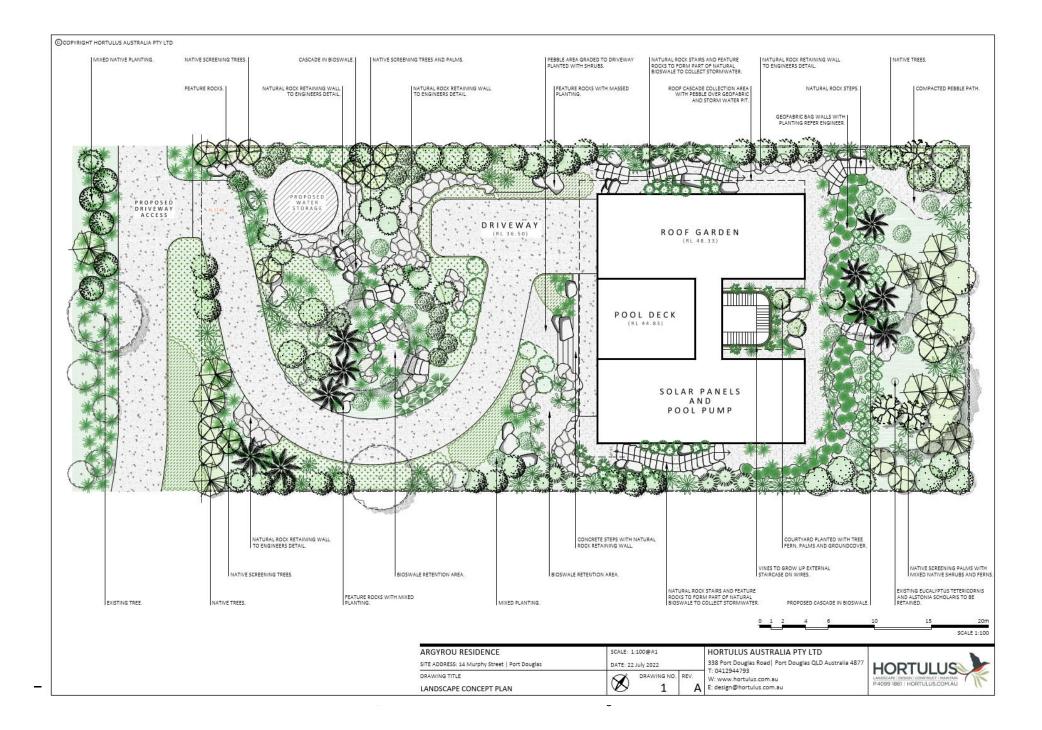

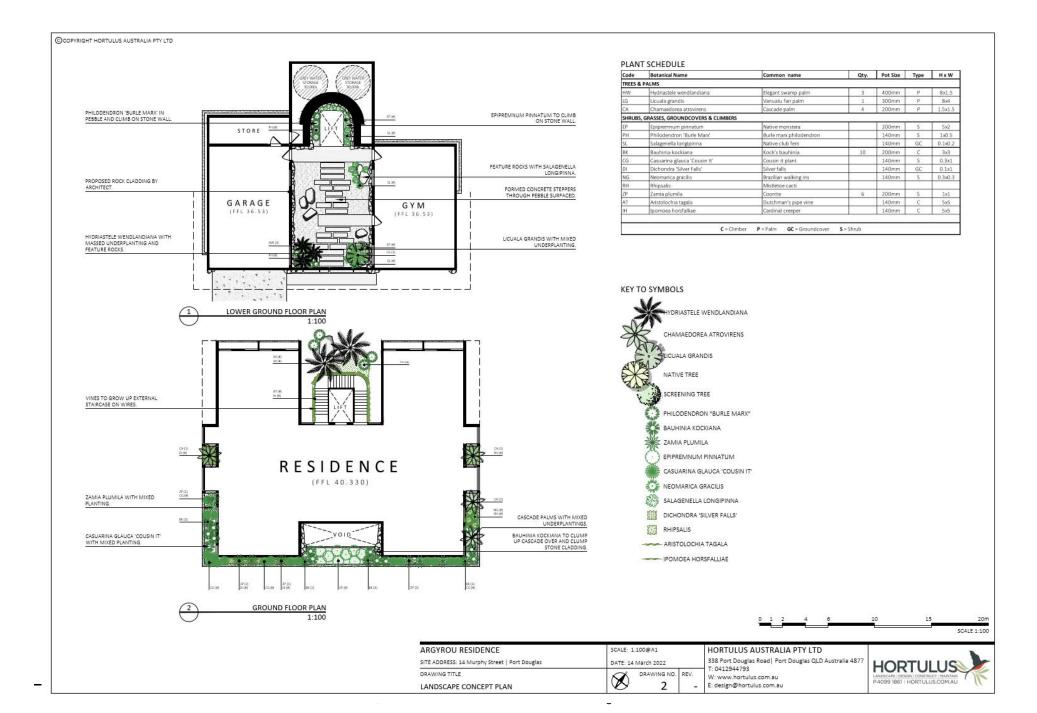

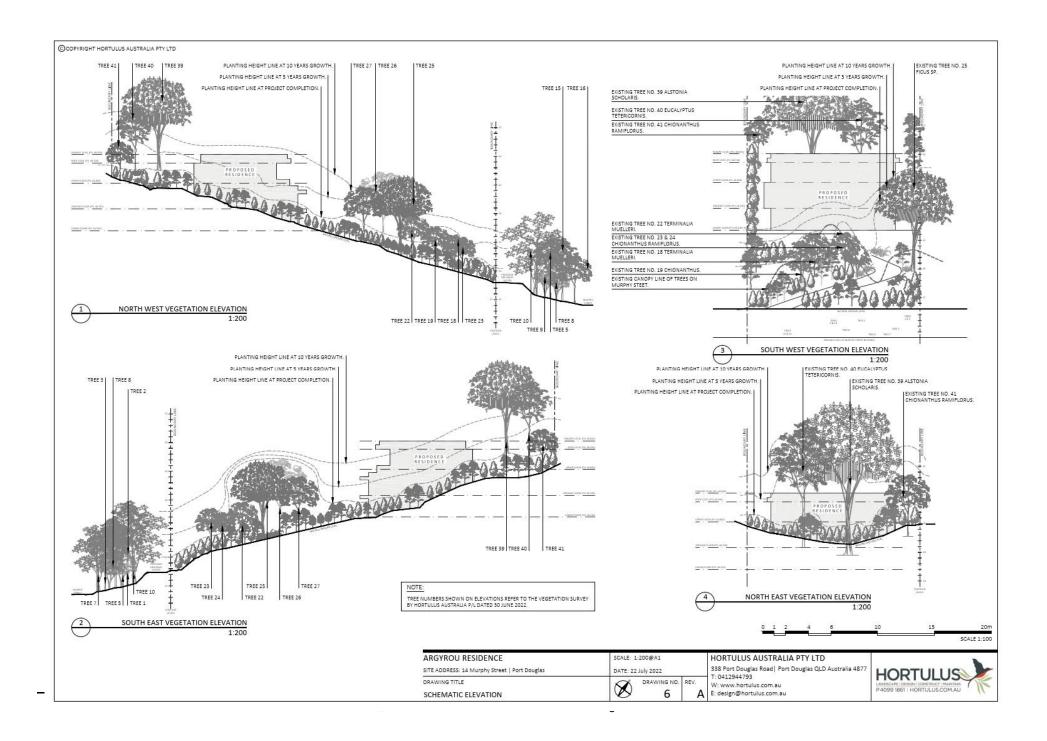

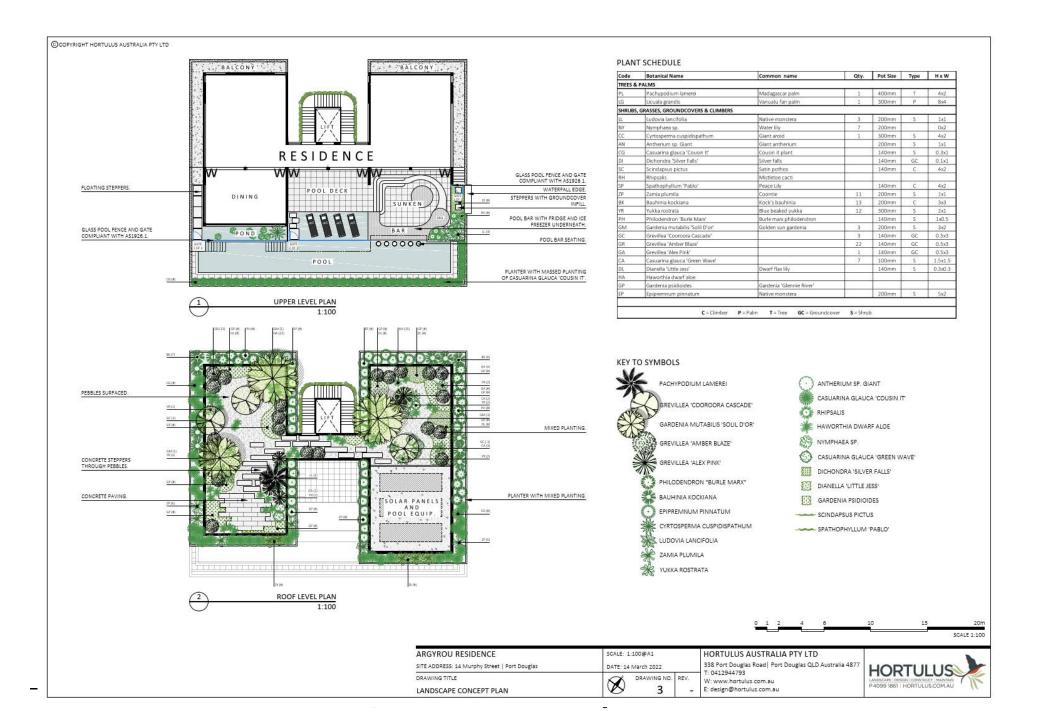

PLANT SCHEDULE Code Sotavical Name Common name Qty. Pot Size Type H x W TREES & PALMS 106 DRIVEWAY ROOF GARDEN visses tree Ptycosperms degens Arenga Australasica lative sugar paim POOL DECK SHRUBS, GRASSES, GROUNDCOVERS & CLIMBER Glerinie nver gerden SOLAR PANELS PIS AND POOL PUMP Red shell girgar Alpinia terumbet vartegata Variegated shell garger 1 Eristing T 4 Existing T 4 Cristing T 1 Bisting T 1 Sesting T 20x14 2 Sesting Y 20x8 KEY TO SYMBOLS ALPINIA PURPURATA LICUALA RAMSAYII CUPANIOPSIS FLAGELLIFORMIS DIANELLA ATRAXIS CALATHEA ZEBRINA PHILODENDRON 'BURLE MARX' CYATHEA COOPERI EXISTING TREES (ANTHOSTEMON CHRYSANTHUS 'FAIRHILL GOLD ASPLENIUM AUSTRALASICUM GARDENIA SCABRELLA CORDYLINE MANNERS-SUTTONIAE BOWENIA SPECTABILIS C-Oimber G-Ginger SE-Sedge F-Fem P-Paim T-Time GC-Groundcover S-Shrull MIMUSOPS ELENGI SYZYGIUM AUSTRALE 'STRAIGHT & NARROW' ARENGA AUSTRALASICA LOMANDRA HYSTRIX MELICOPE ELLERYANA SYZYGIUM WILSONII XANTHOSTEMON VERTICILLATUS MOLINERIA CAPITULATE PTYCOSPERMA MACARTHERI ARCHIDENDRON LUCYI GARDENIA PSIDIODES 'GLENNIE RIVER' CALLISTEMON SP. 'SLIM' PTYCOSPERMA ELEGANS OPHIOPOGON JAPONICUS 'NANA' TRACTOCARPUS FITZALANNI DEPLANCHEA TETRAPHYLLA CRINUM PEDUNCULATUM HELICONIA CHARTACEA 'SEXY PINK' ALPINIA ZERUMBET VARIEGATA NATIVE TREE ALPINIA ZERUMBET VARIEGATA PHILODENDRON GLORIOSUM TACCA CHANTRIERI GARDENIA ACTINOCARPA ARLINGIA DARLINGIANA ARISTOLOCHIA TAGALA ANGIOPTERIS EVECTA POMOEA HORSFALLIAE ARGYROU RESIDENCE SCALE: 1:100@A0 HORTULUS AUSTRALIA PTY LTD

SITE ADDRESS: 14 Murphy Street | Port Douglas

DRAWING TITLE

PLANTING PLAN

DATE: 22 July 2022

DRAWING NO. REV.

5

338 Port Douglas Road | Port Douglas QLD Australia 4877

T: 0412944793

W: www.hortulus.com.au

E: design@hortulus.com.au

HORTULUS

P4099 1861 | HORTULUS COM AU

Reasons for Decision

The reasons for this decision are:

- 1. Sections 60, 62 and 63 of the Planning Act 2016:
 - a. to ensure the development satisfies the benchmarks of the 2018 Douglas Shire Planning Scheme Version 1.0; and
 - b. to ensure compliance with the *Planning Act 2016*.
- 2. Findings on material questions of fact:
 - a. the development application was properly lodged to the Douglas Shire Council on 20 June 2022 under section 51 of the *Planning Act 2016* and Part 1 of the *Development Assessment Rules*:
 - b. the development application contained information from the applicant which Council reviewed together with Council's own assessment against the 2017 State Planning Policy and the 2018 Douglas Shire Planning Scheme Version 1.0 in making its assessment manager decision.
- 3. Evidence or other material on which findings were based:
 - a. the development triggered assessable development under the Assessment Table associated with the Environmental Management Zone Code;
 - b. Council undertook an assessment in accordance with the provisions of sections 60, 62 and 63 of the *Planning Act 2016*; and
 - b. Council undertook an assessment in accordance with the provisions of s60, s62 and s63 of the *Planning Act 2016*; and
 - c. the applicant's reasons have been considered and the following findings are made:
 - i. Subject to conditions, the development satisfactorily meets the Planning Scheme benchmarks.

Non-Compliance with Assessment Benchmarks

None. Subject to the conditions the development complies with the Planning Scheme Assessment Benchmarks.

Extracts from the Planning Act 2016 - Making Representations During Applicant's Appeal Period

Planning Act 2016 Chapter 3 Development assessment

Is 74

Division 2 Changing development approvals

Subdivision 1 Changes during appeal period

74 What this subdivision is about

- This subdivision is about changing a development approval before the applicant's appeal period for the approval ends.
- (2) This subdivision also applies to an approval of a change application, other than a change application for a minor change to a development approval.
- (3) For subsection (2), sections 75 and 76 apply—
 - (a) as if a reference in section 75 to a development approval were a reference to an approval of a change application;
 and
 - (b) as if a reference in the sections to the assessment manager were a reference to the responsible entity; and
 - (c) as if a reference in section 76 to a development application were a reference to a change application;
 and
 - (d) as if the reference in section 76(3)(b) to section 63(2) and (3) were a reference to section 83(4); and
 - (e) with any other necessary changes.

75 Making change representations

- The applicant may make representations (change representations) to the assessment manager, during the applicant's appeal period for the development approval, about changing—
 - (a) a matter in the development approval, other than—
 - a matter stated because of a referral agency's response; or

Page 94

Current as at 10 June 2022

- (ii) a development condition imposed under a direction made by the Minister under chapter 3, part 6, division 2; or
- (b) if the development approval is a deemed approval—the standard conditions taken to be included in the deemed approval under section 64(8)(c).
- (2) If the applicant needs more time to make the change representations, the applicant may, during the applicant's appeal period for the approval, suspend the appeal period by a notice given to the assessment manager.
- (3) Only 1 notice may be given.
- (4) If a notice is given, the appeal period is suspended-
 - (a) if the change representations are not made within a period of 20 business days after the notice is given to the assessment manager—until the end of that period; or
 - (b) if the change representations are made within 20 business days after the notice is given to the assessment manager, until—
 - the applicant withdraws the notice, by giving another notice to the assessment manager; or
 - (ii) the applicant receives notice that the assessment manager does not agree with the change representations; or
 - (iii) the end of 20 business days after the change representations are made, or a longer period agreed in writing between the applicant and the assessment manager.
- (5) However, if the assessment manager gives the applicant a negotiated decision notice, the appeal period starts again on the day after the negotiated decision notice is given.

76 Deciding change representations

 The assessment manager must assess the change representations against and having regard to the matters that

Current as at 10 June 2022

Page 95

- must be considered when assessing a development application, to the extent those matters are relevant.
- (2) The assessment manager must, within 5 business days after deciding the change representations, give a decision notice to—
 - (a) the applicant; and
 - if the assessment manager agrees with any of the change representations—
 - (i) each principal submitter; and
 - (ii) each referral agency; and
 - (iii) if the assessment manager is not a local government and the development is in a local government area—the relevant local government; and
 - (iv) if the assessment manager is a chosen assessment manager—the prescribed assessment manager; and
 - (v) another person prescribed by regulation.
- (3) A decision notice (a negotiated decision notice) that states the assessment manager agrees with a change representation must—
 - (a) state the nature of the change agreed to; and
 - (b) comply with section 63(2) and (3).
- (4) A negotiated decision notice replaces the decision notice for the development application.
- (5) Only 1 negotiated decision notice may be given.
- (6) If a negotiated decision notice is given to an applicant, a local government may give a replacement infrastructure charges notice to the applicant.

Page 96

Current as at 10 June 2022

Planning Act 2016 Chapter 6 Dispute resolution

[s 229]

Chapter 6 Dispute resolution

Part 1 Appeal rights

229 Appeals to tribunal or P&E Court

- Schedule 1 states—
 - (a) matters that may be appealed to-
 - (i) either a tribunal or the P&E Court; or
 - (ii) only a tribunal; or
 - (iii) only the P&E Court; and
 - (b) the person—
 - (i) who may appeal a matter (the appellant); and
 - (ii) who is a respondent in an appeal of the matter; and
 - (iii) who is a co-respondent in an appeal of the matter; and
 - (iv) who may elect to be a co-respondent in an appeal of the matter.
- An appellant may start an appeal within the appeal period.
- (3) The appeal period is—
 - (a) for an appeal by a building advisory agency—10 business days after a decision notice for the decision is given to the agency; or
 - (b) for an appeal against a deemed refusal—at any time after the deemed refusal happens; or
 - (c) for an appeal against a decision of the Minister, under chapter 7, part 4, to register premises or to renew the registration of premises—20 business days after a notice is published under section 269(3)(a) or (4); or

Current as at 10 June 2022

Page 213

- (d) for an appeal against an infrastructure charges notice—20 business days after the infrastructure charges notice is given to the person; or
- (e) for an appeal about a deemed approval of a development application for which a decision notice has not been given—30 business days after the applicant gives the deemed approval notice to the assessment manager; or
- (f) for an appeal relating to the Plumbing and Drainage Act 2018—
 - for an appeal against an enforcement notice given because of a belief mentioned in the *Plumbing and Drainage Act 2018*, section 143(2)(a)(i), (b) or (c)—5 business days after the day the notice is given; or
 - (ii) for an appeal against a decision of a local government or an inspector to give an action notice under the *Plumbing and Drainage Act 2018*—5 business days after the notice is given; or
 - (iii) for an appeal against a failure to make a decision about an application or other matter under the Plumbing and Drainage Act 2018—at anytime after the period within which the application or matter was required to be decided ends; or
 - (iv) otherwise—20 business days after the day the notice is given; or
- (g) for any other appeal—20 business days after a notice of the decision for the matter, including an enforcement notice, is given to the person.

Note-

See the P&E Court Act for the court's power to extend the appeal period.

(4) Each respondent and co-respondent for an appeal may be heard in the appeal.

Page 214

Current as at 10 June 2022

- (5) If an appeal is only about a referral agency's response, the assessment manager may apply to the tribunal or P&E Court to withdraw from the appeal.
- (6) To remove any doubt, it is declared that an appeal against an infrastructure charges notice must not be about—
 - (a) the adopted charge itself; or
 - (b) for a decision about an offset or refund-
 - the establishment cost of trunk infrastructure identified in a LGIP; or
 - the cost of infrastructure decided using the method included in the local government's charges resolution.

230 Notice of appeal

- An appellant starts an appeal by lodging, with the registrar of the tribunal or P&E Court, a notice of appeal that—
 - (a) is in the approved form; and
 - (b) succinctly states the grounds of the appeal.
- (2) The notice of appeal must be accompanied by the required fee.
- (3) The appellant or, for an appeal to a tribunal, the registrar, must, within the service period, give a copy of the notice of appeal to—
 - (a) the respondent for the appeal; and
 - (b) each co-respondent for the appeal; and
 - (c) for an appeal about a development application under schedule 1, section 1, table 1, item 1—each principal submitter for the application whose submission has not been withdrawn; and
 - (d) for an appeal about a change application under schedule 1, section 1, table 1, item 2—each principal submitter for the application whose submission has not been withdrawn; and

Current as at 10 June 2022

Page 215

- (e) each person who may elect to be a co-respondent for the appeal other than an eligible submitter for a development application or change application the subject of the appeal; and
- (f) for an appeal to the P&E Court—the chief executive;
 and
- (g) for an appeal to a tribunal under another Act—any other person who the registrar considers appropriate.

(4) The service period is—

- (a) if a submitter or advice agency started the appeal in the P&E Court—2 business days after the appeal is started; or
- (b) otherwise—10 business days after the appeal is started.
- (5) A notice of appeal given to a person who may elect to be a co-respondent must state the effect of subsection (6).
- (6) A person elects to be a co-respondent to an appeal by filing a notice of election in the approved form—
 - (a) if a copy of the notice of appeal is given to the person—within 10 business days after the copy is given to the person; or
 - (b) otherwise—within 15 business days after the notice of appeal is lodged with the registrar of the tribunal or the P&E Court.
- (7) Despite any other Act or rules of court to the contrary, a copy of a notice of appeal may be given to the chief executive by emailing the copy to the chief executive at the email address stated on the department's website for this purpose.

231 Non-appealable decisions and matters

(1) Subject to this chapter, section 316(2), schedule 1 and the P&E Court Act, unless the Supreme Court decides a decision or other matter under this Act is affected by jurisdictional error, the decision or matter is non-appealable.

Page 216 Current as at 10 June 2022

- The Judicial Review Act 1991, part 5 applies to the decision or matter to the extent it is affected by jurisdictional error.
- (3) A person who, but for subsection (1) could have made an application under the *Judicial Review Act 1991* in relation to the decision or matter, may apply under part 4 of that Act for a statement of reasons in relation to the decision or matter.
- (4) In this section—

decision includes-

- (a) conduct engaged in for the purpose of making a decision; and
- (b) other conduct that relates to the making of a decision;
 and
- (c) the making of a decision or the failure to make a decision; and
- (d) a purported decision; and
- (e) a deemed refusal.

non-appealable, for a decision or matter, means the decision or matter—

- (a) is final and conclusive; and
- (b) may not be challenged, appealed against, reviewed, quashed, set aside or called into question in any other way under the *Judicial Review Act 1991* or otherwise, whether by the Supreme Court, another court, any tribunal or another entity; and
- (c) is not subject to any declaratory, injunctive or other order of the Supreme Court, another court, any tribunal or another entity on any ground.

232 Rules of the P&E Court

- A person who is appealing to the P&E Court must comply with the rules of the court that apply to the appeal.
- (2) However, the P&E Court may hear and decide an appeal even if the person has not complied with rules of the P&E Court.

Current as at 10 June 2022

Page 217

Individual owner's consent for making a development application under the *Planning Act 2016*

I, 'George Argyrou'		
as owner of the premises identified as follows:		
14 Murphy Street, Port Douglas (Lot 114 PTD 2094)		
consent to the making of a development application under the Planning Act 2016 by:		
Neil Biddle & Kim Cullen		
on the premises described above for:		
Dwelling House including provision of access and earthworks associated with the Dwelling House site location		
DocuSigned by: [signature of owner and 4/10/2024 gned]		

Individual owner's consent for making a development application under the *Planning Act 2016*

We, Neil Biddle & Kim Cullen		
as owner of the premises identified as follows:		
12 Murphy Street, Port Douglas (Lot 113 PTD 209	4)	
consent to the making of a development application under the <i>Planning Act 2016</i> by:		
George Argyrou		
on the premises described above for:		
Dwelling House including provision of access and House site location	earthworks associated with the Dwelling	
15811h 161	[signature of owner and date signed]	